
Historical Affairs and Landmark Review Board

Arlington County, Virginia

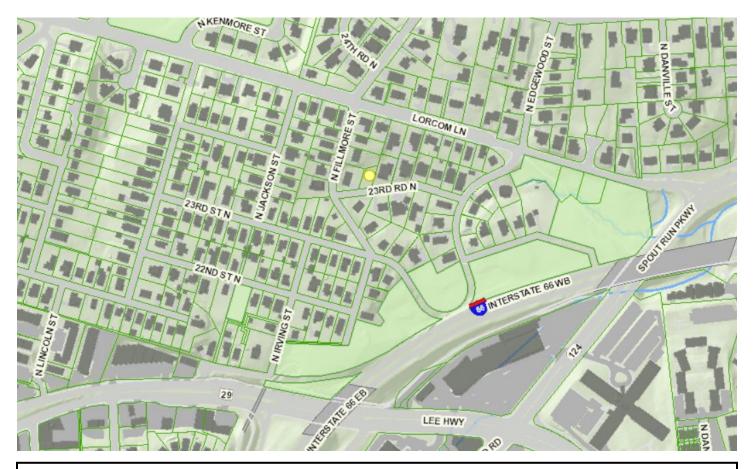

HALRB meeting January 19, 2022, Case 21-32 (HPCA21-00076)

2831 23rd Road North: Request to replace vinyl windows with aluminum clad wooden windows, reduce size of two windows, move entrance doorway from porch side to front of property, convert a window in rear into doorway, and replace existing siding with fiberboard siding.



PHONE: (703) 243-3171

VICINITY MAP Recreation Association DOVER CRYSTAL G000 Cover Sheet G001 Existing plans & elevations Z001 | Site Plan RIVERWOOD D001 Basement demo plan D002 Main level demo plan D003 | Second level demo plan WOODMONT D004 Existing elevation demo Smith Park D005 Existing elevation demo 331 23rd Rd N, ton, VA 22201 🥒 A001 Proposed basement level plan MAYWOOD A002 Proposed main level plan RRYDALE VS Pharmacy A003 Proposed second level plan VINCI School-Arlingto A004 Proposed elevations gnes Catholic Church A005 Proposed elevations E001 Proposed main level electrical plan LYON VILLAGE COURT S000 Notes de details Whole Foods Market S100 Foundation & 1st floor framing plan S101 2nd floor framing plan S102 Roof framing plan DMV Virginia Square

CODE ANALYSIS

2018 INTERNATIONAL RESIDENTIAL BUILDING CODE WITH 2018 VA UNIFORM STATEWIDE BUILDING CODE, NFPA 101 2018 CODES & ARLINGTON COUNTY AMMENDMENTS.

TABLE OF CONTENTS

PERMIT SET 12/14/2021

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USE RESIDENTIAL GROUP "R-5" CONSTRUCTION TYPE: COMBUSTIBLE, WOOD FRAME

HEIGHT CALCULATION

HEIGHT OF ROOF: MEASURED FROM AVERAGE FRONT GRADE TO HIGHEST POINT OF ROOF:

SQUARE FOOTAGE CALCULATION

EXISTING TOTAL FINISHED SQFT

±679 SQ FT. LOWER LEVEL -±1,086 SQ FT. FIRST FLOOR -±932 SQ FT. SECOND FLOOR -

EXISTING TOTAL UNFINISHED SQFT:

±489 SQ FT.

INS INSULATION

LAM LAMINATED LAV LAVATORY

LBS POUNDS

LT LIGHT

LH LEFT HAND

INT INTERIOR

JB JAMB JST JOIST KIT KITCHEN

±3,322 SQ FT.

EXISTING TOTAL COVERED SQFT:

FIRST FLOOR -±1,086 SQ FT. SECOND FLOOR -±932 SQ FT.

±489 SQ FT.

PROPOSED TOTAL COVERED SQFT: (INCLUDES PORCHES, UNFIN. SPACES, ETC.)

ABBREVIATIONS

SCOPE OF WORK

1. RENOVATION OF EXISTING 2 STORY SINGLE FAMILY

DETACHED HOME TO INCLUDE RECONFIGURATION OF MAIN LEVEL, NEW WINDOWS AND DOORS, EXTERIOR

2. NO CHANGE TO EXISTING BUILDING FOOTPRINT.

SIDING REPLACEMENT AND PAINT BRICK.

LAND DISTURBANCE, OR LOT COVERAGE.

AB ANCHOR BOLT A/C AIR CONDITIONING ACT ACOUSTICAL CEILING TILE ADJ ADJUSTABLE AFF ABOVE FINISHED FLOOR AP ACCESS PANEL BD BOARD BIT BITUMINOUS BKG BLOCKING **BLDG BUILDING** BM BEAM BOF BOTTOM OF FOOTING **BRG BEARING** C COURSE CAB CABINET CFM CUBIC FEET PER MINUTE CI CAST IRON CLG CEILING CMU CONCRETE MASONRY UNIT COL COLUMN CONC CONCRETE **CONT CONTINUOUS** CPT CARPET CT CERAMIC TILE CTR CENTER DBL DOUBLE DEM DEMOLISH/DEMOLITION DET DETAIL DH DOUBLE HUNG DIA DIAMETER DIM DIMENSION DN DOWN DR DOOR DS DOWN SPOUT DWG DRAWING EA EACH EL ELEVATION **ENCL ENCLOSURE** EQ EQUAL **EQPT EQUIPMENT** EX EXISTING EXP EXPANSION **EXT EXTERIOR** FBRGL FIBERGLASS FD FLOOR DRAIN FDN FOUNDATION FF FOIL FACE FIN FINISH FL FLOOR FLG FLASHING FOM FACE OF MASONRY FS FULL SIZE FT FOOT OR FEET FTG FOOTING FUR FURRING GA GAUGE GALV GALVANIZED GC GENERAL CONTRACTOR GL GLASS GR GRADE GTR GUTTER GWB GYPSUM WALL BOARD HB HOSE BIB HC HANDICAF HD HEAD HDR HEADER HDW HARDWARE HGR HANGER HOR HORIZONTAL HT HEIGHT HTG HEATING HVAC HEATING VENTILATING AND AIR CONDITIONING HW HOT WATER HWD HARDWOOD ID INSIDE DIAMETER

MAS MASONRY MAX MAXIMUM MECH MECHANICAL MEMB MEMBRANE MFR MANUFACTURER MIN MINIMUM MISC MISCELLANEOUS MLDG MOLDING MO MASONRY OPENING MTD MOUNTED MTL METAL NO/# NUMBER NTS NOT TO SCALE OC ON CENTER OD OUTSIDE DIAMETER OPG OPENING OPP OPPOSITE PC PRECAST CONCRETE PI PI ATF PLAM PLASTIC LAMINATE PLAS PLASTER PNL PANEL PNT PAINT PR PAIR PSF POUNDS PER SQUARE FOOT PSI POUNDS PER SQUARE INCH PVC POLYVINYL CHLORIDE PLY PLYWOOD RAD RADIUS RD ROOF DRAIN REBAR STEEL REINFORCING BAR REC RECESSED REFG REFRIGERATOR REINF REINFORCED REQ. REQUIRED REV REVERSE REF REFERENCE RFG ROOFING RH RIGHT HAND RM ROOM RO ROUGH OPENING RTG RATING SCHD SCHEDULE SECT SECTION SF SQUARE FOOT SHT SHEET SIM SIMILAR SM# SMOOT LUMBER **COMPANY DESIGNATION** SPEC SPECIFICATION SPKR SPEAKER SQ SQUARE S&R SHELF AND ROD STD STANDARD STL STEEL STR STRUCTURE SUSP SUSPENDED SYS SYSTEM T&G TONGUE AND GROOVE TEL TELEPHONE TEMP TEMPERED THK THICK TOF TOP OF FOOTING TOW TOP OF WALL TV TELEVISION TYP TYPICAL UON UNLESS OTHERWISE NOTED VB VAPOR BARRIER VCT VINYL COMPOSITION TILE **VERT VERTICAL** VT VINYL TILE W/ WITH WD WOOD WIN WINDOW W/O WITHOUT WP WATERPROOFING WR WATER RESISTANT WSCT WAINSCOT WT WEIGHT WWF WELDED WIRE FABRIC



DESIGN + BUILD

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> Johnson Residence McGraw

SHEET SIZE:

18" X 24"

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ISSUES/REVISIONS:

No.	Description	Date
	Permit Set	12/14/2021

TITLE:

SHEET:

Cover Sheet

Permit Set

G000

DEC 14,2021

12/14/2021

SCALE: 1/8" = 1'-0" SQUARE PROJECT TEAM INSULATION VALUES ALL INSULATION "R/U" VALUES PER **GENERAL CONTRACTOR:** SECTION 402.1, 2018 IECC & 2018 VIRGINIA RESIDENTIAL CODE (VRC 2018). AS NOTED: TRI-VISTA USA DESIGN + BUILD, LLC. **BASMENT WALLS:** 925 N. GARFIELD ST, SUITE 106 R-13 SPRAY FOAM INSULATION ARLINGTON, VIRGINIA 22201

EXTERIOR WALL R-VALUE: R-20 SPRAY FOAM INSULATION **FLOOR R-VALUE:** R-19 SPRAY FOAM INSULATION **CEILING R-VALUE:** R-49 SPRAY FOAM INSULATION

PROPOSED NEW DOORS & WINDOWS U VALUE : SHGC:

INSULATION FOR NEW DUCTWORK IN **UNCONDITIONED SPACES** R-VALUE: R-8 MIN.

INSULATION FOR NEW HVAC PIPING & HOT WATER PIPES

R-VALUE:

R-3 MIN.

(INCLUDES PORCHES, UNFIN. SPACES, ETC.)


PROPOSED TOTAL FINISHED SQFT:

LOWER LEVEL -±679 SQ FT.

PROPOSED TOTAL UNFINISHED SQFT:

±3,322 SQ FT.


(NO CHANGES TO THE MAIN BUILDING FOOTPRINT)

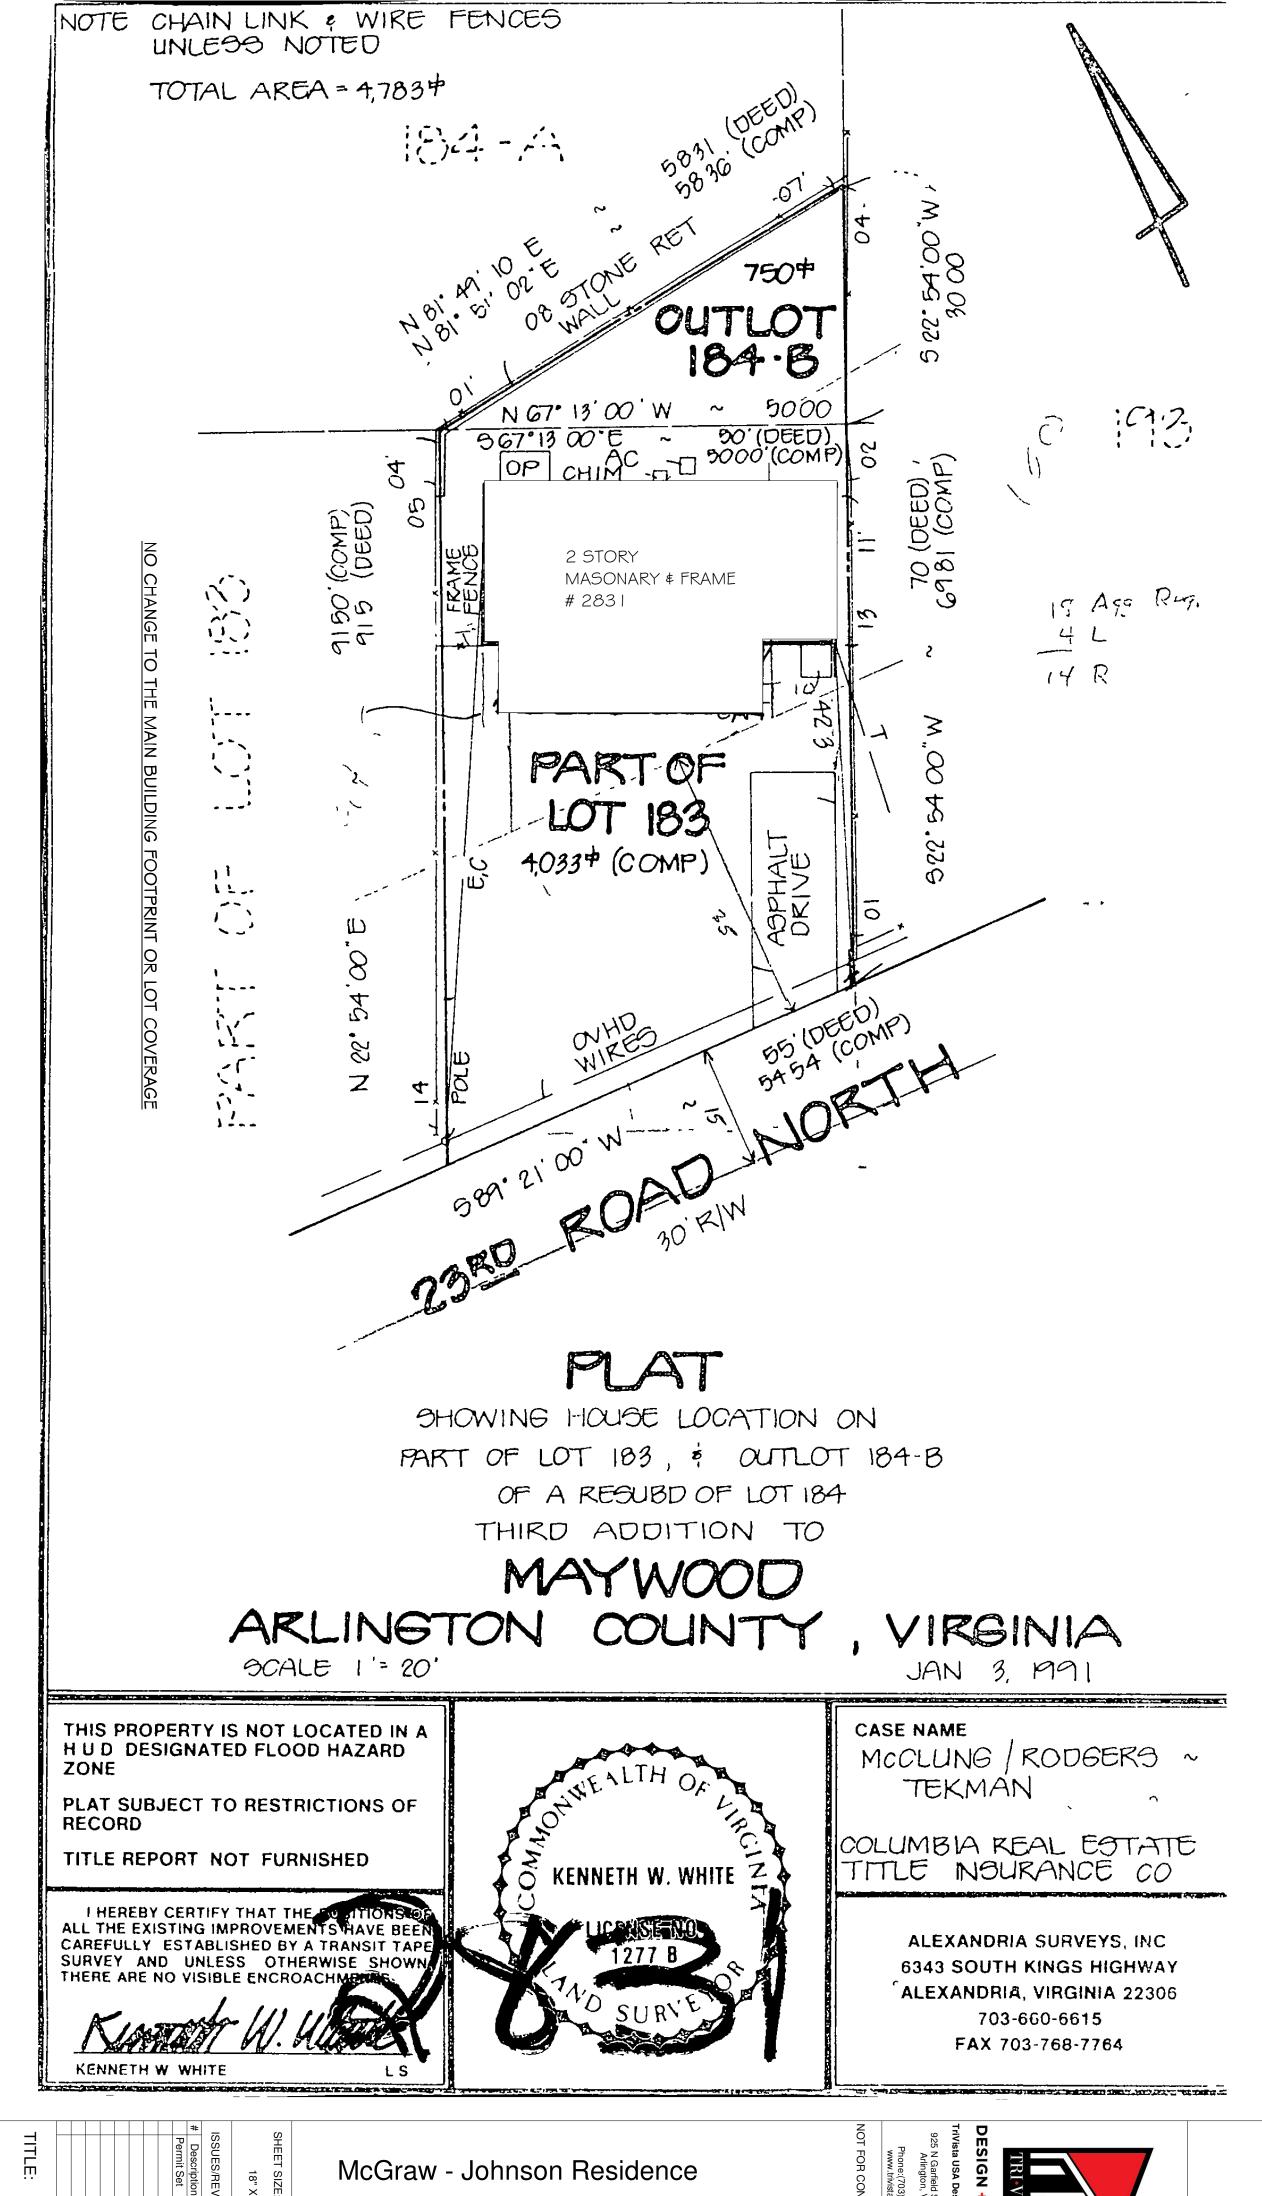

2831 23rd Rd N, Arlington, VA 22201

N Garfield St., Suite #106 Arlington, VA 22201



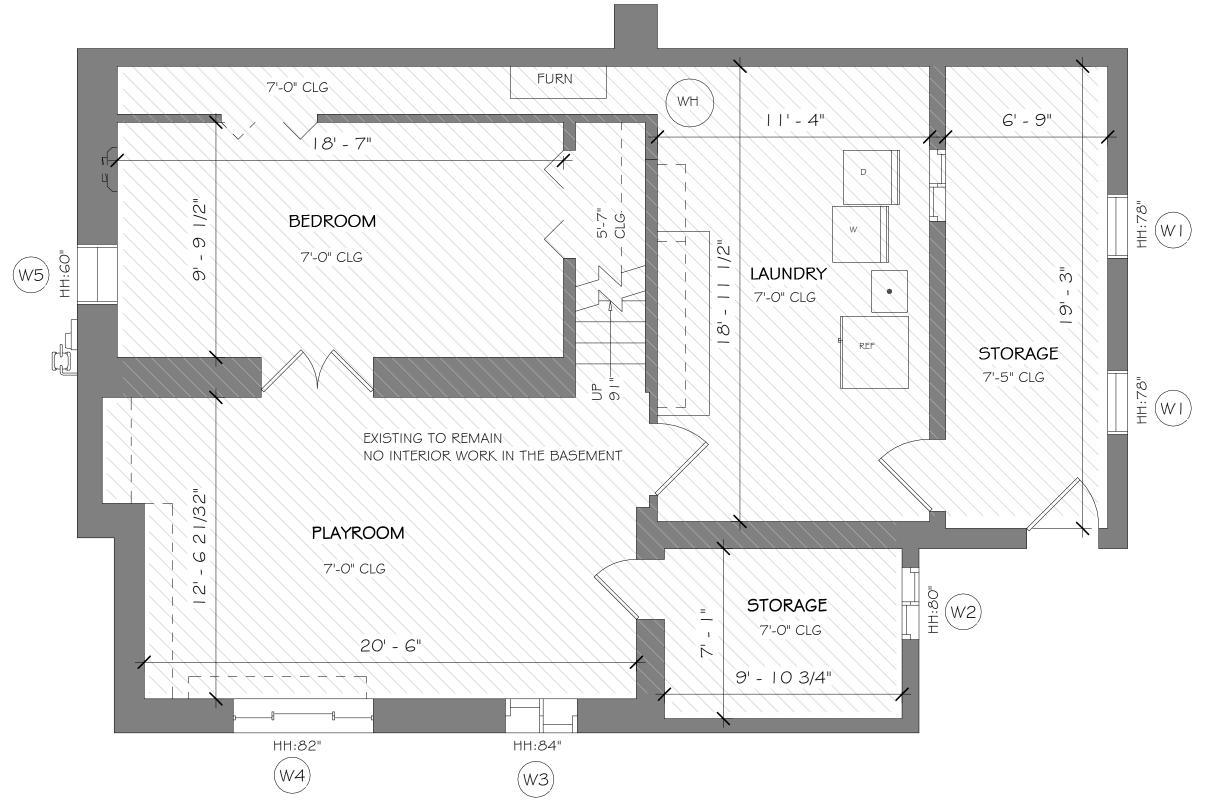

Proposed basement level plan
1/4" = 1'-0"

EXISTING TO REMAIN

GENERAL NOTES:

- ALL DIMENSIONS +/-, TO BE VERIFIED IN
- ALL DOORS AND WINDOWS TO REMAIN UNCHANGED UNLESS NOTED ON PROPOSED
- EXISTING FLOORING TO REMAIN, PATCH AS REQ'D., UNLESS NOTED ON PROPOSED PLANS. - PLANS SHOWN ARE PRELIMINARY, SUBJECT TO CHANGE PENDING STRUCTURAL REVIEW FROM STRUCTURAL ENGINEER.
- ALL WOOD TRIM WORK TO MATCH EXISTING

____ FLOOR MATERIAL BREAK

NOTE: WINDOWS:

REPLACE ALL WINDOWS IN THE BASEMENT (SAME SIZE).

PLUMBING:

- SECURE WATE LINES IN THE BASEMENT (2) HOSE BIBS

	WINDOW SCHEDULE				
ID	TYPE	#	W	HT	
WI	FIXED PANEL (REPLACEMENT)	2	31 1/2"	14 1/2"	
W2	CASEMENT (REPLACEMENT)	I	37"	37"	
W3 CASEMENT (REPLACEMENT) 34" 32"		32"			
W4	FIXED#CASEMENT (REPLAC.)	I	69"	32"	
W5	EXISTING TO REMAIN	I	-	_	

W5 WINDOW FRAME TO BE PAINTED BLACK

BOD: LINCOLN WINDOW

- ALUM. CLAD

- INT. \$ EXT. COLOR: BLACK - HARDWARE: BLACK

WINDOW ELEVATION



DESIGN + BUILD

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McGraw

SHEET SIZE:

18" X 24"

ISSUES/REVISIONS:		
#	Description	Date
	Permit Set	12/14/20

TITLE:

Proposed basement level plan

SHEET:

A001 DEC 14,2021


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Arlington, VA 22201

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- STAIR

Bottom

WAREHOUSE #:

6040 Round Flat

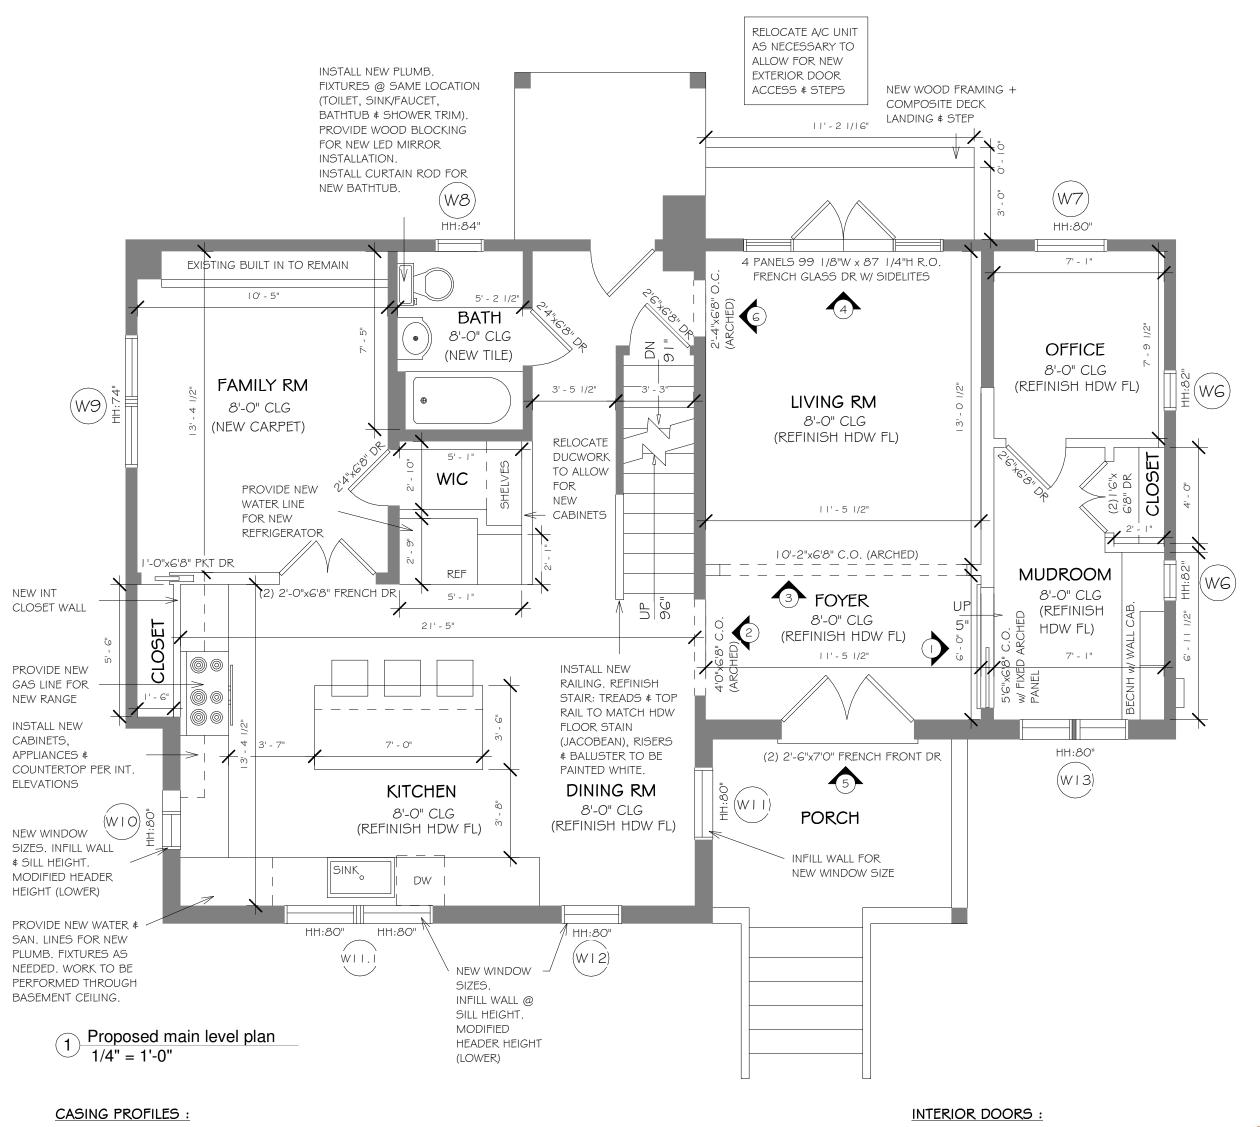STAIN: JACOBEAN

I" ROUND BALUSTERS

\$ STAIN MATCHING HDW FLOOR (JACOBEAN)

STAIR RISERS TO BE PAINTED WHITE.

PAINTED WHITE

- STAIR TREADS TO BE RENIFISHED

NOTE:

Top Rail typ. detail

BEADED CASING

PAINTED WHITE

PRIMED FJ

ADAMS BACKBAND

3" = 1'-0"

3" = 1'-0"

A GRADE PINE PAINTED WHITE

WM-97-B (| |/|6" x | 3/8")

Windows & doors casing typ. detail

PANEL MOULD

3" GAP BETWEEN

BASE CAPE # BASE

PAINTED DRYWALL

OGEE BASE

9/16" x 3 1/4" PRIMED FJ

WM-623

4) Main level basement profile typ detail

SM-D7P 5/16" x 7/8"

POPLAR

WM-371 (11/16" x 2 3/4")

NOTES:

HVAC:

-RELOCATE A/C UNIT TO ALLOW FOR NEW SLIDING DOOR \$ STEPS.

- RELOCATE DUCTWORK AS NEEDED TO COMPLY WITH NEW DESIGN AT WIC.

DRYWALL:

-REPAIR/PATCH DRYWALL READY FOR PAINT AT RENOVATED AREAS. REPAIR \$ PATCH BASEMENT CEILING AFTER PLUMBING & DUCTWORK.

WOOD TRIM:

- INSTALL NEW BASEBOARD IN THE ENTIRE MAIN LEVEL. SEE DETAIL FOR NEW PROFILE.
- PROVIDE \$ INSTALL NEW WOOD SHELF \$ ROD FOR ALL NEW CLOSETS.

FLOORING:

- PROVIDE \$ INSTALL NEW OAK HDW FLOOR IN THE LIVING ROOM AND KITCHEN
- AS NEEDED. REFINISH HDW FLOOR \$ INSTALL NEW SHOW MOLDING IN THE ENTIRE MAIN LEVEL \$ STAIR(MAIN TO SECOND LEVEL).
- INSTALL NEW CARPET IN THE FAMILY ROOM.

PAINTING:


- AREAS TO BE PAINTED: ENTIRE MAIN LEVEL AND BASEMENT CEILING AFTER PLUMBING \$ DUCTWORK.
- PAINT ALL WOOD TRIM IN THE ENTIRE MAIN LEVEL.

GENERAL NOTES:

- ALL DIMENSIONS +/-, TO BE VERIFIED IN
- FIELD.
- ALL DOORS AND WINDOWS TO REMAIN UNCHANGED UNLESS NOTED ON PROPOSED PLANS.
- EXISTING FLOORING TO REMAIN. PATCH AS REQ'D., UNLESS NOTED ON PROPOSED PLANS.
- PLANS SHOWN ARE PRELIMINARY, SUBJECT TO CHANGE PENDING STRUCTURAL REVIEW FROM STRUCTURAL ENGINEER.
- ALL WOOD TRIM WORK TO MATCH EXISTING

____ FLOOR MATERIAL BREAK

WINDOW SCHEDULE				
ID	TYPE	#	W	HT
W6	DOUBLE HUNG (REPLACEMENT)	2	20"	481/2"
W7	DOUBLE HUNG (REPLACEMENT)	I	37 3/8"	48 1/2"
W8	DOUBLE HUNG (REPLACEMENT)	ı	25 3/8"	44 1/2"
W9	DOUBLE HUNG (REPLACEMENT)	ı	66 3/4"	36 1/2"
WIO	DOUBLE HUNG (NEW R.O.)	1	18"	36 1/2"
WII	DOUBLE HUNG (NEW R.O.)	1	35 3/8"	36 1/2"
WII.I	DOUBLE HUNG (NEW R.O.)	1	66"	36 1/2"
WI2	DOUBLE HUNG (NEW R.O.)	1	29 3/8"	36 1/2"
WI3	DOUBLE HUNG (REPLACEMENT)	1	55"	48 1/2"
			•	

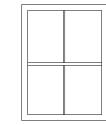


BOD: LINCOLN WINDOW

- ALUM. CLAD
- INT. \$ EXT. COLOR: BLACK
- HARDWARE: BLACK

WINDOW ELEVATION

1/4"= | '-0"


EXTERIOR DOORS :

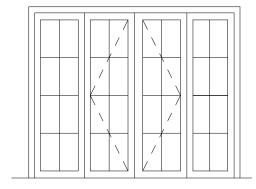

1/4"=1'-0"

LINCOLN FRENCH DOOR -BLACK ALUM. CLAD

- SQUARE EXTERIOR 7/8" SDL - INT. \$EXT. BLACK - OUTSWING - 3 3/8" STILES/TOP RAIL
- (DIMENSION ON THE PLAN)

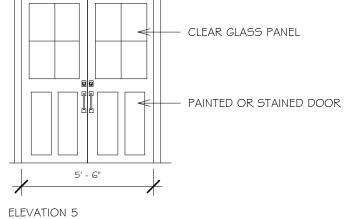

ELEVATION 4 1/4"= 1'-0"



ARCHED CASING

CLEAR GLASS

(FIXED PANEL)

- PAINTED WOOD

DOOR CASING

PAINTED

WOOD

OPENING

CASING

ELEVATION I

CASED OPENING ELEVATIONS


ELEVATION 2

1/4"=1'-0"


1/4"=1'-0"


PAINTED WOOD PANEL

PAINTED WOOD DOOR PANEL. COLOR WHITE ALL INT. DOOR

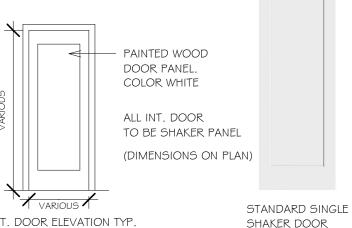



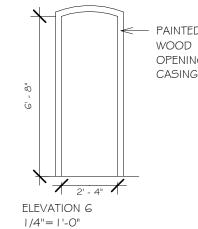

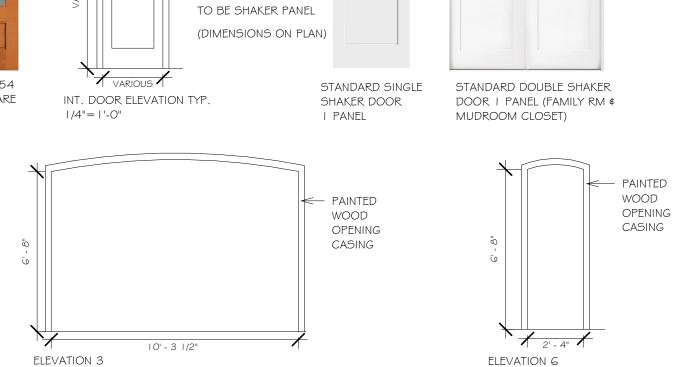

SHEET SIZE:

18" X 24" ISSUES/REVISIONS: # Description Date Permit Set 12/14/2021

TITLE:

Proposed main level plan

SHEET:

A002 DEC 14,2021

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Johnson Residence 2831 23rd Rd N, Arlington, VA McGraw

SHEET SIZE:

18" X 24"

ISSUES/REVISIONS: # Description Date
Permit Set 12/14/2021


TITLE:

Proposed second level plan

SHEET:

A003 DEC 14,2021

INSTALL NEW RAILING. TREADS \$ TOP RAIL TO MATCH HARDWOOD FLOOR STAIN, RISERS & BALUSTER TO BE PAINTED WHITE.

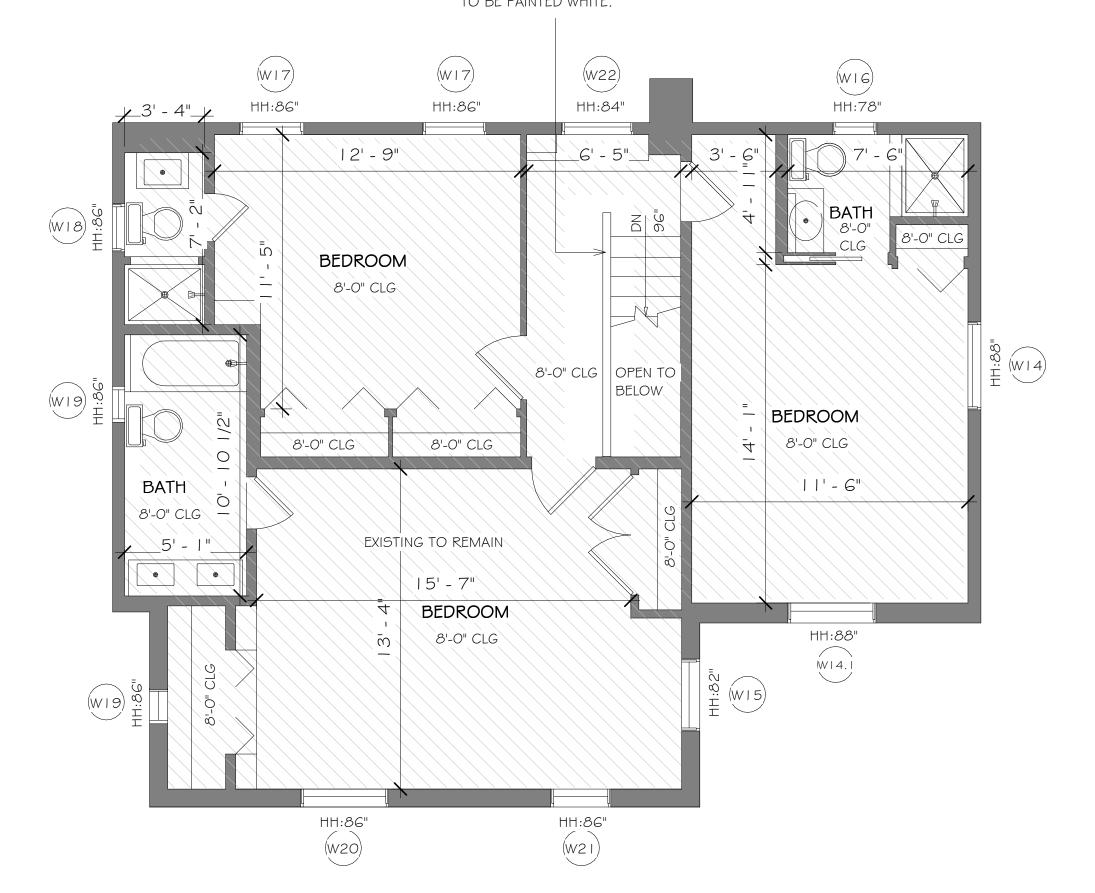

EXISTING TO REMAIN

Proposed second level plan
1/4" = 1'-0"

GENERAL NOTES:

- ALL DIMENSIONS +/-, TO BE VERIFIED IN
- ALL DOORS AND WINDOWS TO REMAIN UNCHANGED UNLESS NOTED ON PROPOSED
- EXISTING FLOORING TO REMAIN, PATCH AS REQ'D., UNLESS NOTED ON PROPOSED PLANS. - PLANS SHOWN ARE PRELIMINARY, SUBJECT TO CHANGE PENDING STRUCTURAL REVIEW FROM STRUCTURAL ENGINEER.
- ALL WOOD TRIM WORK TO MATCH EXISTING

____ FLOOR MATERIAL BREAK

	WINDOW SCHEDULE			
ID	TYPE	#	W	HT
WI4	DOUBLE HUNG (REPLACEMENT)	1	45 3/8"	52 1/2"
W14.1	DOUBLE HUNG (REPLACEMENT)	1	41 3/8"	52 1/2"
WI5	DOUBLE HUNG (REPLACEMENT)	1	33 3/8"	36 1/2"
WI6	DOUBLE HUNG (REPLACEMENT)	1	23 3/8"	40 1/2"
WI7	DOUBLE HUNG (REPLACEMENT)	2	33 3/8"	48 1/2"
WI8	DOUBLE HUNG (REPLACEMENT)	1	25 3/8"	48 1/2"
WI9	DOUBLE HUNG (REPLACEMENT)	2	21 3/8"	48 1/2"
W20	DOUBLE HUNG (REPLACEMENT)	I	45 3/8"	52 1/2"
W21	DOUBLE HUNG (REPLACEMENT)	1	3 3/8"	52 1/2"
W22	DOUBLE HUNG (REPLACEMENT)	I	37 3/8"	44 1/2"

BOD: LINCOLN WINDOW - ALUM. CLAD - INT. \$ EXT. COLOR: BLACK

- HARDWARE: BLACK

WINDOW ELEVATION

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Matte Black

18" X 24"

SHEET:


A004 DEC 14,2021

MAJOR RIDGE BEDROOM F.C.E. BRICK TO BE PAINTED 2ND FLOOR F.F.E. DINING F.C.E. 2ND FLOOR F.F.E. STORAGE F.C.E. IST FLOOR F.F.E. EX DOOR TO REMAIN

Proposed south elevation 1/4" = 1'-0"



- PATIO DOOR: FRENCH STYLE LINCOLN DOOR W/ SIDELIGHTS PRIMARY RIGHT DOOR/ SECONDARY LEFT DOOR BLACK ALUM. CLAD & HARDWARE PER MANIF.

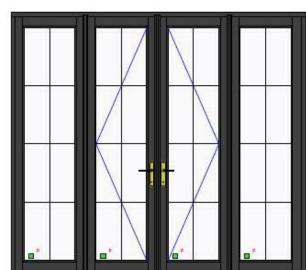

FRONT ELEVATION - NO SCALE (DIAGONAL LINES REPRESENT OPENING DIRECTION)

- DOUBLE HUNG LINCOLN WINDOWS

WINDOWS:

2 PANELS WINDOW



INSPIRATIONAL PHOTO




SINGLE WINDOW








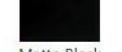



7/8" Bar CONTEMPORARY (SQUARE)

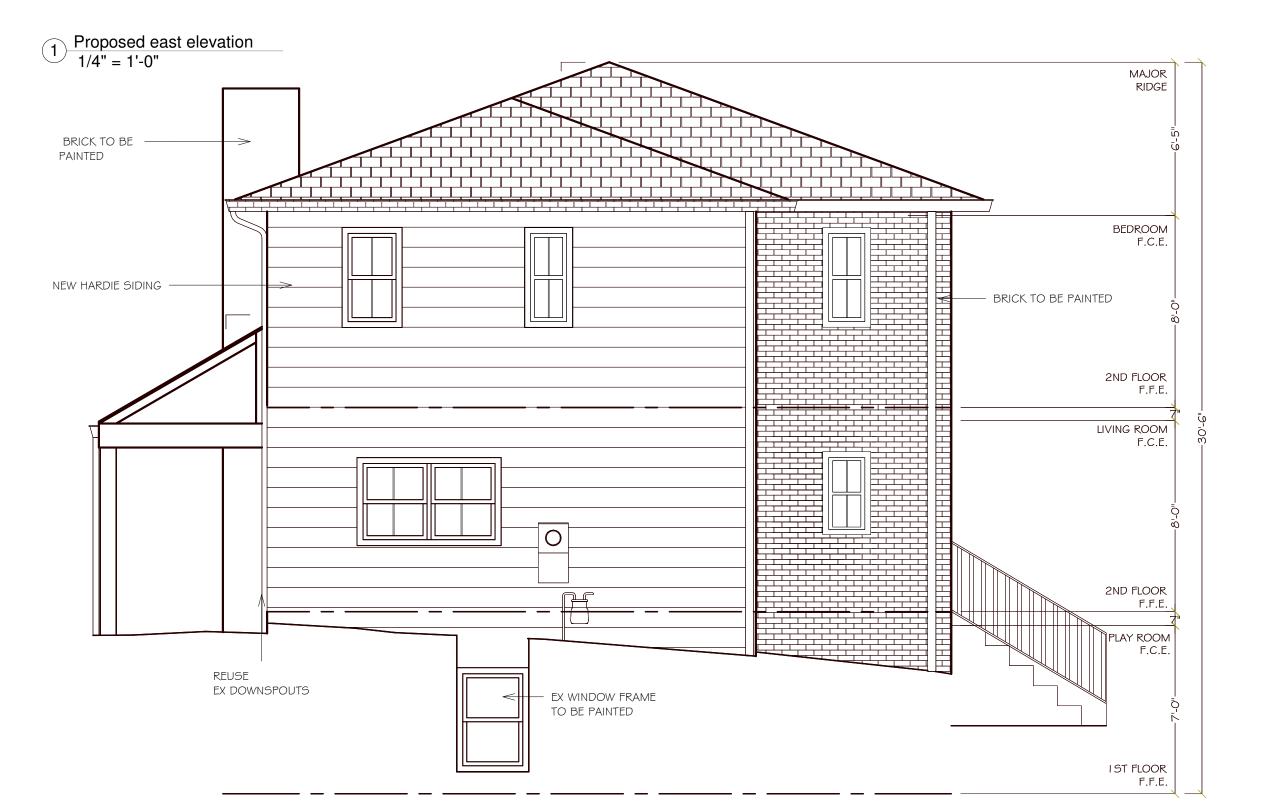

Proposed west elevation
1/4" = 1'-0"



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SHEET SIZE:

ISSUES/REVISIONS:

18" X 24"

Description Date
Permit Set 12/14/2021

TITLE:

Proposed elevations

SHEET:


A005
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GENERAL NOTES:

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- EXISTING FLOORING TO REMAIN, PATCH AS REQ'D., UNLESS NOTED ON PROPOSED PLANS. - PLANS SHOWN ARE PRELIMINARY, SUBJECT TO CHANGE PENDING STRUCTURAL REVIEW FROM STRUCTURAL ENGINEER.

NOTE:

- ALL BASEMENT WINDOWS TO BE REPLACED WITHIN THE SAME R.O. SIZES - REMOVE EXISTING SIDING TO ALLOW FOR NEW HARDIE SIDING.

Demo basement level plan
1/4" = 1'-0"

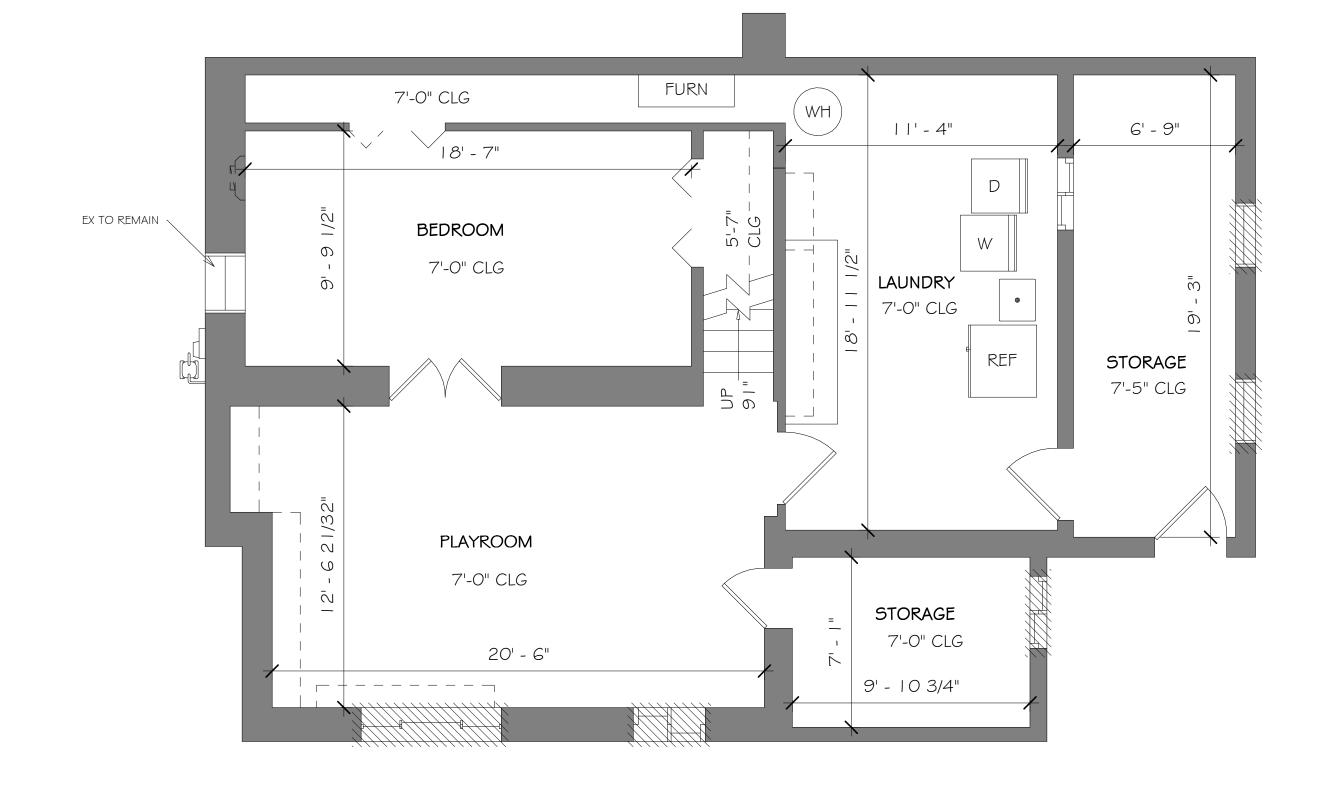

TO BE REMOVED OR ALTERED

SHEET SIZE: 18" X 24"

ISSUES/REVISIONS:

	ISSUES/REVISIONS:		
#	Description	Date	
	Permit Set	12/14/2021	
		# Description	

TITLE:

Basement demo plan

SHEET:


D001 DEC 14,2021

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NOT FOR CONSTRUCTION



GENERAL NOTES:

- ALL DIMENSIONS +/-, TO BE VERIFIED IN FIELD.
- ALL DOORS AND WINDOWS TO REMAIN
UNCHANGED UNLESS NOTED ON PROPOSED
PLANS.

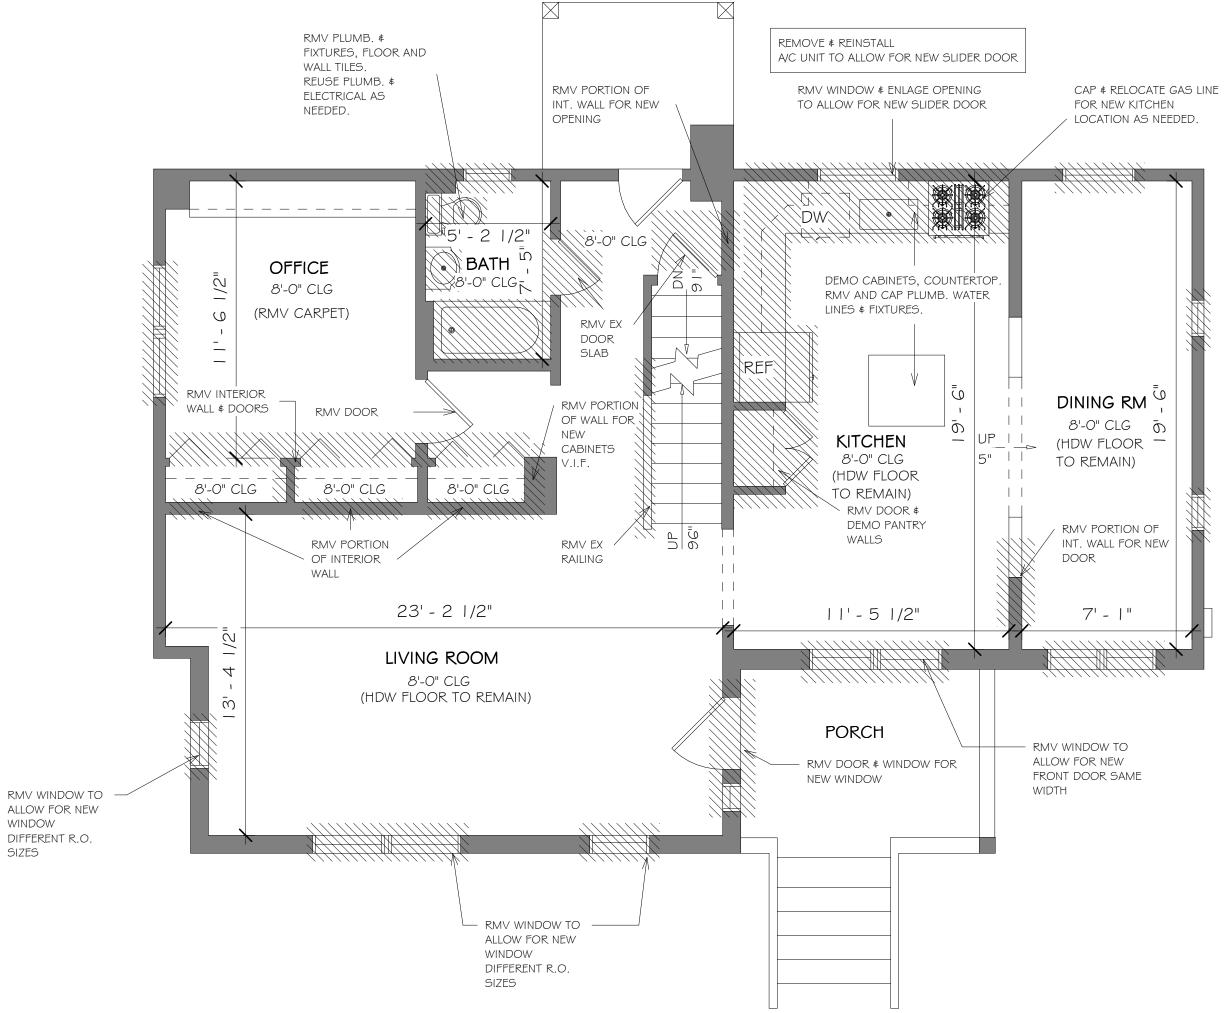- EXISTING FLOORING TO REMAIN, PATCH AS REQ'D., UNLESS NOTED ON PROPOSED PLANS.
- PLANS SHOWN ARE PRELIMINARY, SUBJECT TO CHANGE PENDING STRUCTURAL REVIEW FROM STRUCTURAL ENGINEER.

NOTE:

- ALL MAIN LEVEL WINDOWS TO BE REPLACED WITHIN THE SAME R.O. SIZES, UNLESS NOTED ON THE PLANS.
- REMOVE EXISTING SIDING TO ALLOW FOR NEW HARDIE SIDING
- REMOVE BASEBOARD AND WINDOW/DOOR CASING IN THE ENTIRE MAIN LEVEL TO ALLOW FOR NEW WOOD TRIM.
- COORDINATE ITEMS TO BE SAVED OR DONATED W/ CLIENT BEFORE DEMOLITION.

18" X 24"

ISSUES/REVISIONS:

#	Description	Date
	Permit Set	12/14/2


TITLE:

Main level demo plan

SHEET:

D002
DEC 14,2021

Demo main level plan 1/4" = 1'-0"

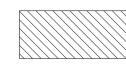

TO BE REMOVED OR ALTERED





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2831 23rd Rd N, Arlington, VA McGraw

SHEET SIZE: 18" X 24"

ISSUES/REVISIONS:


#	Description	Date
	Permit Set	12/14/20

TITLE:

Second level demo plan

SHEET:

D003 DEC 14,2021

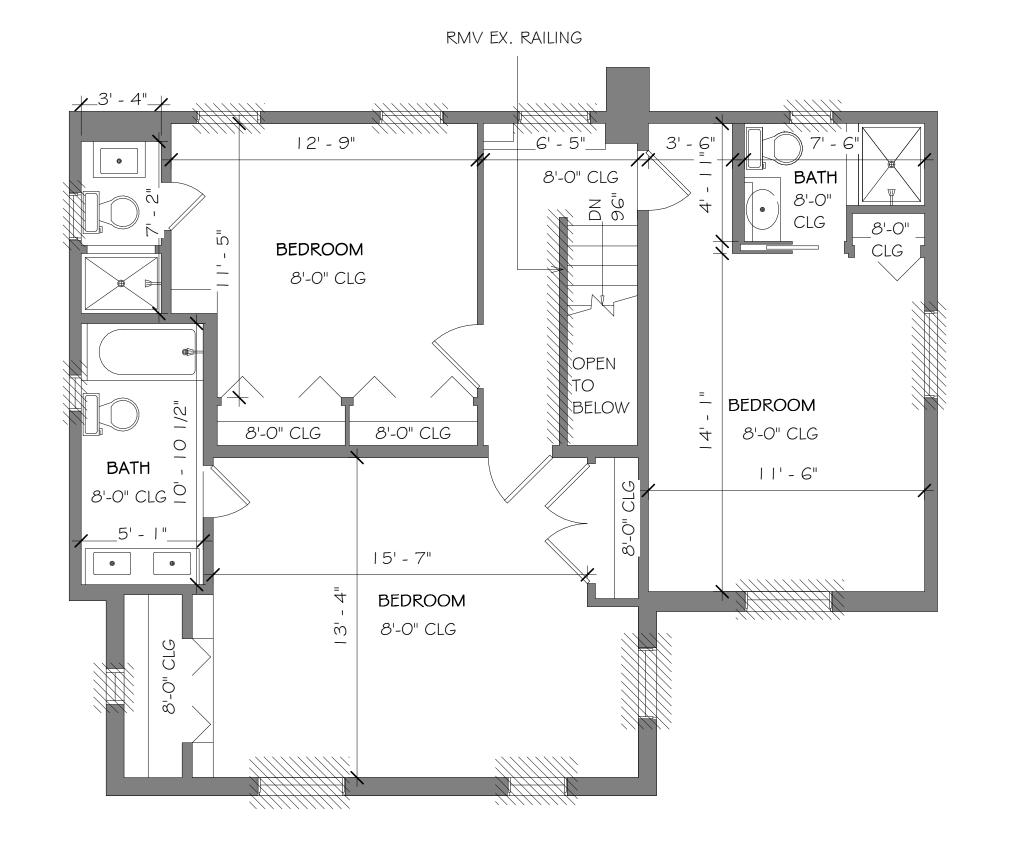

Demo second level plan
1/4" = 1'-0"

TO BE REMOVED OR ALTERED

GENERAL NOTES:

- ALL DIMENSIONS +/-, TO BE VERIFIED IN FIELD. - ALL DOORS AND WINDOWS TO REMAIN UNCHANGED UNLESS NOTED ON PROPOSED PLANS.
- EXISTING FLOORING TO REMAIN, PATCH AS REQ'D., UNLESS NOTED ON PROPOSED PLANS. - PLANS SHOWN ARE PRELIMINARY, SUBJECT TO CHANGE PENDING STRUCTURAL REVIEW FROM STRUCTURAL ENGINEER.

NOTE:

- ALL SECOND LEVEL WINDOWS TO BE REPLACED WITHIN THE SAME R.O. SIZES
- REMOVE EXISTING SIDING TO ALLOW FOR NEW HARDIE SIDING

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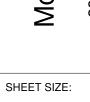
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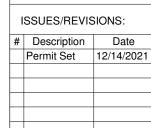
NOTE:

- ALL WINDOWS TO BE REPLACED

ON PLANS & ELEVATIONS.

WITHIN THE SAME R.O. SIZES, UNLESS NOTED






18" X 24"

TITLE:

Existing elevation demo

SHEET:

D004
DEC 14,2021

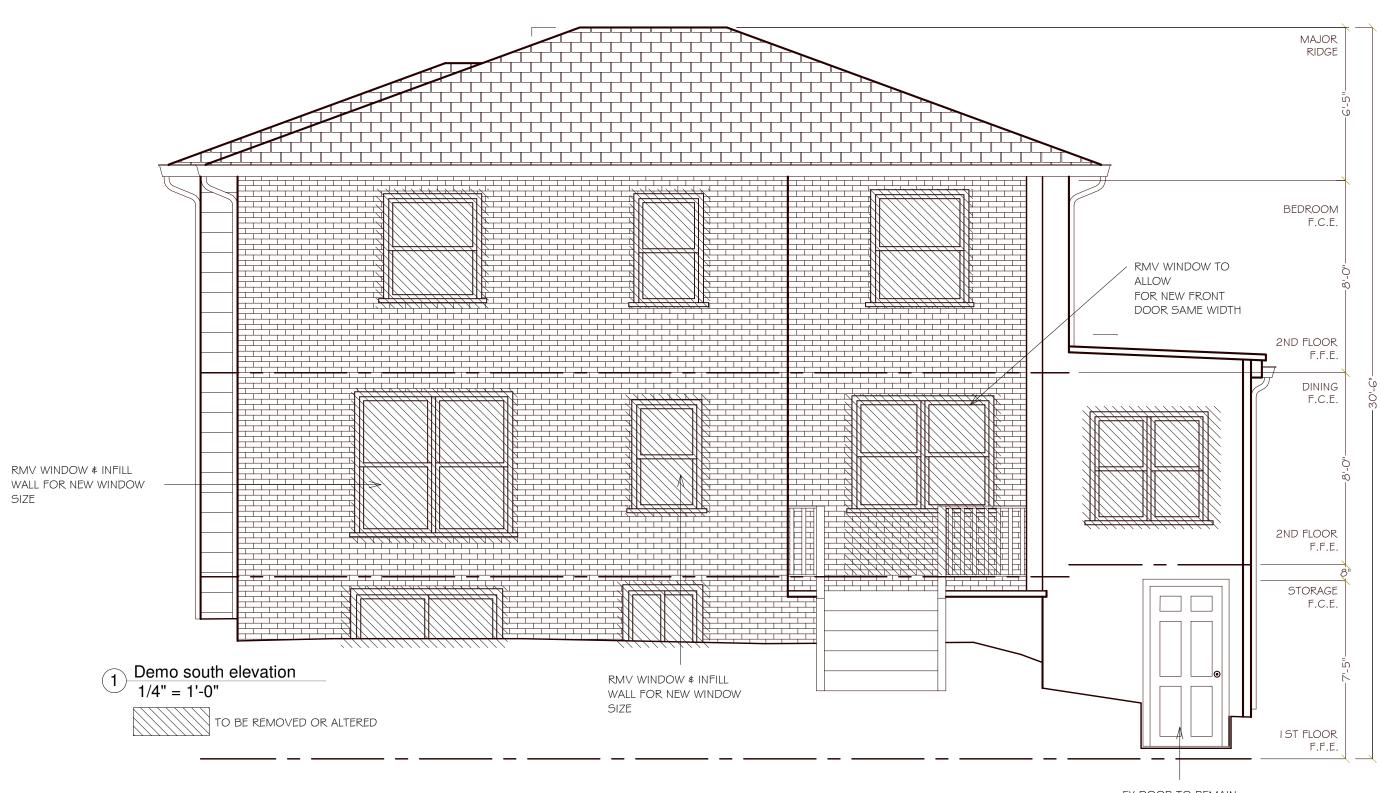



TO BE REMOVED OR ALTERED

SHEET SIZE:

TITLE:

SHEET:

18" X 24"

Description Date
Permit Set 12/14/2021

Existing elevation demo

D005

DEC 14,2021

ISSUES/REVISIONS:


DESIGN + BUILD

TriVista USA Design Build, LLC

925 N Garfield St., Suite #106 Arlington, VA 22201

Phone:(703)243 3171 www.trivistausa.com

NOT FOR CONSTRUCTION

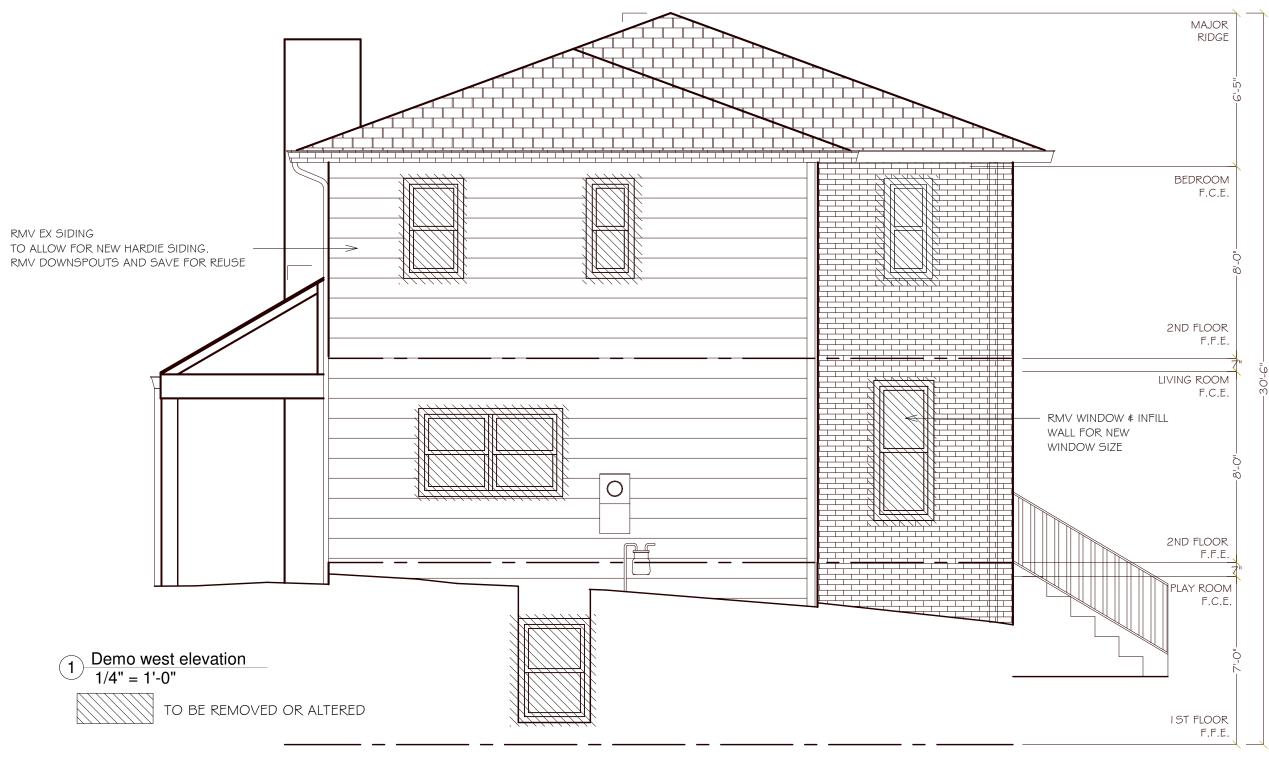

RMV DOOR \$
WINDOW FOR NEW
WINDOW SIZE


Demo east elevation

1/4" = 1'-0"


TO BE REMOVED OR ALTERED



- ALL WINDOWS TO BE REPLACED
WITHIN THE SAME R.O. SIZES, UNLESS NOTED
ON THE PLANS & ELEVATIONS.

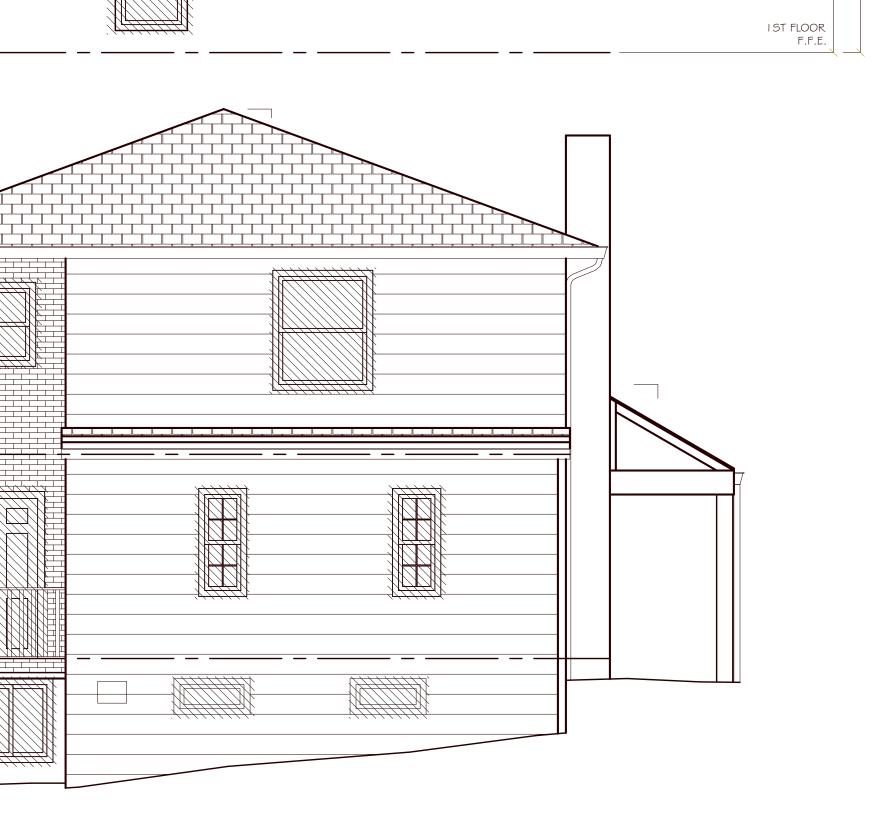

EXISTING TO REMAIN

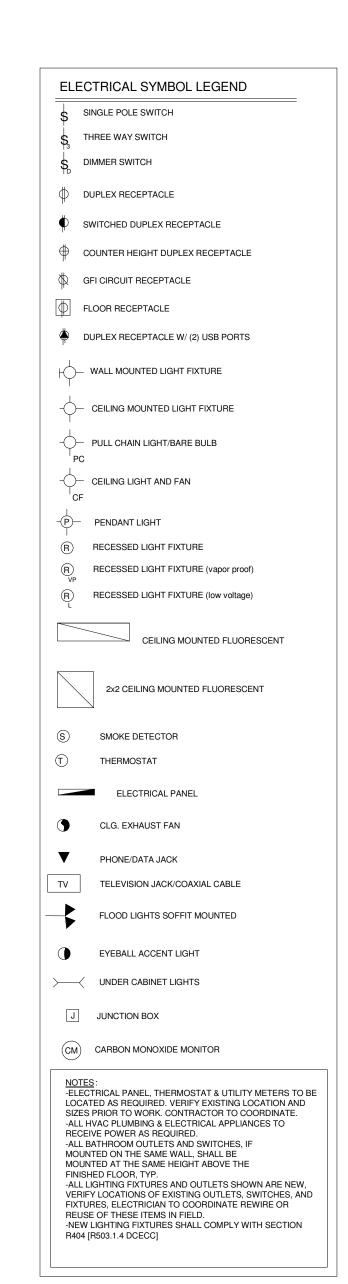

USA TRI-VISTA

DESIGN + BUILD

TriVista USA Design Build, LLC 925 N Garfield St., Suite #106 Arlington, VA 22201

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NOT FOR CONSTRUCTION

McGraw - Johnson Residence 2831 23rd Rd N, Arlington, VA 22201

SHEET SIZE:

ISSUES/REVISIONS:

18" X 24"

Description Date
Permit Set 12/14/2021

TITLE:

Proposed main level electrical plan

SHEET:

E001

DEC 14,2021



BEDROOM

BEDROOM

8'-0" CLG

3 Existing second level plan
1/8" = 1'-0"

11' - 6"

44X54 HH:88

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NOT FOR CONSTRUCTION

Johnson Residence 2831 23rd Rd N, Arlington, VA 22201 McGraw

SHEET SIZE:

ISSUES/REVISIONS: # Description Date
Permit Set 12/14/2021

18" X 24"

TITLE:


Existing plans & elevations

SHEET:

G001 DEC 14,2021

BEDROOM 7'-0" CLG LAUNDRY REF STORAGE 7'-5" CLG PLAYROOM 7'-0" CLG STORAGE 7'-0" CLG

1 Existing basement level plan 1/8" = 1'-0"

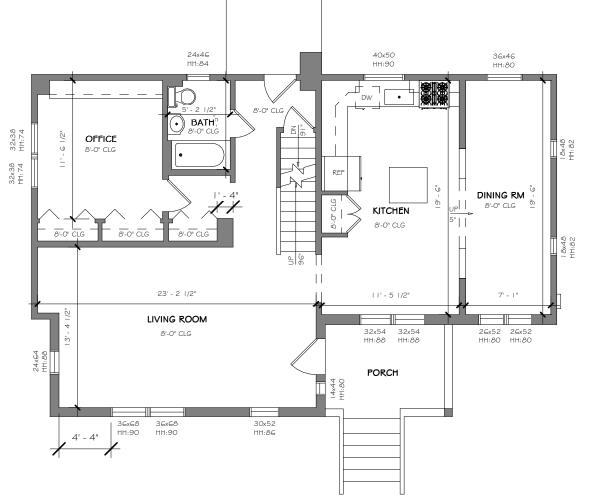


2 Existing main level plan 1/8" = 1'-0"



4 Existing south elevation 1/8" = 1'-0"



6 Existing north elevation 1/8" = 1'-0"

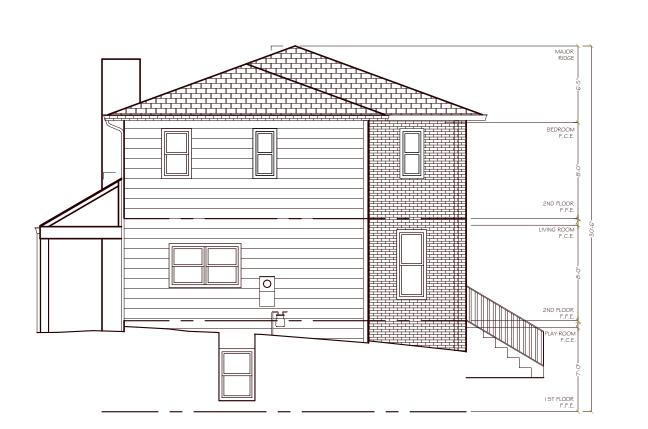

5 Existing west elevation 1/8" = 1'-0"



Existing east elevation
1/8" = 1'-0"

STRUCTURAL NOTES

1 GENERAL

- A. THE BUILDING MODIFICATION IS DESIGNED UNDER THE PROVISIONS OF THE 2018 VIRGINIA UNIFORM STATEWIDE BUILDING CODE (VUSBC).
- B. THE FOLLOWING LIVE LOADS WERE UTILIZED IN THE DESIGN:

 ROOF

 30 PS

LIVING AREAS 40 PSF
SLEEPING ROOMS 30 PSF

ROOF SNOW LOAD

GROUND SNOW LOAD (Pg)

WIND LOAD

BASIC WIND SPEED (V3s)

IMPORTANCE FACTOR (Iw)

WIND EXPOSURE

25 PSF

115 MPH

1.0

B

DEAD LOAD ARE USED AS FOLLOWS UNLESS NOTED OTHERWISE:

ROOF RAFTER 10 PSF CEILING JOIST 7 PSF 2ND FLOOR 10 PSF 1ST FLOOR 10 PSF

- C. THE BASIC STABILITY OF THE STRUCTURE IS DEPENDENT UPON THE DIAPHRAGM ACTION OF FLOORS, WALLS & ROOF ACTING TOGETHER. CONTRACTOR TO PROVIDE ALL GUYS, BRACES, STRUTS, ETC. AS REQUIRED TO ACCOMMODATE ALL LIVE, DEAD AND WIND LOADS UNTIL ALL FINAL CONNECTIONS BETWEEN THESE ELEMENTS ARE MADE.
- D. BASEMENT AND FOUNDATION WALLS ARE DEPENDENT UPON THE COMPLETED INSTALLATION OF FLOORS FOR THEIR STABILITY. CONTRACTOR SHALL NOT PLACE BACKFILL UNTIL THESE ELEMENTS ARE COMPLETELY INSTALLED, OR CONTRACTOR HAS PROVIDE SHORING AND BRACING TO ADEQUATELY RESTRAIN WALL.
- E. THE STRUCTURAL INTEGRITY OF THE BUILDING SHOWN ON THESE PLANS IS DEPENDENT UPON COMPLETION ACCORDING TO PLANS AND SPECIFICATIONS. STRUCTURAL MEMBERS ARE NOT SELF BRACING UNTIL PERMANENTLY AFFIXED TO THE STRUCTURE AS DIRECTED. THE STRUCTURAL ENGINEERS ASSUME NO LIABILITY FOR THE STRUCTURE DURING ARE INCLUDED IN THE PLANS AND SPECIFICATIONS OR ARE SUPERVISED BY THE STRUCTURAL ENGINEERS DURING CONSTRUCTION.

2 EARTHWORK

- A. SOIL BEARING VALUE AT THE BOTTOM OF ALL FOOTINGS IS ASSUMED TO BE 1500 PSF. THIS VALUE IS TO BE VERIFIED IN THE FIELD PRIOR TO POURING FOOTINGS BY A REGISTERED ENGINEER EXPERIENCED IN SOILS ENGINEERING OR BY A QUALIFIED INSPECTOR.
- B. BOTTOM OF ALL EXTERIOR FOOTINGS SHALL BE A MINIMUM OF 2'-0" BELOW FINISH EXTERIOR GRADE. WHERE REQUIRED, STEP FOOTINGS IN RATIO OF 2 HORIZONTAL TO 1 VERTICAL.
- C. COMPACTED BACKFILL BELOW BUILDING SLABS ALL SOIL FILL MATERIAL MUST BE APPROVED BY SOILS ENGINEER PRIOR TO PLACEMENT. MATERIALS TO BE FREE FROM ORGANIC MATERIAL, TRASH, MUCK, CONCRETE, ASPHALT OR OTHER DELETERIOUS SUBSTANCES. PRIOR TO PLACING FILL, THE EXISTING SURFACE SHALL BE CLEARED OF ALL REFUSE OR ORGANIC MATERIALS. FILL MATERIAL SHALL BE PLACED IN LAYERS NOT TO EXCEED 8" AND COMPACTED TO MIN. 95% OF THE DRY MAX. DENSITY AS DETERMINED BY ASTM D698.
- D. FOUNDATION WALLS ARE DESIGNED FOR A LATERAL EARTH PRESSURE OF 60 PCF ASSUMING A FREE DRAINING MATERIAL OR DRAINING BOARD BEHIND WALL WITH A PERIMETER DRAINTILE SYSTEM. NOTIFY ENGINEER IF SOIL CONDITIONS DIFFER.

3 DEMOLITION

- A. PROVIDE ADEQUATE SHORING, BRACING AND OTHER TEMPORARY SUPPORT DURING DEMOLITION. RETAIN THE SERVICE OF A QUALIFIED SPECIALTY ENGINEER TO DESIGN AND MONITOR THE TEMPORARY SUPPORT. SUBMIT DRAWINGS FOR RECORD ONLY.
- B. UNTIL PROPERLY SHORED, DO NOT CUT EXISTING STRUCTRUAL MEMBER IN A MANNER RESULTING IN A REDUCTION OF LOAD—CARRYING CAPACITY. DO NOT EXCEED THE CAPACITY OF THE EXISTING STRUCTURE WITH SUPERIMPOSED LOADS.
- C. IN GENERAL, SELECTIVE STRUCTURAL DEMOLITION IS TO BE PERFORMED WITH PHYSICAL CUTTING ACTION (I.E.SAWING AND GRINDING INSTEAD OF HAMMERING AND CHOPPING). DO NOT USE JACKHAMMERS ON STRUCTURALLY SUPPORTED MEMBERS.
- D. CONTRACTOR SHALL VERIFY THAT EXISTING CONSTRUCTION CORRESPONDS TO THAT SHOWN ON THE DRAWINGS. DISCREPANCIES SHALL BE IMMEDIATELY BROUGHT TO THE ATTENTION OF THE ARCHITECT/ENGINEER.

4 WOOD

- A. ALL FRAMING LUMBER SHALL BE HEM-FIR, GRADE #2, OR SPRUCE-PINE-FIR GRADE #2, OR BETTER, HAVING THE FOLLOWING MINIMUM BASE DESIGN VALUES:
- -BENDING STRESS "Fb" = 850 PSI FOR SINGLE MEMBER USE -HORIZONTAL SHEAR "Fv" = 135 PSI
- COMPRESSION PERPENDICULAR TO GRAIN "Fc" = 405 PSI
- -COMPRESSION PARALLEL TO GRAIN "Fc11" = 1,150 PSI
 -MODULUS OF ELASTICITY "E" = 1,300,000 PSI
- NOTE: SPRUCE-PINE-FIR (SOUTH) IS NOT ACCEPTABLE. SPRUCE-PINE-FIR MUST BE GRADED BY NLGA.
- C. PLYWOOD LAMINATED (MICROLAM OR LVL) BEAMS SHALL HAVE THE FOLLOWING MINIMUM PROPERTIES: -BENDING STRESS "Fb" = 2600 PSI
 - -HORIZONTAL SHEAR "Fv" = 250 PSI
- -MODULUS OF ELASTICITY "E" = 1,900,000 PSI
- D. ALL WALL STUDS SHALL BE SPF STUD GRADE OR BETTER, HAVING THE FOLLOWING MINIMUM BASE DESIGN VALUES:

 -COMPRESSION PARALLEL TO GRAIN "Fc11" = 625 PSI
- -BENDING STRESS "F" = 725 PSI FOR SINGLE USE MEMBERS
 -MODULUS OF ELASTICITY "E" = 1,200,000 PSI
- E. UNLESS NOTED OTHERWISE, FASTENING FOR STRUCTURAL MEMBERS SHALL FOLLOW INTERNATIONAL RESIDENTIAL CODE TABLE R602.3(1).
- F. CUTTING AND NOTCHING OF CONVENTIONAL 2X FLOOR JOISTS SHALL CONFORM TO THE FOLLOWING:
 - -NOTCH DEPTH IN THE TOP OR BOTTOM OF THE JOISTS AND BEAMS SHALL NOT EXCEED ONE-SIXTH THE DEPTH OF THE MEMBERS AND SHALL NOT BE LOCATED IN THE MIDDLE ONE THIRD OF THE SPAN (INCLUDING BIRDS MOUTH CUTS).
 - -NOTCH DEPTH AT THE ENDS OF THE MEMBER SHALL NOT EXCEED ONE—FOURTH THE DEPTH OF THE MEMBER.
 - THE TENSION SIDE OF BEAMS, JOISTS AND RAFTERS SHALL NOT BE BOTCHED, EXCEPT AT ENDS OF MEMBERS.
 - -HOLES BORED OR CUT INTO JOISTS SHALL NOT BE CLOSER THAN TWO INCHES TO THE TOP OR BOTTOM OF THE JOISTS. THE DIAMETER OF THE HOLE SHALL NOT EXCEED ONE—THIRD THE DEPTH OF THE JOISTS.

- H. PROVIDE SOLID BLOCKING AT 4 FEET ON CENTER BETWEEN BAND JOIST AND FIRST INTERIOR PARALLEL JOIST, UNO.
- I. PREFABRICATED JOIST HANGERS, BEAM HANGERS, POST CAPS AND POST BASES SHALL BE SIZED AND ATTACHED PER MANUFACTURERS RECOMMENDATION. FASTENERS AND CONNECTORS UTILIZED WITH PRESSURE—TREATED MEMBERS SHALL MEET G185 GALVANIZING.
- N. MULTIPLE STUDS SHALL BE NAILED WITH 10d NAILS AT 24" O.C. PROVIDE SOLID BLOCKING OR CRIPPLE STUDS IN FLOOR SYSTEM AT ALL POINT LOADS ABOVE.
- P. HOLES BORED IN BEARING WALL STUDS SHALL NOT EXCEED 1/3 OF STUD WIDTH.
- Q. ALL STUD BEARING WALLS TO BE PROVIDED WITH 2 CONTINUOUS TOP PLATES AND 1 CONTINUOUS BOTTOM PLATE SPLICES OF TOP PLATE SHALL OCCUR OVER STUD. SPLICES SHALL BE STAGGERED A MINIMUM OF TWO FEET.

5 MISCELLANEOUS

A. ALL WOOD BLOCKING, NAILERS, ETC. SHALL BE ATTACHED TO STEEL OR CONCRETE FRAMING WITH POWER ACTUATED FASTENERS OR 1/2' DIAMETER BOLTS UNLESS NOTED OTHERWISE. FASTENERS SHALL BE SPACED AT 24" MAXIMUM O.C. FASTENERS SHALL HAVE A MINIMUM CAPACITY OF 100 POUNDS IN SHEAR AND PULLOUT UNLESS NOTED OTHERWISE.



43130 Amberwood Plaza, #235 Chantilly, VA 20152

www.jzstructure.com

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Job #	
Date: 12/01/2021	Issue:
REVISION	


Drawn	Checked
HZ	JZ
Scale	
	AS NOTED

NOTES AND DETAILS

Sheet Title

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Sheet No.

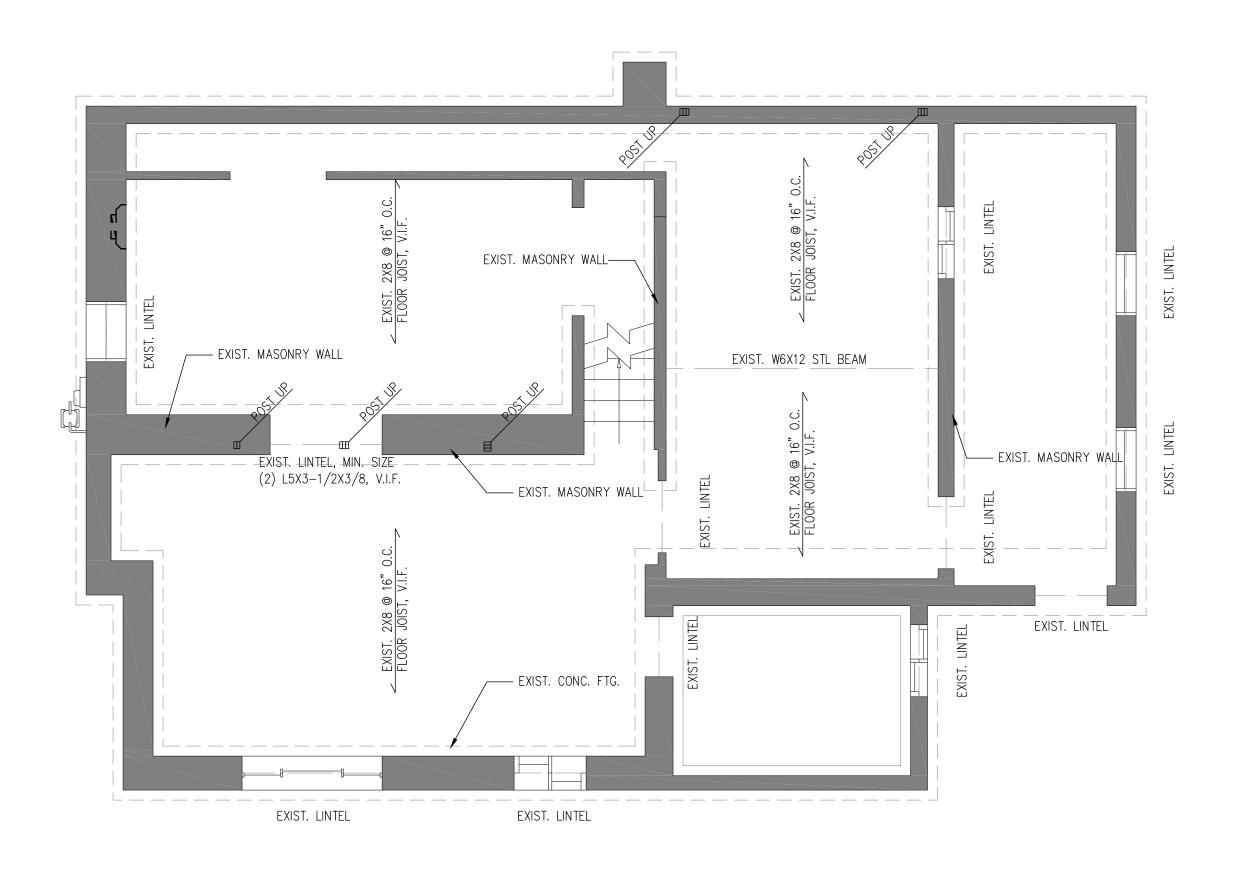

FOUNDATION &1ST FLOOR FRAMING PLAN

1/4"= 1'-0"

NOTES:

1) UNO, PROVIDE IN FLOOR SQUASH BLOCKS UNDER ALL POSTS TO ENSURE CONTINUOUS LOAD BEARING

1		
www.jz PH. (7		20152 e.com
McGraw - Johnson Residence	2831 23rd Rd N, Arlington, VA 22201	Structural Framing
Job # Date:	leonor	
12/01/2021	Issue:	
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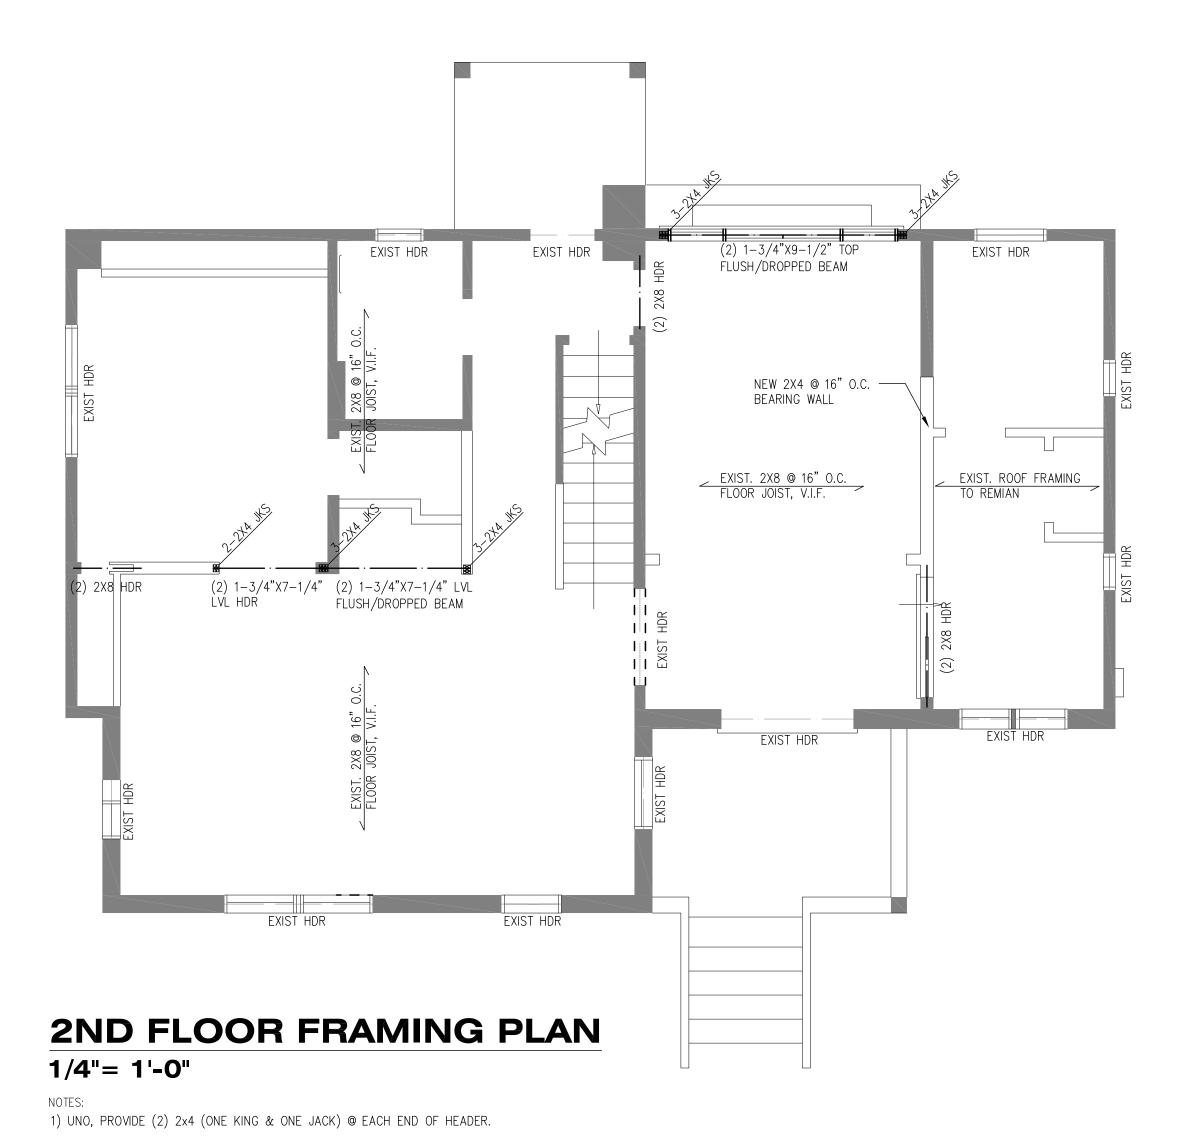
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HZ	JZ

AS NOTED

Sheet Title

FOUNDATION & 1ST FLOOR FRAMING PLAN

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Date: Issue: 12/01/2021


REVISION

Scale AS NOTED

Sheet Title

2ND FLOOR FRAMING PLAN

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EXIST ROOF FRAMING PLAN 1/4"= 1'-0"
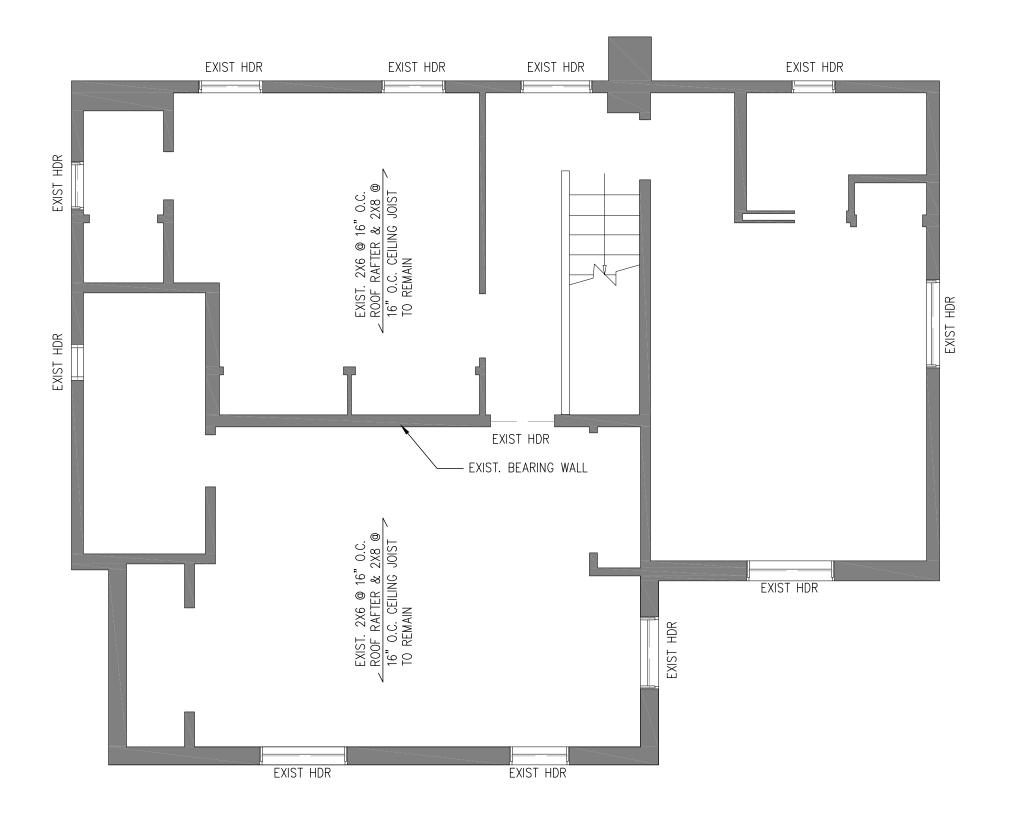
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Job # Date: 12/01/2021 REVISION	Issue:	
Drawn HZ Scale Sheet Title	(AS NOTED	Checked JZ

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DEPARTMENT OF COMMUNITY PLANNING, HOUSING and DEVELOPMENT Inspection Services Division

2100 Clarendon Blvd., Suite 800, Arlington, VA. 22201 Tel 703-228-3800 Fax 703-228-7046 www.arlingtonva.us

MECHANICAL PLAN REVIEW WAIVER FORM

Conditions

Important: The Mechanical plan review waiver applies **ONLY** to the **Alterations and Additions** Proposed to one and two Family Dwellings.

Certification

I the under signed property Owner, request that mechanical code compliance be determined by the field inspection in-lieu of the standard mechanical plan review. I herby certify the mechanical systems will be installed according to all requirements of the Virginia Uniform Statewide Building Code. I also certify that all design specifications shall be available on the job site at the time of inspection for the Inspector to review.

I understand that proper Mechanical permits are required and this work is at my own risk and may require <u>excessive</u> changes necessary to meet code compliance.

Applicant Information

Permit Number: Not assigned yet

Address: 283/23° Rd N. Arlington, VA 22201

Property Owner (Please print): Elizabeth McGrow and Trace Johnson

- Steve Inch for TrivisiousA

Signature of Property Owner or Property Owner's Agent

Date

12114131



DEPARTMENT of COMMUNITY PLANNING, HOUSING and DEVELOPMENT Inspection Services Division

2100 Clarendon Blvd., Suite 800, Arlington, VA. 22201 Tel 703-228-3800 Fax 703-228-7046 www.arlingtonva.us

ASBESTOS INSPECTION AND AWARENESS FORM

Effective July 1, 1993, the Virginia Uniform Statewide Building Code requires that all buildings to be renovated or demolished shall be inspected for the presence of asbestos-containing materials, and subject to exemptions, appropriate response actions shall be undertaken. The following form is to be completed by all applicants for Building Permits for renovation or demolition. A completed form will contain one box checked below and must be signed by the owner or authorized agent of the owner(s).

Own	er(s): Elizabeth McGrow and Trece Johnson ress 2831 2310 Rd N Arlington MA 22201			
Addı	ress 2831 2310 Rd N Arligton VA 22201			
Addı	ress where work is to be performed: Some as above			
Cer	tification			
	AN OWNER, OR AN OWNER'S AGENT, OF THE ABOVE BUILDING, I HEREBY TIFY THAT:			
<u></u>	The above building is a single family dwelling, or is a residential housing building containing four or fewer units, and is exempt from asbestos inspection requirements. (NOTE: This exemption does not apply if the proposed renovation or demolition is for commercial or public development purposes); or			
	The combined amount of regulated asbestos-containing material involved in the renovation or demolition is less than 260 linear feet on pipes, or less than 160 square feet on other facility components, or less than thirty-five cubic feet off facility components where length or area could not be measured previously, and is exempt from asbestos inspection requirements.			
	This building is exempt from asbestos certification requirements because the original building permit was issued after January 1, 1985.			
repa	ONE of the boxes above has been checked, and if the building permit application is for air or replacement of roofing, floorcovering, or siding materials and the use is not a bol, asbestos inspection requirements may be satisfied by checking one of the two owing boxes:			
	The materials to be repaired or replaced are assumed to contain asbestos and that appropriate response actions will be accomplished by a licensed asbestos contractor or a licensed RFS contractor; or			
	An inspection of the materials to be removed was accomplished by an RFS inspector and analysis of the sample showed no asbestos to be present.			

IF <u>NONE</u> OF THE FIVE (5) BOXES ON THE FRONT PAGE HAVE BEEN CHECKED, ONE OF THE REMAINING TWO BOXES HEREUNDER MUST BE CHECKED IN ORDER TO COMPLETE THIS FORM:	
The affected area of the above building to be renovated or demolished has been inspected for the presence of asbestos by an individual licensed to perform such inspections and that no asbestos-containing materials were found; or	
Asbestos-containing materials in the affected area of the above building to be renovated or demolished will be subject to appropriate response actions in accordance with all applicable laws relating to asbestos abatement.	
In accordance with S36-99.7, I further certify that the abatement area will not be reoccupied until any required response actions have been completed and final clearances have been measured and found to be within regulated tolerances.	
Printed Name: Steve Inch	
Telephone number(s): 703-980-7601	
Signature of Owner or Owner's Agent:	USF

Date: (2/14/2)