# Historical Affairs and Landmark Review Board

Arlington County, Virginia



HALRB Meeting April 17, 2024, CoA 24-09

2725 23<sup>rd</sup> Rd. N.: Request to build rear and side addition to connect the house with the existing garage.



MC3 DESIGN 1308 VINCENT PLACE, MCLEAN, VA 22102 INFO@MC3.DESIGN

**DWELL BUILD** 1308 VINCENT PLACE, MCLEAN, VA 22102 INFO@DWELLBUILD.COM

PROJECT INFORMATION

ZONING DISTRICT: R-6 LOT NUMBER: 213 LOT SQUARE FOOTAGE: 28651 SF BUILDING SQUARE FOOTAGE: 2073 SF Appendix F: Map of Maywood



MAYWOOD HOMEOWNER'S HANDBOOK: DESIGN GUIDELINES

CODE

PROJECT SHALL CONFORM TO THE 2018 VIRGINIA UNIFORM STATEWIDE BUILDING CODE AND 2018 VIRGINIA INTERNATIONAL RESIDENTIAL CODE.

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GENERAL

THE BUILDER SHALL VERIFY THAT SITE CONDITIONS ARE CONSISTENT WITH THESE PLANS BEFORE STARTING WORK.

WRITTEN DIMENSIONS AND SPECIFIC NOTES SHALL TAKE PRECEDENCE OVER SCALED DIMENSIONS AND GENERAL NOTES. THE DESIGN-BUILDER SHALL BE CONSULTED FOR CARRICATION IF SITE CONDITIONS ARE ENCOUNTERED THAT ARE DIFFERENT THAN SHOWN, IF DISCREPANCIES ARE FOUND IN THE PLANS OR NOTES, OR IF A QUESTION ARISES OVER THE INTENT OF THE PLANS OR NOTES.

CODES AND STANDARDS

THE FOLLOWING CODES AND STANDARDS, INCLUDING ALL SPECIFICATIONS REFERENCED WITHIN SHALL APPLY TO THE DESIGN, CONSTRUCTION, QUALITY CONTROL AND SAFETY OF ALL WORK PERFORMED ON THE PROJECT. USE THE LATEST EDITIONS UNLESS NO

MINIMUM DESIGN LOADS FOR BUILDINGS AND OTHER STRUCTURES (ANSI/ASCE 7), AMERICAN SOCIETY OF CIVIL ENGINEERS.

BUILDING CODE REQUIREMENTS FOR REINFORCED CONCRETE (ACI 318), AMERICAN

CODE REQUIREMENTS FOR RESIDENTIAL CONRETE (ACI 332), AMERICAN CONCRETE INSTITUTE.

ACI MANUAL OF CONCRETE PRACTICE - PARTS 1 THROUGH 5.

MANUAL OF STANDARD PRACTICE CONCRETE REINFORCING STEEL INSTITUTE

MANUAL OF STEEL CONSTRUCTION - ALLOWARI E STRESS DESIGN - AMERICAN INSTITUTE IMPRIANCE OF STEEL COME THE UNIVERSE STREAM OF STEEL CONSTRUCTION (INCLUDING SPECIFICATION S FOR STRUCTION) (INCLUDING SPECIFICATION S FOR STRUCTIONAL JOISTS USING ATSM A225 OR A490 BOLTS AND AISC CODE OF STANDARD PRACTICE WITH EXCEPTION, IF ANY, AS INDICATED IN THE SPECIFICATIONS).

MANUAL OF STEEL CONSTRUCTION, VOLUME II - CONNECTIONS - AMERICAN INSTITUTE OF STEEL CONSTRUCTION.

DETAILING FOR STEEL CONSTRUCTION AMERICAN INSTITUTE OF STEEL CONSTRUCTION

STRUCTURAL WELDING CODE (ANSI/AWS1.1-92), AMERICAN WELDING SOCIETY.

DESIGN MANUAL FOR FLOOR DECKS AND ROOF DECKS, STEEL DECK INSTITUTE.

SPECIFICATION FOR THE DESIGN OF COLD-FORMED STEEL STRUCTURAL MEMBERS, AMERICAN IRON AND STEEL INSTITUTE.

BUILDING CODE REQUIREMENTS FOR MASONRY STRUCTURES (ACI 530/TMS 402) AND SPECIFICATIONS FOR MASONRY STRUCTURES (ACI 530/ ASCE 7/TMS 602).

NATIONAL DESIGN SPECIFICATION FOR WOOD CONSTRUCTION (NDS)

MISCELL ANEOUS NOTES

EACH BEDROOM TO HAVE A MINIMUM WINDOW OPENING OF 5.7 SQ. FT. WITH A MINIMUM WIDTH OF 20 IN. AND A SILL LESS THAN 44" ABOVE FIN. FLR.

ALL GLAZING WITHIN 18 IN. OF THE FLOOR AND/OR WITHIN 24 IN. OF ANY DOOR (REGARDLESS OF WALL PLANE) ARE TO HAVE SAFETY GLAZING. ALL GLAZING WITHIN 60 IN. OF TUB OR SHOWER FLOOR, 60 IN. OF A STAIR LANDING OR GREATER THAN 9 SQUARE FEET ARE TO HAVE SAFETY GLAZING

SKYLIGHTS ARE TO BE GLAZED WITH TEMPERED GLASS ON OUTSIDE AND LAMINATED GLASS ON THE INSIDE (UNLESS PLEXIGLASS). GLASS TO HAVE MAXIMUM CLEAR SPAN OF 2S IN. AND FRAME IS TO BE ATTACHED TO A 2x CURB WITH A MINIMUM OF 4 IN. ABOVE ROOF PLANE.

ALL TUB AND SHOWER ENCLOSURES ARE TO BE GLAZED WITH SAFETY GLASS.

ALL EXTERIOR WINDOWS ARE TO BE DOUBLE GLAZED AND ALL EXTERIOR DOORS ARE TO BE SOLID CORE WITH WEATHERSTRIPPING, PROVIDE 1/2 IN. DEADBOLT LOCKS ON ALL EXTERIOR DOORS, AND LOCKING DEVICES ON ALL DOORS AND WINDOWS WITHIN 10 FT. (VERTICAL) OF GRADE. PROVIDE PEEPHOLE 54-66 IN. ABOVE FIN. FLOOR ON EXTERIOR ENTRY DOORS.

PROVIDE ONE SMOKE DETECTOR IN EACH ROOM AND ONE IN EACH CORRIDOR ACCESSING BEDROOMS. CONNECT SMOKE DETECTORS TO HOUSE POWER AND INTER-CONNECT SMOKE DETECTORS TO HOUSE POWER AND INTERCONNECT SO THAT, WHEN ANY ONE IS TRIPPED, THEY ALL WILL SOUND. PROVIDE BATTERY BACKUP FOR ALL UNITS.

PROVIDE COMBUSTION AIR VENTS (W/SCREEN AND BACK DAMPER) FOR GAS FIRE-PLACE AND ANY OTHER APPLIANCES WITH AN OPEN FLAME

BATHROOMS AND UTILITY ROOMS ARE TO BE VENTED TO THE OUTSIDE WITH A FAN CAPABLE OF PRODUCING A MINIMUM OF 5 AIR EXCHANGES PER HOUR.

RANGE HOODS ARE ALSO TO BE VENTED TO THE OUTSIDE.

ELECTRICAL RECEPTACLES IN BATHROOMS, KITCHENS AND GARAGES SHALL BE G.F.I. OR G.F.I.C. PER NATIONAL ELECTRICAL CODE REQUIREMENTS

PROVIDE CRAWLSPACE VENTING TO MEET THE REQUIREMENTS OF THE 2006 EDITION OF THE I.R.C.

DRAWING SCHEDULE SHEET NAME NUMBER COVER PAGE GENERAL NOTES AREA PLANS SURVEY PLAT A005 EXISTING STUDY PROPOSED PERSPECTIVES DEMOLITION PLAN GARAGE BASEMENT LEVEL DEMOLITION PLAN BASEMENT LEVEL DEMOLITION PLAN FIRST LEVE DEMOLITION PLAN SECOND LEVE DEMOLITION ROOF PLAN PROPOSED GARAGE BASEMENT PLAN PROPOSED BASEMENT PLAN PROPOSED FIRST LEVEL PLAN PROPOSED SECOND LEVEL PLAN PROPOSED ROOF PLAN FRONT FLEVATION BACK ELEVATION LEFT ELEVATION WINDOW DOOR SCHEDULES MATERIAL TAKEOFFS TYPICAL DETAILS FLOOR DETAILS ROOF DETAILS STAIR DETAILS A505 TYPICAL WALL DETAILS PROPOSED INTERIOR PERSPECTIVES

DESIGN MC3

1308 VINCENT PLACE MCLEAN, VA 22101

JMCKENNA@MC3.DESIGN

DRAWN BY

JOHN MCKENNA, AIA, NCARB ARCHITECT

1308 VINCENT PLACE MCLEAN VA 22101 SEAL

CODE

2018 VIRGINIA RESIDENTIAL CODE (IRC)

PROJECT

## COE RESIDENCE

2725 23RD RD N ARLINGTON VA 22201

REVISIONS

NO.	DESCRIPTION	DATE

SHEET TITLE

COVER PAGE

SCALE 12" = 1'-0" DATE 2024.04.09

SHEET NO.

TYPE SC. PROVIDE HARDENED WASHERS CONFORMING TO ASTM F 436 UNDER ELEMENTS TO BE TIGHTENED.
PROVIDE NUTS CONFORMING TO ASTM A 563. PROVIDE NUTS CONFORMING TO ASTM A 563. TIGHTEN TYPE N BEARING BOLTS TO A SNUG TIGHT CONDITION. INSTALL HIGH-STRENGTH BOLTS ACCORDING TO ASTM STANDARDS. DO NOT WELD TO HIGH-STRENGTH BOLTS. GALVANIZED BOLTS (WHERE SHOWN ON D DRAWINGS); GALVANIZED BOLTS (WHERE SHOWN ON D DRAWINGS). ASTM A 307, GRADE A. PROVIDE WITH STANDARD WASHERS AND NUTS. OVER-TAP NUTS TO CLASS 2A FIT BEFORE GALVANIZING, PROVIDE BEVELED WASHERS AT BOLT HEADS OR NUTS BEARING ON SLOPING WELDING: CONFORM WITH AWS WABO SPECIFICATIONS. WELDERS TO BE QUALIFIED UNDER AWS WABO SPECIFICATIONS. WELDS MATERIAL: 70 KSI FILLER METAL, UNLESS NOTED OTHERWISE PROVIDE LOW-HYDROGEN FILLER METALS AT MOMENT FRAME WELDS.
WELDS TO METAL DECK, METAL STUDS OR OTHER COLD-FORMED METALS: CONFORM TO AWS D1.3. DESIGN LOADS GROUND SNOW LOAD WIND SPEED
SEISMIC DESIGN CATEGORY
WEATHERING PROBABILITY OF CONCRETE FROST LINE TERMITE INFESTATION PROBABILITY DECAY PROBABILITY WINTER DESIGN TEMPERATURE ICE SHIELD UNDERLAYMENT REQUIRED EXTERIOR BALCONIES & DECKS HABITABLE ATTICS & ATTICS SERVED W/ FIXED STAIRS UNCHARITABLE ATTICS W/ STORAGE UNCHARITABLE ATTICS W FLOOR DEAD LOAD ROOF LIVE LOAD ROOF DEAD LOAD SOIL BEARING CAPACITY WATER TABLE BACKELL

SITE WORK BUILDER TO LOCATE ALL SURFACE AND SUBSURFACE UTILITIES IN THE AREA OF THE CONSTRUCTION PRIOR TO COMMENCING WORK, CALL MISS UTILITY PRIOR TO BEGINNING WORK. THE BUILDER SHALL STORE MATERIALS IN A SAFE AREA ON SITE WITH PROTECTION FROM WEATHER, DO NOT STACK BUILDING MATERIALS IN A MANNER THAT COULD CREATE CONCENTRATED LOADS ON NEW OR EXISTING WORK. BUILDER SHALL RETAIN A GEOTECHNICAL ENGINEER TO TEST SOIL BEARING CAPACITY IF PROVIDE POSITIVE DRAINAGE AWAY FROM BUILDING MATERIAL W AND WT SHAPES: ASTM A 992; FT = 50 KSI M, MT, S, ST, HP, C, MC AND L SHAPES: ASTM A 36; FT = 36 KSI STEEL PIPE: ASTM A 53, GRADE B; FT = 35 KSI STEEL HSS SECTIONS (ROUND, SQUARE, RECTANGULAR) COLD ROLLED: ASTM A 500, GRADE B; FT = 46 KSI HOT POLLED: ASTM A 501 STEEL DLATES: ASTM A 36: ET = 36 KSI 

= 25 psf = 115 MPH

= B = SEVERE

= FIRM-2013

= YFS

= 30 ps

= 40 psf

= 10 psf U.N.O. = 30 psf

= 20 psf = 1,500 psf V.I.F.

= 30 psf U.N.O.

= 2'-0" MIN. BELOW

BOTTOM OF ALL

CONCRETE FOOTINGS

= MODERATE TO HEAVY

= SLIGHT TO MODERATE = 17° F

SHEATHING 3/4" PLYWOOD SUBFLOOR W/(2) @ EA. END OR SPLICE (3) OR FEWER (4) OR MORE

NAILING NOTES PER IRC TABLE R602.3

IOIST TO SILL OR GIRDER

DOUBLE STUDS DOUBLE TOP PLATES

JOIST TO SILL OR GIRDER
BRIDGING TO JOIST
SOLE PLATE TO JOIST OR BLK'G
STUD TO SOLE PLATE
TOP PLATE TO STUD

BUILT-UP HEADER, TWO PIECES

CONTINUOUS HEADER TWO PIECES

BOILT-OF HEADER, TWO PIECES
W/ 1/2" SPACER
TOP PLATES, LAPS AND INTERSECTIONS
CEILING JOISTS TO PLATE
CONTINUOUS HEADER TO STUD

CEILING JOISTS, LAPS OVER PARTITIONS CEILING JOISTS TO PARALLEL RAFTERS

1" BRACE TO EACH STUD AND PLATE BUILT-UP CORNER STUDS

2" PLANKS 1/2" PLYWOOD ROOF AND WALL

TOE NAIL (2)-16d
FACE NAIL (2)-8d
10d @ 24\* OC
(2)-16d @ EA.BRG.
EDGES 8d @ 6\* OC
INTERMEDIATE 8d @ 12\* OC
EDGES 8d @ 6\* OC INTERMEDIATE 8d @ 12" OC 2x MULTIPLE JOISTS - STAGGER @ 15" OC 16d NAILS 1/2" DIA M.B. W/ STANDARD NUT AND WASHERS

A. ALL NAILS ARE SMOOTH-COMMON, BOX OR DEFORMED SHANKS EXCEPT WHERE OTHERWISE STATED. NAILS USED FOR FRAMING AND SHEATHING CONNECTIONS SHALL HAVE MINIMUM AVERAGE BENDING YIELD STRENGTHS AS SHOWN: 80 KSI FOR SHANK DIAMETER OF 0. 192 INCH (20D COMMON NAIL). 90 KSI FOR SHANK DIAMETERS LARGER THAN 0.142 INCH BUT NOT LARGER THAN 0.177 INCH, AND 100 KSI FOR SHANK DIAMETERS B. STAPLES ARE 16 GAGE WIRE AND HAVE A MINIMUM 7/16-INCH ON DIAMETER CROWN

TOE NAIL (3)-8d TOE NAIL EA. END (2)-8d FACE NAIL 16d @ 16°OC TOE NAIL (4)-8d, END NAIL (2) 16d END NAIL (2)-16d

16d @ 16" OC ALONG EA. EDGE

16d @ 16" OC ALONG EA. EDGE FACE NAIL (2)-16d TOE NAIL (3)-8d TOE NAIL (4)-8d

FACE NAIL 16d @ 24" OC FACE NAIL 16d @ 16" OC

FACE NAIL (3)-10d FACE NAIL (3)-10d

TOE NAIL (2)-16d

. NAILS SHALL BE SPACED AT NOT MORE THAN 6 INCHES ON CENTER AT ALL SUPPORTS

WHERE SPANS ARE 48 INCHES OR GREATER. D. FOUR-FOOT BY 8-FOOT OR 4-FOOT BY 9-FOOT PANELS SHALL BE APPLIED VERTICALLY.

E. SPACING OF FASTENERS NOT INCLUDED IN THIS TABLE SHALL BE BASED ON TABLE FOR REGIONS HAVING BASIC WIND SPEED OF 110 MPH OR GREATER 8D DEFORMED (21/2" × 0.120) NAILS SHALL BE USED FOR ATTACHING PLYWOOD AND WOOD STRUCTURAL

[2112" x 0.120) NAILS SHALL BE USED FOR ATTACHING PLYWOOD AND WOOD STRUCTURAL PANEL ROOP SHEATHING TO FRAMING WITHIN MINIMUM 48-INCH DISTANCE FROM GABLE END WALLS, IF MEAN ROOF HEIGHT IS MORE THAN 25 FEET, UP TO 35 FEET MAXIMUM. G. FOR REGIONS HAVING BASIC WIND SPEED OF 100 MPH OR LESS, NAILS FOR ATTACHING WOOD STRUCTURAL PANEL ROOF SHEATHING TO GABLE END WALL FRAMING SHALL BE SPACED 6 INCHES ON CENTER. WHEN BASIC WIND SPEED IS GREATER THAN 100 MPH, NAILS FOR ATTACHING PANEL ROOF SHEATHING TO INTERMEDIATE SUPPORTS SHALL BE SPACED 6 INCHES ON CENTER FOR MINIMUM 48-INCH DISTANCE FROM RIDGES EAVES AND GABLE END WALLS: AND 4 INCHES ON CENTER TO GABLE END WALL

FRAMING.

H. GYPSUM SHEATHING SHALL CONFORM TO ASTM C 1396 AND SHALL BE INSTALLED IN ACCORDANCE WITH 6A 253. FIBERBOARD SHEATHING SHALL CONFORM TO ASTM C 208. IS SHACING OF FASTENER'S ON FLOOR SHEATHING PANEL EDGES APPLIES TO PANEL EDGES SUPPORTED BY FRAMING MEMBERS AND REQUIRED BLOCKING, AND AT ALL FLOOR PERMIETERS ONLY SPACING OF FASTENER'S ON ROOF SHEATHING PANEL EDGES APPLIES TO PANEL EDGES SUPPORTED BY FRAMING MEMBERS AND REQUIRED BLOCKING. BLOCKING SHOCKING OF ROOF OF FLOOR SHEATHING PANEL EDGES PERPENDICULAR BLOCKING. BLOCKING OF ROOF OF FLOOR SHEATHING PANEL EDGES PERPENDICULAR TO THE FRAMING MEMBERS NEED NOT BE PROVIDED EXCEPT AS REQUIRED BY OTHER PROVISIONS OF THIS CODE. FLOOR PERIMETER SHALL BE SUPPORTED BY FRAMING MEMBERS OR SOLID BLOCKING.

MEMBERS OR SOLID BLOCKING.

J. WHERE A RAFTER IS FASTENED TO AN ADJACENT PARALLEL CEILING JOIST IN ACCORDANCE WITH THIS SCHEDULE, PROVIDE TWO TOE NAILS ON ONE SIDE OF THE RAFTER AND TOE NAILS FROM THE CEILING JOIST TO TOP PLATE IN ACCORDANCE WITH THIS SCHEDULE. THE TOE NAIL ON THE OPPOSITE SIDE OF THE RAFTER SHALL NOT BE

STAIRWAY AND RAILING

STAIRWAY SHALL NOT BE LESS THAN 36" IN WIDTH

STAIRWAY RISER SHALL NOT BE GREATER THAN 8 1/4" STAIRWAY TREAD DEPTH SHALL NOT BE LESS THAN 9" THE LENGTH OF RUN AND HEIGHT OF RISER SHALL NOT VARY MORE THAN 3/8" IN THE ENTIRE RUN OF STAIR ENTIRE RUN OF STAIR.

OPEN RISER PERMITTED IF OPENING IS LESS THAN 4".

MINIMUM 3/4" NOSING.

POST/ BALUSTERS OPENING NOT GREATER THAN 4". POST/BALUSTERS OPENING NOT GREATER THAN 4". STAIRWAY HEADROOM HEIGHT SHALL NOT BE LESS THAN 6"-8". STAIRWAY HANDRAIL HEIGHT SHALL NOT BE LESS THAN 34" AND NO MORE THAN 38"

STARWAY HANDRAIL HEIGHT SHALL NOT BE LESS THAN 34" AND NO MORE THAN 38". ENCLOSED BABLE SPACE UNDER INTERIOR STAIRS SHALL BE PROTECTED ON THE ENCLOSED FACE WITH 38" TYPE "X" GYPSUM WALL BOARD. STARWAYS SHALL HAVE AT LEAST ONE HANDRAIL LOCATED 54" TO 38" ABOVE THE NOSING OF TREADS AND LANDINGS. THE HAND GRIP PORTION OF HANDRAILS SHALL BO BE LESS THAN 11", OR GREATER THAN 2" IN CORSS-SECTIONAL DIMENSION. HANDRAILS SHALL BE CONTINUOUS THE FULL ELENGTH OF THE STARS, THE ENDS OF HANDRAILS SHALL BETURN TO WALL ON TERMINATE INTO A NEWEL POST OR SAFETY

STAIRWAYS HAVING LESS THAN 2 RISERS DO NOT REQUIRE A HAND RAIL 34" MIN HEIGHT GUARDRAILS SHALL BE PROVIDED FOR AT PORCHES, DECKS BALCONIES, 15) STAIRWAYS AND LANDINGS WHERE THE ADJACENT SURFACE IS GREATER THAN 24" BELOW

JUNEA ILER THAN 24" BELOW.
RAILING AND GUARDRAIL BALUSTER SPACING SHALL BE NO GREATER THAN 4".
THE TRIANGULAR OPENINGS FORMED BY THE RISER, TREAD, AND BOTTOM OF
GUARDRAIL SHALL NOT ALLOW A 6" DIAMETER SPHERE TO PASS THROUGH.
EXTERIOR SPIRAL STAIRS TO BE FABRICATED AND INSTALLED PER THE MFG.
INSTRUCTIONS.

ELECTRICAL

ELECTRICAL, DATA, & AUDIO NOTES: HOME OWNER SHALL DO A WALK-THRU WITH RELEVANT INSTALLERS TO VERIFY TH EXACT LOCATION FOR OUTLETS, LIGHTS, SWITCHES, CABLE, DATA, PHONE, AUDIO,

ELECTRICAL RECEPTACLES IN BATHROOMS, KITCHENS AND GARAGES SHALL BE G.F.I. ORG.F.I.C. PER NATIONAL ELECTRICAL CODE REQUIREMENTS.
PROVIDE ONE SMOKE DETECTOR IN EACH ROOM AND ONE IN EACH CORRIDOR

PADVIDE UNE SMOKE DE LECTUR IN EACH ROUM AND DIKE IN EACH CONKILDING. ACCESSION SERVICE SERVICE AND AND EACH CONKILDING AND INTER-ACCESSION SERVICE SERVICE AND AND EACH END REST TRIPPED, THEY ALL WILL SOUND, PROVIDE BATTERY BACKUP FOR ALL UNITS.

CIRCUITS SHALL BE VERRIER OWNTH HOME OWNER PRIOR TO WIRE INSTALLATION. FINAL SWITCHES FOR TIMERS AND DIMMERS SHALL BE VERIFIED WITH HOME OWNER. FIXTURES TO BE SELECTED BY HOME OWNER.

LOCATE SPEAKERS AND ALIDIO CONTROLS AS INDICATED IN THE PLAN: RUN CIRCUIT OF SPEAKER WIRING TO AUDIO HOME PANEL SPECIFIED BY FLOOR AUDIO SPEAKERS TO BE APPROVED BY HOME OWNER;

AUDIO SPEARENS 10 BE APPROVED BY HOME OWNER;
LOCATE JACKS AS INDICATED IN THE PLAN; INSTALL DATA / CABLE PANEL SIMILAR TO "ON Q". SYSTEM TO BE APPROVED BY HOME OWNER.
DATA / CABLE:
LOCATE SECURITY PANELS AS INDICATED IN THE PLAN; SYSTEM TO BE APPROVED BY

HOME OWNER

PI UMBING

HVAC SHALL HAVE THREE ZONES, ONE FOR EACH FLOOR.

THE FURNACE AND WATER HEATER ON FLOOR S SHALL SERVE FLOORS 3.

THE FURNACE AND WATER HEATER ON FLOOR S SHALL SERVE FLOORS 1.

THE FURNACE AND WATER HEATER ON FLOOR SHALL SERVE FLOORS 1.

8. Z.

METALLIC GAS PIEW, WATER PIEW, AND FOUNDATION REINFORCING BARS SHALL BE BONDED TO THE ELECTRICAL SERVICE GROUND.

DRYER, WATER HEATER, KITCHEN AND BATHROOM VENTING SHALL EXHAUST TO THE

OUTSIDE OF THE BUILDING AND BE EQUIPPED WITH A BACK DRAFT DAMPER. LL GAS LINES SHALL BE SIZED FOR APPLIANCE LOAD. "BLACK" PIPE SHALL BE USED INSIDE THE BUILDING, "GREEN" PIPE WHERE UNDERGROUND OR EXPOSED TO WEATHER ALL JOINTS SHALL BE TAPED WHERE BURIED OR EXPOSED TO WEATHER. TUBS/SHOWERS SHALL BE PROVIDED WITH INDIVIDUAL CONTROL VALVES OF THE TUBSISHOWERS SHALL BE PROVIDED WITH INDIVIDUAL CONTROL VALYS OF THE PRESSURE BLANCE OR THE THERMOSTATIC MIXING TYPE. THE WATER TEMPERATURE SHALL BE AT A MAXIMUM OF 120°F. WATER SOFTENBE UNIT SHALL CONDITION WATER BEFORE ENTERING THE WATER HEATERS AND THE COLD WATER SOURCE. EACH HOSE BIES SHALL BE CUIPPED WITH A BACK FLOW PREVENTION DEVICE.

FAT DUCTING SHALL BE SECURED. SEALED AND INSULATED AS APPROPRIATE INSTALL WATERPROOF GYPSUM BOARD AT ALL WATER SPLASH AREAS TO MINIMUM 70" ABOVE SHOWER DRAINS.

NSULATE WASTE LINES FOR SOUND CONTROL. NSTALL CENTRAL VACUUM SYSTEM & PIPING; CONFIRM BRAND WITH HOMEOWNER.

VENTIL ATION

ALL COMBUSTION APPLIANCES WILL BE VENTED DIRECTLY TO THE EXTERIOR. FURNACE FIREBOX AND TANKLESS WATER HEATER SHALL HAVE OUTSIDE COMBUSTION AIR SUPPLY PURSUANT TO REGIONAL AND LOCAL CODES.

ATTIC SHALL HAVE VENTILATION EQUAL TO 1 SQ. FOOT PER 150 SQ. FEET OF ATTIC SPACE. VENTILATION SHALL BE PROTECTED FROM SNOW AND RAIN AND SHALL BE COVERED WITH GALVANIZED WIRE SCREEN. OPENINGS SHALL BE LOCATED TO PROVIDE ROSS VENTIL ATION

EXHAUST ALL VENTS AND FANS DIRECTLY TO OUTSIDE VIA METAL DUCTS, PROVIDE 90 CFM (MIN) FANS TO PROVIDE 5 AIR CHANGES PER HOUR IN BATHS CONTAINING TUB AND / OR SHOWER AND IN LAUNDRY ROOMS.

GARAGES SHALL BE VENTED WITH 60 SQUARE INCHES LOCATED 6" ABOVE THE FLOOR

INDER FLOOR SPACES SHALL HAVE VENTILATION EQUAL TO ONE SQ. FOOT PER 150 SQ. ORDER'T LOOK SPACE, SHALL PAYE VENILATION EQUAL TO ONE 32. "COT FER TO 32 COT FER TO SHALL BE CAST INTO THE CONCRETE STEM WALLS AND COVERED WITH GALVANIZED WIRE SCREEN. VENTS SHALL BE LOCATED TO PROVIDE CROSS VENTILATION.


INSULATION REQUIREMENTS

REFER TO TABLE N1102 1 2 (R402 1 2)

CLIMATE ZONE: 4. FENESTRATION U-FACTOR: 0.32. SKYLIGHT U-FACTOR: 0.55. GLAZED FENESTRATION SHGC: 0.40 GLAZED FENES ITATION SHIGO: 0.40
CEILING R-VALUE: 49.
WOOD FRAME WALL R-VALUE: 15.
MASS WALL R-VALUE: 19.
FLOOR R-VALUE: 19.
BASEMENT WALL R-VALUE: 10 CONTINUOUS) / 13 (CAVITY). UNHEATED SLAB R-VALUE AND DEPTH: 10 / 2'. HEATED SLAB R-VALUE: R-5. CRAWL SPACE WALL R-VALUE: 10 (CONTINUOUS) / 13 (CAVITY).


MECHANICAL REQUIREMENTS

WHOLE HOUSE MECHANICAL VENTILATION SYSTEM SHALL BE DESIGNED IN ACCORDANCE

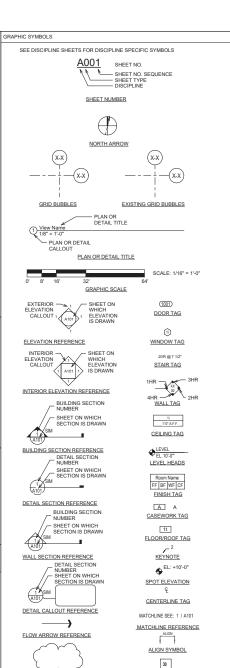

REVISION CALLOUT AND CLOUD

APARTMENT NUMBERS

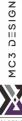



1308 VINCENT PLACE MCLEAN, VA 22101

202.599.7779 JMCKENNA@MC3.DESIGN

DRAWN BY JOHN MCKENNA, AIA, NCARB ARCHITECT

1308 VINCENT PLACE MCI FAN VA 22101 SFAL

CODE 2018 VIRGINIA RESIDENTIAL

PROJECT

COE RESIDENCE 2725 23RD RD N

ARLINGTON VA 22201

REVISIONS

NO. DESCRIPTION DATE

SHEET TITLE

**GENERAL** NOTES

SCALE As indicated DATE 2024 04 09 SHEET NO



DESIGN MC3



1308 VINCENT PLACE MCLEAN, VA 22101

JMCKENNA@MC3.DESIGN

JOHN MCKENNA, AIA, NCARB ARCHITECT

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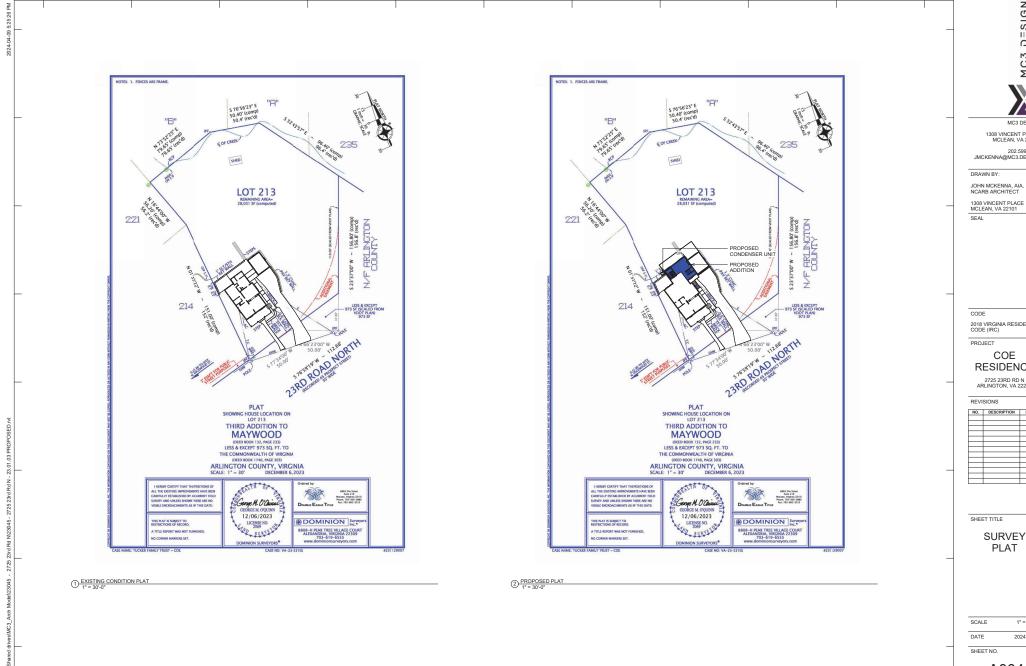
NO.	DESCRIPTION	DATE
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SHEET TITLE

AREA PLANS

JUALE	As indicated
DATE	2024.04.09

SHEET NO.



DESIGN MC3

1308 VINCENT PLACE MCLEAN, VA 22101

202.599.7779 JMCKENNA@MC3.DESIGN

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## COE RESIDENCE

2725 23RD RD N ARLINGTON, VA 22201

SURVEY PLAT

1" = 30'-0" 2024.04.09

NNY NEW ROOF OVERHANGS SHOULD DISPLAY FAUX) RAFTERS AS DOES EXISTING HOUSE

ANY NEW HARDSCAPE TO MATCH EXISTING BRICK PAVER









MC3 DESIGN

1308 VINCENT PLACE MCLEAN, VA 22101

202.599.7779 JMCKENNA@MC3.DESIGN

DRAWN BY:

JOHN MCKENNA, AIA, NCARB ARCHITECT

1308 VINCENT PLACE MCLEAN, VA 22101 SEAL

CODE

2018 VIRGINIA RESIDENTIAL CODE (IRC)

PROJECT

## COE RESIDENCE

2725 23RD RD N ARLINGTON, VA 22201

REVISIONS

NO. DESCRIPTION DATE

SHEET TITLE

EXISTING STUDY

SCALE

DATE 2024.04.09

SHEET NO.



Mode/L23045 - 2725 23rd Rd N/23045 - 2725 23rd Rd N - 23.01.03 PROPOSED.rvt

PROPOSED FRONT FOUNDATION WALLS TO MATCH EXISTING TEXTURED CMU. PAINTED WHITE



PORTION OF GABLE ROOF TO REMAIN

- EXTERIOR WALL TO REMAIN

- REPLACE EXISTING GARAGE DOOR WITH FAUX DOUBLE DOOR STYLE WOOD GARAGE DOOR TO BE INSTALLED



EXISTING FRONT PORCH WINDOWS. PROPOSED TO MATCH:

PROPOSED WINDOWS TO MATCH EXISTING MUNTIN PROFILE AND BE INTEGRAL TO GLASS PANES

EXISTING 2 1/2" OVERLAPPING WOOD SIDING



EXISTING WOOD SIDING TO BE PAINTED NAVY BLUE

PROPOSED TO MATCH EXISTING

CORNER TRIM PROPORTIONS,
PAINT WHITE



PROPOSED BATHROOM WINDOWS TO MATCH PROPORTION AND STYLE OF THESE EXISTING WINDOWS

DESIGN MC3

1308 VINCENT PLACE MCLEAN, VA 22101

202.599.7779 JMCKENNA@MC3.DESIGN

DRAWN BY:

JOHN MCKENNA, AIA, NCARB ARCHITECT

1308 VINCENT PLACE MCLEAN, VA 22101 SEAL

CODE

2018 VIRGINIA RESIDENTIAL CODE (IRC)

PROJECT

### COE RESIDENCE

2725 23RD RD N ARLINGTON, VA 22201

REVISIONS

NO. DESCRIPTION DATE

SHEET TITLE

**EXISTING** SITE **PHOTOS** 

SCALE

DATE 2024.04.09

SHEET NO.



MC3 DESIGN

1308 VINCENT PLACE MCLEAN, VA 22101

202.599.7779 JMCKENNA@MC3.DESIGN

DRAWN BY:

JOHN MCKENNA, AIA, NCARB ARCHITECT

1308 VINCENT PLACE MCLEAN, VA 22101

2018 VIRGINIA RESIDENTIAL CODE (IRC)

PROJECT

## COE RESIDENCE

2725 23RD RD N ARLINGTON, VA 22201

REVISIONS

NO.	DESCRIPTION	DATE

SHEET TITLE

## PERSPECTIVES

DATE 2024.04.09

SHEET NO.



① EXTERIOR - FRONT PERSPECTIVE VIEW 01



② EXTERIOR - LEFT PERSPECTIVE 01



6 EXTERIOR - FRONT PERSPECTIVE 02



3 EXTERIOR - BACK PERSEPECTIVE 01



(4) EXTERIOR - RIGHT PERSPECTIVE 01



5 EXTERIOR - BACK PERSPECTIVE 02

MC3 DESIGN



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202.599.7779 JMCKENNA@MC3.DESIGN

DRAWN BY:

JOHN MCKENNA, AIA, NCARB ARCHITECT

1308 VINCENT PLACE MCLEAN, VA 22101 SEAL

CODE

2018 VIRGINIA RESIDENTIAL CODE (IRC)

PROJECT

## COE RESIDENCE

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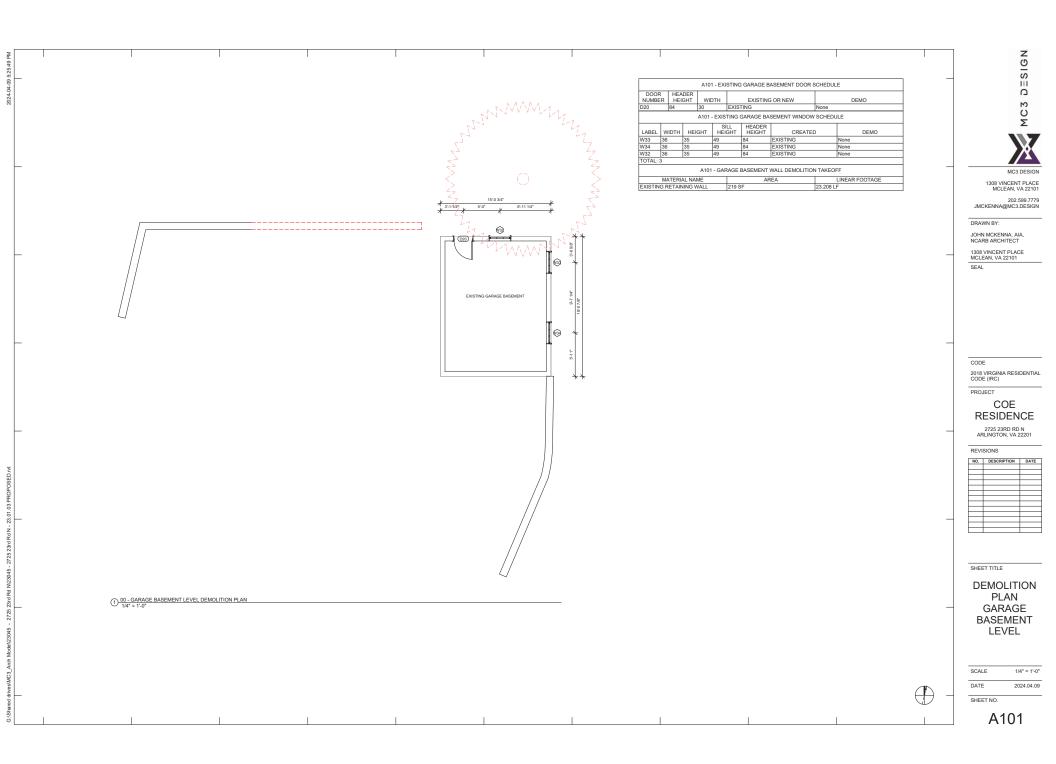
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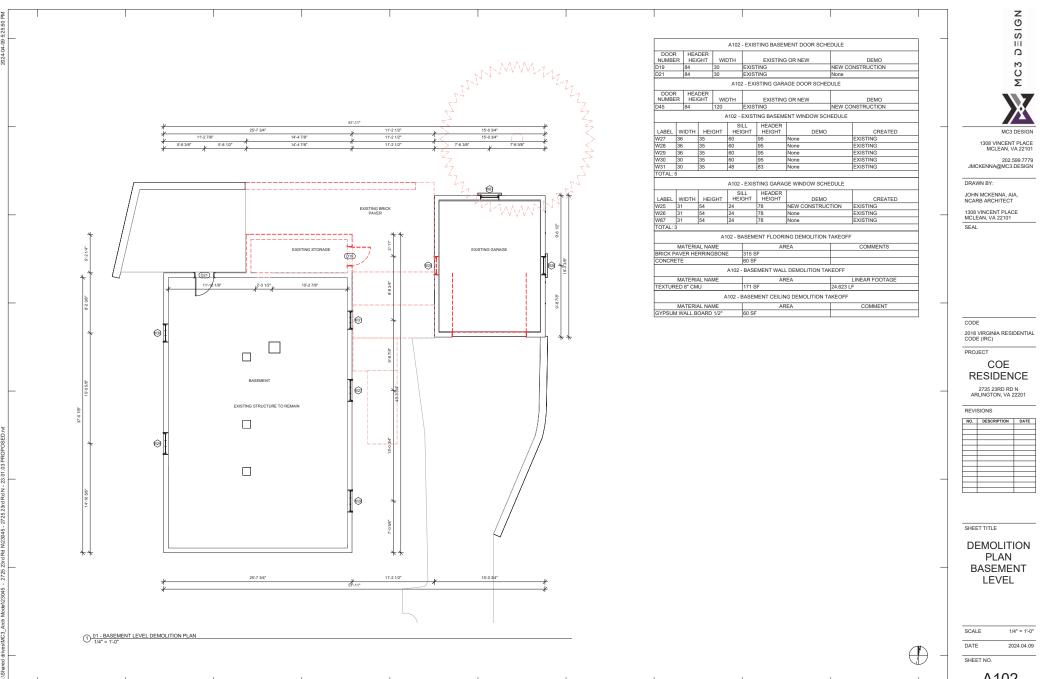
SHEET TITLE


## PROPOSED **PERSPECTIVES**

SCALE DATE 2024.04.09


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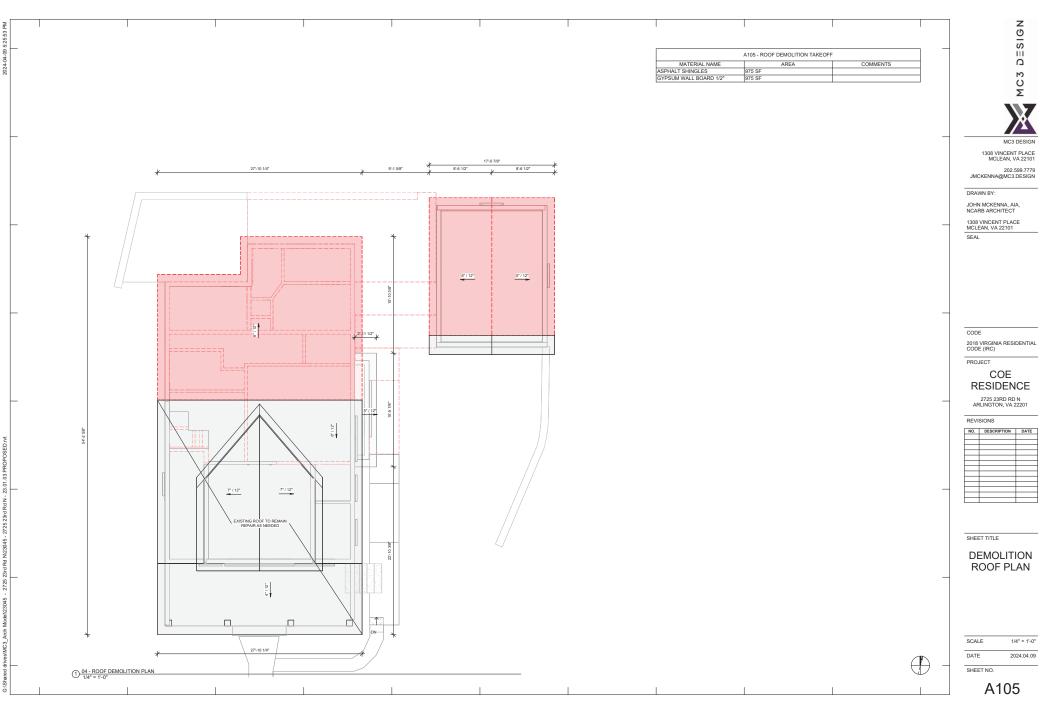








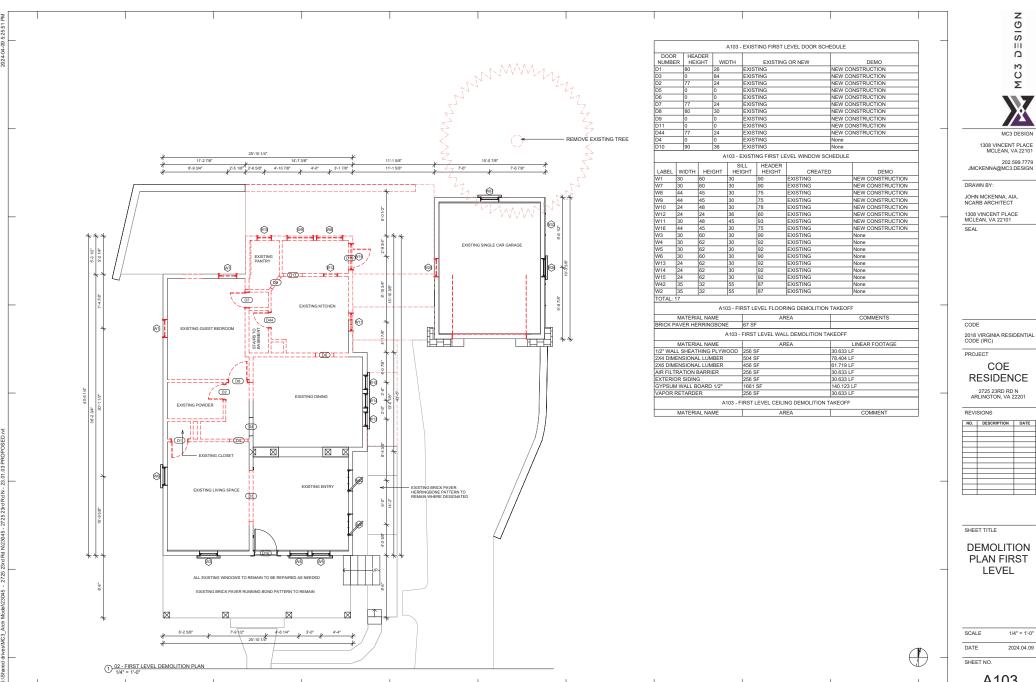




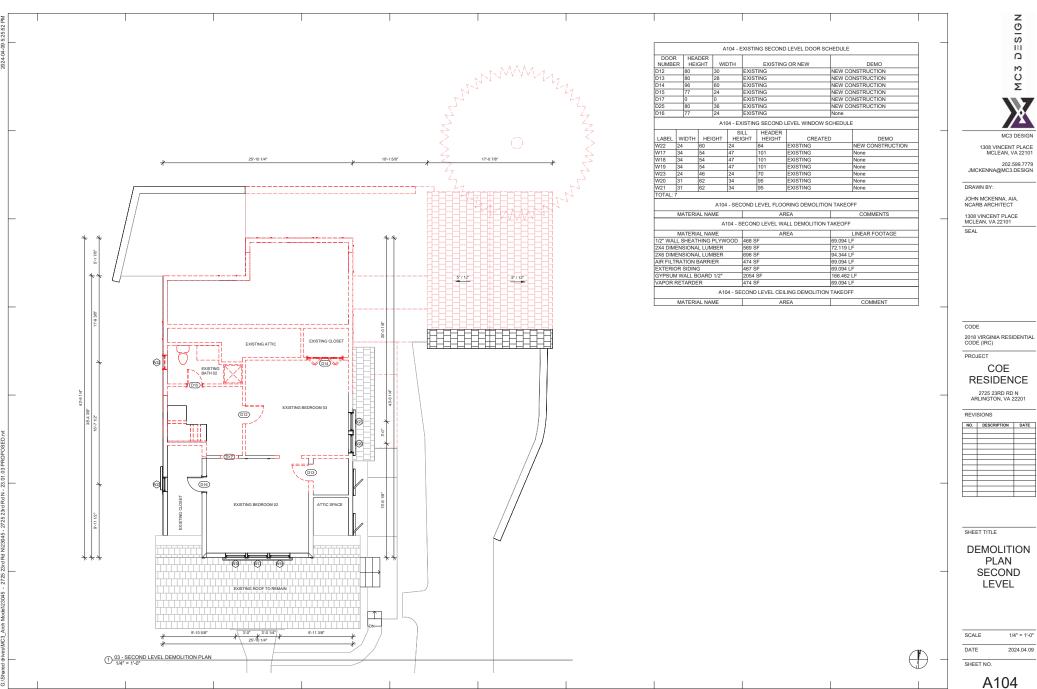

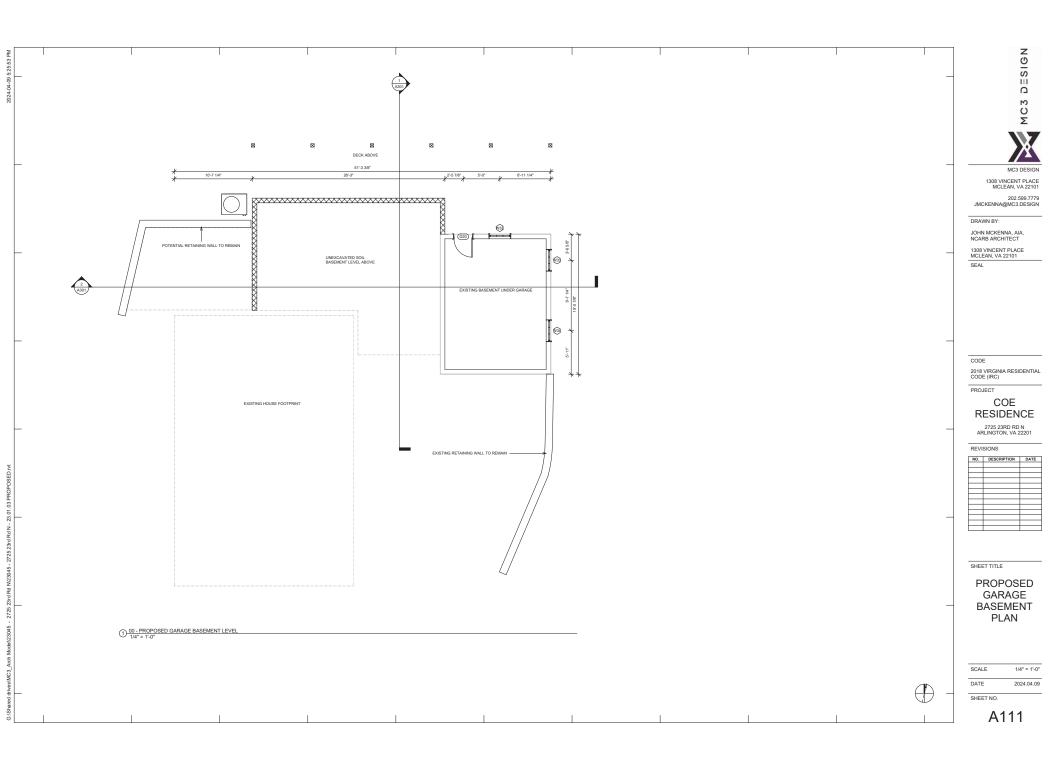

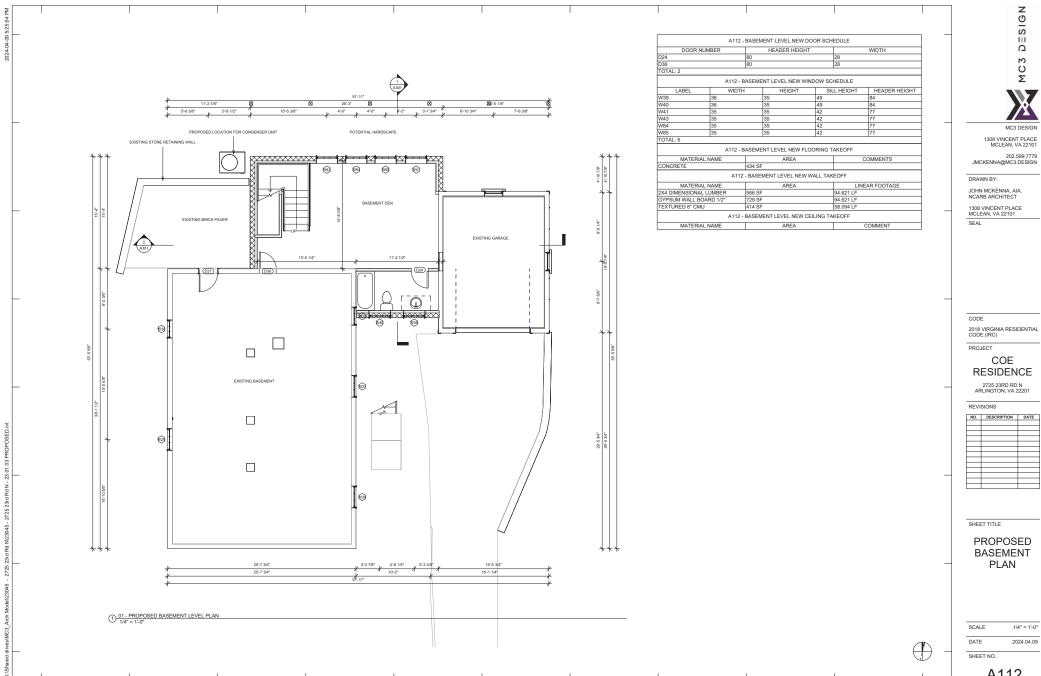

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DESIGN MC3

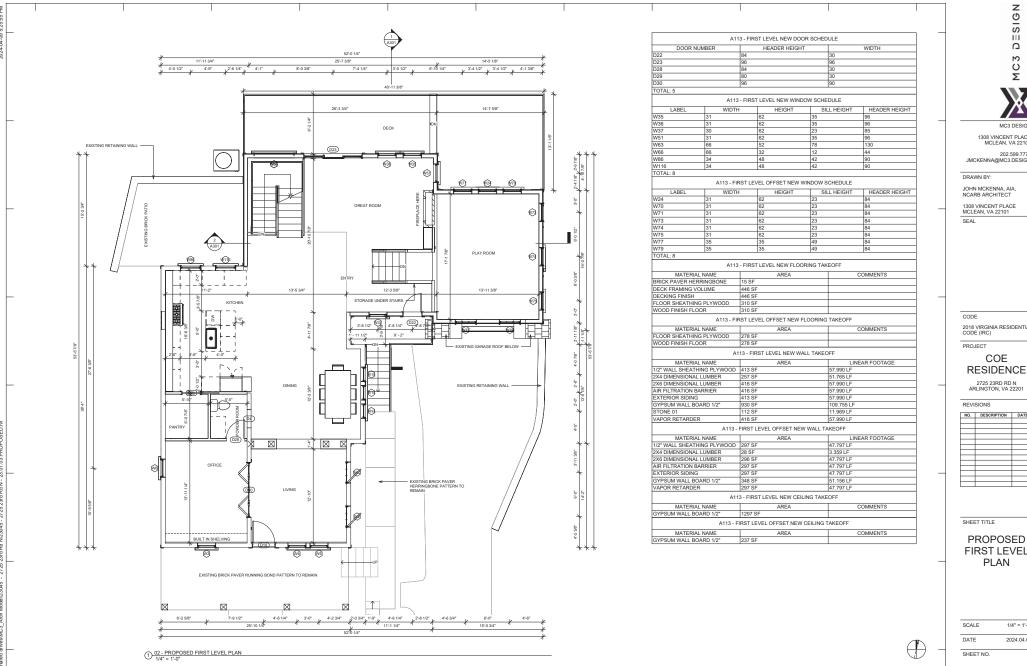1308 VINCENT PLACE MCLEAN, VA 22101

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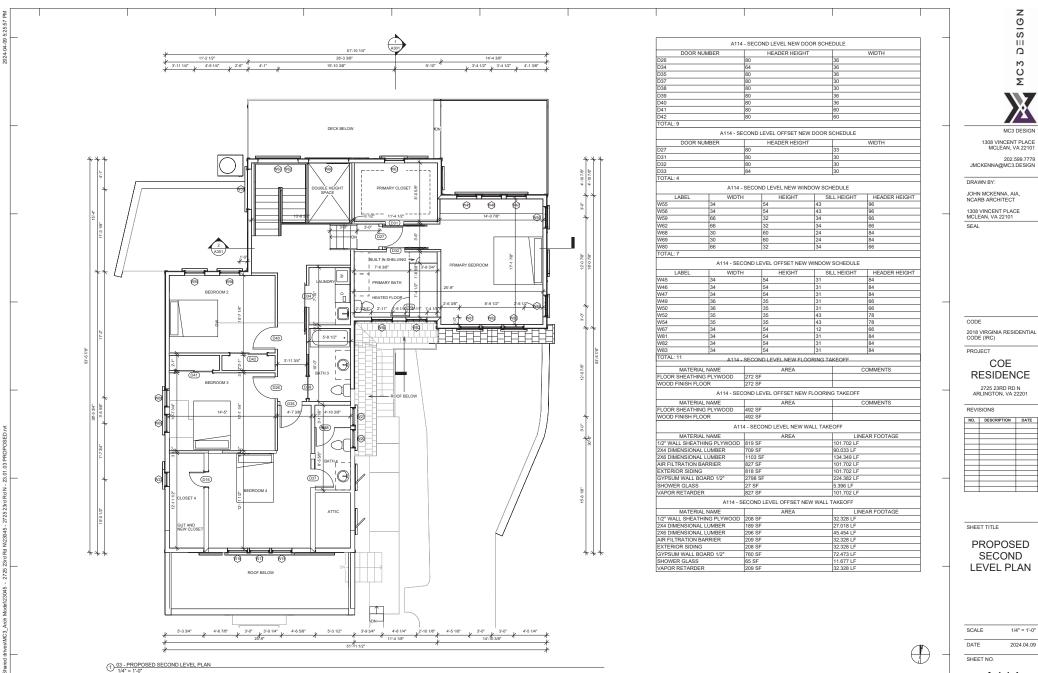
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FIRST LEVEL **PLAN** 


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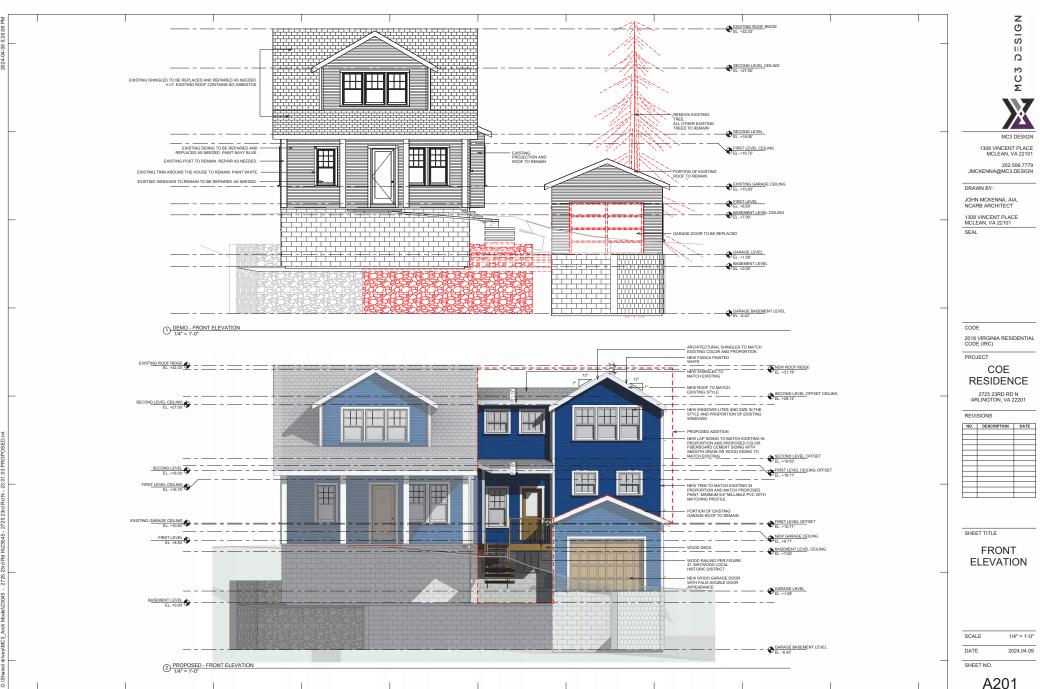



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1/4" = 1'-0" 2024.04.09









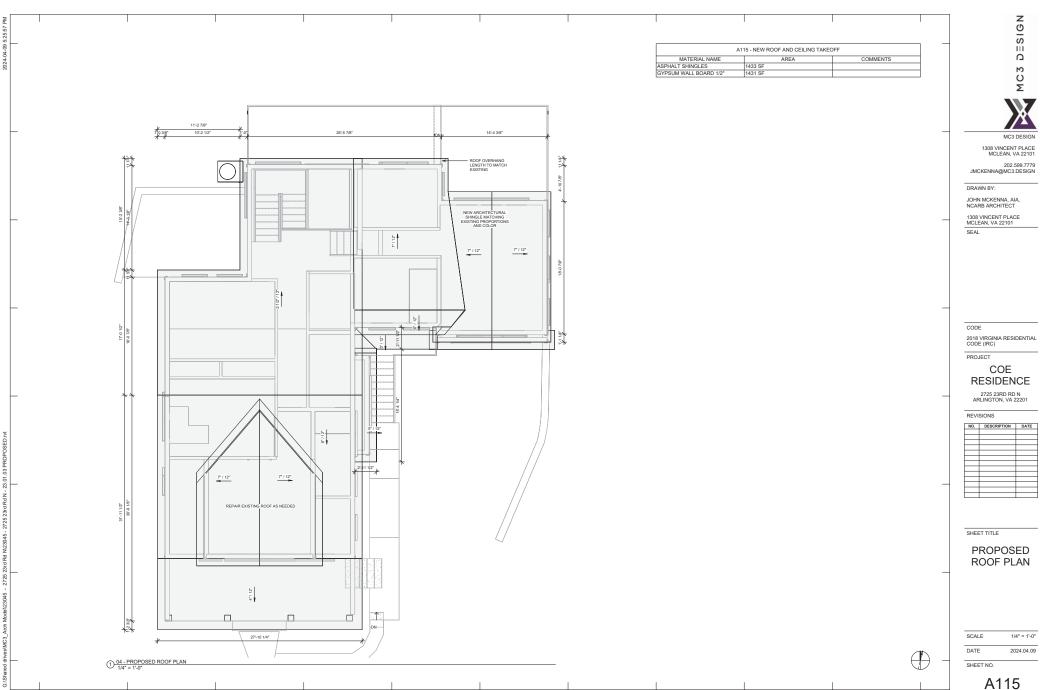

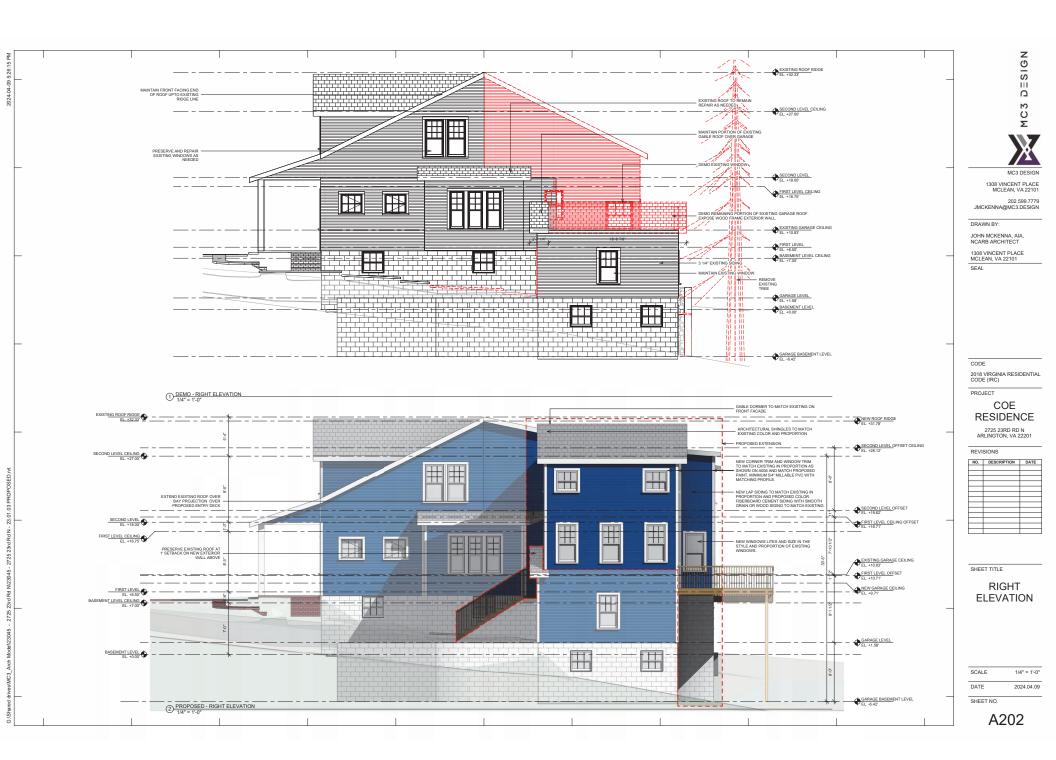

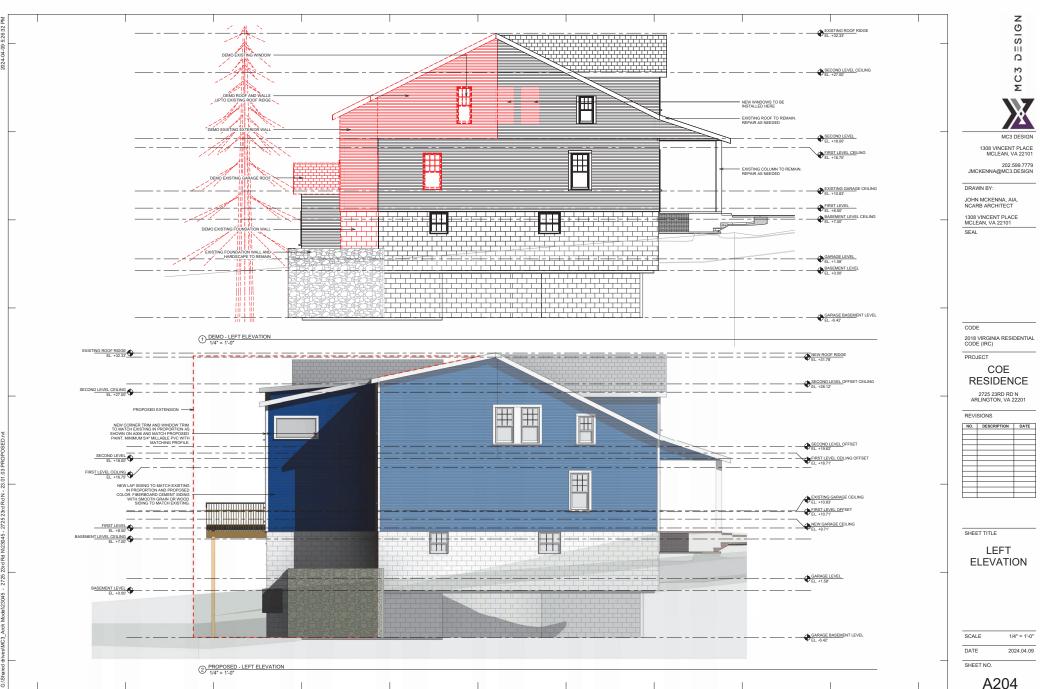

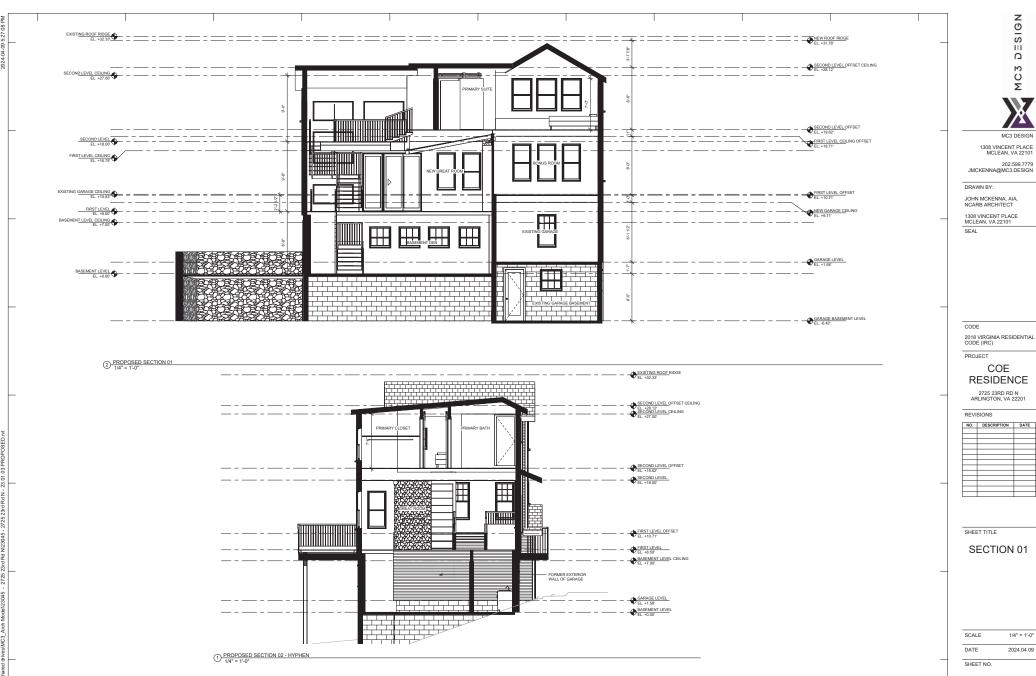

2024-04-09

N/23045 - 2725 23rd Rd N - 23.01.03

23rd Rd



JMCKENNA@MC3.DESIGN

## RESIDENCE

NO.	DESCRIPTION	DATE
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**SCHEDULES** 

2024.04.09

SHEET NO.

MATERIAL NAME	ARFA	COMMENTS
BRICK PAVER HERRINGBONE	382 SF	
CONCRETE	60 SF	
02 - COMP	LETE DEMOLITION WALL MA	TERIAL TAKEOFFS
MATERIAL NAME	AREA	LINEAR FOOTAGE
1/2" WALL SHEATHING PLYWOOD	796 SF	114.378 LF
2X4 DIMENSIONAL LUMBER	1073 SF	150.523 LF
2X6 DIMENSIONAL LUMBER	1238 SF	170.714 LF
AIR FILTRATION BARRIER	802 SF	114.378 LF
EXISTING RETAINING WALL	219 SF	23.208 LF
EXTERIOR SIDING	795 SF	114.378 LF
SYPSUM WALL BOARD 1/2"	3809 SF	321.237 LF
TEXTURED 8" CMU	187 SF	24.623 LF
/APOR RETARDER	802 SF	114.378 LF
02 - COMPL	ETE DEMOLITION CEILING M	MATERIAL TAKEOFF
	ARFA	COMMENT
MATERIAL NAME	ANEA	
MATERIAL NAME SYPSUM WALL BOARD 1/2"	60 SF	
GYPSUM WALL BOARD 1/2"		ATERIAL TAKEOFF
GYPSUM WALL BOARD 1/2"	60 SF	ATERIAL TAKEOFF  COMMENTS
GYPSUM WALL BOARD 1/2" 02 - COMF	60 SF PLETE DEMOLITION ROOF MA	

03 - CON	MPLETE NEW FLOORING MATER	RIAL TAKEOFF
MATERIAL NAME	AREA	COMMENTS
BRICK PAVER HERRINGBONE	15 SF	
CONCRETE	434 SF	
DECK FRAMING VOLUME	446 SF	
DECKING FINISH	446 SF	
FLOOR SHEATHING PLYWOOD	1352 SF	
WOOD FINISH FLOOR 03 - CI	1352-SE NEW WALL MATERIAL	TAKEOFFS
MATERIAL NAME	AREA	LINEAR FOOTAGE
1/2" WALL SHEATHING PLYWOOD	1860 SF	267.003 LF
2X4 DIMENSIONAL LUMBER	1825 SF	275.276 LF
2X6 DIMENSIONAL LUMBER	2236 SF	312.776 LF
AIR FILTRATION BARRIER	1876 SF	267.003 LF
EXTERIOR SIDING	1860 SF	267.003 LF
GYPSUM WALL BOARD 1/2"	5905 SF	648.759 LF
SHOWER GLASS	92 SF	17.073 LF
STONE 01	112 SF	11.969 LF
TEXTURED 8" CMU	704 SF	103.592 LF
VAPOR RETARDER	1876 SF	267.003 LF
03 - CC	MPLETE NEW CEILING MATERI.	AL TAKEOFF
MATERIAL NAME	AREA	COMMENT
GYPSUM WALL BOARD 1/2"	1785 SF	
03 - C	OMPLETE NEW ROOF MATERIA	L TAKEOFF
MATERIAL NAME	AREA	COMMENTS
ASPHALT SHINGLES	1433 SF	
GYPSUM WALL BOARD 1/2"	1431 SF	

MC3 DESIGN



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1308 VINCENT PLACE MCLEAN, VA 22101 SEAL

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REVISIONS

NO.	DESCRIPTION	DATE			
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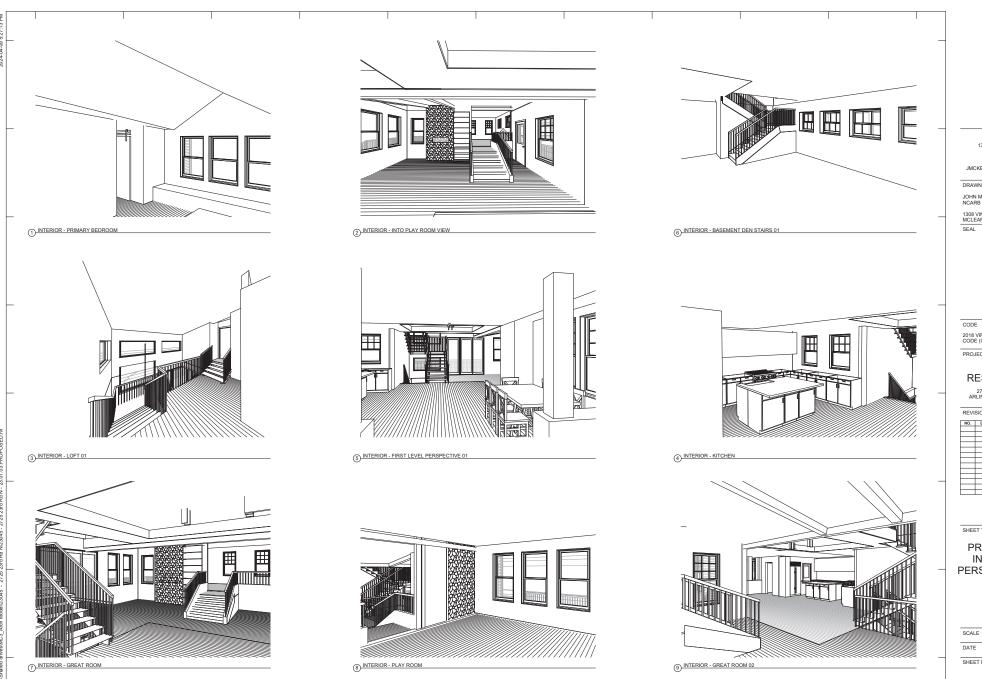
SHEET TITLE

MATERIAL TAKEOFFS

SCALE

DATE 2024.04.09

SHEET NO.



MC3 DESIGN

1308 VINCENT PLACE MCLEAN, VA 22101 202.599.7779 JMCKENNA@MC3.DESIGN

DRAWN BY:

1308 VINCENT PLACE MCLEAN, VA 22101

2018 VIRGINIA RESIDENTIAL CODE (IRC)

PROJECT

## COE RESIDENCE

2725 23RD RD N ARLINGTON, VA 22201

REVISIONS

SHEET TITLE

## PROPOSED INTERIOR PERSPECTIVES

DATE 2024.04.09

SHEET NO.

# Pella® Reserve™

# Traditional Wood & Clad/Wood



Exquisitely designed windows and doors with unparalleled historical detailing.

Double-Hung Interior



## Double-Hung Exterior



#### • Historical details

Our most historically authentic line of wood windows and patio doors. Featuring through-stile construction, deliberate proportions and intricate profiles. Pella Reserve - Traditional products are the ideal choice for historical renovations and traditional building projects.

## • Authentic hardware

Complement your project with historically authentic spoon-lock window hardware. Our Antiek casement window hardware is inspired by period furniture to deliver authentic traditional style.

## • Architectural interest

Featuring the industry's only foam spacer solution, Pella's Integral Light Technology® grille helps capture the look of true-divided-light without sacrificing energy performance. Further your aesthetic with the putty profile, recreated with historically accurate angles – providing meaningful depth and a realistic shadow. Pella Reserve products offer the industry's deepest sash dimension.

### • Virtually unlimited customization

If you can dream it, we can build it with our most customizable product line. From extra tall to extra wide, Pella can craft unique windows that complement your aesthetic. Custom sizes, grille patterns and designs, finishes, wood types and glass options are available.

#### • Tailor-made solutions

From preliminary drawings to installation, Pella's expert team of architects, engineers, drafters and consultants can work to deliver custom window and door solutions for your project. Partner with Pella to achieve your unique vision without concessions.

## • Intentional innovation

Winner of the 2019 Most Innovative Window from Window and Door Magazine, the Integrated Rolscreen® retractable screen preserves aesthetics and the view. It is a double- and single-hung screen that appears when you open the window, and rolls away, out of sight, when you close it.

## • Durable interiors and extruded aluminum exteriors

To help save you time on the jobsite, interior finish options are available in a variety of paints and stains, or primed and ready-to-paint. To complement your exterior aesthetic, choose from our carefully curated color palette or define your own custom color for your project.

### • ENERGY STAR\* certified1

Pella wood products offer energy-efficient options that will meet or exceed ENERGY STAR guidelines in all 50 states. Pella Reserve products with triple-pane glass have been awarded the ENERGY STAR Most Efficient Mark in 2021.

#### • Testing beyond requirements

At Pella, our products are tested beyond requirements to help ensure they have long-lasting performance and reduce call-backs for you.

## • Best limited lifetime warranty<sup>2</sup>

Pella Reserve products are covered by the best limited lifetime warranty in the business for wood windows and patio doors.<sup>2</sup>

## Available in these window and patio door styles:



Special shape windows also available.

12 See back cover for disclosures.

## **Product Specifications**

	Min.	Min.	Max.	Max.	Performance	Performance Values —			
Window & Patio Door Styles	Width	Height	Width	Height	Class & Grade	U-Factor	SHGC	STC	Frame / Install
Awning	13-¾"	13-¾"	59"	59"	LC40-CW50	0.25-0.29	0.18-0.47	27-35	Fold-out Fin, Block Frame, EnduraClad Exterior Trim / Brickmould
Precision Fit Awning	17"	17"	53"	29"	R45-CW50	0.28-0.32	0.18-0.47	27-30	Pocket Replacement
Casement	13-¾"	13-¾"	47"	108"	R35-CW50	0.25-0.29	0.18-0.47	27-34	Fold-out Fin, Block Frame, EnduraClad Exterior Trim / Brickmould
Precision Fit Casement	17"	17"	35"	73"	R35-CW50	0.28-0.33	0.18-0.47	27-30	Pocket Replacement
Fixed Casement	10"	10"	144"	144"	R35-CW50	0.25-0.29	0.18-0.47	27-35	Fold-out Fin, Block Frame, EnduraClad Exterior Trim / Brickmould
Precision Fit Fixed Casement	17"	17"	59"	73"	R45-CW50	0.28-0.33	0.18-0.47	27-30	Pocket Replacement
Double-Hung	14"	24-3/8"	48"	96"	CW30-CW50	0.25-0.30	0.19-0.53	28-35	Fold-out Fin, Block Frame, EnduraClad Exterior Trim / Brickmould
Precision Fit Double-Hung	13-1/2"	23-¾"	48"	84"	CW40-CW50	0.25-0.31	0.19-0.53	26-30	Pocket Replacement
Monumental Hung	13-¾"	24"	72"	144"	LC25-CW50	0.25-0.30	0.17-0.47	29-34	Fold-out Fin, Block Frame, EnduraClad Exterior Trim / Brickmould
In-Swing Hinged Patio Door (Single)	18"	36"	48"	199-1⁄2"	LC40-LC55	0.25-0.29	0.14-0.40	31-35	
In-Swing Hinged Patio Door (Double)	36"	36"	96"	119-1⁄2"	LC40-LC55	0.25-0.29	0.14-0.40	31-35	
Out-Swing Hinged Patio Door (Single)	18"	36"	48"	119-1⁄2"	R50-LC70	0.25-0.30	0.14-0.39	30-36	
Out-Swing Hinged Patio Door (Double)	36"	36"	96"	119-1⁄2"	R50-LC70	0.25-0.30	0.14-0.39	30-36	
Sliding Patio Door (O)	30-¾"	74"	60-¾"	119-1⁄2"	LC40-LC70	0.29-0.32	0.15-0.42	_	
Sliding Patio Door (OX, XO)	59-1/4"	74"	119-1⁄2"	119-1⁄2"	LC35-LC65	0.29-0.32	0.15-0.42	29-35	
Sliding Patio Door (OXO)	90"	74"	180"	119-1⁄2"	LC30-LC45	0.29-0.32	0.15-0.42	-	
Sliding Patio Door (OXXO)	116-1/8"	74"	236-1/8"	119-1⁄2"	LC25-LC40	0.29-0.32	0.15-0.42	_	
Multi-Slide Patio Door	40-1/4"	50-1/2"	701-5/8"	119-1⁄2"	R15-LC25 <sup>3</sup>	0.30 - 0.36	0.15 - 0.46	31	For more info visit PellaADM.com
Bifold Patio Door	31-¾"	55-1/2"	312"	119-1⁄2"	R15-LC25 <sup>3</sup>	0.26-0.44	0.13-0.45	_	

## Window sizes available in 1/8" increments

Special sizes available. For more information regarding performance, visit pella.com/performance. For more information regarding frame and installation types, visit PellaADM.com.

## **Grilles**

## Integral Light Technology®

Choose the look of true divided light featuring the industry's only foam spacer.



Putty Glaze Exterior with Ogee Interior<sup>4</sup> 7/8", 1-1/4" or 2"




Putty Glaze Exterior with Ogee Interior<sup>4</sup> 7/8", 1-1/4" or 2"



Ogee Exterior with Ogee Interior<sup>4</sup> 7/8", 1-1/4" or 2"

## **Cross Sections**

## **Cross Sections**

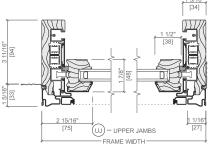

Optional Fold-out Installation Fin


The double-hung cross sections provide visual reference to the historic putty exterior profile and traditional, beveled Ogee interior that add architectural interest to your project.




## HUNG

## **UNIT SECTIONS**

Wood Exterior

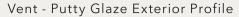



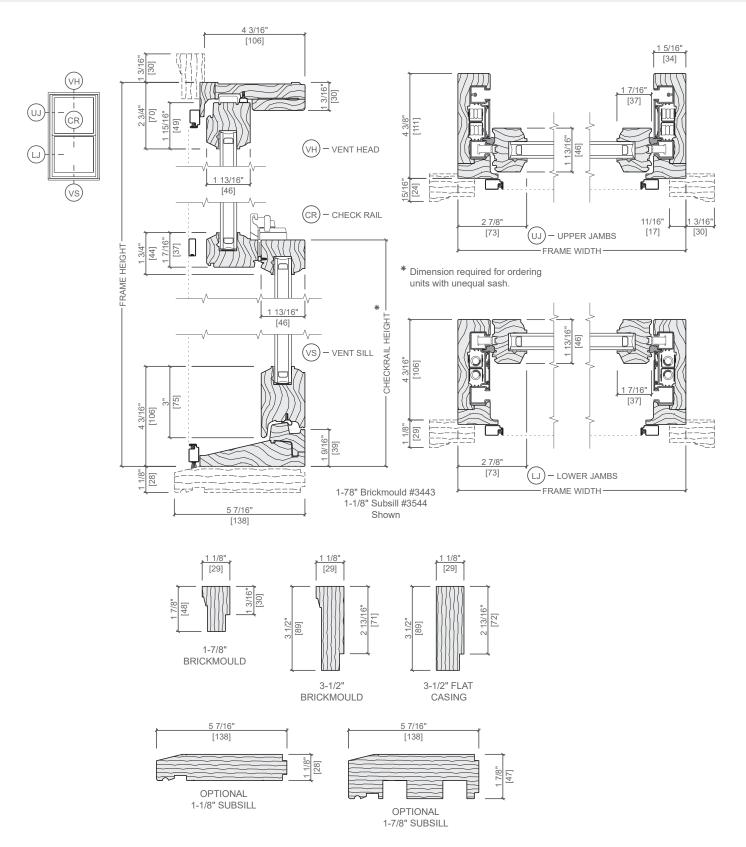



# RESERVE<sup>™</sup> WOOD ENTRY SYSTEM ARCHITECTURAL DETAIL MANUAL



## **Unit Features**

#### **Maximum Sizes:**

Pre-hung doors:

• Maximum: 42" wide x 96" high

Slab doors:

• Maximum: 48" wide × 120" high

Sidelites:

• Maximum: 36" wide × 120" high

Transoms:

• Maximum: 120" wide x 48" high

## **Overall Entry System:**

Factory assembled maximum: 93" wide  $\times$  96" high

Certified units: Rules TBD

System layouts: See page 4 to choose from

available configurations

## **Available Frame Types:**

Uniframe:

Minimum: 4-%6"Maximum: 6-%6"

Single Rabbet:

Minimum: 4-%6" Maximum: 9"

Double Rabbet:

Minimum: 4-%6"
 Maximum: 9"

• With screen door minimum: 6-%6" – maximum: 9"

## Frame Mulling Options:

Prep for field mull

Factory mull

Spread mull:

Minimum: 1"Maximum: 6"Reinforced mull:

Minimum: 1"LVL,Maximum: 2"LVL

## **Sill Options:**

Available as continuous up to 120"

Available with sill horns:

Depth

Minimum: 1-1/16"
 Maximum: 3-7/16"

Length

Minimum: 1"Maximum: 6"

Oak adjustable

Hydrosill

Sill horns not available for Hydrosill™.

ADA sill

Solid honduran mahogany

Solid plain sawn white oak

Solid honduran mahogany with bronze interlock

Solid plain sawn white oak with bronze interlock

## **Sidelite Options:**

600+ Door styles can be configured as sidelites Available in-sash or direct set

## **Transom Options:**

Choose from 23 glass or panel transom options Available in-sash or direct set

Note: all transoms ship separately for field mulling

## **Natural Wood Species:**

Standard 1/16" flitch veneers

Optional 1/8" veneers

- · Stain-grade genuine mahogany
- · Stain-grade mahogany
- · Paint-grade mahogany
- · Douglas fir
- Cherry
- · White oak
- Walnut
- · Paint-grade douglas fir
- Alder

## **Sticking Profiles**

Styles (see pages 22-23)

- OG Roman Ogee
- SS Square Stick
- QB Quarter Bead
- QR Quarter Round
- CB Cove and Bead
- BV Bevel
- OS One Step
- LP Low Profile Bolection Moulding
- CV Cove Moulding
- BBM Big Bolection Moulding
- BM Bolection Moulding

Custom profiles available upon request

## **Panel Profiles:**

Styles (see pages 24-25)

- A Raised
- B Scoop
- C Flat
- D Double Hip
- E Senior Raised
- F Senior Bevel

Custom profiles with size limitations — contact your Sales Rep for more information

## **Unit Features**

## **Glass Types**

Standard insulated glass:

- LoE 272 w/Argon (default)
- LoE 366
- LoE 340 (ELR)
- LoE 180
- · White Lami
- Clear Lami
- Satin Etched
- Low Iron

- Frosted
- · English Reeded
- Glue Chip
- Rain
- Obscure
- Aqualite
- Seedy Wash
- Bevel

## Simulated Divided Lite (SDL) Options

Available in %", 7%", and 1-1%" wide bars

- OG Roman Ogee
- SS Square Stick
- · OB Ouarter Bead
- QR Quarter Round
- CB Cove and Bead
- BV Bevel
- OS One Step

## True Divided Lite (TDL) Options

Only offered in 1-%" wide bars

- OG Roman Ogee
- SS Square Stick
- OB Ouarter Bead
- QR Quarter Round
- CB Cove and Bead
- BV Bevel
- OS One Step

## **Factory Finishing**

Stain-grade: High-quality, exterior-grade factory finishing

> available. See <a href="https://www.trustile.com/">https://www.trustile.com/</a> finishing-options/factory-finishing for finish

options by species

Paint-grade: High-quality, exterior-grade primer standard.

### Hardware

Handle sets not provided

· Ability to machine for any cylindrical or mortise handle set GU Secury Automatic Multipoint available upon request GU Secury Rhino Multpoint lock available upon request

Note: multipoint locks are highly recommended on pair units and doors over 8' tall.

## Hinges

4" × 4" ball bearing, square corner TruStile branded architectural hinges standard

• US14 Polished Nickel

• US15A Antique Nickel

· US26 Polished Chrome

• US26D Satin Chrome

US15 Satin Nickel

#### Colors:

- US19 Flat Black
- US3 Bright Brass
- US4 Satin Brass
- US5 Antique Brass
- US10A Antique Bronze
- US10B Oil-Rubbed Bronze

Emtek and Baldwin hinges available upon request

## Screen Door/Storm Door

Manufactured to match/complement the entry system

Screen options:

- Fiberglass · Aluminum
- Bronze
- Hi-vis
- Pet

## Options:

- Black hydraulic closer (default)
- Screen door handle sets from Emtek and Deltana available as standard options.

## **Casing options**


WM180 – Brick Mould:  $1-\frac{1}{4}$ " thick  $\times$  2" wide

Configurable S4S: Available in all species in

both 3/4" and 1" thicknesses

Revision Date: 2023/4/25 4

# **Entry System Codes – Square-Top**

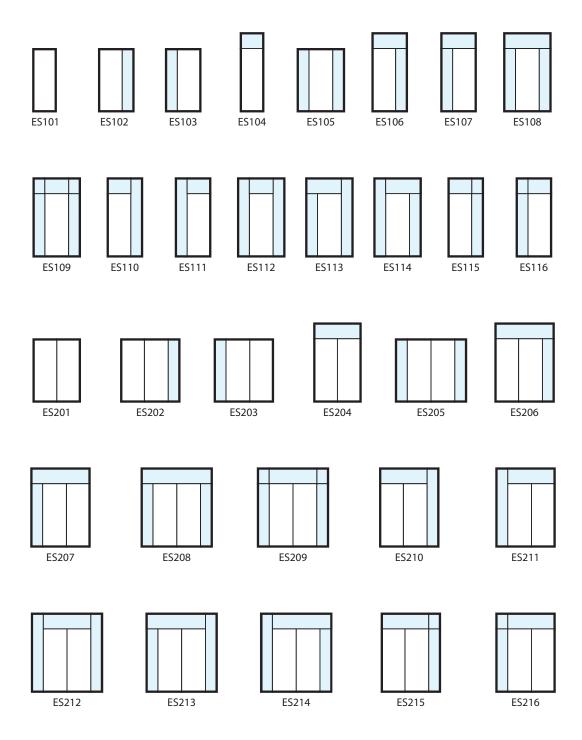



## **400 SERIES**



 $^{\star}2020$  Andersen brand survey of U.S. contractors.

## RELIABLE & ENERGY EFFICIENT

As our best-selling products, the 400 Series product line offers a distinct blend of design, reliability and trade confidence.

Designed for easy installation for replacement, remodel or new construction projects, 400 Series products feature our Perma-Shield® exterior cladding that revolutionized the window industry. They're also backed by our renowned limited warranty and the largest service network in the industry.

# ENERGY-SAVING GLASS FOR ANY CLIMATE

Andersen makes windows and patio doors with options that make them ENERGY STAR® v. 6.0 certified throughout the United States.

Visit andersenwindows.com/energystar for more information and to verify that the product with your glass option is certified in your area.



#### **RIGOROUSLY TESTED**

The exclusive Andersen Perma-Shield system gives our windows and doors a tough, protective shell that safeguards the wood inside. It repels water, resists dents\* and stays beautiful for years.

## LOW MAINTENANCE, NEVER NEEDS PAINTING

The Perma-Shield exteriors on Andersen 400 Series windows and doors offer superior weather resistance and are virtually maintenance free.



# OPTIONS FOR THE HARSHEST WEATHER

400 Series windows with Stormwatch®
Protection meet building code
requirements in coastal areas.\*\* Products
with Stormwatch Protection are energy
efficient, resist the effects of salt water,
and stand up to hurricane-force winds
and wind-borne debris.\*\* For details, visit
andersenwindows.com/coastal.



# QUALITY SO SOLID, THE WARRANTY IS TRANSFERABLE

Many other window and door warranties end when a home is sold, but our coverage – 20 years on glass, 10 years on non-glass parts – transfers from each owner to the next. And because it's not prorated, the coverage offers full benefits year after year, owner after owner. So it can add real value when you decide to sell your home.



## **BUILT FOR YEARS TO COME**\*

Our products are built strong to last long.\*

We use the right materials in the right places, including solid wood, fiberglass and our own Fibrex® composite material.

These give our windows and doors superior strength, stability and long-term beauty.

### **KEEPS THE WEATHER OUT**

Our weather-resistant construction and careful selection of weatherstrip by product type seals out drafts, wind and water whatever the weather.

## REPLACEMENT SOLUTIONS

Homeowners and realtors agree that Andersen products increase the value of a home by at least 10%. So you're not just replacing their windows, you're upgrading their home.

#### **INSERT WINDOWS**



400 Series Woodwright® Double-Hung Insert Windows

The classic, traditional style of Woodwright full-frame windows in a time-saving insert.



400 Series Tilt-Wash Double-Hung Insert Windows

Our best-selling double-hung windows in an insert for easy replacement.

#### **REPLACEMENT WINDOWS**



400 Series Replacement Casement & Awning Windows

Available without an installation flange for easy window replacement from inside or outside. Feature predrilled, through-the-jamb installation holes for quick installation.

Our insert and replacement windows include flat self-hanging shims, backer rod, installation screws and complete instructions.



## CUSTOM-SIZE FULL-FRAME WINDOWS

When the existing window frame is rotted or deteriorated, or you're modifying the size or shape of the existing window opening, our full-frame doublehung, casement, awning and specialty windows are available in custom sizes to fit your project.





## CUSTOM-SIZE PATIO DOORS

Whether you need a hinged or gliding patio door for replacement, Andersen has a number of customsize options to fit your project.



<sup>\*2020</sup> Andersen brand surveys of U.S. realtors and homeowners.

## **PRODUCT OVERVIEW**



## Double-Hung Windows

Choose Woodwright® double-hung windows that replicate the look of traditional architecture or our best-selling tilt-wash double-hung windows that are extremely energy efficient. Both are available as full-frame or insert windows, and can be part of bay window combinations. Coordinating picture and transom windows are also available.



## **Specialty Windows**

A collection of stylish shapes to help distinguish a home's style or create a delicate accent.



Woodwright full-frame windows come in a variety of shapes.



Our Narroline® double-hung window conversion kit can upgrade Andersen® Narroline double-hung windows to tilt-wash windows.



Complementary specialty windows offer 35 additional shapes and custom sizes.



## Casement & Awning Windows

Casement and awning windows are energy efficient, and are built with our low-maintenance Perma-Shield® cladding. Available for new construction or replacement, as integral twin or triple units, or as part of bay or bow window combinations. Coordinating picture and transom windows are also available.



## Gliding Windows

Superior energy efficiency, reliable performance and uncommon beauty.

Both sash on our gliding windows open for improved ventilation.





Frame any Frenchwood patio door with Frenchwood patio door sidelights and transoms.

## Frenchwood® Gliding & Hinged Inswing Patio Doors

Wide wood profiles provide the authentic craftsmanship of traditional French doors, and our Perma-Shield exterior cladding protects the unit and offers low maintenance. Add blinds-between-the-glass to conveniently control light and privacy. To learn more about other traditional- and contemporary-style Andersen door options, visit andersenwindows.com/doors.



Complementary curved top patio doors, including Springline™ and arch hinged doors, are handcrafted and complement our 400 Series products.

## **GLASS OPTIONS**

Andersen has the glass you need to get the performance you want. From SmartSun™ glass with HeatLock® coating that's ENERGY STAR® certified in all climate zones\* to PassiveSun® glass that helps heat homes in northern areas, there's an option for every climate, project and customer. Check with your supplier for selections that meet ENERGY STAR requirements in your area.

		ENE	RGY	LIGHT		
GLASS		U-Factor  How well a product prevents heat from escaping.	Solar Heat Gain Coefficient How well a product blocks heat caused by sunlight.	Visible Light Transmittance How much visible light comes through a product.	UV Protection  How well a product blocks ultraviolet rays.	
Low-E4®	Outstanding overall performance for climates where both heating and cooling costs are a concern.	• • • •	• • • •	• • • •	• • • •	
Low-E4 with HeatLock® Coating	Applied to the room-side surface, it reflects heat back into the home and improves U-Factor values.	• • • •	• • • •	• • • •	• • • 0	
SmartSun™	Thermal control similar to tinted glass, with visible light transmittance similar to Low-E4 glass.	• • • •	• • • •	• • • •	• • • •	
SmartSun with HeatLock Coating	Applied to the room-side surface, it reflects heat back into the home and improves U-Factor values.	• • • 0	• • • •	• • • •	• • • •	
Sun	Outstanding thermal control in southern climates where less solar heat gain is desired.	• • • •	• • • •	• 0 0 0	• • • •	
PassiveSun®	Ideal for northern, passive solar construction applications where solar heat gain is desired.	• • • •	• 0 0 0	• • • •	• • • •	
PassiveSun with HeatLock Coating	Applied to the room-side surface, it reflects heat back into the home and improves U-Factor values.	• • • •	• 0 0 0	• • • •	• • • •	
Clear Dual-Pane	High visibility with basic thermal performance.	• 0 0 0	0000	• • • •	0000	

Center of glass performance only. Ratings based on glass options as of May 2021. Visit andersenwindows.com/energystar for ENERGY STAR map and NFRC total unit performance data.

#### **HEATLOCK TECHNOLOGY**

Applied to the room-side glass surface, HeatLock coating reflects heat back into the home for improved performance.

## STORMWATCH® PROTECTION

Most Andersen 400 Series windows are available with impact-resistant glass and structural upgrades to meet the tough building codes of hurricane-prone coastal areas. See your local code official for specific requirements.



#### **ADDITIONAL GLASS OPTIONS**

Tempered safety glass is standard on patio doors and required for larger window sizes.

Laminated glass is available for added strength, enhanced security and sound control.

Patterned glass lets in light while obscuring vision and adds a unique, decorative touch. Cascade and Reed patterns can be ordered with either a vertical or horizontal orientation.



Satin Etch

Reed

#### **ART GLASS**

With art glass panels from Andersen, you can add interest, create focal points and make your work stand out. See page 173 or visit andersenwindows.com/artglass

for more information.

#### **TIME-SAVING FILM**

We protect our products during delivery and construction with translucent film on the glass that peels away for a virtually spotless window.

For more details on our glass options, visit andersenwindows.com/glass.



<sup>\*</sup>Andersen 400 Series products only with SmartSun glass with HeatLock coating (argon gas blend), no grilles, no capillary breather tubes. Excludes patterned/textured glass. "ENERGY STAR" is a registered trademark of the U.S. Environmental Protection Agency.



## **GRILLE OPTIONS**

Grille patterns are available in widths and configurations to fit any architectural style or the taste of any customer. We can match virtually any existing grille pattern, and we'll even work with you and your customers to create custom patterns.



## **FULL DIVIDED LIGHT**

Permanently applied to the interior and exterior of the window, with a spacer between the glass.



Permanent exterior Permanent interior



Permanent exterior Removable interior

## SIMULATED DIVIDED LIGHT

Permanent grilles on the exterior and interior, with no spacer between the glass. We also offer permanent exterior grilles with removable interior grilles.



Removable interior




Finelight grillesbetweenthe-glass\*

## **CONVENIENT CLEANING OPTIONS**

Removable interior grilles come off for easy cleaning. Finelight<sup>™</sup> grilles-between-the-glass are installed between the glass panes, and feature a contoured profile in 1" (25) and 3/4" (19) widths.

## Grille Bar Widths & Patterns

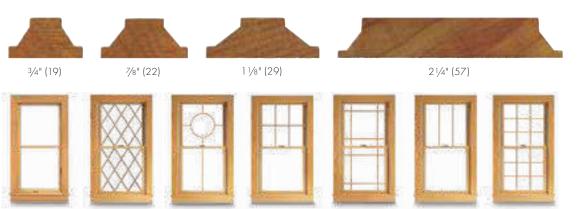

Actual width shown.

Our 21/4" (57) width grille can be positioned horizontally across the center of a casement window to simulate the look of a double-hung window.

To see all of the standard patterns available for a specific window or door, refer to the detailed product sections in this product guide.





## **FEATURES**

#### FRAME

A seamless one-piece, rigid vinyl frame cover is secured to the exterior of the frame to protect the wood frame from moisture and maintain an attractive appearance while minimizing maintenance.

B The seamless rigid vinyl cover extends 1 3/8" (35) around the perimeter of the unit, creating a flange to help seal the unit to the structure.

• Wood frame members are treated with a water-repellent preservative for long-lasting\* protection and performance.

• Interior stops are unfinished pine. Low-maintenance prefinished white, dark bronze and black\*\* interiors are also available.

#### **SASH**

• Rigid vinyl encases the entire sash - a vinyl weld protects each sash corner for superior weathertightness. It maintains an attractive appearance and minimizes maintenance.

• Wood core members provide excellent structural stability and energy efficiency.

**6** Vinyl closed-cell foam weatherstrip is factory installed on the perimeter of the sash.

## **GLASS**

1 In addition to stainless steel glass spacers, black or white glass spacers are now available to allow the spacer to blend in with the unit color.

 A glazing bead and silicone provide superior weathertightness and durability.

High-Performance options include:


- Low-E4® glass
- · Low-E4 HeatLock® glass
- Low-E4 SmartSun™ glass
- · Low-E4 SmartSun HeatLock glass
- · Low-E4 Sun glass

Tempered and other glass options are available. Contact your Andersen supplier.

A removable translucent film helps shield the glass from damage during delivery and construction, and simplifies finishing at the job site.

#### Patterned Glass

Patterned glass options are available. See page 12 for more details.

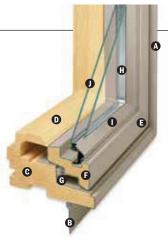

#### **HARDWARE**

#### Smooth Control Hardware System



The smooth control hardware system employs a worm gear drive for easy operation. Units with a wash mode have hinges that move the sash away from the frame to provide easier glass

cleaning. CXW15, CXW155, CXW16 and CXW25 sizes not available with wash mode. Hardware option and finish must be specified. Operator handle and cover sold separately.

#### Single-Actuation Casement Lock



On casement windows, a singleactuation lock easily releases all locking points on the casement sash while the reach-out action eliminates binding when closing. The lock handle is offered in finishes that coordinate with your specified hardware option.

#### Awning Sash Locks



Awning sash locks provide an added measure of security and weathertightness. Hardware style and finish options are compatible with Andersen® casement windows to ensure consistency in appearance when used in window combination designs.

Dimensions in parentheses are in millimeters.

Printing limitations prevent exact replication of colors and finishes. See your Andersen supplier for actual color and finish samples.

## **Stormwatch**

400 Series casement and awning windows are available with Stormwatch® Protection. For more details, visit andersenwindows.com/coastal

#### Performance Grade (PG) Upgrades

Performance upgrades are available for select sizes of standard, non-impact casement and awning windows,

allowing these units to achieve higher performance ratings. Performance Grade (PG) ratings are more comprehensive than Design Pressure (DP) ratings for measuring product performance. Visit andersenwindows.com for up-to-date performance information of individual products. Contact your Andersen supplier for availability.

## **EXTERIOR & INTERIOR OPTIONS**

#### **EXTERIOR COLORS**



## **INTERIOR OPTIONS**



## HARDWARE OPTIONS Sold Separately



#### **CONTEMPORARY FOLDING**

Black | Bright Brass | Gold Dust Oil Rubbed Bronze | Satin Nickel Stone | White



## TRADITIONAL FOLDING

Antique Brass | Black | Bright Brass Distressed Bronze | Distressed Nickel Gold Dust | Oil Rubbed Bronze Satin Nickel | Stone | White

Folding handles avoid interference with window treatments



Stone | White

Bold name denotes finish shown.



#### **ESTATE**™

Antique Brass | Bright Brass Brushed Chrome | Distressed Bronze Distressed Nickel | Oil Rubbed Bronze Polished Chrome | Satin Nickel

### **HARDWARE FINISHES**



Naturally occurring variations in grain, color and texture of wood make each window one of a kind. All wood interiors are unfinished unless a finish is specified. Distressed bronze and oil rubbed bronze are "living" finishes that will change with time and use.

<sup>\*</sup>Visit andersenwindows.com/warranty for details.

<sup>\*\*</sup>Products with dark bronze and black interiors have matching exteriors.





## WOODWRIGHT® DOUBLE-HUNG FULL-FRAME WINDOWS

## **FEATURES**

#### FRAME

A Perma-Shield® exterior cladding protects the frame - beautifully. Best of all, it's low maintenance and never needs painting.\*

B For exceptional long-lasting\* performance, sill members are constructed with a wood core and a Fibrex® material exterior.

• Natural wood stops are available in pine, maple, oak and prefinished white. Wood jamb liners add beauty and authenticity to the window interior.

• A factory-applied rigid vinyl flange on the head, sill and sides of the outer frame helps secure the unit to the structure.

 Multiple weatherstrip systems help provide a barrier against wind, rain and dust. The combination of springtension vinyl, rigid vinyl and flexible bulb weatherstrip is efficient and effective.

• For units with white exterior color, the exterior jamb liner is white. For all other units, the exterior jamb liner is gray.

#### **SASH**

@ Balancers in the sash enable contractors to screw through the jamb during installation without interfering with the window's operation.


#### Wood Jamb Liner



• Natural wood sash interior with classic chamfer detailing. Available in pine, maple, oak or prefinished white.

O Low-maintenance sash exterior provides long-lasting\* protection and performance. Sash exteriors on most units include Fibrex material.

Sash joints simulate the look of traditional mortise-and-tenon construction inside and out

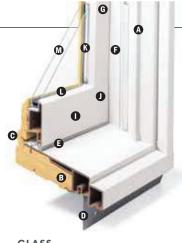

#### GLASS

**(6)** In addition to stainless steel glass spacers, black or white glass spacers are now available to allow the spacer to blend in with the unit color.

Silicone bed glazing provides superior weathertightness and durability.

M High-Performance options include:

- · Low-E4® glass
- Low-E4 HeatLock® glass
- Low-E4 SmartSun<sup>™</sup> glass
- Low-E4 SmartSun HeatLock glass
- · Low-E4 Sun glass

Tempered and other glass options are available. Contact your Andersen supplier.

A removable translucent film helps shield the glass from damage during delivery and construction, and simplifies finishing at the job site.

#### Patterned Glass

Patterned glass options are available. See page 12 for more details.

### HARDWARE



Standard lock and keeper design provides an easy tilt-to-clean feature integrated into the lock.

## **EXTERIOR & INTERIOR OPTIONS INTERIOR OPTIONS**

# **EXTERIOR COLORS**





## **HARDWARE**

Bronze



Green

Standard Lock & Keeper

Antique Brass | **Black** | Bright Brass Brushed Chrome | Distressed Bronze Distressed Nickel | Gold Dust Oil Rubbed Bronze | Polished Chrome Satin Nickel | Stone | White

## **OPTIONAL HARDWARE** Sold Separately

#### CONTEMPORARY



Available in all hardware finishes. Shown in Distressed Nickel

## **ESTATE™**



Hand Lift Finger Lifts

Antique Brass | Bright Brass Brushed Chrome | Distressed Bronze Distressed Nickel | Oil Rubbed Bronze Polished Chrome | Satin Nickel









Antique Brass | Black | Bright Brass | Brushed Chrome Distressed Bronze | Distressed Nickel | Gold Dust | Oil Rubbed Bronze

**TRADITIONAL** 

# Polished Chrome | Satin Nickel | Stone | White

## **CLASSIC SERIES™**







Stone | White

Bold name denotes finish shown.

#### HARDWARE FINISHES

Bronze



Nickel

Dimensions in parentheses are in millimeters.

Printing limitations prevent exact replication of colors and finishes. See your Andersen supplier for actual color and finish samples.

Naturally occurring variations in grain, color and texture of wood make each window one of a kind. All wood interiors are unfinished unless a finish is specified.

Distressed bronze and oil rubbed bronze are "living" finishes that will change with time and use.

<sup>\*</sup>Visit andersenwindows.com/warranty for details.



## **Stormwatch**

#### Performance Grade (PG) Upgrades

Performance upgrades are available for select sizes of standard, non-impact Woodwright® windows allowing these units to achieve higher performance ratings.

Performance Grade (PG) ratings are more comprehensive than Design Pressure (DP) ratings for measuring product performance. For up-to-date performance information of individual products, visit andersenwindows.com. Use of this option will subtract 5/s® (16) from clear opening height. Contact your Andersen supplier for availability.

Visit andersenwindows.com/coastal for more information on Stormwatch® Protection.

#### **SHAPES**

Woodwright windows are available in the following shapes.





Double-Hung

Springline™ Single-Hung





Arch Double-Hung

Unequal Leg Arch Double-Hung

#### SASH OPTIONS



## **ACCESSORIES** Sold Separately

#### FRAME

#### Extension Jambs



Standard jamb depth is 4 ½" (114). Extension jambs are available in unfinished pine or prefinished white. Some sizes may be veneered.

Factory-applied and non-applied interior extension jambs are available in 1/16" (1.5) increments between 5 1/4" (133) and 7 1/8" (181). Extension jambs can be factory applied to either three sides (stool and apron application) or four sides (picture frame casing).

#### Pine Stool



A clear pine stool is available and ready for finishing. The Woodwright stool is available in 4% (116) for use in wall depths up to  $5\frac{1}{4}$ " (133) and 6% (167) for use in wall depths up to  $7\frac{1}{4}$ " (181). Works with  $2\frac{1}{4}$ " (57) and  $2\frac{1}{4}$ " (64) casing widths. Shown above on a 400 Series tilt-wash double-hung window.

#### **HARDWARE**

#### Window Opening Control Device



A window opening control device is available, which limits sash travel to less than 4" (102) when the window is first opened. Available factory applied, or as a field-applied kit in stone or white.

## STORM/INSECT SCREEN COMBINATION UNIT"



A self-storing storm window combined with an insect screen provides greater energy efficiency, while allowing ventilation when needed.

Constructed with an aluminum frame, single-pane upper and lower glass panels, and charcoal powder-coated aluminum screen mesh. Available in white, Sandtone and Terratone to match product exteriors. Canvas, dark bronze, forest green and black are available by special order.

Combination units can improve Sound Transmission Class (STC) and Outdoor Indoor Transmission Class (OITC) ratings. Ideal for projects near airports, busy roadways or other noisy environments. For example, adding a combination unit to a 400 Series till-wash double-hung (3862) unit with Low-E4® glass will improve its STC rating from 26 to 32. Contact your Andersen supplier for additional STC and OITC rating information.

#### **INSECT SCREENS**

#### Insect Screen Frames



Choose full insect screen or half insect screen. Half insect screen (shown above) allows ventilation without affecting the view through the upper sash. Frames are available in colors to match product exteriors.

#### TruScene® Insect Screens

Andersen TruScene insect screens let in over 25% more fresh air† and provide 50% greater clarity than conventional Andersen insect screens, all while keeping out unwanted small insects.

#### Conventional Insect Screens

Conventional insect screens have charcoal powder-coated aluminum screen mesh.

## GRILLES

Grilles are available in a variety of configurations and widths. For doublehung grille patterns, see page 63.

#### **EXTERIOR TRIM**

Available with Andersen® exterior trim. See exterior trim section starting on page 175.

### CAUTION:

- Painting and staining may cause damage to rigid vinyl.
- 400 Series windows in Terratone color may be painted any color lighter than Terratone color using quality oil-based or latex paint.
- Do not paint 400 Series windows with white, canvas, Sandtone, dark bronze, forest green or black exterior colors.
- Andersen does not warrant the adhesion or performance of homeowner-applied paint over vinyl or other factory-coated surfaces.
- For vinyl painting instructions and preparation, contact your Andersen supplier.
- Do not paint weatherstrip
- Creosote-based stains should not come in contact with Andersen products.
- Abrasive cleaners or solutions containing corrosive solvents should not be used on Andersen products.

<sup>\*</sup>Shown on 400 Series tilt-wash double-hung windows.

<sup>\*\*</sup>Do not add combination units to windows with Low-E4 Sun glass unless window glass is tempered. Combination units may also reduce the overall clear operable area of the window. See your local code official for egress requirements in your area.

<sup>†</sup>TruScene insect screens let in over 25% more fresh air than standard Andersen fiberglass insect screens. Dimensions in parentheses are in millimeters.

## WOODWRIGHT® DOUBLE-HUNG FULL-FRAME WINDOWS

#### Table of Woodwright Double-Hung Window Sizes Notes on the next page also apply to this page. Scale $\frac{1}{8}$ " (3) = 1'-0" (305) -1:962:3 cottage or 3:2 reverse cottage sash 1'-9 5/8" 2'-1 5/8" 2'-5 5/8" 2'-7 5/8" 2'-9 5/8" 2'-11 5/8" 3'-1 5/8" 3'-5 5/8" 3'-9 5/8" Window Dimension ratio available for all widths and heights. (549) (651)(752)(803)(854)(905)(956)(1057)(1159)Size tables for windows with cottage or 2'-10 <sup>1</sup>/8" 1'-10 <sup>1</sup>/8' 2'-6 1/8 3'-10 1/8" 2'-2 1/8" 2'-8 1/8 3'-0 1/8' 3'-2 1/8" 3'-6 1/8" reverse cottage sash are available at **Rough Opening** (562) (664) (765) (816) (867) (917) (968) (1070) (1172) andersenwindow.com/sizing. CUSTOM WIDTHS -15 5/8" 19 5/8" 23 5/8" 25 5/8" 27 5/8" 29 5/8" 31 5/8" 39 5/8" 35 5/8" **Unobstructed Glass** 1'-4 1/2" (419) to 3'-9 5/8" (1159) [(397)] [(498)] (600) (651) (702) (752) (803) (905) (1006)(lower sash only) CUSTOM HEIGHTS -CUSTOM WIDTHS - 16 1/2" to 45 5/8 3'-0 <sup>7</sup>/8" (937) to 6'-4 <sup>7</sup>/8" (1953) 32" to 76 7/8" 3'-0 7/8" 13 3/8" (340)(937) **WDH**38210 WDH18210 WDH20210 WDH24210 WDH26210 **WDH**28210 WDH210210 **WDH**30210 WDH34210 Reverse Cottage 15 3/8" (391) (1038)HEIGHTS WDH1832 WDH2032 WDH2432 WDH2632 WDH2832 WDH21032 **WDH**3032 **WDH**3432 **WDH**3832 CUSTOM 3'-8 7/8" (1140)17 3/8" (441) WDH1836 WDH2036 **WDH**2436 WDH2636 WDH2836 WDH21036 WDH3036 WDH3436 WDH3836 4'-0 7/8" (1241)19 3/8" (492)WDH18310 WDH20310 WDH24310 WDH210310 WDH30310 WDH26310 WDH28310 **WDH**34310 WDH38310 (1343)(1343)21 3/8" (543) WDH1842 WDH2042 WDH2442 WDH2642 WDH2842 WDH21042 **WDH**3042 **WDH**3442 **WDH**3842 4'-8 7/8" 22 3/4" (577) (1445)WDH1846 WDH2046 WDH2646 WDH2846 **WDH**21046 WDH3046 **WDH**3446◊ **WDH**3846 **WDH**2446 18/2 0-19 (1546)25 3/8" (1546)(645)WDH28410 WDH210410◊ WDH30410 WDH34410 WDH18410 WDH20410 WDH24410 WDH26410 WDH38410 5'-4 7/8" (1648)27 3/8" (1648)(692)WDH1852 WDH2052 **WDH**2452 WDH2652 WDH28520 WDH21052◊ WDH30520 WDH3452<sup>◊</sup> WDH3852<sup>◊</sup> 18/2 8-19 29 3/8" (746) (1749)WDH1856 WDH2056 **WDH**2456 **WDH**2656<sup>◊</sup> **WDH**2856<sup>◊</sup> WDH21056 WDH3056 **WDH**3456 WDH3856 ..8/2 0-.9 .8/2 0-.9 (1851)(1851)31 3/8" 797) WDH18510 WDH20510 WDH24510 WDH26510 WDH28510 WDH210510 **WDH**30510◊ WDH34510 WDH38510 6'-4 7/8" (1953) (1953)33 3/8" (848)

**WDH**2862◊

WDH210620

WDH3062◊

WDH3462◊

WDH38620

WDH1862 WDH2062

WDH2462◊

WDH2662◊

## WOODWRIGHT® DOUBLE-HUNG FULL-FRAME WINDOWS

## Table of Woodwright Transom Window Sizes

Scale  $\frac{1}{8}$ " (3) = 1'-0" (305) - 1:96

## Notes on the next page also apply to this page.

Window Dimension	1'-9 5/8"	2'-1 <sup>5</sup> /8" (651)	2'-5 <sup>5</sup> /8" (752)	2'-7 5/8" (803)	2'-9 <sup>5</sup> /8" (854)	2'-11 <sup>5</sup> /8" (905)	3'-1 <sup>5</sup> /8" (956)	3'-5 <sup>5</sup> /8" (1057)	3'-9 <sup>5</sup> /8" (1159)	3'-11 <sup>5</sup> / <sub>16</sub> " (1202)
Minimum Rough Opening	1'-10 ½" (562)	2'-2 <sup>1</sup> /8" (664)	2'-6 <sup>1</sup> /8" (765)	2'-8 <sup>1</sup> /8" (816)	2'-10 <sup>1</sup> /8" (867)	3'-0 <sup>1</sup> /8" (917)	3'-2 <sup>1</sup> /8" (968)	3'-6 <sup>1</sup> /8" (1070)	3'-10 <sup>1</sup> /8" (1172)	3'-11 <sup>7</sup> /8" (1215)
Unobstructed Glass	15 <sup>5</sup> /8" (397)	19 <sup>5</sup> /8" (498)	23 5/8" (600)	25 <sup>5</sup> /8" (651)	27 <sup>5</sup> /8" (702)	29 <sup>5</sup> /8" (752)	31 <sup>5</sup> /8" (803)	35 <sup>5</sup> /8" (905)	39 <sup>5</sup> / <sub>8</sub> " (1006)	41 1/4" (1048)
		WIDTHS – 12	" to <b>75</b> 5/16"							
1'-0 " (305) 1'-0 1/2" (318) 6 13/16" (173)		WTR2010	<b>WTR</b> 2410	<b>WTR</b> 2610	WTR2810	WTR21010	WTR3010	WTR3410	<b>WTR</b> 3810	WTR31010
1'-7 5/16" (491) 1'-7 7/8" (504) 14 1/8"	WTR1815	WTR2015	WTR2415	WTR2615	WTR2815	WTR21015	WTR3015	WTR3415	WTR3815	WTR31015
1'-9 5/16" (541) 1'-9 7/8" (555) 16 1/8" (410)		WTR2017	<b>WTR</b> 2417	WTR2617	WTR2817	WTR21017	<b>WTR</b> 3017	WTR3417	WTR3817	WTR31017
2'-15/16" (643) 2'-17/8" (657) 201/8" (511)	WTR18111	WTR20111	WTR24111	WTR26111	WTR28111	WTR210111	WTR30111	WTR34111	WTR38111	WTR310111
2'-3 5/4e" (694) 2'-3 7/8" (707) 22 1/8" (562)	WTR1821	WTR2021	WTR2421	WTR2621	WTR2821	WTR21021	WTR3021	WTR3421	WTR3821	WTR31021
2'-5 5/16" (745) 2-5 7/8" (758) 24 1/8" (613)	WTR1823	WTR2023	WTR2423	WTR2623	WTR2823	WTR21023	WTR3023	WTR3423	WTR3823	WTR31023
2'-9 5/16" (846) 2'-9 7/8" (860) 28 1/8" (714)	WTR1827	WTR2027	WTR2427	WTR2627	WTR2827	WTR21027	WTR3027	WTR3427	WTR3827	WTR31027
3'-3 5/16" (999) 3'-3 7/8" (1012) 34 1/8" (867)	WTR1831	WTR2031	WTR2431	WTR2631	WTR2831	WTR21031	WTR3031	WTR3431	WTR3831	WTR31031

## **Woodwright® Transom Window Area Specifications**

Window Number	Ar	ass ea t./(m²)	Overall Window Area Sq. Ft./(m²)		
WTR1810	0.74	(0.07)	1.80	(0.17)	
WTR1815	1.53	(0.14)	2.90	(0.27)	
WTR1817	1.75	(0.16)	3.20	(0.30)	
WTR18111	2.18	(0.20)	3.80	(0.35)	
WTR1821	2.40	(0.22)	4.10	(0.38)	
WTR1823	2.62	(0.24)	4.40	(0.41)	
WTR1827	3.05	(0.28)	5.00	(0.46)	
WTR1831	3.70	(0.34)	5.90	(0.55)	
WTR2010	0.93	(0.09)	2.14	(0.20)	
WTR2015	1.93	(0.18)	3.44	(0.32)	
WTR2017	2.20	(0.20)	3.79	(0.35)	
WTR20111	2.74	(0.25)	4.50	(0.42)	
WTR2021	3.02	(0.28)	4.86	(0.45)	
WTR2023	3.29	(0.31)	5.22	(0.48)	
WTR2027	3.83	(0.36)	5.93	(0.55)	
WTR2031	4.65	(0.43)	7.00	(0.65)	
WTR2410	1.12	(0.10)	2.47	(0.23)	
WTR2415	2.32	(0.22)	3.97	(0.37)	
WTR2417	2.65	(0.25)	4.38	(0.41)	
WTR24111	3.30	(0.31)	5.21	(0.48)	

Window Number	Ar	ass ea t./(m²)	Overall Window Area Sq. Ft./(m²)		
WTR2421	3.63	(0.34)	5.62	(0.52)	
WTR2423	3.96	(0.37)	6.03	(0.56)	
WTR2427	4.61	(0.43)	6.85	(0.64)	
WTR2431	5.60	(0.52)	8.09	(0.75)	
WTR2610	1.21	(0.11)	2.64	(0.24)	
WTR2615	2.51	(0.23)	4.24	(0.39)	
WTR2617	2.87	(0.27)	4.68	(0.43)	
WTR26111	3.58	(0.33)	5.56	(0.52)	
WTR2621	3.94	(0.37)	6.00	(0.56)	
WTR2623	4.29	(0.40)	6.44	(0.60)	
WTR2627	5.00	(0.46)	7.32	(0.68)	
WTR2631	6.07	(0.56)	8.63	(0.80)	
WTR2810	1.31	(0.12)	2.80	(0.26)	
WTR2815	2.71	(0.25)	4.51	(0.42)	
<b>WTR</b> 2817	3.09	(0.29)	4.98	(0.46)	
WTR28111	3.86	(0.36)	5.91	(0.55)	
WTR2821	4.24	(0.39)	6.38	(0.59)	
WTR2823	4.63	(0.43)	6.84	(0.64)	
WTR2827	5.40	(0.50)	7.78	(0.72)	
WTR2831	6.55	(0.61)	9.18	(0.85)	

Window Number	Ar	ass ea t./(m²)	Overall Window Area Sq. Ft./(m²)		
WTR21010	1.40	(0.13)	2.97	(0.28)	
WTR21015	2.91	(0.27)	4.78	(0.44)	
WTR21017	3.32	(0.31)	5.27	(0.49)	
WTR210111	4.14	(0.38)	6.26	(0.58)	
WTR21021	4.55	(0.42)	6.76	(0.63)	
WTR21023	4.96	(0.46)	7.25	(0.67)	
WTR21027	5.79	(0.54)	8.24	(0.77)	
WTR21031	7.02	(0.65)	9.73	(0.90)	
WTR3010	1.50	(0.14)	3.14	(0.29)	
WTR3015	3.10	(0.29)	5.05	(0.47)	
WTR3017	3.54	(0.33)	5.57	(0.52)	
WTR30111	4.42	(0.41)	6.61	(0.61)	
WTR3021	4.86	(0.45)	7.14	(0.66)	
WTR3023	5.30	(0.49)	7.66	(0.71)	
WTR3027	6.18	(0.57)	8.70	(0.81)	
WTR3031	7.49	(0.70)	10.27	(0.95)	
WTR3410	1.69	(0.16)	3.47	(0.32)	
WTR3415	3.49	(0.32)	5.58	(0.52)	

<sup>•</sup> Dimensions in parentheses are in square meters.

continued on next page

<sup>• &</sup>quot;Window Dimension" always refers to outside frame-to-frame dimension.
• "Minimum Rough Opening" dimensions may need to be increased to allow for use of building wraps, flashing, sill panning, brackets, fasteners or other items. See pages 210-211 for more details.
• Dimensions in parentheses are in millimeters.



4'-3 5/16"		4'-11 5/16"		5'-7 5/16"		6'-3 5/16"
(1303)	Ī	(1506)	Ĭ '	(1710)		(1913)
4'-3 7/8"		4'-11 7/8"		5'-7 <sup>7</sup> /8"		6'-3 7/8"
(1317)		(1520)	<b>1</b> '	(1724)		(1927)
45 1/4"		53 1/4"		61 <sup>1</sup> /4"		69 1/4"
(1149)	Ĭ	(1353)	T '	(1556)		(1745)
(1149)	- 1	(1353)	1	(1556)	1	(1/45)

WTR4210	<b>WTR</b> 41010	<b>WTR</b> 5610	WTR6210
WTR4215	<b>WTR</b> 41015	WTR5615	WTR6215
<b>WTR</b> 4217	<b>WTR</b> 41017	WTR5617	WTR6217
WTR42111	WTR410111	WTR56111	WTR62111
WTR4221	WTR41021	WTR5621	WTR6221
WTR4223	WTR41023	WTR5623	WTR6223
WTR4227	<b>WTR</b> 41027	WTR5627	WTR6227
WTR4231	WTR41031	WTR5631	WTR6231
• "Window Dimension	" always refers to outside fr	ame-to-frame dimension.	



Custom-size windows are available in 1/8" (3) increments. See page 62 for custom sizing.

Grille patterns shown on page 63.

## **Woodwright® Transom Window Area** Specifications (continued)

Window Number	Glass Area Sq. Ft./(m²)		Overall Window Area Sq. Ft./(m²)		
WTR3417	3.99	(0.37)	6.16	(0.57)	
WTR34111	4.98	(0.46)	7.32	(0.68)	
WTR3421	5.47	(0.51)	7.90	(0.73)	
WTR3423	5.97	(0.55)	8.47	(0.79)	
WTR3427	6.96	(0.65)	9.63	(0.89)	
WTR3431	8.44	(0.78)	11.36	(1.06)	
WTR3810	1.87	(0.17)	3.80	(0.35)	
WTR3815	3.89	(0.36)	6.12	(0.57)	
WTR3817	4.44	(0.41)	6.75	(0.63)	
WTR38111	5.54	(0.51)	8.02	(0.75)	
WTR3821	6.09	(0.57)	8.65	(0.80)	
WTR3823	6.64	(0.62)	9.29	(0.86)	
WTR3827	7.74	(0.72)	10.55	(0.98)	
WTR3831	9.39	(0.87)	12.46	(1.16)	
WTR31010	1.95	(0.18)	3.94	(0.37)	
WTR31015	4.05	(0.38)	6.35	(0.59)	
WTR31017	4.63	(0.43)	7.00	(0.65)	
WTR310111	5.77	(0.54)	8.32	(0.77)	
WTR31021	6.35	(0.59)	8.97	(0.83)	
WTR31023	6.92	(0.64)	9.63	(0.89)	

Window Number	Ar	ass ea t./(m²)	Overall Window Area Sq. Ft./(m²)		
WTR31027	8.07	(0.75)	10.95	(1.02)	
WTR31031	9.79	(0.91)	12.92	(1.20)	
WTR4210	2.14	(0.20)	4.28	(0.40)	
WTR4215	4.44	(0.41)	6.88	(0.64)	
WTR4217	5.07	(0.47)	7.59	(0.71)	
WTR42111	6.33	(0.59)	9.02	(0.84)	
WTR4221	6.96	(0.65)	9.73	(0.90)	
WTR4223	7.59	(0.71)	10.45	(0.97)	
WTR4227	8.85	(0.82)	11.87	(1.10)	
WTR4231	10.74	(1.00)	14.01	(1.30)	
WTR41010	2.52	(0.23)	4.94	(0.46)	
WTR41015	5.23	(0.49)	7.95	(0.74)	
<b>WTR</b> 41017	5.97	(0.55)	8.78	(0.82)	
WTR410111	7.45	(0.69)	10.43	(0.97)	
WTR41021	8.19	(0.76)	11.25	(1.05)	
WTR41023	8.93	(0.83)	12.07	(1.12)	
WTR41027	10.41	(0.97)	13.72	(1.27)	
WTR41031	12.63	(1.17)	16.19	(1.50)	
WTR5610	2.90	(0.27)	5.61	(0.52)	
WTR5615	6.01	(0.56)	9.03	(0.84)	

Window Number	1A	ass ea t./(m²)	Overall Window Area Sq. Ft./(m²)		
WTR5617	6.87	(0.64)	9.96	(0.93)	
WTR56111	8.57	(0.80)	11.83	(1.10)	
WTR5621	9.42	(0.88)	12.77	(1.19)	
WTR5623	10.27	(0.95)	13.70	(1.27)	
WTR5627	11.98	(1.11)	15.57	(1.45)	
WTR5631	14.53	(1.35)	18.38	(1.71)	
WTR6210	3.28	(0.30)	6.28	(0.58)	
WTR6215	6.80	(0.63)	10.10	(0.94)	
WTR6217	7.76	(0.72)	11.15	(1.04)	
WTR62111	9.69	(0.90)	13.24	(1.23)	
WTR6221	10.65	(0.99)	14.28	(1.33)	
WTR6223	11.61	(1.08)	15.33	(1.42)	
WTR6227	13.54	(1.26)	17.42	(1.62)	
WTR6231	16.43	(1.53)	20.56	(1.91)	

<sup>•</sup> Dimensions in parentheses are in square meters.

<sup>\*&</sup>quot;Minimum Rough Opening" dimensions may need to be increased to allow for use of building wraps, flashing, sill panning, brackets, fasteners or other items. See pages 210-211 for more details.

\*Dimensions in parentheses are in millimeters.





## WOODWRIGHT® DOUBLE-HUNG INSERT WINDOWS

## **FEATURES**

#### FRAME

♠ A Fibrex<sup>®</sup> material exterior protects the frame – beautifully. Best of all, it's low maintenance and never needs painting.\*

For exceptional long-lasting performance, sill members are constructed with a wood core and a Fibrex material exterior.

 Natural wood stops are available in pine, maple, oak and prefinished white. Wood jamb liners add beauty and authenticity to the window interior.

• Multiple weatherstrip systems help provide a barrier against wind, rain and dust. The combination of spring-tension vinyl, rigid vinyl and flexible bulb weatherstrip is efficient and effective.

**(3)** Exterior stop covers are specially designed to allow easy application of high-quality sealant.

3 1/4" (83) "pocket window" jamb depth allows convenient replacement without disturbing interior window trim for most double-hung replacement situations.

• For units with white exterior color, the exterior jamb liner is white. For all other units, the exterior jamb liner is gray.

#### SASH

**6** Balancers in the sash enable contractors to screw through the jamb during installation without interfering with the window's operation.


#### Wood Jamb Liner



① Natural wood sash interior with classic chamfer detailing. Available in pine, maple, oak or prefinished white.

• Low-maintenance sash exterior provides long-lasting\* protection and performance. Sash exteriors on most units include Fibrex material.

Sash joints simulate the look of traditional mortise-and-tenon construction inside and out.

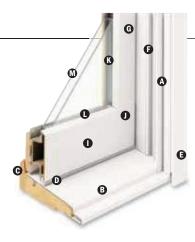

#### **GLASS**

**6** In addition to stainless steel glass spacers, black or white glass spacers are now available to allow the spacer to blend in with the unit color.

• Silicone bed glazing provides superior weathertightness and durability.

M High-Performance options include:

- Low-E4® glass
- Low-E4 HeatLock® glass
- Low-E4 SmartSun™ glass
- Low-E4 SmartSun HeatLock glass
- · Low-E4 Sun glass

Tempered and other glass options are available. Contact your Andersen supplier.

A removable translucent film helps shield the glass from damage during delivery and construction, and simplifies finishing at the job site.

#### Patterned Glass

Patterned glass options are available. See page 12 for more details.

## HARDWARE



Standard lock and keeper design provides an easy tilt-to-clean feature integrated into the lock.

#### SILL ANGLES

Three sill angles are available – 0,° 8° and 14° – to closely match the existing sill in window replacement applications. See page 71 for details.



0° Sill Angle



8° Sill Angle



14° Sill Angle

## Sill Angle Finder App

Our Sill Angle Finder App lets you quickly and easily find the sill angle of existing double-hung windows. Available for free for both iPhone® and Android™ smartphones. Download the app for iPhone from the App Store™ or for Android smartphones from the Google Play Store. The app is only available for smartphones, as tablets and other large devices are too bulky for measuring window sill angles.

#### **INSTALLATION**

#### Exterior Stop Cover



An exterior stop cover provides a clean transition from the new window to the existing window casing.

#### Included Installation Materials



Flat self-hanging shims, backer rod, installation screws and complete instructions are included with each insert window. See the measurement guide and worksheet at andersenwindows.com/measure.

#### SASH OPTIONS"



Cottage Reverse Cottage



## **EXTERIOR & INTERIOR OPTIONS**

#### **EXTERIOR COLORS**



# **INTERIOR OPTIONS** Pine Maple

Oak

White

## **HARDWARE**



Standard Lock & Keeper

Antique Brass | **Black** | Bright Brass Brushed Chrome | Distressed Bronze Distressed Nickel | Gold Dust Oil Rubbed Bronze | Polished Chrome Satin Nickel | Stone | White

## **OPTIONAL HARDWARE** Sold Separately

#### CONTEMPORARY



Available in all hardware finishes. Shown in Distressed Nickel.

## ESTATE™



Antique Brass | Bright Brass Brushed Chrome | Distressed Bronze Distressed Nickel | Oil Rubbed Bronze Polished Chrome | Satin Nickel

## **TRADITIONAL**









Finger Lifts

Antique Brass | Black | Bright Brass | Brushed Chrome Distressed Bronze | Distressed Nickel | Gold Dust | Oil Rubbed Bronze Polished Chrome | Satin Nickel | Stone | White

#### **CLASSIC SERIES™**







Stone | White

Bold name denotes finish shown.

#### HARDWARE FINISHES



## **ACCESSORIES** Sold Separately

#### **FRAME**

## Wood Interior Stop



Optional interior stop with matching chamfer is available.

#### SASH

## Window Opening Control Device



A window opening control device is available, which limits sash travel to less than 4" (102) when the window is first opened. Available factory applied, or as a field-applied kit in stone or white.

#### INSTALLATION

#### Coil Stock



Andersen® aluminum coil stock can be ordered to match any of our 11 trim colors. Made from .018" thick aluminum, Andersen coil stock is available in 24" (610) x 50' (15240) rolls. Color-matched 1 1/4" (32)-long stainless steel trim nails are also available and can be ordered in 1 lb/.454 kg boxes.

#### **INSECT SCREENS**

#### Insect Screen Frames



Choose full insect screen or half insect screen. Half insect screen (shown above) allows ventilation without affecting the view through the upper sash. Frames are available in colors to match product exteriors.

#### TruScene® Insect Screens

Andersen TruScene insect screens let in over 25% more fresh air\* and provide 50% greater clarity than conventional Andersen insect screens, all while keeping out unwanted small insects.

#### Conventional Insect Screens

Conventional insect screens have charcoal powder-coated aluminum screen mesh.

#### **GRILLES**

Grilles are available in a variety of configurations and widths. For doublehung grille patterns, see page 72.

### CAUTION

- Painting and staining may cause damage to rigid vinyl.
- 400 Series windows in Terratone color may be painted any color lighter than Terratone color using quality oil-based or latex paint.
- Do not paint 400 Series windows in white, canvas, Sandtone, dark bronze, forest green or black exterior colors.
- Andersen does not warrant the adhesion or performance of homeowner-applied paint over vinyl or other factory-coated surfaces.
- · For vinyl painting instructions and preparation, contact your Andersen supplier.
- Do not paint weatherstrip.
- Creasate-based stains should not come in contact with Andersen products.
- Abrasive cleaners or solutions containing corrosive solvents should not be used on Andersen products.

\*TruScene insect screens let in over 25% more fresh air than standard Andersen fiberglass

Dimensions in parentheses are in millimeters.

time and use

Printing limitations prevent exact replication of colors and finishes. See your Andersen supplier for actual color and finish samples.


Naturally occurring variations in grain, color and texture of wood make each window one of a kind. All wood interiors are unfinished unless a finish is specified. Distressed bronze and oil rubbed bronze are "living" finishes that will change with




## **Existing Window Measurements**


Required measurements:


- 1. Existing Opening Height
- 2. Existing Sill Angle
- 3. Existing Opening Width

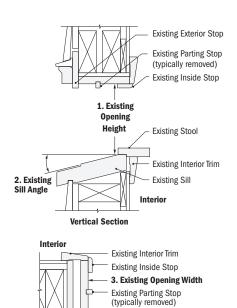


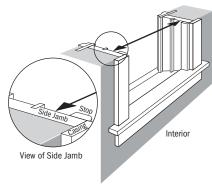

**Existing Double-Hung Window** 

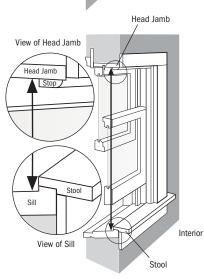

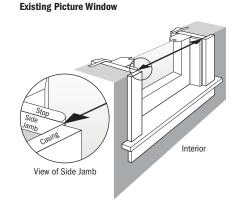

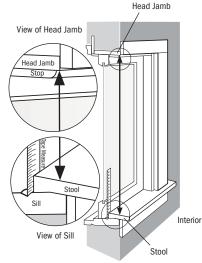

## **Sill Angle Details**

Scale 3''(76) = 1'-0''(305) - 1:4

**Horizontal Section** 


Select a sill angle that most closely matches your existing sill angle.

Existing Exterior Stop

Existing Exterior Trim

Windows with a smaller sill angle will have a larger maximum height.


A "Sill Angle Finder App" is available; see page 68.

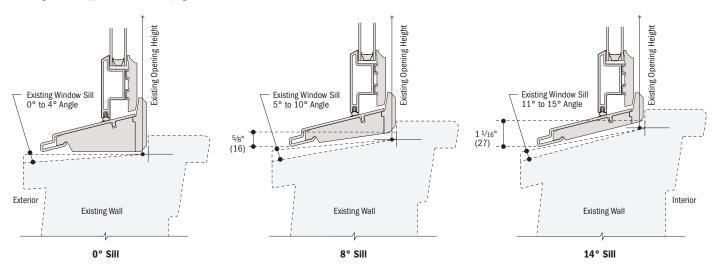

- Details are for illustration only and are not intended to represent product installation methods or materials. Refer to product installation guides at andersenwindows.com.
- · Dimensions in parentheses are in millimeters.
- Refer to andersenwindows.com/measure for detailed instructions on how to properly measure for insert windows.

## **WOODWRIGHT® DOUBLE-HUNG INSERT WINDOWS**


## **Grille Patterns**

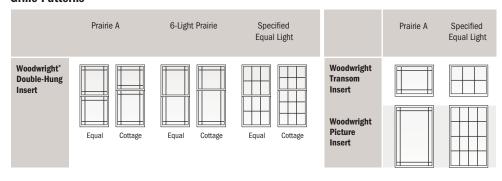


Patterns for double-hung windows are also available in Upper Sash Only (USO) configurations. For picture window patterns that require alignment with double-hung window patterns, identify the sash style (equal, cottage or reverse cottage) when ordering. Number of lights and overall pattern varies with window size. Patterns not available in all configurations. For more grille options, see page 14 or visit andersenwindows.com/grilles.

## Woodwright® Double-Hung Insert Window Details

Scale  $1^{1/2}$ " (38) = 1'-0" (305) - 1:8

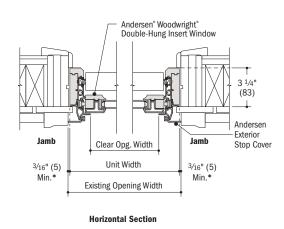

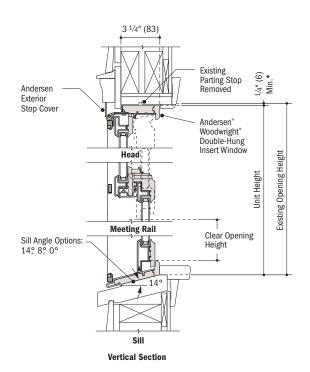

<sup>\*</sup>Light-colored areas are parts included with window. Dark-colored areas are additional Andersen\* parts required to complete window assembly as shown.

Details are for illustration only and are not intended to represent product installation methods or materials. Refer to product installation guides at andersenwindows.com.

<sup>•</sup> Dimensions in parentheses are in millimeters.

<sup>\*</sup>Refer to andersenwindows.com/measure for detailed instructions on how to properly measure for insert windows.




## **Woodwright® Picture Insert Window Details**

Scale  $1^{1/2}$ " (38) = 1'-0" (305) -1:8


#### Andersen® Woodwright® Picture Insert Window 3 1/4" (83)Andersen Exterior Jamb Jamb Clear Opg. Width Stop Cover Unit Width 3/16" (5) 3/16" (5) Min.\* Min.\* Existing Opening Width

#### **Horizontal Section**

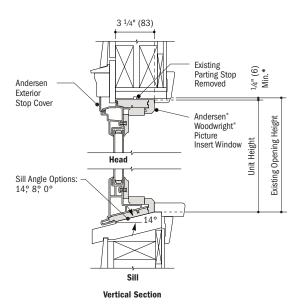


## **Woodwright® Transom Insert Window Details**


Scale  $1^{1}/_{2}$ " (38) = 1'-0" (305) - 1:8

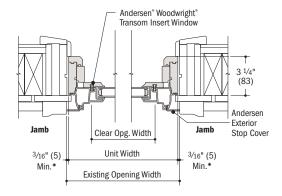

#### **Horizontal Section**

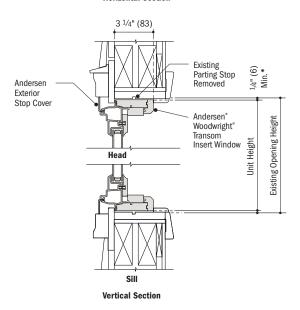


## **Joining Combinations**

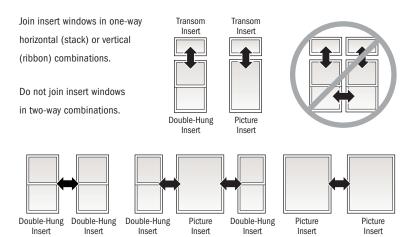

## Vertical (ribbon) Joining Detail

Scale  $1^{1}/2$ " (38) = 1'-0" (305) -1:8

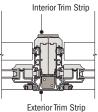

Horizontal Section

Woodwright® Double-Hung Insert to Woodwright Double-Hung Insert

For more joining information, see the combination designs section starting on page 181.

<sup>\*</sup> Light-colored areas are parts included with window. Dark-colored areas are additional Andersen\* parts required to complete window assembly as shown.

Details are for illustration only and are not intended to represent product installation methods or materials. Refer to product installation guides at andersenwindows.com.

<sup>·</sup> Dimensions in parentheses are in millimeters.

<sup>\*</sup>Refer to andersenwindows.com/measure for detailed instructions on how to properly measure for insert windows.