COE RESIDENCE ADDITION

2725 23RD RD N ARLINGTON, VA 22201



MC3 DESIGN 1308 VINCENT PLACE, MCLEAN, VA 22102 INFO@MC3.DESIGN

GC GC ADDRESS GC EMAIL

PROJECT INFORMATION

ZONING DISTRICT: R-6 Z LOT NUMBER: 213 LOT SQUARE FOOTAGE: 0 SF BUILDING SQUARE FOOTAGE: 0 SF

PROJECT SHALL CONFORM TO THE 2018 VIRGINIA UNIFORM STATEWIDE BUILDING CODE AND 2018 VIRGINIA INTERNATIONAL RESIDENTIAL CODE.

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GENERAL

THE BUILDER SHALL VERIFY THAT SITE CONDITIONS ARE CONSISTENT WITH THESE PLANS BEFORE STARTING WORK.

WRITTEN DIMENSIONS AND SPECIFIC NOTES SHALL TAKE PRECEDENCE OVER SCALED DIMENSIONS AND GENERAL NOTES. THE DESIGN-BUILDER SHALL BE CONSULTED FOR CLARIFICATION IF SITE CONDITIONS ARE ENCOUNTERED THAT ARE DIFFERENT THAN SHOWN, IF DISCREPANCIES ARE FOUND IN THE PLANS OR NOTES, OR IF A QUESTION ARISES OVER THE INTENT OF THE PLANS OR NOTES.

CODES AND STANDARDS

THE FOLLOWING CODES AND STANDARDS, INCLUDING ALL SPECIFICATIONS REFERENCED WITHIN SHALL APPLY TO THE DESIGN, CONSTRUCTION, QUALITY CONTROL AND SAFETY OF ALL WORK PERFORMED ON THE PROJECT. USE THE LATEST EDITIONS UNLESS NOTED OTHERWISE.

MINIMUM DESIGN LOADS FOR BUILDINGS AND OTHER STRUCTURES (ANSI/ASCE 7), AMERICAN SOCIETY OF CIVIL ENGINEERS.

BUILDING CODE REQUIREMENTS FOR REINFORCED CONCRETE (ACI 318), AMERICAN CONCRETE INSTITUTE.

CODE REQUIREMENTS FOR RESIDENTIAL CONRETE (ACI 332), AMERICAN CONCRETE

ACI MANUAL OF CONCRETE PRACTICE - PARTS 1 THROUGH 5.

MANUAL OF STANDARD PRACTICE, CONCRETE REINFORCING STEEL INSTITUTE.

MANUAL OF STEEL CONSTRUCTION - ALLOWABLE STRESS DESIGN - AMERICAN INSTITUTE OF STEEL CONSTRUCTION (INCLUDING SPECIFICATION S FOR STRUCTURAL JOISTS USING ATSM A325 OR A490 BOLTS AND AISC CODE OF STANDARD PRACTICE WITH EXCEPTION, IF ANY, AS INDICATED IN THE SPECIFICATIONS).

MANUAL OF STEEL CONSTRUCTION. VOLUME II - CONNECTIONS - AMERICAN INSTITUTE OF STEEL CONSTRUCTION.

DETAILING FOR STEEL CONSTRUCTION, AMERICAN INSTITUTE OF STEEL CONSTRUCTION.

STRUCTURAL WELDING CODE (ANSI/AWS1.1-92), AMERICAN WELDING SOCIETY.

DESIGN MANUAL FOR FLOOR DECKS AND ROOF DECKS, STEEL DECK INSTITUTE.

SPECIFICATION FOR THE DESIGN OF COLD-FORMED STEEL STRUCTURAL MEMBERS, AMERICAN IRON AND STEEL INSTITUTE.

BUILDING CODE REQUIREMENTS FOR MASONRY STRUCTURES (ACI 530/TMS 402) AND SPECIFICATIONS FOR MASONRY STRUCTURES (ACI 530/ ASCE 7/TMS 602).

NATIONAL DESIGN SPECIFICATION FOR WOOD CONSTRUCTION (NDS)

MISCELLANEOUS NOTES

EACH BEDROOM TO HAVE A MINIMUM WINDOW OPENING OF 5.7 SQ. FT. WITH A MINIMUM WIDTH OF 20 IN. AND A SILL LESS THAN 44" ABOVE FIN. FLR.

ALL GLAZING WITHIN 18 IN. OF THE FLOOR AND/OR WITHIN 24 IN. OF ANY DOOR (REGARDLESS OF WALL PLANE) ARE TO HAVE SAFETY GLAZING. ALL GLAZING WITHIN 60 IN. OF TUB OR SHOWER FLOOR, 60 IN. OF A STAIR LANDING OR GREATER THAN 9 SQUARE

SKYLIGHTS ARE TO BE GLAZED WITH TEMPERED GLASS ON OUTSIDE AND LAMINATED GLASS ON THE INSIDE (UNLESS PLEXIGLASS). GLASS TO HAVE MAXIMUM CLEAR SPAN OF 25 IN. AND FRAME IS TO BE ATTACHED TO A 2x CURB WITH A MINIMUM OF 4 IN. ABOVE ROOF PLANE.

ALL TUB AND SHOWER ENCLOSURES ARE TO BE GLAZED WITH SAFETY GLASS.

ALL EXTERIOR WINDOWS ARE TO BE DOUBLE GLAZED AND ALL EXTERIOR DOORS ARE TO BE SOLID CORE WITH WEATHERSTRIPPING. PROVIDE 1/2 IN. DEADBOLT LOCKS ON ALL EXTERIOR DOORS, AND LOCKING DEVICES ON ALL DOORS AND WINDOWS WITHIN 10 FT. (VERTICAL) OF GRADE. PROVIDE PEEPHOLE 54-66 IN. ABOVE FIN. FLOOR ON EXTERIOR ENTRY DOORS.

PROVIDE ONE SMOKE DETECTOR IN EACH ROOM AND ONE IN EACH CORRIDOR ACCESSING BEDROOMS. CONNECT SMOKE DETECTORS TO HOUSE POWER AND INTER-CONNECT SMOKE DETECTORS TO HOUSE POWER AND INTERCONNECT SO THAT, WHEN ANY ONE IS TRIPPED, THEY ALL WILL SOUND. PROVIDE BATTERY BACKUP FOR ALL UNITS.

PROVIDE COMBUSTION AIR VENTS (W/SCREEN AND BACK DAMPER) FOR GAS FIRE-PLACE AND ANY OTHER APPLIANCES WITH AN OPEN FLAME.

BATHROOMS AND UTILITY ROOMS ARE TO BE VENTED TO THE OUTSIDE WITH A FAN CAPABLE OF PRODUCING A MINIMUM OF 5 AIR EXCHANGES PER HOUR.

RANGE HOODS ARE ALSO TO BE VENTED TO THE OUTSIDE.

ELECTRICAL RECEPTACLES IN BATHROOMS, KITCHENS AND GARAGES SHALL BE G.F.I. OR G.F.I.C. PER NATIONAL ELECTRICAL CODE REQUIREMENTS.

PROVIDE CRAWLSPACE VENTING TO MEET THE REQUIREMENTS OF THE 2006 EDITION OF THE I.R.C.

DRAWING SCHEDULE						
NUMBER	SHEET NAME					
A 001	COVER PAGE					
1 002	GENERAL NOTES					
4003	AREA PLANS					
4004	SURVEY PLAT					
1 101	DEMOLITION PLAN GARAGE BASEMENT LEVEL					
1 102	DEMOLITION PLAN BASEMENT LEVEL					
A103	DEMOLITION PLAN FIRST LEVEL					
4104	DEMOLITION PLAN SECOND LEVEL					
A 105	DEMOLITION ROOF PLAN					
A 111	PROPOSED GARAGE BASEMENT PLAN					
A112	PROPOSED BASEMENT PLAN					
A113	PROPOSED FIRST LEVEL PLAN					
A 114	PROPOSED SECOND LEVEL PLAN					
A 115	PROPOSED ROOF PLAN					
A201	DEMOLITION FRONT AND RIGHT ELEVATIONS					
A 202	DEMOLITION BACK AND LEFT ELEVATIONS					
A 211	FRONT AND RIGHT ELEVATIONS					
1 212	BACK AND LEFT ELEVATIONS					
4 301	SECTION 01					
4401	WINDOW DOOR SCHEDULES					
4402	MATERIAL TAKEOFFS					
4 501	TYPICAL DETAILS					
4 502	FOUNDATION DETAILS					
4 503	FLOOR DETAILS					
4 504	ROOF DETAILS					
4 505	STAIR DETAILS					
4506	TYPICAL WALL DETAILS					
4 901	PROPOSED PERSPECTIVES					
4902	PROPOSED INTERIOR PERSPECTIVES					



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SEAL

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REVISIONS NO. DESCRIPTION

SHEET TITLE

COVER **PAGE**

SCALE 12" = 1'-0" DATE 02.16.2024

SHEET NO.

BUILDER TO LOCATE ALL SURFACE AND SUBSURFACE UTILITIES IN THE AREA OF THE CONSTRUCTION PRIOR TO COMMENCING WORK. CALL MISS UTILITY PRIOR TO BEGINNING WORK.

THE BUILDER SHALL STORE MATERIALS IN A SAFE AREA ON SITE WITH PROTECTION FROM WEATHER. DO NOT STACK BUILDING MATERIALS IN A MANNER THAT COULD CREATE CONCENTRATED LOADS ON NEW OR EXISTING WORK.

BUILDER SHALL RETAIN A GEOTECHNICAL ENGINEER TO TEST SOIL BEARING CAPACITY IF FIELD INSPECTION INDICATES A NEED.

PROVIDE POSITIVE DRAINAGE AWAY FROM BUILDING

MATERIAL

W AND WT SHAPES: ASTM A 992; FT = 50 KSI M, MT, S, ST, HP, C, MC AND L SHAPES: ASTM A 36; FT = 36 KSI STEEL PIPE: ASTM A 53, GRADE B; FT = 35 KSI STEEL HSS SECTIONS (ROUND, SQUARE, RECTANGULAR): COLD ROLLED: ASTM A 500, GRADE B; FT = 46 KSI HOT ROLLED; ASTM A-501 STEEL PLATES: ASTM A 36: FT = 36 KSI HEADED STUDS; ASTM A 108, GRADES 1010 THROUGH 1016 INCLUSIVE. CONNECT ALL MEMBERS WITH HIGH-STRENGTH BOLTS. BEARING TYPE CONNECTIONS, TYPE N: PROVIDE ASTM A 325, TYPE N BOLTS AT ALL LOCATIONS NOT NOTED ON DRAWINGS AS TYPE SC. PROVIDE HARDENED WASHERS CONFORMING TO ASTM F 436 UNDER ELEMENTS TO BE TIGHTENED. PROVIDE NUTS CONFORMING TO ASTM A 563. TIGHTEN TYPE N BEARING BOLTS TO A SNUG TIGHT CONDITION. INSTALL HIGH-STRENGTH BOLTS ACCORDING TO ASTM STANDARDS. DO NOT WELD TO HIGH-STRENGTH BOLTS.

GALVANIZED BOLTS (WHERE SHOWN ON DRAWINGS): HOT-DIPPED GALVANIZED ACCORDING TO ASTM A 153, CLASS C. **ANCHOR BOLTS:** ASTM A 307. GRADE A PROVIDE WITH STANDARD WASHERS AND NUTS. OVER-TAP NUTS TO CLASS 2A FIT BEFORE GALVANIZING, ACCORDING TO ASTM A 563. PROVIDE BEVELED WASHERS AT BOLT HEADS OR NUTS BEARING ON SLOPING **SURFACES** WELDING: CONFORM WITH AWS WABO SPECIFICATIONS.

WELDERS TO BE QUALIFIED UNDER AWS WABO SPECIFICATIONS.

WELDS MATERIAL: 70 KSI FILLER METAL, UNLESS NOTED OTHERWISE.

PROVIDE LOW-HYDROGEN FILLER METALS AT MOMENT FRAME WELDS

WELDS TO METAL DECK, METAL STUDS OR OTHER COLD-FORMED METALS:

= 25 psf

= B

= 115 MPH

DESIGN LOADS

CONFORM TO AWS D1.3.

GROUND SNOW LOAD WIND SPEED SEISMIC DESIGN CATEGORY **FROST LINE** FLOOR HAZARDS LIVING AREAS SLEEPING AREAS

WEATHERING PROBABILITY OF CONCRETE = SEVERE = 24" = MODERATE TO HEAVY TERMITE INFESTATION PROBABILITY DECAY PROBABILITY = SLIGHT TO MODERATE WINTER DESIGN TEMPERATURE = 17° F = YES ICE SHIELD UNDERLAYMENT REQUIRED = FIRM-2013 AIR FREEZING INDEX = 250 MEAN ANNUAL TEMPERATURE = 55° F FLOOR LIVE LOADS (PER VRC2015 - TABLE R301.5) = 40 psf= 30 psfEXTERIOR BALCONIES & DECKS = 40 psfHABITABLE ATTICS & ATTICS SERVED W/ FIXED STAIRS = 30 psfUNCHARITABLE ATTICS W/ STORAGE = 10 psfFLOOR DEAD LOAD = 10 psf U.N.O. ROOF LIVE LOAD = 30 psfROOF DEAD LOAD = 20 psfSOIL BEARING CAPACITY = 1,500 psf V.I.F.= 2'-0" MIN. BELOW WATER TABLE **BOTTOM OF ALL** CONCRETE FOOTINGS & SLABS **BACKFILL** = 30 psf U.N.O.

JOIST TO SILL OR GIRDER BRIDGING TO JOIST SOLE PLATE TO JOIST OR BLK'G

STUD TO SOLE PLATE TOP PLATE TO STUD DOUBLE STUDS DOUBLE TOP PLATES CONTINUOUS HEADER, TWO PIECES BUILT-UP HEADER, TWO PIECES W/ 1/2" SPACER

NAILING NOTES PER IRC TABLE R602.3

TOP PLATES, LAPS AND INTERSECTIONS **CEILING JOISTS TO PLATE** CONTINUOUS HEADER TO STUD CEILING JOISTS, LAPS OVER PARTITIONS **CEILING JOISTS TO PARALLEL RAFTERS** RAFTER TO PLATE 1" BRACE TO EACH STUD AND PLATE **BUILT-UP CORNER STUDS**

2" PLANKS 1/2" PLYWOOD ROOF AND WALL SHEATHING 3/4" PLYWOOD SUBFLOOR

(4) OR MORE

2x MULTIPLE JOISTS - STAGGER @ 15" OC W/(2) @ EA. END OR SPLICE (3) OR FEWER

16d NAILS 1/2" DIA M.B. W/ STANDARD NUT AND **WASHERS**

INTERMEDIATE 8d @ 12" OC

INTERMEDIATE 8d @ 12" OC

TOE NAIL (3)-8d

END NAIL (2)-16d

FACE NAIL (2)-16d

TOE NAIL (3)-8d

TOE NAIL (4)-8d

FACE NAIL (3)-10d

FACE NAIL (3)-10d

TOE NAIL (2)-16d

FACE NAIL (2)-80

10d @ 24" OC

(2)-16d @ EA.BRG

EDGES 8d @ 6" OC

EDGES 8d @ 6" OC

TOE NAIL EA. END (2)-8d

FACE NAIL 16d @ 16"OC

FACE NAIL 16d @ 24" OC

FACE NAIL 16d @ 16" OC

TOE NAIL (4)-8d, END NAIL (2) 16d

16d @ 16" OC ALONG EA. EDGE

16d @ 16" OC ALONG EA. EDGE

A. ALL NAILS ARE SMOOTH-COMMON, BOX OR DEFORMED SHANKS EXCEPT WHERE OTHERWISE STATED. NAILS USED FOR FRAMING AND SHEATHING CONNECTIONS SHALL HAVE MINIMUM AVERAGE BENDING YIELD STRENGTHS AS SHOWN: 80 KSI FOR SHANK DIAMETER OF 0.192 INCH (20D COMMON NAIL), 90 KSI FOR SHANK DIAMETERS LARGER THAN 0.142 INCH BUT NOT LARGER THAN 0.177 INCH. AND 100 KSI FOR SHANK DIAMETERS OF 0.142 INCH OR LESS

B. STAPLES ARE 16 GAGE WIRE AND HAVE A MINIMUM 7/16-INCH ON DIAMETER CROWN WIDTH.

C. NAILS SHALL BE SPACED AT NOT MORE THAN 6 INCHES ON CENTER AT ALL SUPPORTS

WHERE SPANS ARE 48 INCHES OR GREATER. D. FOUR-FOOT BY 8-FOOT OR 4-FOOT BY 9-FOOT PANELS SHALL BE APPLIED VERTICALLY. E. SPACING OF FASTENERS NOT INCLUDED IN THIS TABLE SHALL BE BASED ON TABLE

F. FOR REGIONS HAVING BASIC WIND SPEED OF 110 MPH OR GREATER, 8D DEFORMED (21/2" × 0.120) NAILS SHALL BE USED FOR ATTACHING PLYWOOD AND WOOD STRUCTURAL PANEL ROOF SHEATHING TO FRAMING WITHIN MINIMUM 48-INCH DISTANCE FROM GABLE END WALLS, IF MEAN ROOF HEIGHT IS MORE THAN 25 FEET, UP TO 35 FEET MAXIMUM. G. FOR REGIONS HAVING BASIC WIND SPEED OF 100 MPH OR LESS, NAILS FOR ATTACHING WOOD STRUCTURAL PANEL ROOF SHEATHING TO GABLE END WALL FRAMING SHALL BE SPACED 6 INCHES ON CENTER. WHEN BASIC WIND SPEED IS GREATER THAN 100 MPH, NAILS FOR ATTACHING PANEL ROOF SHEATHING TO INTERMEDIATE SUPPORTS SHALL BE SPACED 6 INCHES ON CENTER FOR MINIMUM 48-INCH DISTANCE FROM RIDGES. EAVES AND GABLE END WALLS; AND 4 INCHES ON CENTER TO GABLE END WALL FRAMING.

H. GYPSUM SHEATHING SHALL CONFORM TO ASTM C 1396 AND SHALL BE INSTALLED IN ACCORDANCE WITH GA 253. FIBERBOARD SHEATHING SHALL CONFORM TO ASTM C 208. I. SPACING OF FASTENERS ON FLOOR SHEATHING PANEL EDGES APPLIES TO PANEL EDGES SUPPORTED BY FRAMING MEMBERS AND REQUIRED BLOCKING AND AT ALL FLOOR PERIMETERS ONLY. SPACING OF FASTENERS ON ROOF SHEATHING PANEL EDGES APPLIES TO PANEL EDGES SUPPORTED BY FRAMING MEMBERS AND REQUIRED BLOCKING. BLOCKING OF ROOF OR FLOOR SHEATHING PANEL EDGES PERPENDICULAR TO THE FRAMING MEMBERS NEED NOT BE PROVIDED EXCEPT AS REQUIRED BY OTHER PROVISIONS OF THIS CODE. FLOOR PERIMETER SHALL BE SUPPORTED BY FRAMING MEMBERS OR SOLID BLOCKING.

J. WHERE A RAFTER IS FASTENED TO AN ADJACENT PARALLEL CEILING JOIST IN ACCORDANCE WITH THIS SCHEDULE, PROVIDE TWO TOE NAILS ON ONE SIDE OF THE RAFTER AND TOE NAILS FROM THE CEILING JOIST TO TOP PLATE IN ACCORDANCE WITH THIS SCHEDULE. THE TOE NAIL ON THE OPPOSITE SIDE OF THE RAFTER SHALL NOT BE REQUIRED

STAIRWAY AND RAILING

STAIRWAY SHALL NOT BE LESS THAN 36" IN WIDTH. STAIRWAY RISER SHALL NOT BE GREATER THAN 8 1/4". STAIRWAY TREAD DEPTH SHALL NOT BE LESS THAN 9". THE LENGTH OF RUN AND HEIGHT OF RISER SHALL NOT VARY MORE THAN 3/8" IN THE ENTIRE RUN OF STAIR. OPEN RISER PERMITTED IF OPENING IS LESS THAN 4". MINIMUM 3/4" NOSING POST/ BALUSTERS OPENING NOT GREATER THAN 4".

STAIRWAY HEADROOM HEIGHT SHALL NOT BE LESS THAN 6'-8". STAIRWAY HANDRAIL HEIGHT SHALL NOT BE LESS THAN 34" AND NO MORE THAN 38". ENCLOSED USABLE SPACE UNDER INTERIOR STAIRS SHALL BE PROTECTED ON THE ENCLOSED FACE WITH 5/8" TYPE "X" GYPSUM WALL BOARD STAIRWAYS SHALL HAVE AT LEAST ONE HANDRAIL LOCATED 34" TO 38" ABOVE THE NOSING OF TREADS AND LANDINGS. THE HAND GRIP PORTION OF HANDRAILS SHALL NOT BE LESS THAN 1-1/2" OR GREATER THAN 2" IN CROSS-SECTIONAL DIMENSION.

HANDRAILS SHALL BE CONTINUOUS THE FULL LENGTH OF THE STAIRS. THE ENDS OF

HANDRAILS SHALL RETURN TO WALL OR TERMINATE INTO A NEWEL POST OR SAFETY STAIRWAYS HAVING LESS THAN 2 RISERS DO NOT REQUIRE A HAND RAIL. 34" MIN. HEIGHT GUARDRAILS SHALL BE PROVIDED FOR AT PORCHES, DECKS, BALCONIES, 15) STAIRWAYS AND LANDINGS WHERE THE ADJACENT SURFACE IS

GREATER THAN 24" BELOW. RAILING AND GUARDRAIL BALUSTER SPACING SHALL BE NO GREATER THAN 4". THE TRIANGULAR OPENINGS FORMED BY THE RISER, TREAD, AND BOTTOM OF GUARDRAIL SHALL NOT ALLOW A 6" DIAMETER SPHERE TO PASS THROUGH. EXTERIOR SPIRAL STAIRS TO BE FABRICATED AND INSTALLED PER THE MFG. INSTRUCTIONS.

ELECTRICAL

ELECTRICAL, DATA, & AUDIO NOTES: HOME OWNER SHALL DO A WALK-THRU WITH RELEVANT INSTALLERS TO VERIFY THE EXACT LOCATION FOR OUTLETS, LIGHTS, SWITCHES, CABLE, DATA, PHONE, AUDIO, ETC.

ELECTRICAL RECEPTACLES IN BATHROOMS, KITCHENS AND GARAGES SHALL BE G.F.I. ORG.F.I.C. PER NATIONAL ELECTRICAL CODE REQUIREMENTS PROVIDE ONE SMOKE DETECTOR IN EACH ROOM AND ONE IN EACH CORRIDOR ACCESSING BEDROOMS. CONNECT SMOKE DETECTORS TO HOUSE POWER AND INTER-CONNECT SMOKE DETECTORS SO THAT, WHEN ANY ONE IS TRIPPED, THEY ALL WILL SOUND. PROVIDE BATTERY BACKUP FOR ALL UNITS.

CIRCUITS SHALL BE VERIFIED WITH HOME OWNER PRIOR TO WIRE INSTALLATION. FINAL SWITCHES FOR TIMERS AND DIMMERS SHALL BE VERIFIED WITH HOME OWNER. FIXTURES TO BE SELECTED BY HOME OWNER

LOCATE SPEAKERS AND AUDIO CONTROLS AS INDICATED IN THE PLAN; RUN CIRCUIT OF SPEAKER WIRING TO AUDIO HOME PANEL SPECIFIED BY FLOOR; AUDIO SPEAKERS TO BE APPROVED BY HOME OWNER

LOCATE JACKS AS INDICATED IN THE PLAN; INSTALL DATA / CABLE PANEL SIMILAR TO "ON Q". SYSTEM TO BE APPROVED BY HOME OWNER DATA / CABLE:

LOCATE SECURITY PANELS AS INDICATED IN THE PLAN; SYSTEM TO BE APPROVED BY HOME OWNER.

PLUMBING

HVAC SHALL HAVE THREE ZONES, ONE FOR EACH FLOOR THE FURNACE AND WATER HEATER ON FLOOR 3 SHALL SERVE FLOOR 3 THE FURNACE AND WATER HEATER ON FLOOR 1 SHALL SERVE FLOORS 1 & 2. METALLIC GAS PIPE, WATER PIPE, AND FOUNDATION REINFORCING BARS SHALL BE BONDED TO THE ELECTRICAL SERVICE GROUND DRYER, WATER HEATER, KITCHEN AND BATHROOM VENTING SHALL EXHAUST TO THE OUTSIDE OF THE BUILDING AND BE EQUIPPED WITH A BACK DRAFT DAMPER. ALL GAS LINES SHALL BE SIZED FOR APPLIANCE LOAD. "BLACK" PIPE SHALL BE USED

INSIDE THE BUILDING, "GREEN" PIPE WHERE UNDERGROUND OR EXPOSED TO WEATHER. ALL JOINTS SHALL BE TAPED WHERE BURIED OR EXPOSED TO WEATHER. TUBS/SHOWERS SHALL BE PROVIDED WITH INDIVIDUAL CONTROL VALVES OF THE PRESSURE BALANCE OR THE THERMOSTATIC MIXING TYPE. THE WATER TEMPERATURE SHALL BE AT A MAXIMUM OF 120*F.

WATER SOFTENER UNIT SHALL CONDITION WATER BEFORE ENTERING THE WATER HEATERS AND THE COLD WATER SOURCE

EACH HOSE BIBB SHALL BE EQUIPPED WITH A BACK FLOW PREVENTION DEVICE. HEAT DUCTING SHALL BE SECURED, SEALED AND INSULATED AS APPROPRIATE INSTALL WATERPROOF GYPSUM BOARD AT ALL WATER SPLASH AREAS TO MINIMUM 70" ABOVE SHOWER DRAINS.

INSULATE WASTE LINES FOR SOUND CONTROL

INSTALL CENTRAL VACUUM SYSTEM & PIPING; CONFIRM BRAND WITH HOMEOWNER.

VENTILATION

ALL COMBUSTION APPLIANCES WILL BE VENTED DIRECTLY TO THE EXTERIOR. FURNACE FIREBOX AND TANKLESS WATER HEATER SHALL HAVE OUTSIDE COMBUSTION AIR SUPPLY PURSUANT TO REGIONAL AND LOCAL CODES.

ATTIC SHALL HAVE VENTILATION EQUAL TO 1 SQ. FOOT PER 150 SQ. FEET OF ATTIC SPACE. VENTILATION SHALL BE PROTECTED FROM SNOW AND RAIN AND SHALL BE COVERED WITH GALVANIZED WIRE SCREEN. OPENINGS SHALL BE LOCATED TO PROVIDE CROSS VENTILATION.

EXHAUST ALL VENTS AND FANS DIRECTLY TO OUTSIDE VIA METAL DUCTS, PROVIDE 90 CFM (MIN) FANS TO PROVIDE 5 AIR CHANGES PER HOUR IN BATHS CONTAINING TUB AND OR SHOWER AND IN LAUNDRY ROOMS.

GARAGES SHALL BE VENTED WITH 60 SQUARE INCHES LOCATED 6" ABOVE THE FLOOR SURFACE.

UNDER FLOOR SPACES SHALL HAVE VENTILATION EQUAL TO ONE SQ. FOOT PER 150 SQ. FEET OF FLOOR SPACE. VENTS SHALL BE CAST INTO THE CONCRETE STEM WALLS AND COVERED WITH GALVANIZED WIRE SCREEN. VENTS SHALL BE LOCATED TO PROVIDE CROSS VENTILATION.


INSULATION REQUIREMENTS

REFER TO TABLE N1102.1.2 (R402.1.2)

CLIMATE ZONE: 4. FENESTRATION U-FACTOR: 0.32. SKYLIGHT U-FACTOR: 0.55. GLAZED FENESTRATION SHGC: 0.40 CEILING R-VALUE: 49. WOOD FRAME WALL R-VALUE: 15. MASS WALL R-VALUE: 8 (CONTINUOUS) / 13 (CAVITY). FLOOR R-VALUE: 19. BASEMENT WALL R-VALUE: 10 (CONTINUOUS) / 13 (CAVITY). UNHEATED SLAB R-VALUE AND DEPTH: 10 / 2'. HEATED SLAB R-VALUE: R-5. CRAWL SPACE WALL R-VALUE: 10 (CONTINUOUS) / 13 (CAVITY).

MECHANICAL REQUIREMENTS

WHOLE HOUSE MECHANICAL VENTILATION SYSTEM SHALL BE DESIGNED IN ACCORDANCE WITH IRC SECTION M1507.3.

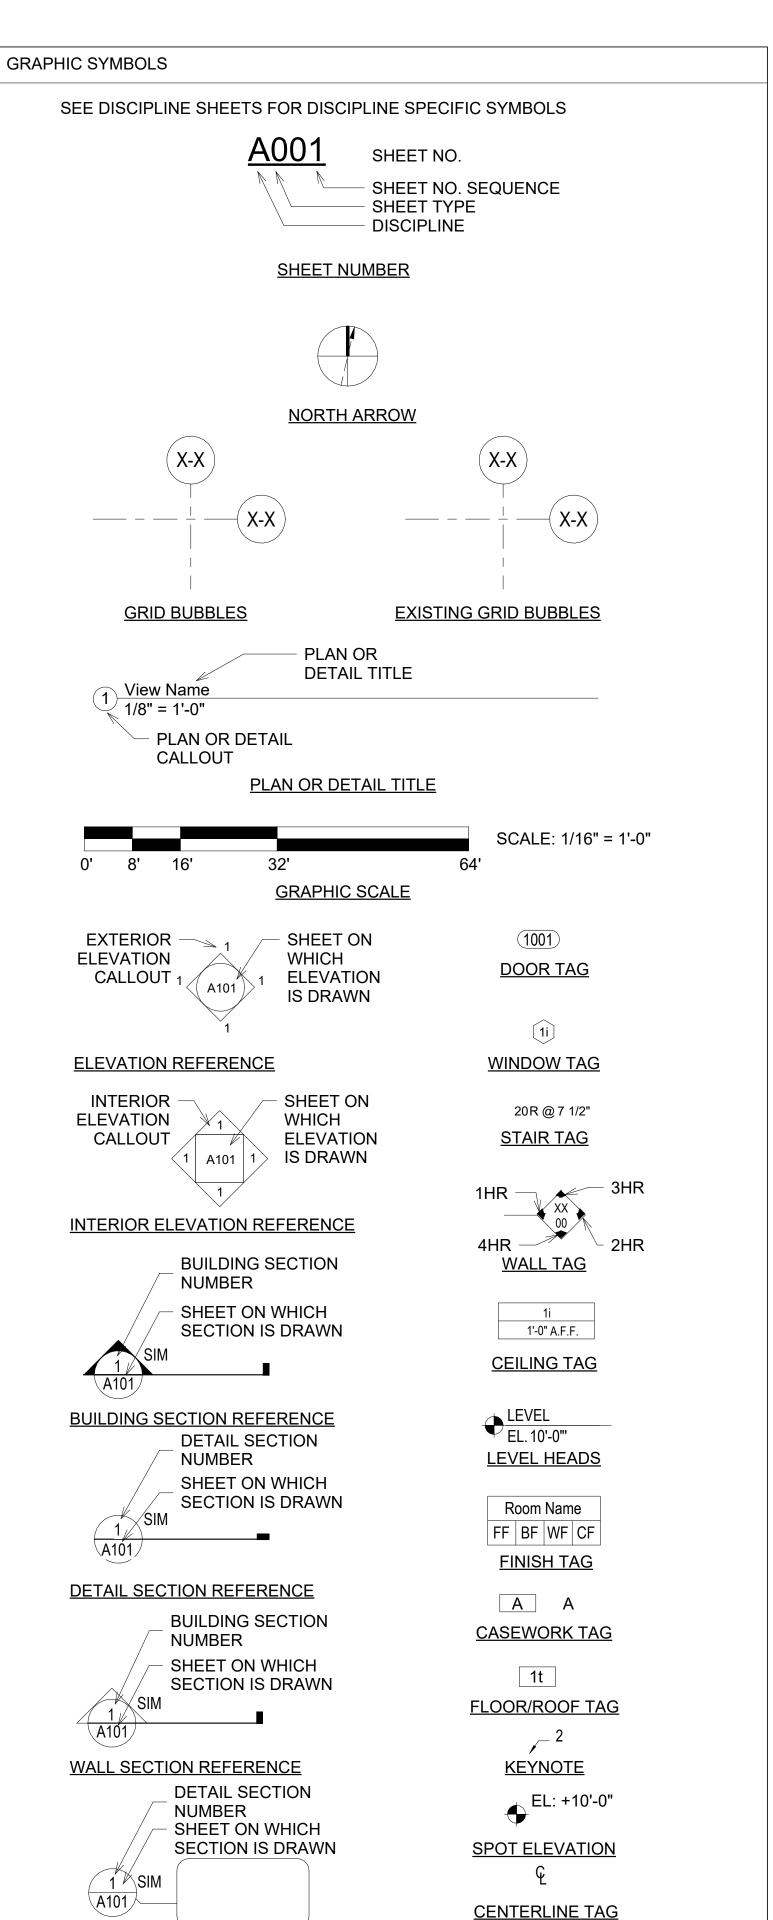

DETAIL CALLOUT REFERENCE

FLOW ARROW REFERENCE

REVISION CALLOUT AND CLOUD

MATCHLINE SEE: 1 / A101

MATCHLINE REFERENCE

ALIGN SYMBOI

30

APARTMENT NUMBERS





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1308 VINCENT PLACE

MCLEAN, VA 22101

202.599.7779 JMCKENNA@MC3.DESIGN

DRAWN BY:

JOHN MCKENNA, AIA, NCARB ARCHITECT

1308 VINCENT PLACE MCLEAN, VA 22101 **SEAL**


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2725 23RD RD N ARLINGTON, VA 22201

REVISIONS



SHEET TITLE

GENERAL NOTES

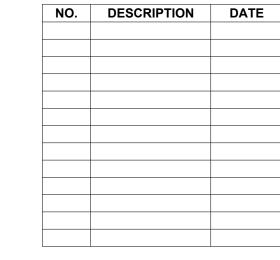SCALE As indicated DATE 02.16.2024

SHEET NO.



NAME	AREA	LEVEL
EXISTING BASEMENT	1053 SF	BASEMENT LEVEL
EXISTING GARAGE BASEMENT	291 SF	BASEMENT LEVEL
EXISTING GARAGE	291 SF	FIRST LEVEL
EXISTING FIRST LEVEL	1093 SF	FIRST LEVEL
EXISTING HARDSCAPE	886 SF	FIRST LEVEL
EXISTING FRONT PORCH	217 SF	FIRST LEVEL
EXISTING SECOND LEVEL	1067 SF	SECOND LEVEL
ΓΟΤΑL	4898 SF	
DEMOL	ITION AREA	
NAME	AREA	LEVEL
HARDSCAPE DEMO	408 SF	BASEMENT LEVEL
BASEMENT DEMO	76 SF	BASEMENT LEVEL
FIRST LEVEL DEMO	335 SF	FIRST LEVEL
GARAGE ROOF DEMO	291 SF	FIRST LEVEL
FIRST LEVEL DEMO	2 SF	FIRST LEVEL
SECOND LEVEL DEMO	725 SF	SECOND LEVEL
ROOF DEMO	563 SF	NEW ROOF RIDGE
ГОТАL	2398 SF	•
NEW B	UILD AREA	
TITLE	AREA	LEVEL
NEW BASEMENT AREA	472 SF	BASEMENT LEVEL
NEW FIRST LEVEL AREA	711 SF	FIRST LEVEL
NEW SECOND LEVEL AREA	948 SF	SECOND LEVEL
NEW ROOF	1354 SF	NEW ROOF RIDGE
ΓΟΤΑL	3485 SF	
PROPOSE	D AREA PLA	N
NAME	AREA	LEVEL
PROPOSED BASEMENT LEVEL	1740 SF	BASEMENT LEVEL
PROPOSED FIRST LEVEL	1784 SF	FIRST LEVEL
PROPOSED DECK	402 SF	FIRST LEVEL
PROPOSED DECK	38 SF	FIRST LEVEL
PROPOSED HARDSCAPE	291 SF	FIRST LEVEL
PROPOSED HARDSCAPE	179 SF	BASEMENT LEVEL
PROPOSED SECOND LEVEL	1756 SF	SECOND LEVEL
DRIVEWAY	844 SF	FIRST LEVEL
ΓΟΤΑL	7033 SF	-
LO	T AREA	
NAME		AREA
_OT AREA	28651 SF	

MC3 DESI



MC3 DESIGN
1308 VINCENT PLACE

MCLEAN, VA 22101 202.599.7779

JMCKENNA@MC3.DESIGN

DRAWN BY:

JOHN MCKENNA, AIA, NCARB ARCHITECT

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ARLINGTON, VA 22201

2725 23RD RD N

REVISIONS

NO.	DESCRIPTION	DATE

SHEET TITLE


AREA PLANS

SCALE	As indicated
DATE	02.16.2024

SHEET NO.

4003

1 EXISTING CONDITION PLAT 1" = 30'-0"

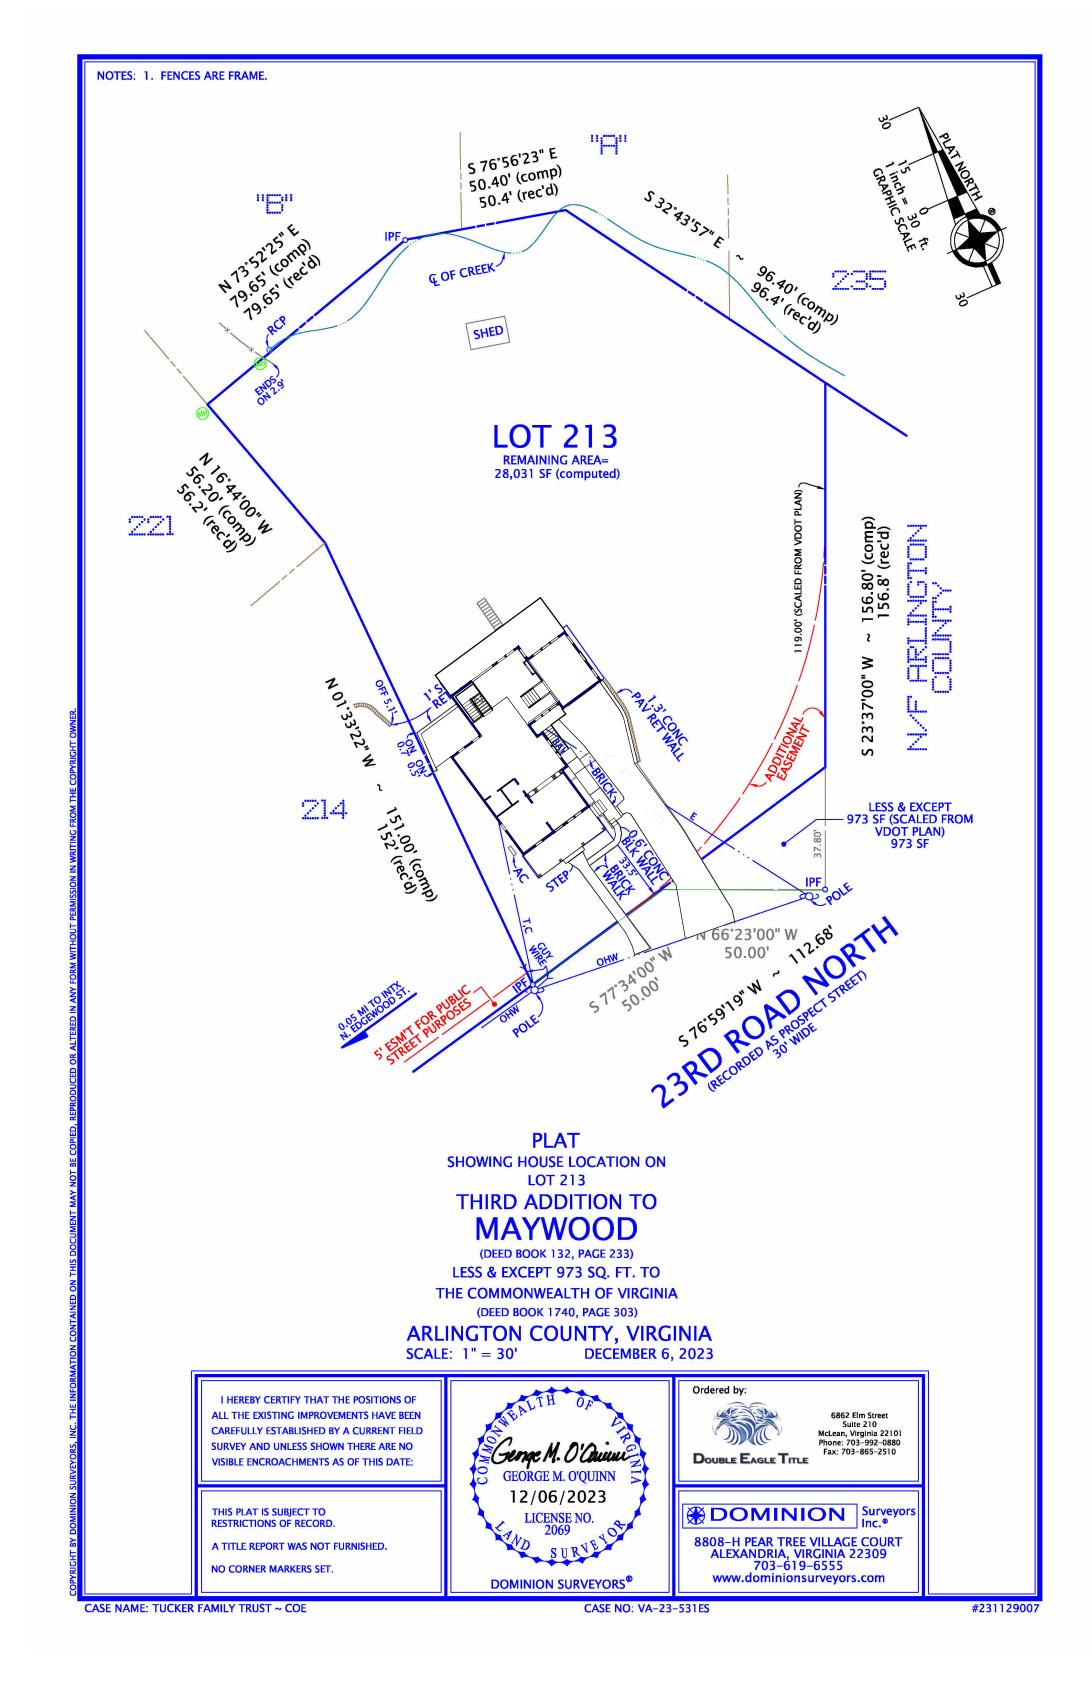

2 PROPOSED PLAT 1" = 30'-0" MC3 DESIG



1308 VINCENT PLACE MCLEAN, VA 22101

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REVISIONS

NO. DESCRIPTION DATE


SHEET TITLE

SURVEY PLAT

SCALE 1" = 30'-0"

DATE 02.16.2024

SHEET NO.

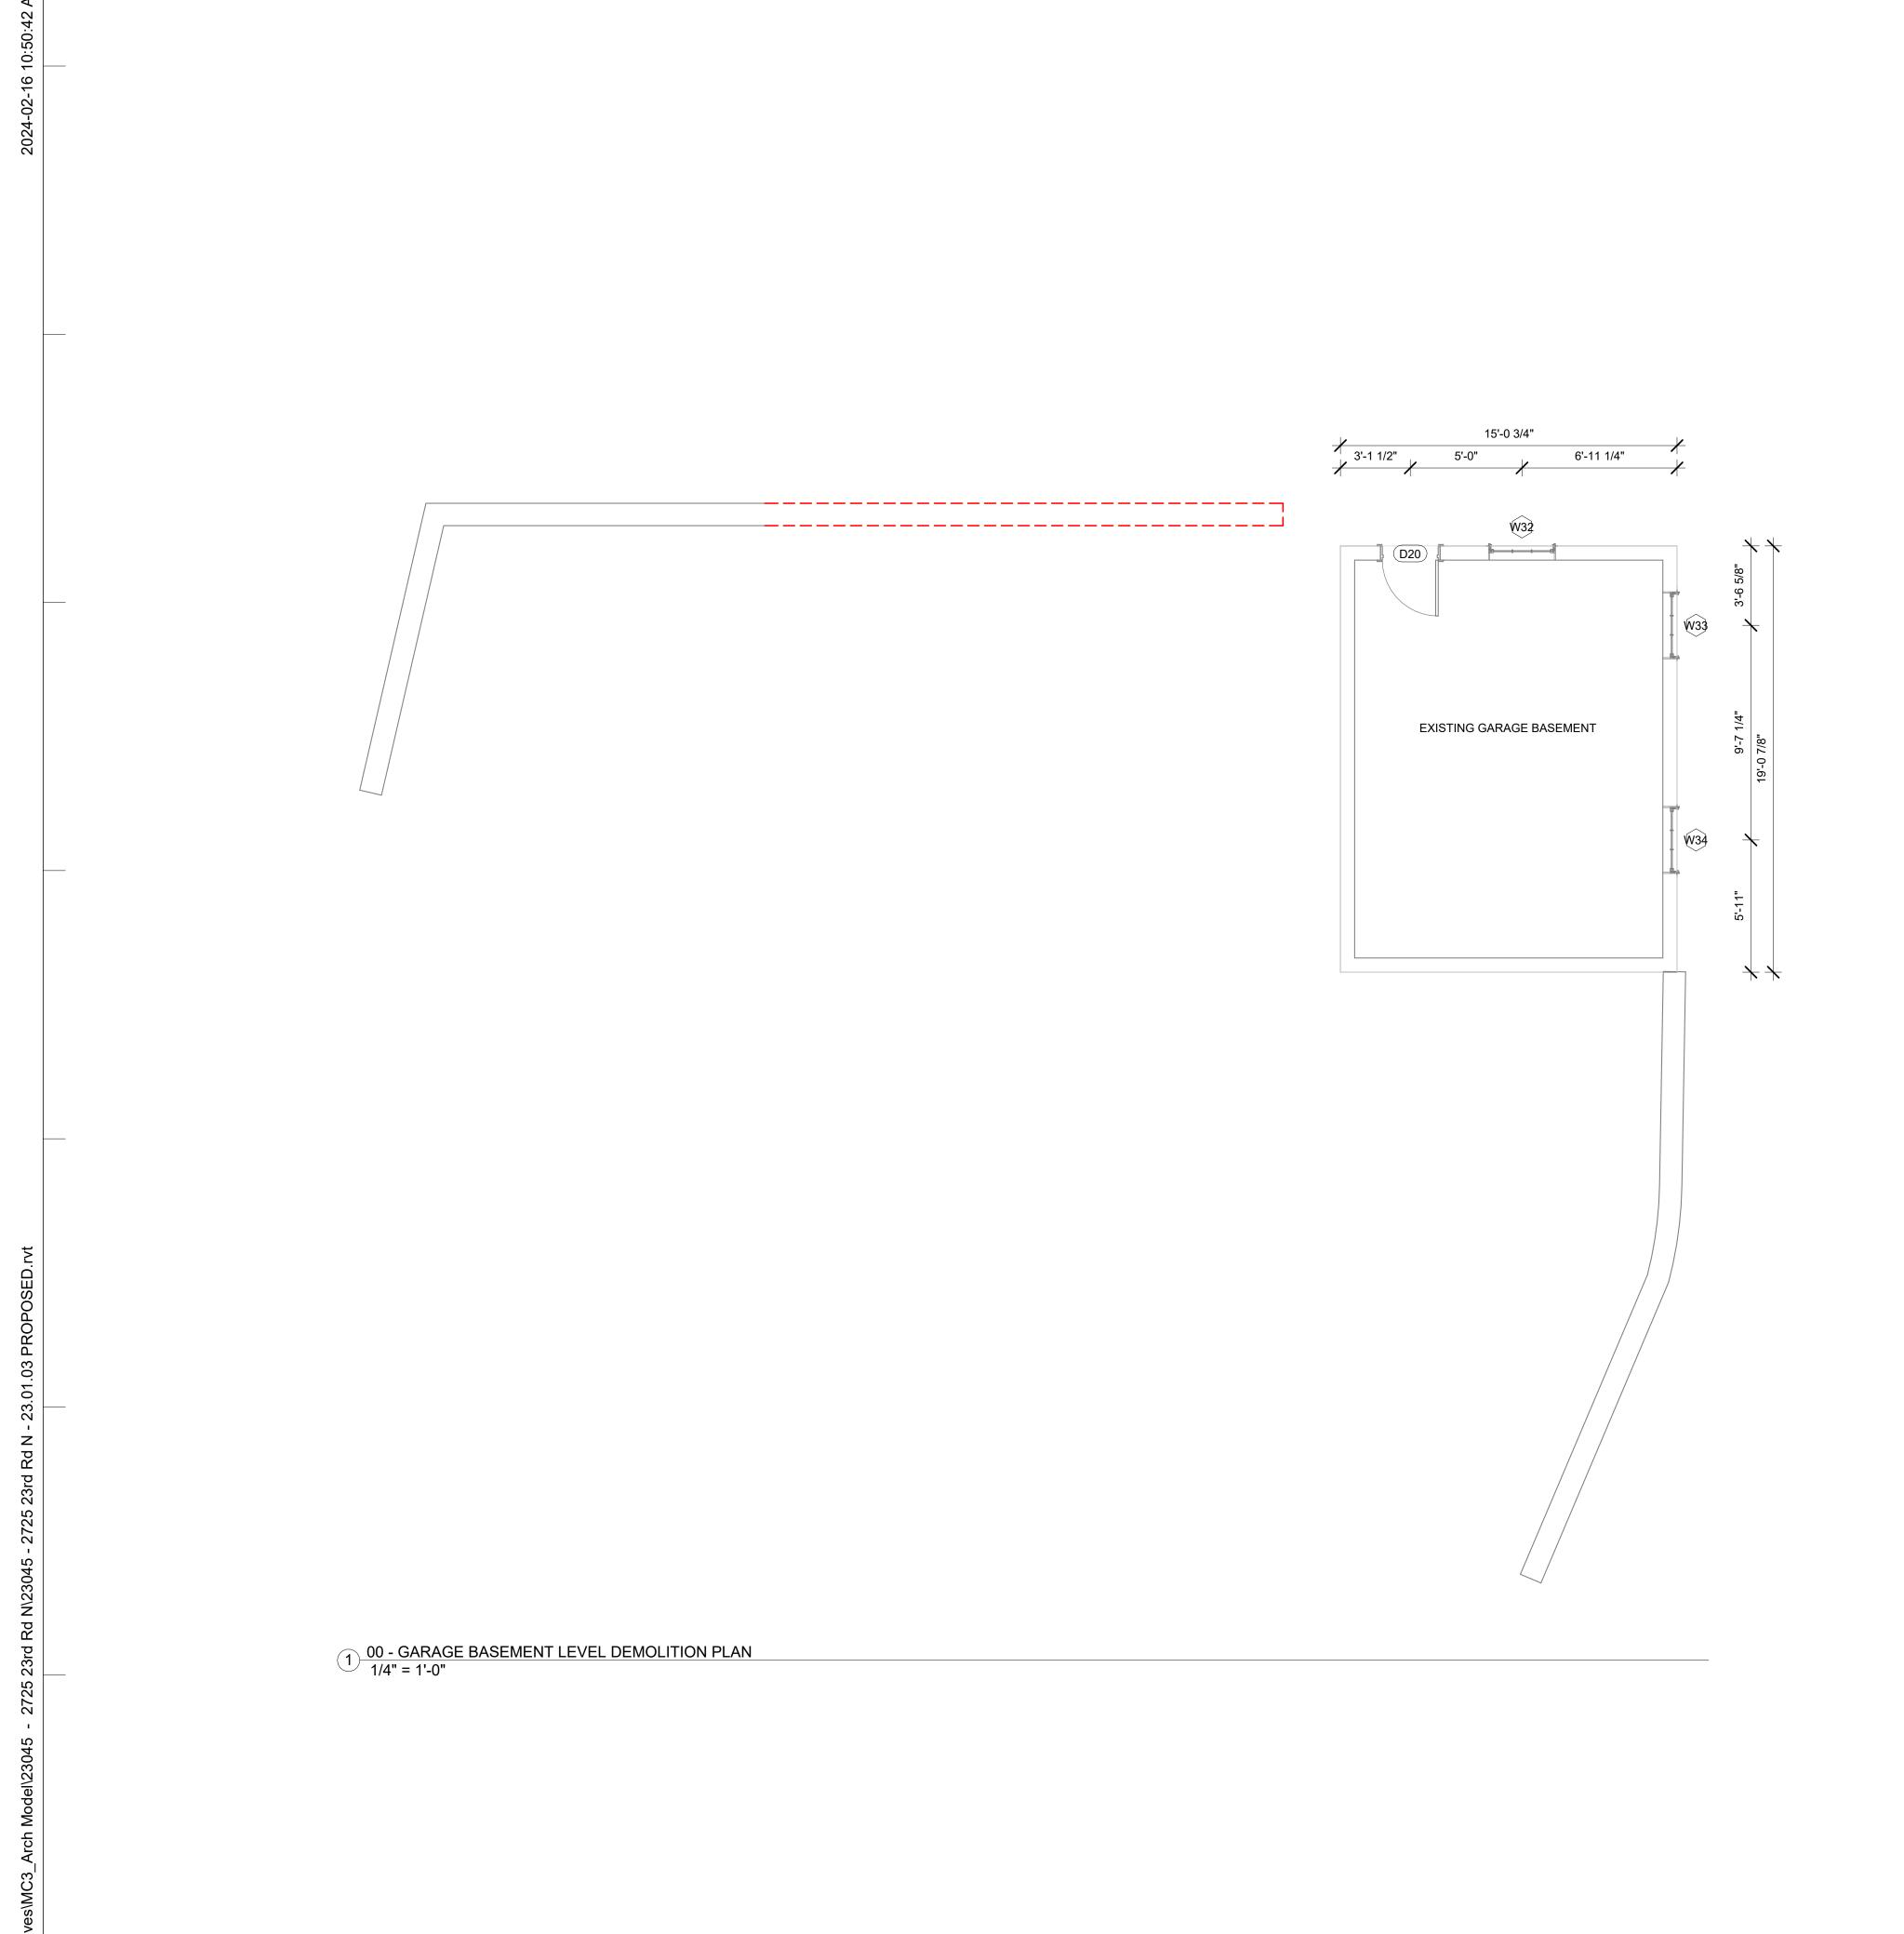

DOOR NUMBE		ADER GHT WIDTH		EXISTING OR NEW			DEMO		
D20	84	30			EXISTING		None	Vone	
			A101 -	EXIS	ΓING (GARAGE BA	SEMENT WINDOW	SCHEDU	JLE
LABEL	WIDTH	HEI	GHT	SII HEI		HEADER HEIGHT	CREATE)	DEMO
W33	36	35		49		84	EXISTING		None
W34	36	35		49		84	EXISTING		None
W32	36	35		49		84	EXISTING		None
TOTAL:	3								
			A101	- GAR	AGE E	BASEMENT '	WALL DEMOLITION	N TAKEOI	FF
MATERIAL NAME					AF	REA		LINEAR FOOTAGE	
EXISTING RETAINING WALL				219 S			23.208 L	C	

MC3 DESIGN

1308 VINCENT PLACE MCLEAN, VA 22101

202.599.7779 JMCKENNA@MC3.DESIGN

DRAWN BY:

JOHN MCKENNA, AIA, NCARB ARCHITECT

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SEAL

CODE

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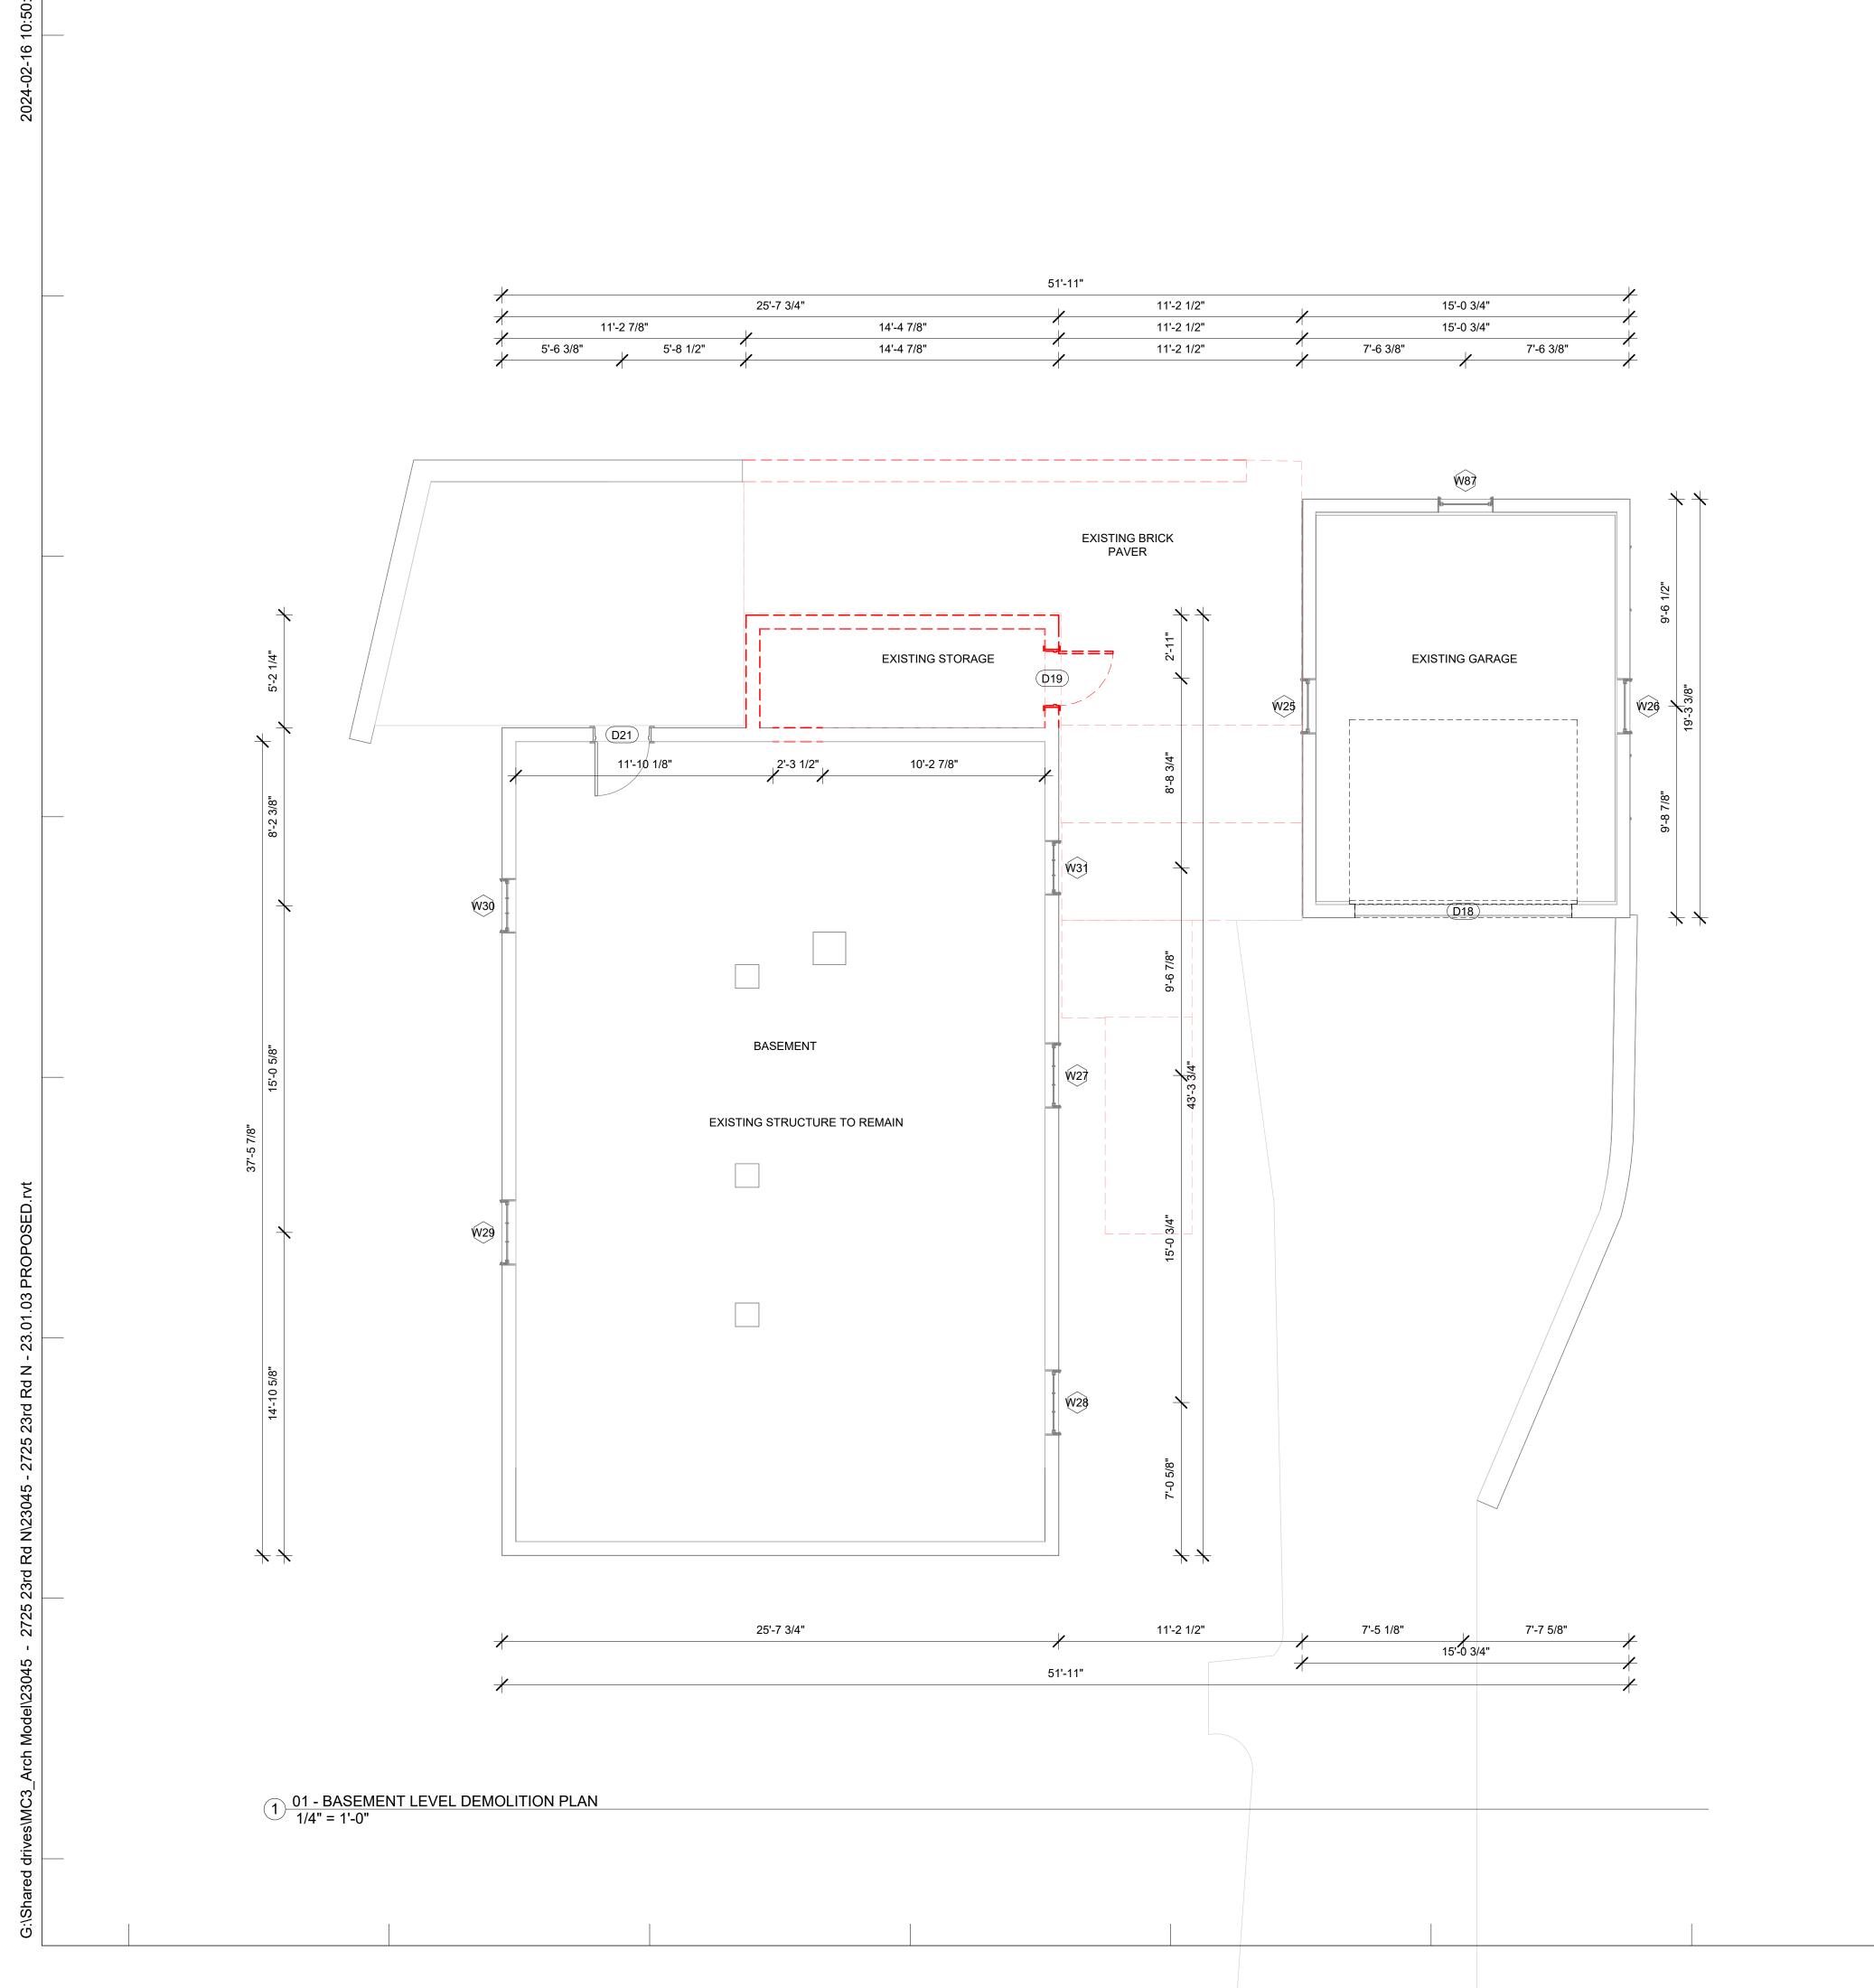
NO.	DESCRIPTION	DATE

SHEET TITLE

DEMOLITION PLAN GARAGE BASEMENT LEVEL

SCALE 1/4" = 1'-0" DATE 02.16.2024

SHEET NO.



A102 - EXISTING BASEMENT DOOR SCHEDULE DOOR HEADER NUMBER HEIGHT WIDTH DEMO EXISTING OR NEW NEW CONSTRUCTION 30 EXISTING D21 84 **EXISTING** A102 - EXISTING GARAGE DOOR SCHEDULE DOOR HEADER NUMBER HEIGHT WIDTH **EXISTING OR NEW** DEMO 120 84 **EXISTING** None A102 - EXISTING BASEMENT WINDOW SCHEDULE SILL HEADER LABEL WIDTH HEIGHT HEIGHT HEIGHT DEMO CREATED W27 36 EXISTING 36 35 EXISTING None W29 EXISTING None EXISTING 30 None W31 30 EXISTING None TOTAL: 5 A102 - EXISTING GARAGE WINDOW SCHEDULE SILL HEADER HEIGHT HEIGHT CREATED LABEL | WIDTH | HEIGHT DEMO W25 31 EXISTING 31 EXISTING 24 None W87 31 None EXISTING TOTAL: 3 A102 - BASEMENT FLOORING DEMOLITION TAKEOFF MATERIAL NAME AREA COMMENTS BRICK PAVER HERRINGBONE 315 SF CONCRETE 60 SF A102 - BASEMENT WALL DEMOLITION TAKEOFF

A102 - BASEMENT CEILING DEMOLITION TAKEOFF

AREA

171 SF

60 SF

MATERIAL NAME

MATERIAL NAME

GYPSUM WALL BOARD 1/2"

TEXTURED 8" CMU



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LINEAR FOOTAGE

COMMENT

24.623 LF

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2725 23RD RD N ARLINGTON, VA 22201

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NO.	DESCRIPTION	DATE

SHEET TITLE

DEMOLITION PLAN **BASEMENT** LEVEL

SCALE 1/4" = 1'-0" 02.16.2024

SHEET NO.



A103 - EXISTING FIRST LEVEL DOOR SCHEDULE							
DOOR NUMBER	HEADER HEIGHT	WIDTH	EXISTING OR NEW	DEMO			
1	80	26	EXISTING	NEW CONSTRUCTION			
3	0	84	EXISTING	NEW CONSTRUCTION			
2	77	24	EXISTING	NEW CONSTRUCTION			
5	0	0	EXISTING	NEW CONSTRUCTION			
6	0	0	EXISTING	NEW CONSTRUCTION			
7	77	24	EXISTING	NEW CONSTRUCTION			
8	80	30	EXISTING	NEW CONSTRUCTION			
9	0	0	EXISTING	NEW CONSTRUCTION			
11	0	0	EXISTING	NEW CONSTRUCTION			
44	77	24	EXISTING	NEW CONSTRUCTION			
4	0	0	EXISTING	None			

A103 - EXISTING FIRST LEVEL WINDOW SCHEDULE

None

EXISTING

90

MATERIAL NAME

36

			SILL	HEADER		
LABEL	WIDTH	HEIGHT	HEIGHT	HEIGHT	CREATED	DEMO
W1	30	60	30	90	EXISTING	NEW CONSTRUCTION
W8	44	45	30	75	EXISTING	NEW CONSTRUCTION
W9	44	45	30	75	EXISTING	NEW CONSTRUCTION
W10	24	48	30	78	EXISTING	NEW CONSTRUCTION
W12	24	24	36	60	EXISTING	NEW CONSTRUCTION
W11	30	48	45	93	EXISTING	NEW CONSTRUCTION
W16	44	45	30	75	EXISTING	NEW CONSTRUCTION
W3	30	60	30	90	EXISTING	None
W4	30	62	30	92	EXISTING	None
W5	30	62	30	92	EXISTING	None
W6	30	60	30	90	EXISTING	None
W7	30	60	30	90	EXISTING	None
W13	24	62	30	92	EXISTING	None
W14	24	62	30	92	EXISTING	None
W15	24	62	30	92	EXISTING	None
W42	35	32	55	87	EXISTING	None
W2	35	32	55	87	EXISTING	None
TOTAL:	17		•	•		

A103 - FIRST LEVEL FLOORING DEMOLITION TAKEOFF

MATERIAL NAME	AREA	COMMENTS
BRICK PAVER HERRINGBONE	67 SF	
A103 -	FIRST LEVEL WALL DEMOLIT	TION TAKEOFF
MATERIAL NAME	AREA	LINEAR FOOTAGE
1/2" WALL SHEATHING PLYWOOD	256 SF	30.633 LF
2X4 DIMENSIONAL LUMBER	504 SF	78.404 LF
2X6 DIMENSIONAL LUMBER	456 SF	61.719 LF
AIR FILTRATION BARRIER	256 SF	30.633 LF
EXTERIOR SIDING	256 SF	30.633 LF
GYPSUM WALL BOARD 1/2"	1661 SF	140.123 LF
VAPOR RETARDER	256 SF	30.633 LF

2725 23RD RD N ARLINGTON, VA 22201 A103 - FIRST LEVEL CEILING DEMOLITION TAKEOFF AREA

COMMENT

REVISIONS

CODE

CODE (IRC)

PROJECT

NO.	DESCRIPTION	DATE

SHEET TITLE

DEMOLITION PLAN FIRST LEVEL

SCALE	1/4" = 1'-0"
DATE	02.16.2024

SHEET NO.

A103

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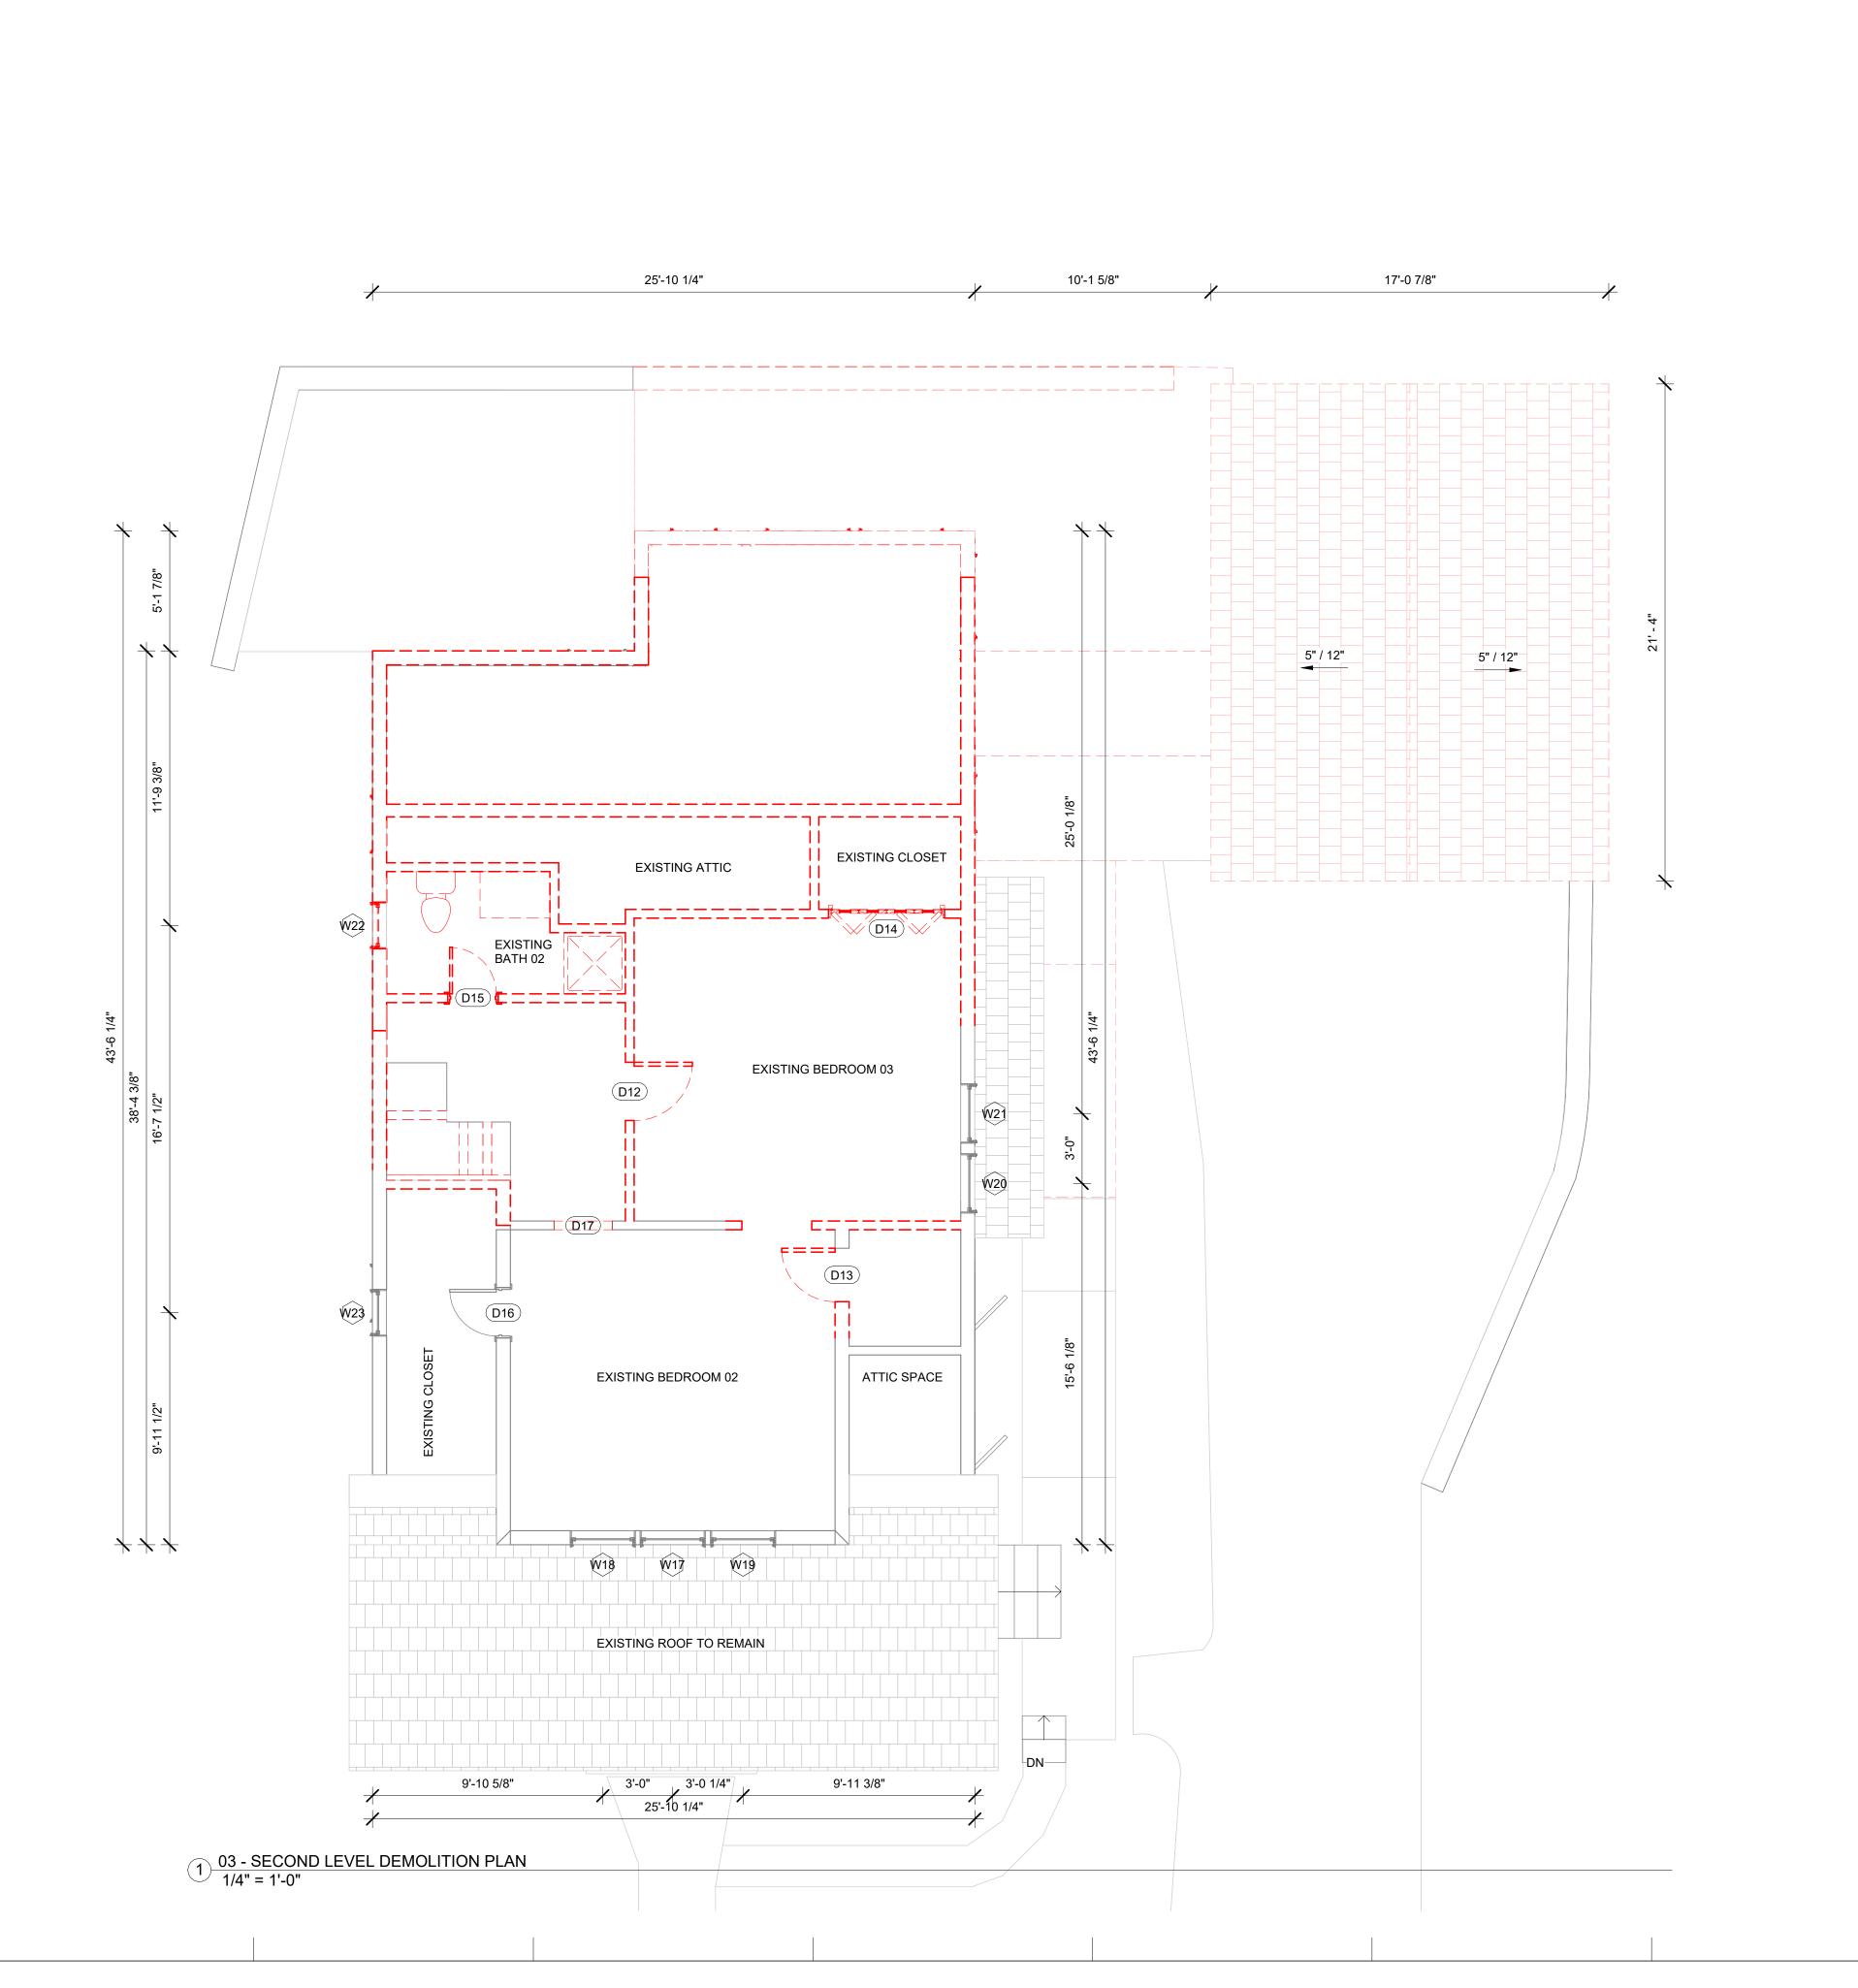
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SEAL



			A	104 - E	XISTI	NG SECOND	LEVEL DOOR SCI	HEDULE	
DOOR NUMBE		DER GHT	WIE	DTH		EXISTING	GOR NEW		DEMO
D12	80		30		EXIST	ING		NEW CO	NSTRUCTION
D13	80		28		EXIST	ING		NEW CO	NSTRUCTION
D14	96		60		EXIST	ING		NEW CO	NSTRUCTION
D15	77		24		EXIST	ING		NEW CO	NSTRUCTION
D17	0		0		EXIST	ING		NEW CO	NSTRUCTION
D25	80		36		EXIST	ING		NEW CO	NSTRUCTION
D16	77		24		EXIST	ING		None	
A104 - EXISTING SECOND LEVEL WINDOW SCHEDULE									
LABEL	WIDTH	HEIC	GHT	SI HEI		HEADER HEIGHT	CREATED)	DEMO
W22	24	60		24		84	EXISTING		NEW CONSTRUCTION

LABEL	WIDTH	HEIGHT	SILL HEIGHT	HEADER HEIGHT	CREATED	DEMO
W22	24	60	24	84	EXISTING	NEW CONSTRUCTION
W17	34	54	47	101	EXISTING	None
W18	34	54	47	101	EXISTING	None
W19	34	54	47	101	EXISTING	None
W23	24	46	24	70	EXISTING	None
W20	31	62	34	95	EXISTING	None
W21	31	62	34	95	EXISTING	None

TOTAL: 7

MATERIAL NAME

A104 - SECOND LEVEL FLOORING DEMOLITION TAKEOFF

COMMENTS

AREA

A104 - SECOND LEVEL WALL DEMOLITION TAKEOFF							
MATERIAL NAME	AREA	LINEAR FOOTAGE					
1/2" WALL SHEATHING PLYWOOD	466 SF	69.094 LF					
2X4 DIMENSIONAL LUMBER	569 SF	72.119 LF					
2X6 DIMENSIONAL LUMBER	696 SF	94.344 LF					
AIR FILTRATION BARRIER	472 SF	69.094 LF					
EXTERIOR SIDING	465 SF	69.094 LF					
GYPSUM WALL BOARD 1/2"	2052 SF	166.462 LF					
VAPOR RETARDER	472 SF	69.094 LF					

A104 - SECOND LEVEL CEILING DEMOLITION TAKEOFF

MATERIAL NAME AREA COMMENT

MC3 DESIG



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2725 23RD RD N ARLINGTON, VA 22201

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DESCRIPTION	DATE
	DESCRIPTION

SHEET TITLE

DEMOLITION
PLAN
SECOND
LEVEL

DATE 1/4" = 1'-0"

SHEET NO.

A105 - ROOF DEMOLITION TAKEOFF

MATERIAL NAME AREA COMMENTS

ASPHALT SHINGLES 1023 SF

GYPSUM WALL BOARD 1/2" 1023 SF





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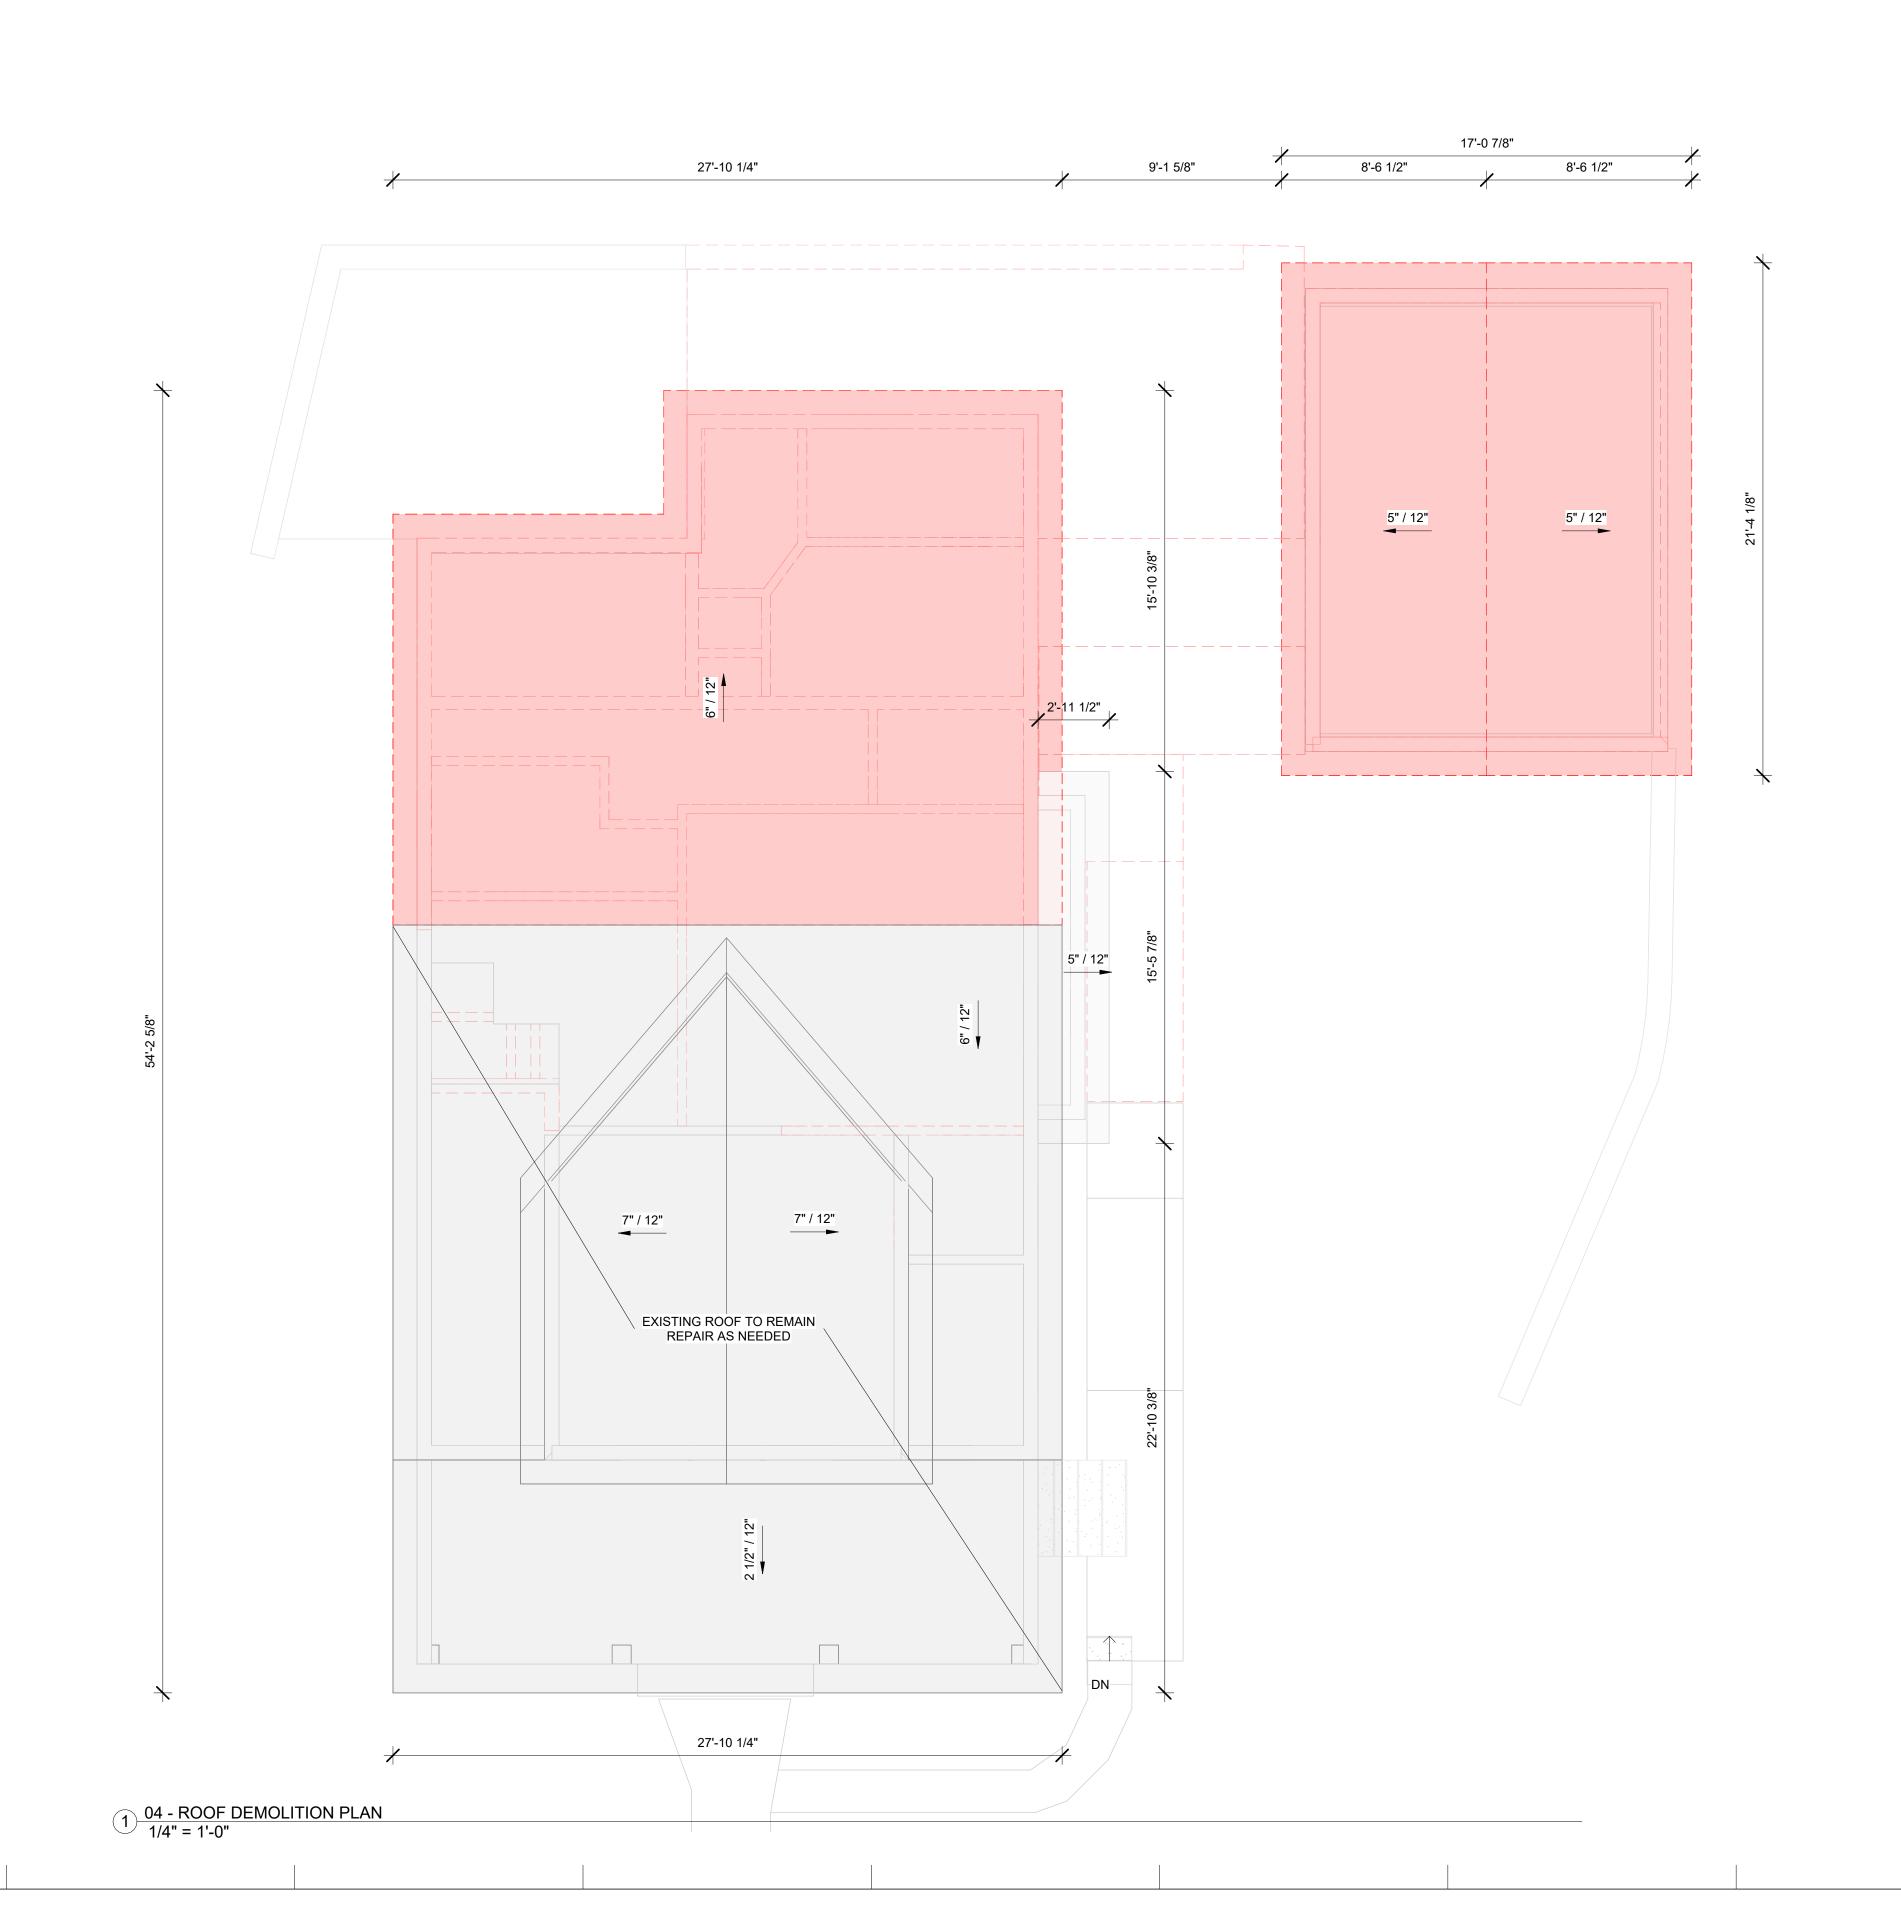
NO.	DESCRIPTION	DATE

SHEET TITLE

DEMOLITION ROOF PLAN

SCALE	1/4" = 1'-0'
DATE	02.16.2024

SHEET NO.



5'-0" 6'-11 1/4" DECK ABOVE POTENTIAL RETAINING WALL TO REMAIN **UNEXCAVATED SOIL** BASEMENT LEVEL ABOVE EXISTING BASEMENT UNDER GARAGE W34 + EXISTING HOUSE FOOTPRINT EXISTING RETAINING WALL TO REMAIN 1) 00 - PROPOSED GARAGE BASEMENT LEVEL 1/4" = 1'-0"

MC3 D≣SIG



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NO.	DESCRIPTION	DATE

SHEET TITLE

PROPOSED GARAGE BASEMENT PLAN


SCALE 1/4" = 1'-0"

SHEET NO.

DATE

1111

02.16.2024

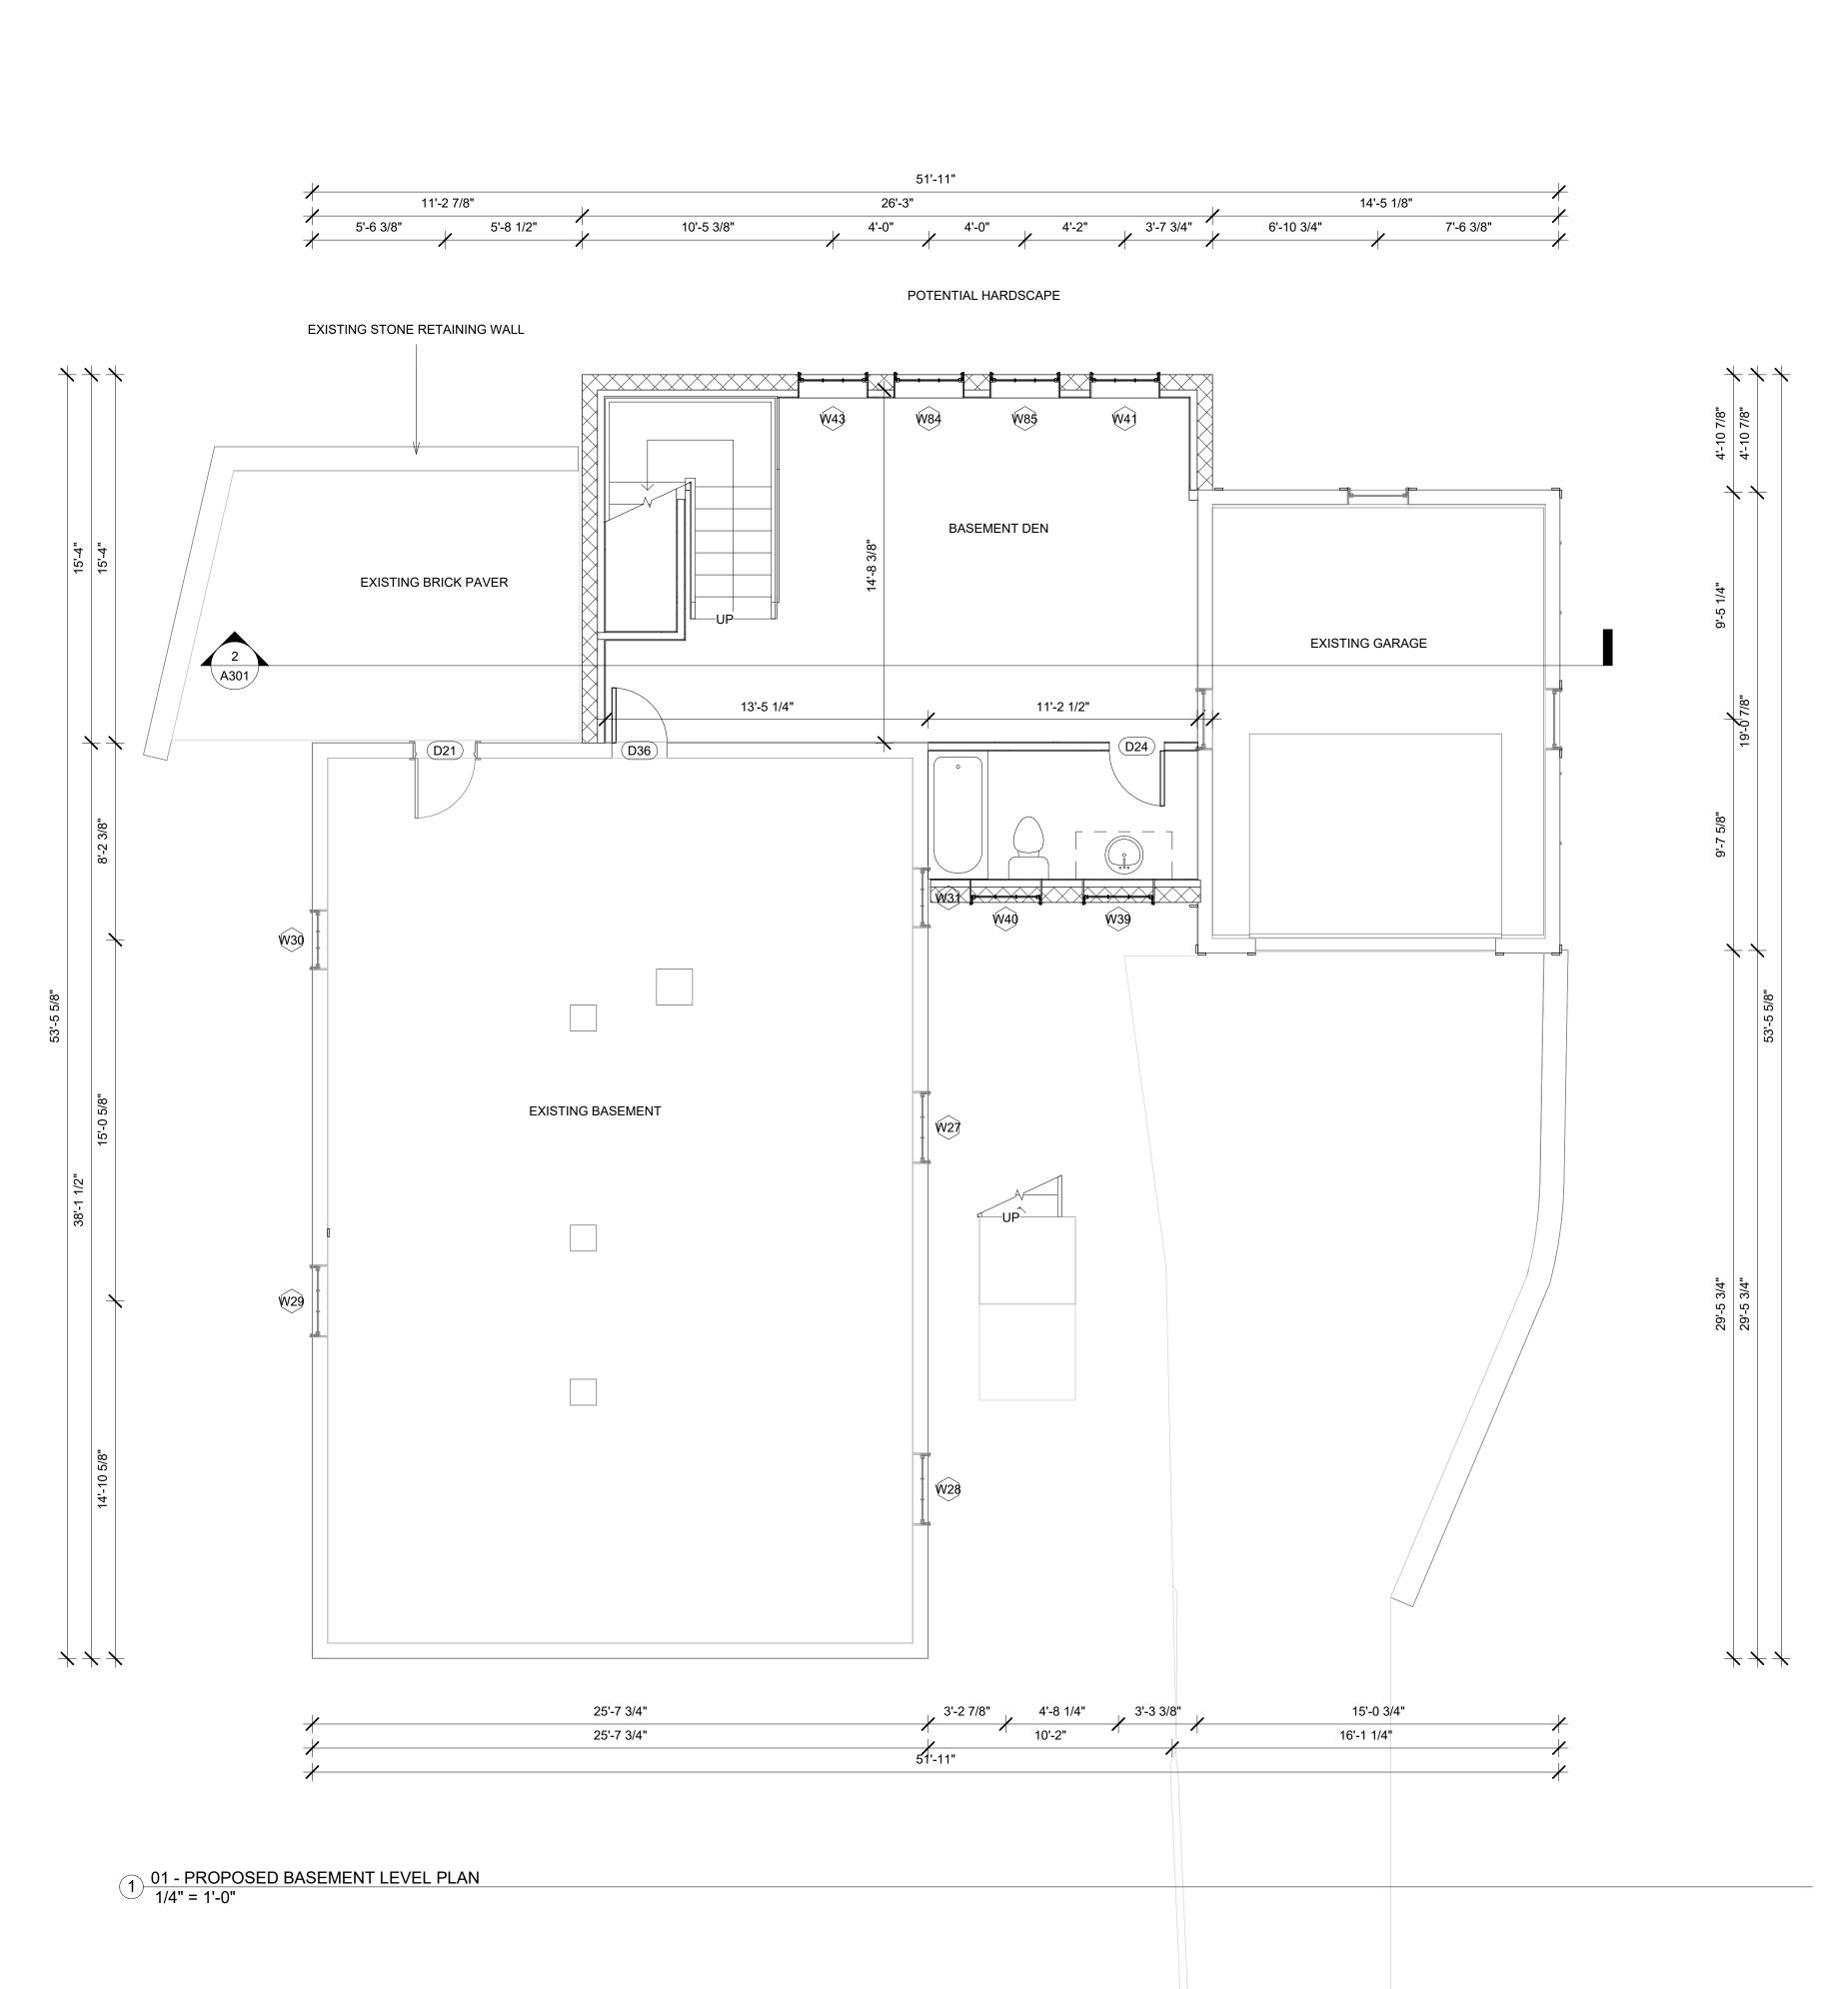

DOOR	NUMBER	HEADER HEIGHT			WIDTH	
D24		80			28	
D36		80			28	
TOTAL: 2						
	A112 - E	BASEMENT LE	EVEL NEW W	INDOW SC	HEDULE	
LABEL	WIDTH	1	HEIGHT	SII	LL HEIGHT	HEADER HEIGHT
W39	36	35		49		84
W40	36	35		49		84
W41	35	35		42		77
W43	35	35		42		77
W84	35	35		42		77
W85	35	35		42		77
TOTAL: 6						
	A112 - E	BASEMENT LE	EVEL NEW FL	OORING T	AKEOFF	
MATER	RIAL NAME		AREA		(COMMENTS
CONCRETE		434 SF				
	A112	- BASEMENT	LEVEL NEW	WALL TAK	EOFF	
MATER	RIAL NAME		AREA		LINI	EAR FOOTAGE
2X4 DIMENSION	IAL LUMBER	567 SF			94.621 LF	
GYPSUM WALL	BOARD 1/2"	730 SF			94.621 LF	
TEXTURED 8" C	NAL I	415 SF			58.094 LF	

A112 - BASEMENT LEVEL NEW CEILING TAKEOFF

AREA

COMMENT

MATERIAL NAME



MC3 DESIGN 1308 VINCENT PLACE MCLEAN, VA 22101

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COE RESIDENCE

2725 23RD RD N ARLINGTON, VA 22201

REVISIONS

NO.	DESCRIPTION	DATE

SHEET TITLE

PROPOSED BASEMENT PLAN

SCALE 1/4" = 1'-0" 02.16.2024 DATE

SHEET NO.

DOOR	RNUMBER	HE	ADER HEIGH	Т		WIDTH	
D22		84			30		
D23		96			96		
D28		84	84			30	
D29		80			30		
D30		96			90		
TOTAL: 5							
			EL NEW WIND	OOW SCHE	DULE		
LABEL	WIDTH		HEIGHT		LL HEIGHT	HEADER HEIGI	
W35	36	84		12		96	
W36	36	84		12		96	
W37	30	62		30		92	
W38	30	62		30		92	
W51 W63	36 36	84 84		12 72		96 156	
W64 W65	36 36	84 35		72 12		156 47	
W66	36	35		12		47	
w86	30	60		30		90	
TOTAL: 10	100	00		100		100	
. O I / L. 10		DOT : =: :=:		A//2 15 5::)		
	A113 - FI	RST LEVEL C	FFSET NEW \	WINDOW S	CHEDULE		
LABEL	WIDTH	H	HEIGHT	SII	LL HEIGHT	HEADER HEIG	
W24	36	84		12		96	
W70	36	84		12		96	
W71	36	84		12		96	
W73	36	84		12		96	
W74	36	84		12		96	
W75	36	84		12		96	
W77	30	62		30		92	
W78	30	62		30		92	
W79 TOTAL: 9	30	62		30		92	
MATEF BRICK PAVER F DECKING FINIS	RIAL NAME HERRINGBONE	3 - FIRST LEV 15 SF 446 SF	EL NEW FLOO	ORING TAK		COMMENTS	
BRICK PAVER H DECKING FINIS FLOOR SHEATH	RIAL NAME HERRINGBONE H HING PLYWOOD	15 SF 446 SF 305 SF		ORING TAK		COMMENTS	
BRICK PAVER H DECKING FINIS FLOOR SHEATH	RIAL NAME HERRINGBONE H HING PLYWOOD FLOOR	15 SF 446 SF 305 SF 305 SF				COMMENTS	
BRICK PAVER H DECKING FINIS FLOOR SHEATH WOOD FINISH F	RIAL NAME HERRINGBONE H HING PLYWOOD FLOOR A113 - FI	15 SF 446 SF 305 SF 305 SF	AREA		TAKEOFF		
BRICK PAVER H DECKING FINIS FLOOR SHEATH WOOD FINISH F MATER	RIAL NAME HERRINGBONE H HING PLYWOOD FLOOR A113 - FI	15 SF 446 SF 305 SF 305 SF RST LEVEL C	AREA		TAKEOFF	COMMENTS	
BRICK PAVER H DECKING FINIS FLOOR SHEATH WOOD FINISH F MATER FLOOR SHEATH	RIAL NAME HERRINGBONE H HING PLYWOOD FLOOR A113 - FI	15 SF 446 SF 305 SF 305 SF RST LEVEL C	AREA		TAKEOFF		
BRICK PAVER H DECKING FINIS FLOOR SHEATH WOOD FINISH F MATER	RIAL NAME HERRINGBONE H HING PLYWOOD FLOOR A113 - FI	15 SF 446 SF 305 SF 305 SF RST LEVEL C 278 SF 278 SF	AREA	FLOORING	TAKEOFF		
BRICK PAVER H DECKING FINIS FLOOR SHEATH WOOD FINISH F MATEF FLOOR SHEATH WOOD FINISH F	RIAL NAME HERRINGBONE H HING PLYWOOD FLOOR A113 - FI	15 SF 446 SF 305 SF 305 SF RST LEVEL C 278 SF 278 SF	AREA FFSET NEW I AREA	FLOORING	TAKEOFF		
BRICK PAVER H DECKING FINIS FLOOR SHEATH WOOD FINISH F MATER FLOOR SHEATH WOOD FINISH F	RIAL NAME HERRINGBONE H HING PLYWOOD FLOOR A113 - FI	15 SF 446 SF 305 SF 305 SF RST LEVEL C 278 SF 278 SF 113 - FIRST L	AREA OFFSET NEW I AREA EVEL NEW W	FLOORING	TAKEOFF	COMMENTS	
BRICK PAVER H DECKING FINIS FLOOR SHEATH WOOD FINISH F MATER FLOOR SHEATH WOOD FINISH F MATER 1/2" WALL SHEA	RIAL NAME HERRINGBONE H HING PLYWOOD FLOOR A113 - FII RIAL NAME HING PLYWOOD FLOOR A RIAL NAME ATHING PLYWOOD NAL LUMBER	15 SF 446 SF 305 SF 305 SF RST LEVEL C 278 SF 278 SF 113 - FIRST L 362 SF 257 SF	AREA OFFSET NEW I AREA EVEL NEW W	FLOORING	TAKEOFF	COMMENTS	
BRICK PAVER H DECKING FINISI FLOOR SHEATH WOOD FINISH F MATEF FLOOR SHEATH WOOD FINISH F MATEF 1/2" WALL SHEA 2X4 DIMENSION 2X6 DIMENSION	RIAL NAME HERRINGBONE H HING PLYWOOD FLOOR A113 - FII RIAL NAME HING PLYWOOD FLOOR AT RIAL NAME ATHING PLYWOOD NAL LUMBER NAL LUMBER	15 SF 446 SF 305 SF 305 SF RST LEVEL C 278 SF 278 SF 113 - FIRST L 362 SF 257 SF 365 SF	AREA OFFSET NEW I AREA EVEL NEW W	FLOORING	TAKEOFF DFF LIN 57.990 LF 51.765 LF 57.990 LF	COMMENTS	
BRICK PAVER H DECKING FINISI FLOOR SHEATH WOOD FINISH F MATER FLOOR SHEATH WOOD FINISH F MATER 1/2" WALL SHEATH 2X4 DIMENSION AIR FILTRATION	RIAL NAME HERRINGBONE H HING PLYWOOD FLOOR A113 - FI RIAL NAME HING PLYWOOD FLOOR A RIAL NAME ATHING PLYWOOD NAL LUMBER NAL LUMBER N BARRIER	15 SF 446 SF 305 SF 305 SF RST LEVEL C 278 SF 278 SF 113 - FIRST L 362 SF 257 SF 365 SF 365 SF	AREA OFFSET NEW I AREA EVEL NEW W	FLOORING	TAKEOFF DFF LIN 57.990 LF 57.990 LF 57.990 LF 57.990 LF	COMMENTS	
BRICK PAVER H DECKING FINIS FLOOR SHEATH WOOD FINISH F MATER FLOOR SHEATH WOOD FINISH F MATER 1/2" WALL SHEATH 2X4 DIMENSION 2X6 DIMENSION AIR FILTRATION EXTERIOR SIDII	RIAL NAME HERRINGBONE H HING PLYWOOD FLOOR A113 - FII RIAL NAME HING PLYWOOD FLOOR A RIAL NAME ATHING PLYWOOD NAL LUMBER NAL LUMBER N BARRIER NG	15 SF 446 SF 305 SF 305 SF RST LEVEL C 278 SF 278 SF 278 SF 113 - FIRST L 362 SF 257 SF 365 SF 365 SF 361 SF	AREA OFFSET NEW I AREA EVEL NEW W	FLOORING	TAKEOFF LIN 57.990 LF 57.990 LF 57.990 LF 57.990 LF 57.990 LF	COMMENTS	
BRICK PAVER H DECKING FINIS FLOOR SHEATH WOOD FINISH F MATER FLOOR SHEATH WOOD FINISH F MATER 1/2" WALL SHEAT 2X4 DIMENSION 2X6 DIMENSION AIR FILTRATION EXTERIOR SIDII GYPSUM WALL	RIAL NAME HERRINGBONE H HING PLYWOOD FLOOR A113 - FII RIAL NAME HING PLYWOOD FLOOR A RIAL NAME ATHING PLYWOOD NAL LUMBER NAL LUMBER N BARRIER NG	15 SF 446 SF 305 SF 305 SF RST LEVEL C 278 SF 278 SF 113 - FIRST L 362 SF 257 SF 365 SF 365 SF 361 SF 878 SF	AREA OFFSET NEW I AREA EVEL NEW W	FLOORING	TAKEOFF LIN 57.990 LF 57.990 LF 57.990 LF 57.990 LF 109.755 LF	COMMENTS	
BRICK PAVER H DECKING FINISI FLOOR SHEATH WOOD FINISH F MATEF FLOOR SHEATH WOOD FINISH F MATEF 1/2" WALL SHEAT 2X4 DIMENSION 2X6 DIMENSION AIR FILTRATION EXTERIOR SIDII GYPSUM WALL STONE 01	RIAL NAME HERRINGBONE H HING PLYWOOD FLOOR A113 - FI RIAL NAME HING PLYWOOD FLOOR A RIAL NAME ATHING PLYWOOD NAL LUMBER NAL LUMBER N BARRIER NG BOARD 1/2"	15 SF 446 SF 305 SF 305 SF RST LEVEL C 278 SF 278 SF 113 - FIRST L 362 SF 257 SF 365 SF 365 SF 361 SF 878 SF 112 SF	AREA OFFSET NEW I AREA EVEL NEW W	FLOORING	TAKEOFF LIN 57.990 LF 57.990 LF 57.990 LF 57.990 LF 109.755 LF 11.969 LF	COMMENTS	
BRICK PAVER H DECKING FINISI FLOOR SHEATH WOOD FINISH F MATEF FLOOR SHEATH WOOD FINISH F MATEF 1/2" WALL SHEAT 2X4 DIMENSION 2X6 DIMENSION AIR FILTRATION EXTERIOR SIDII GYPSUM WALL STONE 01	RIAL NAME HERRINGBONE H HING PLYWOOD FLOOR A113 - FII RIAL NAME HING PLYWOOD FLOOR AT RIAL NAME ATHING PLYWOOD NAL LUMBER NAL LUMBER NAL LUMBER NAL BARRIER NG BOARD 1/2" DER	15 SF 446 SF 305 SF 305 SF RST LEVEL C 278 SF 278 SF 113 - FIRST L 362 SF 257 SF 365 SF 365 SF 361 SF 878 SF 112 SF 365 SF	AREA OFFSET NEW I AREA EVEL NEW W. AREA	FLOORING ALL TAKEO	TAKEOFF LIN 57.990 LF 57.990 LF 57.990 LF 57.990 LF 109.755 LF 11.969 LF 57.990 LF	COMMENTS	
BRICK PAVER H DECKING FINIS FLOOR SHEATH WOOD FINISH F MATER FLOOR SHEATH WOOD FINISH F MATER 1/2" WALL SHEA 2X4 DIMENSION 2X6 DIMENSION AIR FILTRATION EXTERIOR SIDII GYPSUM WALL STONE 01 VAPOR RETARE	RIAL NAME HERRINGBONE H HING PLYWOOD FLOOR A113 - FII RIAL NAME HING PLYWOOD FLOOR AFIAL NAME ATHING PLYWOOD NAL LUMBER	15 SF 446 SF 305 SF 305 SF RST LEVEL C 278 SF 278 SF 113 - FIRST L 362 SF 257 SF 365 SF 365 SF 361 SF 878 SF 112 SF 365 SF	AREA OFFSET NEW WAREA OFFSET NEW	FLOORING ALL TAKEO	TAKEOFF LIN 57.990 LF 57.990 LF 57.990 LF 57.990 LF 109.755 LF 11.969 LF 57.990 LF	COMMENTS IEAR FOOTAGE	
BRICK PAVER H DECKING FINISI FLOOR SHEATH WOOD FINISH F MATEF FLOOR SHEATH WOOD FINISH F MATEF 1/2" WALL SHEAT 2X4 DIMENSION 2X6 DIMENSION AIR FILTRATION EXTERIOR SIDII GYPSUM WALL STONE 01 VAPOR RETARE	RIAL NAME HERRINGBONE H HING PLYWOOD FLOOR A113 - FII RIAL NAME HING PLYWOOD FLOOR AT RIAL NAME ATHING PLYWOOD NAL LUMBER NAL LUMBER N BARRIER NG BOARD 1/2" DER A113 - RIAL NAME	15 SF 446 SF 305 SF 305 SF RST LEVEL C 278 SF 278 SF 113 - FIRST L 362 SF 257 SF 365 SF 365 SF 361 SF 878 SF 112 SF 112 SF 365 SF	AREA OFFSET NEW I AREA EVEL NEW W. AREA	FLOORING ALL TAKEO	TAKEOFF LIN 57.990 LF 57.990 LF 57.990 LF 57.990 LF 109.755 LF 11.969 LF 57.990 LF AKEOFF LIN	COMMENTS	
BRICK PAVER H DECKING FINIS FLOOR SHEATH WOOD FINISH F MATER FLOOR SHEATH WOOD FINISH F MATER 1/2" WALL SHEA 2X4 DIMENSION 2X6 DIMENSION 2X6 DIMENSION EXTERIOR SIDII GYPSUM WALL STONE 01 VAPOR RETARE MATER 1/2" WALL SHEA	RIAL NAME HERRINGBONE H HING PLYWOOD FLOOR A113 - FI RIAL NAME HING PLYWOOD FLOOR A RIAL NAME ATHING PLYWOOD NAL LUMBER NAL LUMBER NAL LUMBER NBARRIER NG BOARD 1/2" DER A113 - RIAL NAME ATHING PLYWOOD	15 SF 446 SF 305 SF 305 SF RST LEVEL C 278 SF 278 SF 113 - FIRST L 362 SF 257 SF 365 SF 365 SF 361 SF 878 SF 112 SF 365 SF	AREA OFFSET NEW WAREA OFFSET NEW	FLOORING ALL TAKEO	TAKEOFF LIN 57.990 LF 57.990 LF 57.990 LF 57.990 LF 109.755 LF 11.969 LF 57.990 LF AKEOFF LIN 50.401 LF	COMMENTS IEAR FOOTAGE	
BRICK PAVER H DECKING FINIS FLOOR SHEATH WOOD FINISH F MATER FLOOR SHEATH WOOD FINISH F MATER 1/2" WALL SHEA 2X4 DIMENSION 2X6 DIMENSION EXTERIOR SIDII GYPSUM WALL STONE 01 VAPOR RETARD MATER 1/2" WALL SHEA 2X4 DIMENSION	RIAL NAME HERRINGBONE H HING PLYWOOD FLOOR A113 - FI RIAL NAME HING PLYWOOD FLOOR A RIAL NAME ATHING PLYWOOD NAL LUMBER A113 - RIAL NAME ATHING PLYWOOD NAL LUMBER A113 - RIAL NAME ATHING PLYWOOD NAL LUMBER	15 SF 446 SF 305 SF 305 SF RST LEVEL C 278 SF 278 SF 113 - FIRST L 362 SF 257 SF 365 SF 365 SF 361 SF 878 SF 112 SF 112 SF 365 SF	AREA OFFSET NEW WAREA OFFSET NEW	FLOORING ALL TAKEO	TAKEOFF LIN 57.990 LF 57.990 LF 57.990 LF 57.990 LF 109.755 LF 11.969 LF 57.990 LF AKEOFF LIN	COMMENTS IEAR FOOTAGE	
BRICK PAVER H DECKING FINIS FLOOR SHEATH WOOD FINISH F MATER FLOOR SHEATH WOOD FINISH F MATER 1/2" WALL SHEA 2X4 DIMENSION 2X6 DIMENSION AIR FILTRATION EXTERIOR SIDII GYPSUM WALL STONE 01 VAPOR RETARD MATER 1/2" WALL SHEA 2X4 DIMENSION 2X6 DIMENSION	RIAL NAME HERRINGBONE H HING PLYWOOD FLOOR A113 - FI RIAL NAME HING PLYWOOD FLOOR AT RIAL NAME ATHING PLYWOOD NAL LUMBER NAL LUMBER NG BOARD 1/2" DER A113 - RIAL NAME ATHING PLYWOOD NAL LUMBER NG A113 - RIAL NAME ATHING PLYWOOD NAL LUMBER NG A113 - RIAL NAME ATHING PLYWOOD NAL LUMBER	15 SF 446 SF 305 SF 305 SF RST LEVEL C 278 SF 278 SF 278 SF 113 - FIRST L 362 SF 257 SF 365 SF 365 SF 361 SF 878 SF 112 SF 365 SF 112 SF 365 SF	AREA OFFSET NEW WAREA OFFSET NEW	FLOORING ALL TAKEO	TAKEOFF LIN 57.990 LF 57.990 LF 57.990 LF 57.990 LF 109.755 LF 11.969 LF 57.990 LF AKEOFF LIN 50.401 LF 3.359 LF	COMMENTS IEAR FOOTAGE	
BRICK PAVER H DECKING FINIS FLOOR SHEATH WOOD FINISH F MATER FLOOR SHEATH WOOD FINISH F MATER 1/2" WALL SHEAT 2X4 DIMENSION 2X6 DIMENSION EXTERIOR SIDII GYPSUM WALL STONE 01 VAPOR RETARD MATER 1/2" WALL SHEAT 2X4 DIMENSION EXTERIOR SIDII CYPSUM WALL STONE 01 VAPOR RETARD MATER 1/2" WALL SHEAT 2X4 DIMENSION 2X6 DIMENSION AIR FILTRATION AIR FILTRATION	RIAL NAME HERRINGBONE H HING PLYWOOD FLOOR A113 - FI RIAL NAME HING PLYWOOD FLOOR AF RIAL NAME ATHING PLYWOOD NAL LUMBER NAL LUMBER NG BOARD 1/2" DER A113 - RIAL NAME ATHING PLYWOOD NAL LUMBER NG BOARD 1/2" DER A113 - RIAL NAME ATHING PLYWOOD NAL LUMBER NAME ATHING PLYWOOD NAL LUMBER NAME ATHING PLYWOOD NAL LUMBER NAME NAME NAME NAME NAME NAME NAME NAME	15 SF 446 SF 305 SF 305 SF RST LEVEL C 278 SF 278 SF 278 SF 113 - FIRST L 362 SF 257 SF 365 SF 365 SF 365 SF 365 SF 365 SF 112 SF 365 SF 112 SF 243 SF 243 SF 28 SF 242 SF	AREA OFFSET NEW WAREA OFFSET NEW	FLOORING ALL TAKEO	TAKEOFF LIN 57.990 LF 57.990 LF 57.990 LF 57.990 LF 109.755 LF 11.969 LF 57.990 LF 3.359 LF 50.401 LF 3.359 LF	COMMENTS IEAR FOOTAGE	
BRICK PAVER H DECKING FINIS FLOOR SHEATH WOOD FINISH F MATER FLOOR SHEATH WOOD FINISH F MATER 1/2" WALL SHEAT 2X4 DIMENSION 2X6 DIMENSION EXTERIOR SIDII GYPSUM WALL STONE 01 VAPOR RETARD MATER 1/2" WALL SHEAT 2X4 DIMENSION EXTERIOR SIDII CYPSUM WALL STONE 01 VAPOR RETARD MATER 1/2" WALL SHEAT 2X4 DIMENSION AIR FILTRATION EXTERIOR SIDII EXTERIOR SIDII EXTERIOR SIDII EXTERIOR SIDII	RIAL NAME HERRINGBONE H HING PLYWOOD FLOOR A113 - FI RIAL NAME HING PLYWOOD FLOOR A RIAL NAME ATHING PLYWOOD NAL LUMBER NAL NAME ATHING PLYWOOD NAL LUMBER	15 SF 446 SF 305 SF 305 SF RST LEVEL C 278 SF 278 SF 278 SF 113 - FIRST L 362 SF 257 SF 365 SF 365 SF 361 SF 878 SF 112 SF 365 SF 112 SF 365 SF 243 SF 243 SF 243 SF 243 SF	AREA OFFSET NEW WAREA OFFSET NEW	FLOORING ALL TAKEO	TAKEOFF LIN 57.990 LF 57.990 LF 57.990 LF 57.990 LF 109.755 LF 11.969 LF 57.990 LF 3.359 LF 50.401 LF 50.401 LF 50.401 LF	COMMENTS IEAR FOOTAGE	
BRICK PAVER H DECKING FINIS FLOOR SHEATH WOOD FINISH F MATER FLOOR SHEATH WOOD FINISH F MATER 1/2" WALL SHEAT 2X4 DIMENSION 2X6 DIMENSION AIR FILTRATION EXTERIOR SIDII GYPSUM WALL STONE 01 VAPOR RETARD MATER 1/2" WALL SHEAT 2X4 DIMENSION AIR FILTRATION EXTERIOR SIDII GYPSUM WALL STONE 01 VAPOR RETARD MATER 1/2" WALL SHEAT 2X4 DIMENSION 2X6 DIMENSION AIR FILTRATION EXTERIOR SIDII GYPSUM WALL	RIAL NAME HERRINGBONE H HING PLYWOOD FLOOR A113 - FI RIAL NAME HING PLYWOOD FLOOR ARIAL NAME ATHING PLYWOOD NAL LUMBER	15 SF 446 SF 305 SF 305 SF RST LEVEL C 278 SF 278 SF 278 SF 113 - FIRST L 362 SF 257 SF 365 SF 365 SF 361 SF 878 SF 112 SF 365 SF 112 SF 365 SF 243 SF 243 SF 243 SF 243 SF	AREA OFFSET NEW WAREA OFFSET NEW	FLOORING ALL TAKEO	TAKEOFF LIN 57.990 LF 57.990 LF 57.990 LF 57.990 LF 109.755 LF 11.969 LF 57.990 LF 3.359 LF 50.401 LF 50.401 LF 50.401 LF 50.401 LF	COMMENTS IEAR FOOTAGE	
BRICK PAVER H DECKING FINISI FLOOR SHEATH WOOD FINISH F MATEF FLOOR SHEATH WOOD FINISH F MATEF 1/2" WALL SHEAT 2X4 DIMENSION 2X6 DIMENSION AIR FILTRATION EXTERIOR SIDII GYPSUM WALL STONE 01 VAPOR RETARE	RIAL NAME HERRINGBONE H HING PLYWOOD FLOOR A113 - FI RIAL NAME HING PLYWOOD FLOOR ARIAL NAME ATHING PLYWOOD NAL LUMBER	15 SF 446 SF 305 SF 305 SF RST LEVEL C 278 SF 278 SF 278 SF 113 - FIRST L 362 SF 257 SF 365 SF 365 SF 365 SF 365 SF 365 SF 112 SF 365 SF 112 SF 243 SF	AREA OFFSET NEW WAREA OFFSET NEW	FLOORING ALL TAKEO W WALL TA	TAKEOFF LIN 57.990 LF 57.990 LF 57.990 LF 57.990 LF 109.755 LF 11.969 LF 57.990 LF 3.359 LF 50.401 LF 50.401 LF 50.401 LF 50.401 LF 50.401 LF 50.401 LF	COMMENTS IEAR FOOTAGE	
BRICK PAVER H DECKING FINIS FLOOR SHEATH WOOD FINISH F MATER FLOOR SHEATH WOOD FINISH F MATER 1/2" WALL SHEA 2X4 DIMENSION 2X6 DIMENSION EXTERIOR SIDII GYPSUM WALL STONE 01 VAPOR RETARE MATER 1/2" WALL SHEA 2X4 DIMENSION EXTERIOR SIDII GYPSUM WALL STONE 01 VAPOR RETARE MATER 1/2" WALL SHEA 2X4 DIMENSION 2X6 DIMENSION AIR FILTRATION EXTERIOR SIDII GYPSUM WALL VAPOR RETARE	RIAL NAME HERRINGBONE H HING PLYWOOD FLOOR A113 - FI RIAL NAME HING PLYWOOD FLOOR ARIAL NAME ATHING PLYWOOD NAL LUMBER	15 SF 446 SF 305 SF 305 SF RST LEVEL C 278 SF 278 SF 278 SF 113 - FIRST L 362 SF 257 SF 365 SF 365 SF 365 SF 365 SF 365 SF 112 SF 365 SF 112 SF 243 SF	AREA OFFSET NEW WAREA OFFSET NEW WAREA AREA	FLOORING ALL TAKEO W WALL TA	TAKEOFF LIN 57.990 LF 57.990 LF 57.990 LF 57.990 LF 109.755 LF 11.969 LF 57.990 LF 3.359 LF 50.401 LF 50.401 LF 50.401 LF 50.401 LF 50.401 LF 50.401 LF	COMMENTS IEAR FOOTAGE	
BRICK PAVER H DECKING FINIS FLOOR SHEATH WOOD FINISH F MATER FLOOR SHEATH WOOD FINISH F MATER 1/2" WALL SHEA 2X4 DIMENSION 2X6 DIMENSION AIR FILTRATION EXTERIOR SIDII GYPSUM WALL STONE 01 VAPOR RETARD MATER 1/2" WALL SHEA 2X4 DIMENSION AIR FILTRATION EXTERIOR SIDII GYPSUM WALL STONE 01 VAPOR RETARD MATER 1/2" WALL SHEA 2X4 DIMENSION 2X6 DIMENSION AIR FILTRATION EXTERIOR SIDII GYPSUM WALL VAPOR RETARD	RIAL NAME HERRINGBONE H HING PLYWOOD FLOOR A113 - FI RIAL NAME HING PLYWOOD FLOOR ARIAL NAME ATHING PLYWOOD NAL LUMBER	15 SF 446 SF 305 SF 305 SF RST LEVEL C 278 SF 278 SF 278 SF 113 - FIRST L 362 SF 257 SF 365 SF 365 SF 365 SF 365 SF 365 SF 112 SF 365 SF 112 SF 243 SF	AREA OFFSET NEW WAREA OFFSET NEW WAREA OFFSET NEW WAREA VEL NEW CEI	FLOORING ALL TAKEO W WALL TA	TAKEOFF LIN 57.990 LF 57.990 LF 57.990 LF 57.990 LF 109.755 LF 11.969 LF 57.990 LF 3.359 LF 50.401 LF 50.401 LF 50.401 LF 50.401 LF 50.401 LF 50.401 LF	IEAR FOOTAGE	
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BRICK PAVER H DECKING FINIS FLOOR SHEATH WOOD FINISH F MATER FLOOR SHEATH WOOD FINISH F MATER 1/2" WALL SHEA 2X4 DIMENSION 2X6 DIMENSION EXTERIOR SIDII GYPSUM WALL STONE 01 VAPOR RETARD MATER 1/2" WALL SHEA 2X4 DIMENSION EXTERIOR SIDII GYPSUM WALL STONE 01 VAPOR RETARD MATER 1/2" WALL SHEA 2X4 DIMENSION EXTERIOR SIDII GYPSUM WALL VAPOR RETARD MATER GYPSUM WALL VAPOR RETARD	RIAL NAME HERRINGBONE H HING PLYWOOD FLOOR A113 - FI RIAL NAME HING PLYWOOD FLOOR ARIAL NAME ATHING PLYWOOD NAL LUMBER	15 SF 446 SF 305 SF 305 SF RST LEVEL C 278 SF 278 SF 278 SF 278 SF 365 SF 243 SF	AREA OFFSET NEW WAREA OFFSET NEW AREA VEL NEW CEI AREA	FLOORING ALL TAKEO W WALL TA	TAKEOFF LIN 57.990 LF 57.990 LF 57.990 LF 57.990 LF 109.755 LF 11.969 LF 57.990 LF 57.990 LF 50.401 LF	IEAR FOOTAGE	



MC3 DESIGN 1308 VINCENT PLACE

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DRAWN BY:

JOHN MCKENNA, AIA, NCARB ARCHITECT

1308 VINCENT PLACE MCLEAN, VA 22101

SEAL

CODE

2018 VIRGINIA RESIDENTIAL CODE (IRC)

PROJECT

COE RESIDENCE

2725 23RD RD N ARLINGTON, VA 22201

REVISIONS NO. DESCRIPTION DATE

SHEET TITLE

PROPOSED FIRST LEVEL PLAN

SCALE 1/4" = 1'-0" DATE 02.16.2024

SHEET NO.

DOOR NUMBER	HEADER HEIGHT	WIDTH
D26	80	36
D34	96	36
D35	80	36
D37	80	30
D38	80	30
D39	80	36
D40	80	36
D41	80	60
D42	80	60

A114 - SECOND LEVEL OFFSET NEW DOOR SCHEDULE								
DOOR NUMBER	HEADER HEIGHT	WIDTH						
D27	80	33						
D31	84	36						
D32	80	30						
D33	80	30						

TOTAL: 4			
		_	

LABEL	WIDTH	HEIGHT	SILL HEIGHT	HEADER HEIGHT
W44	32	84	-6	78
W49	36	84	44	128
W50	36	84	44	128
W55	36	84	12	96
W56	36	84	12	96
N57	36	84	12	96
N58	36	84	-6	78
W59	36	84	-6	78
W60	36	84	-6	78
W61	36	35	43	78
N62	36	35	43	78
W68	36	84	12	96
W69	36	84	12	96
W80	32	84	-6	78

	A114 - SECONI	D LEVEL OFFSET NEW	WINDOW SCHEDULE	
LABEL	WIDTH	HEIGHT	SILL HEIGHT	HEADER HEIGHT
W45	36	84	12	96
W46	36	84	12	96
W47	36	84	12	96
W52	35	35	55	90
W53	35	35	55	90
W54	35	35	55	90
W67	36	66	12	78
W81	34	54	44	97
W82	34	54	44	97
\ \ \\\\\\\\\\\\\\\\\\\\\\\\\\\\\\\\\\	3/	5.1	11	07

TOTAL:	10

A114 -	SECOND LEVEL NEW FLOORING T	AKEOFF	

MATERIAL NAME	AREA	COMMENTS
FLOOR SHEATHING PLYWOOD	272 SF	
WOOD FINISH FLOOR	272 SF	

A114 - SECOND LEVEL OFFSET NEW FLOORING TAKEOFF

MATERIAL NAME	AREA	COMMENTS
FLOOR SHEATHING PLYWOOD	506 SF	
WOOD FINISH FLOOR	506 SF	

A114 - SECOND LEVEL NEW WALL TAKEOFF

MATERIAL NAME	AREA	LINEAR FOOTAGE
1/2" WALL SHEATHING PLYWOOD	727 SF	101.702 LF
2X4 DIMENSIONAL LUMBER	701 SF	90.033 LF
2X6 DIMENSIONAL LUMBER	1012 SF	134.349 LF
AIR FILTRATION BARRIER	735 SF	101.702 LF
EXTERIOR SIDING	726 SF	101.702 LF
GYPSUM WALL BOARD 1/2"	2691 SF	224.382 LF
SHOWER GLASS	27 SF	5.396 LF
VAPOR RETARDER	735 SF	101.702 LF

A114 SECOND LEVEL OFFSET NEW WALL TAKEOFF

A114 - SECOND LEVEL OFFSET NEW WALL TAKEOFF		
MATERIAL NAME	AREA	LINEAR FOOTAGE
1/2" WALL SHEATHING PLYWOOD	251 SF	33.630 LF
2X4 DIMENSIONAL LUMBER	243 SF	27.018 LF
2X6 DIMENSIONAL LUMBER	370 SF	46.756 LF
AIR FILTRATION BARRIER	252 SF	33.630 LF
EXTERIOR SIDING	252 SF	33.630 LF
GYPSUM WALL BOARD 1/2"	970 SF	73.775 LF
SHOWER GLASS	94 SF	11.677 LF
VAPOR RETARDER	252 SF	33.630 LF





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2725 23RD RD N ARLINGTON, VA 22201

REVISIONS

NO.	DESCRIPTION	DATE

SHEET TITLE

PROPOSED SECOND LEVEL PLAN

SCALE 1/4" = 1'-0" 02.16.2024 DATE

SHEET NO.

11'-2 7/8" 28'-3 3/8" 14'-7 1/4" 10'-2 1/2" 26'-5 7/8" 13'-6 7/8" 7" / 12" 7" / 12" 5" / 12" 8'-2 1/8" 15'-0 7/8" 7" / 12" 7" / 12" 27'-10 1/4" 1 04 - PROPOSED ROOF PLAN 1/4" = 1'-0"

A115 - NEW ROOF AND CEILING TAKEOFF

MATERIAL NAME
AREA
COMMENTS

ASPHALT SHINGLES
1533 SF
GYPSUM WALL BOARD 1/2"
1526 SF

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NO. DESCRIPTION DATE

SHEET TITLE


PROPOSED ROOF PLAN

SCALE 1/4" = 1'-0"

DATE 02.16.2024

SHEET NO.

Δ115

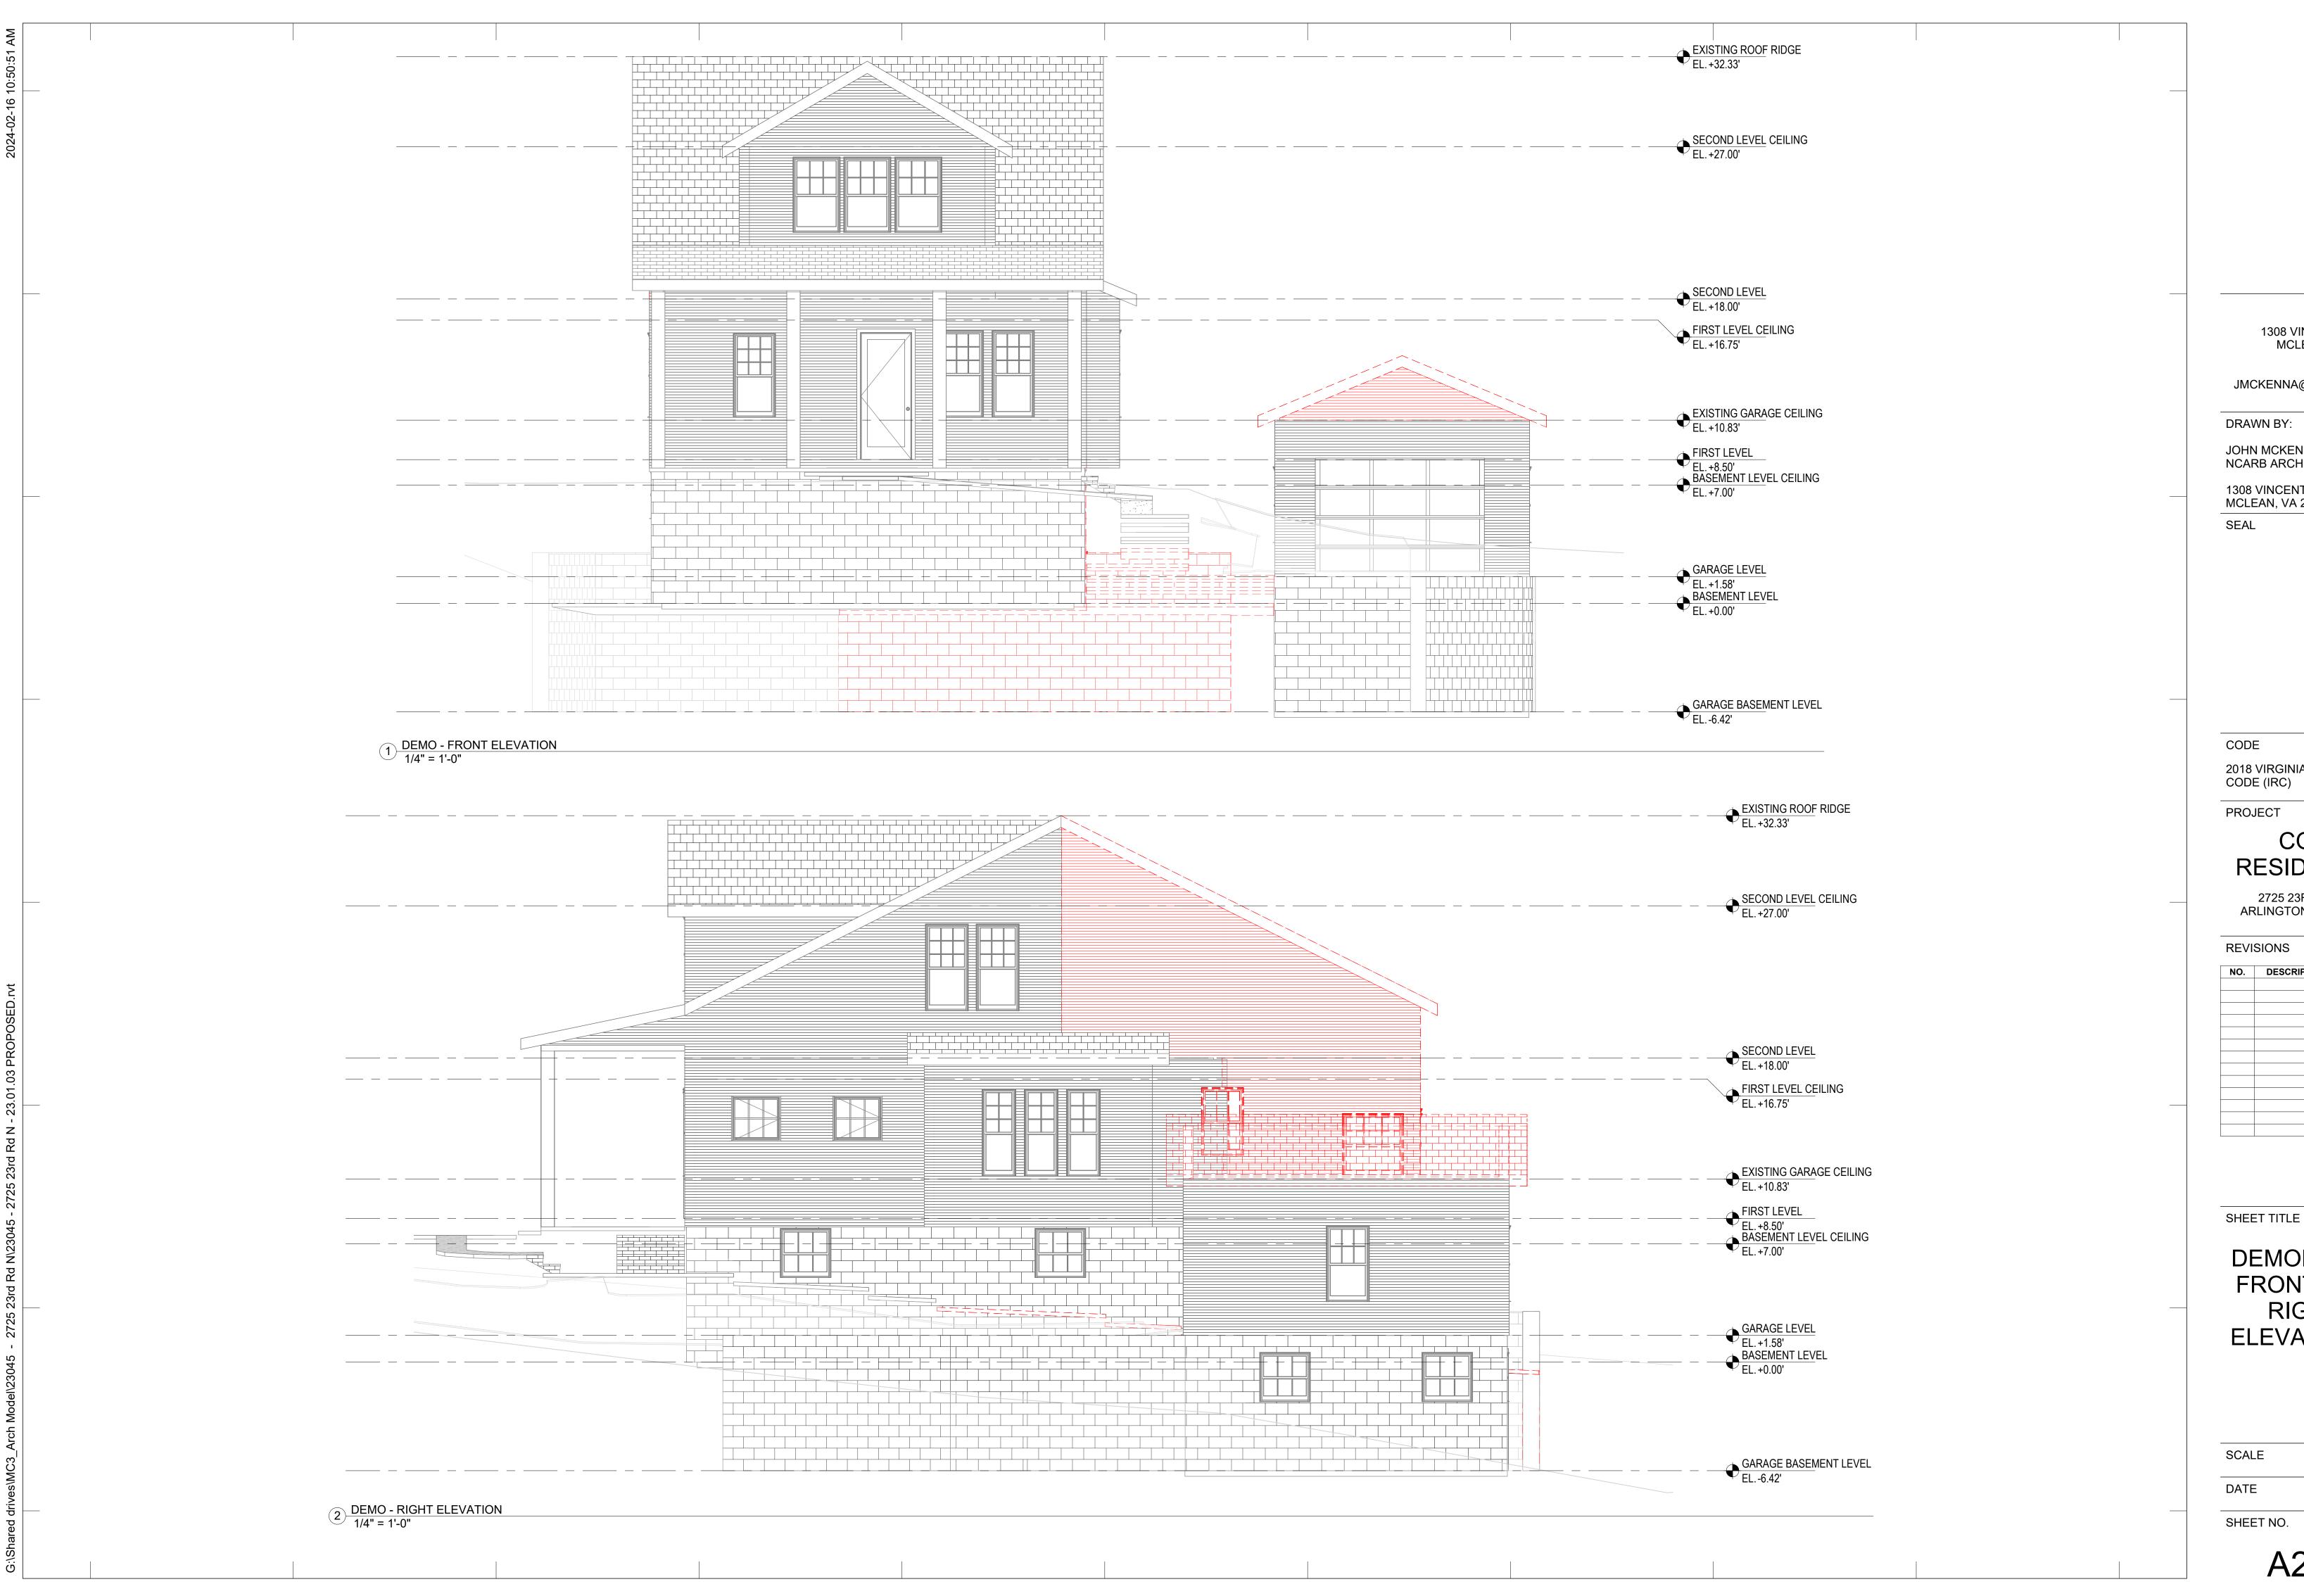



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COE RESIDENCE


2725 23RD RD N ARLINGTON, VA 22201

NO.	DESCRIPTION	DATE

DEMOLITION FRONT AND **RIGHT ELEVATIONS**

1/4" = 1'-0"

02.16.2024

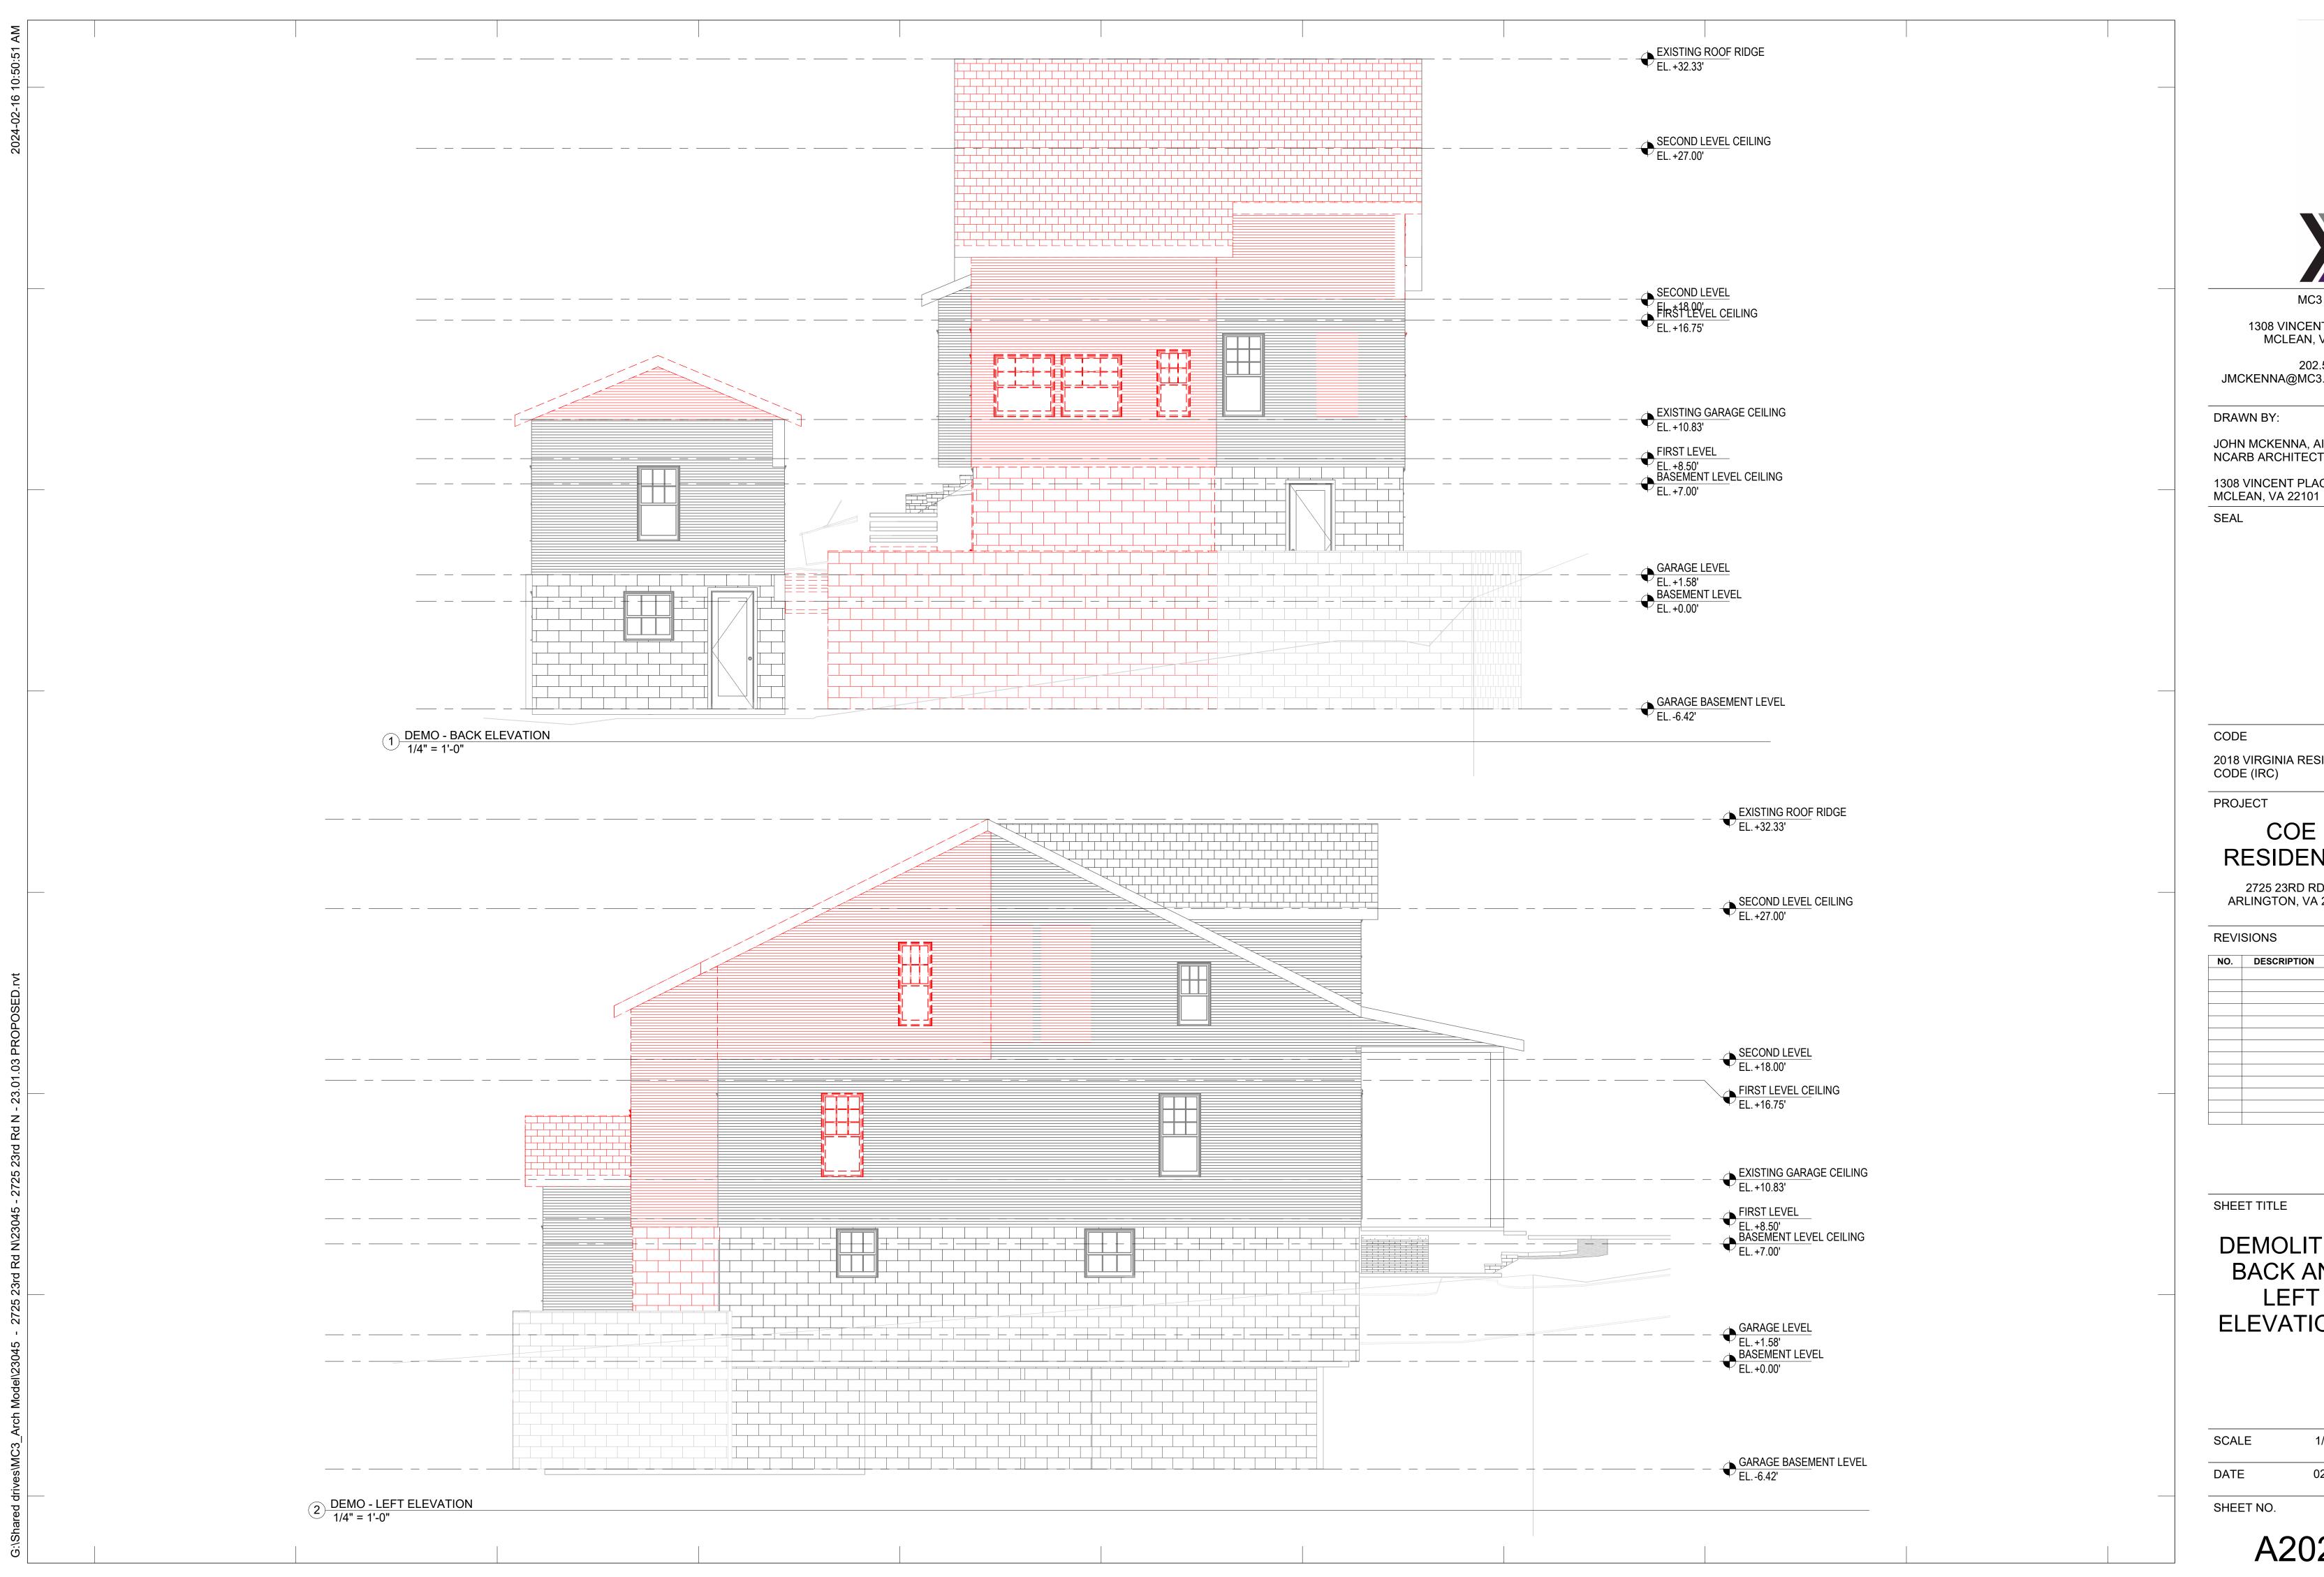



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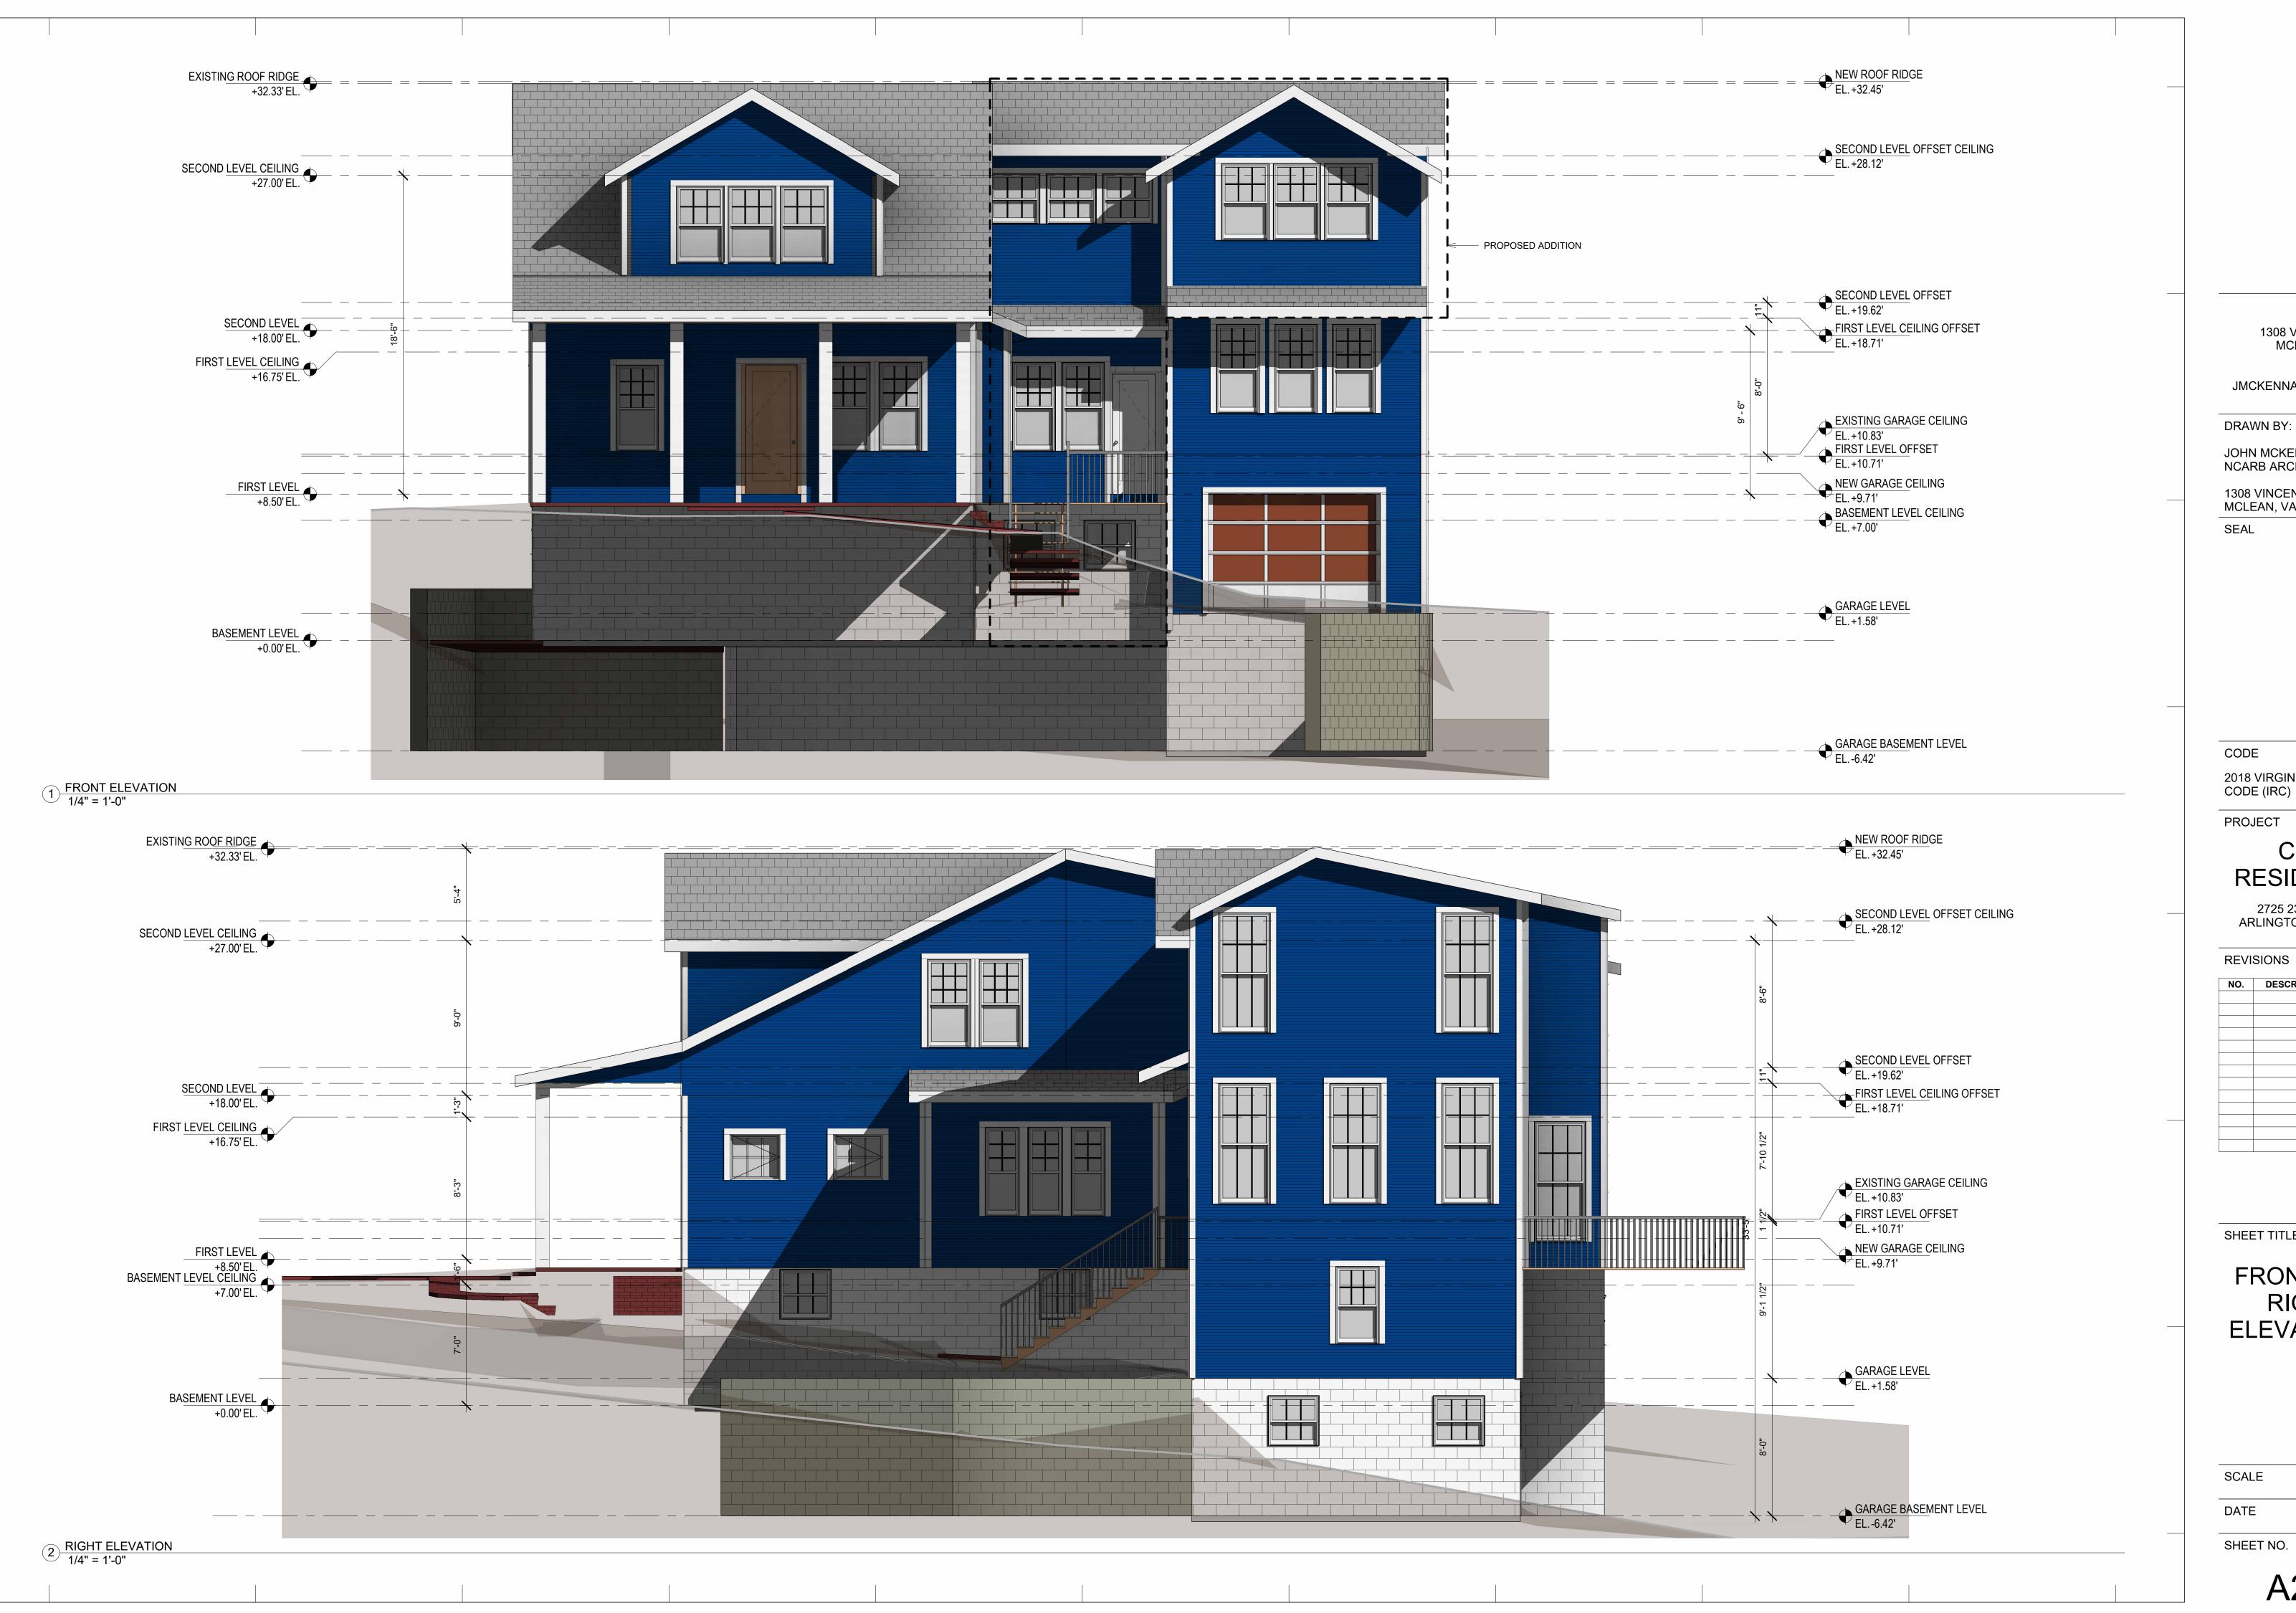
RESIDENCE

2725 23RD RD N ARLINGTON, VA 22201

NO.	DESCRIPTION	DATE

DEMOLITION BACK AND LEFT **ELEVATIONS**

1/4" = 1'-0" 02.16.2024





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RESIDENCE

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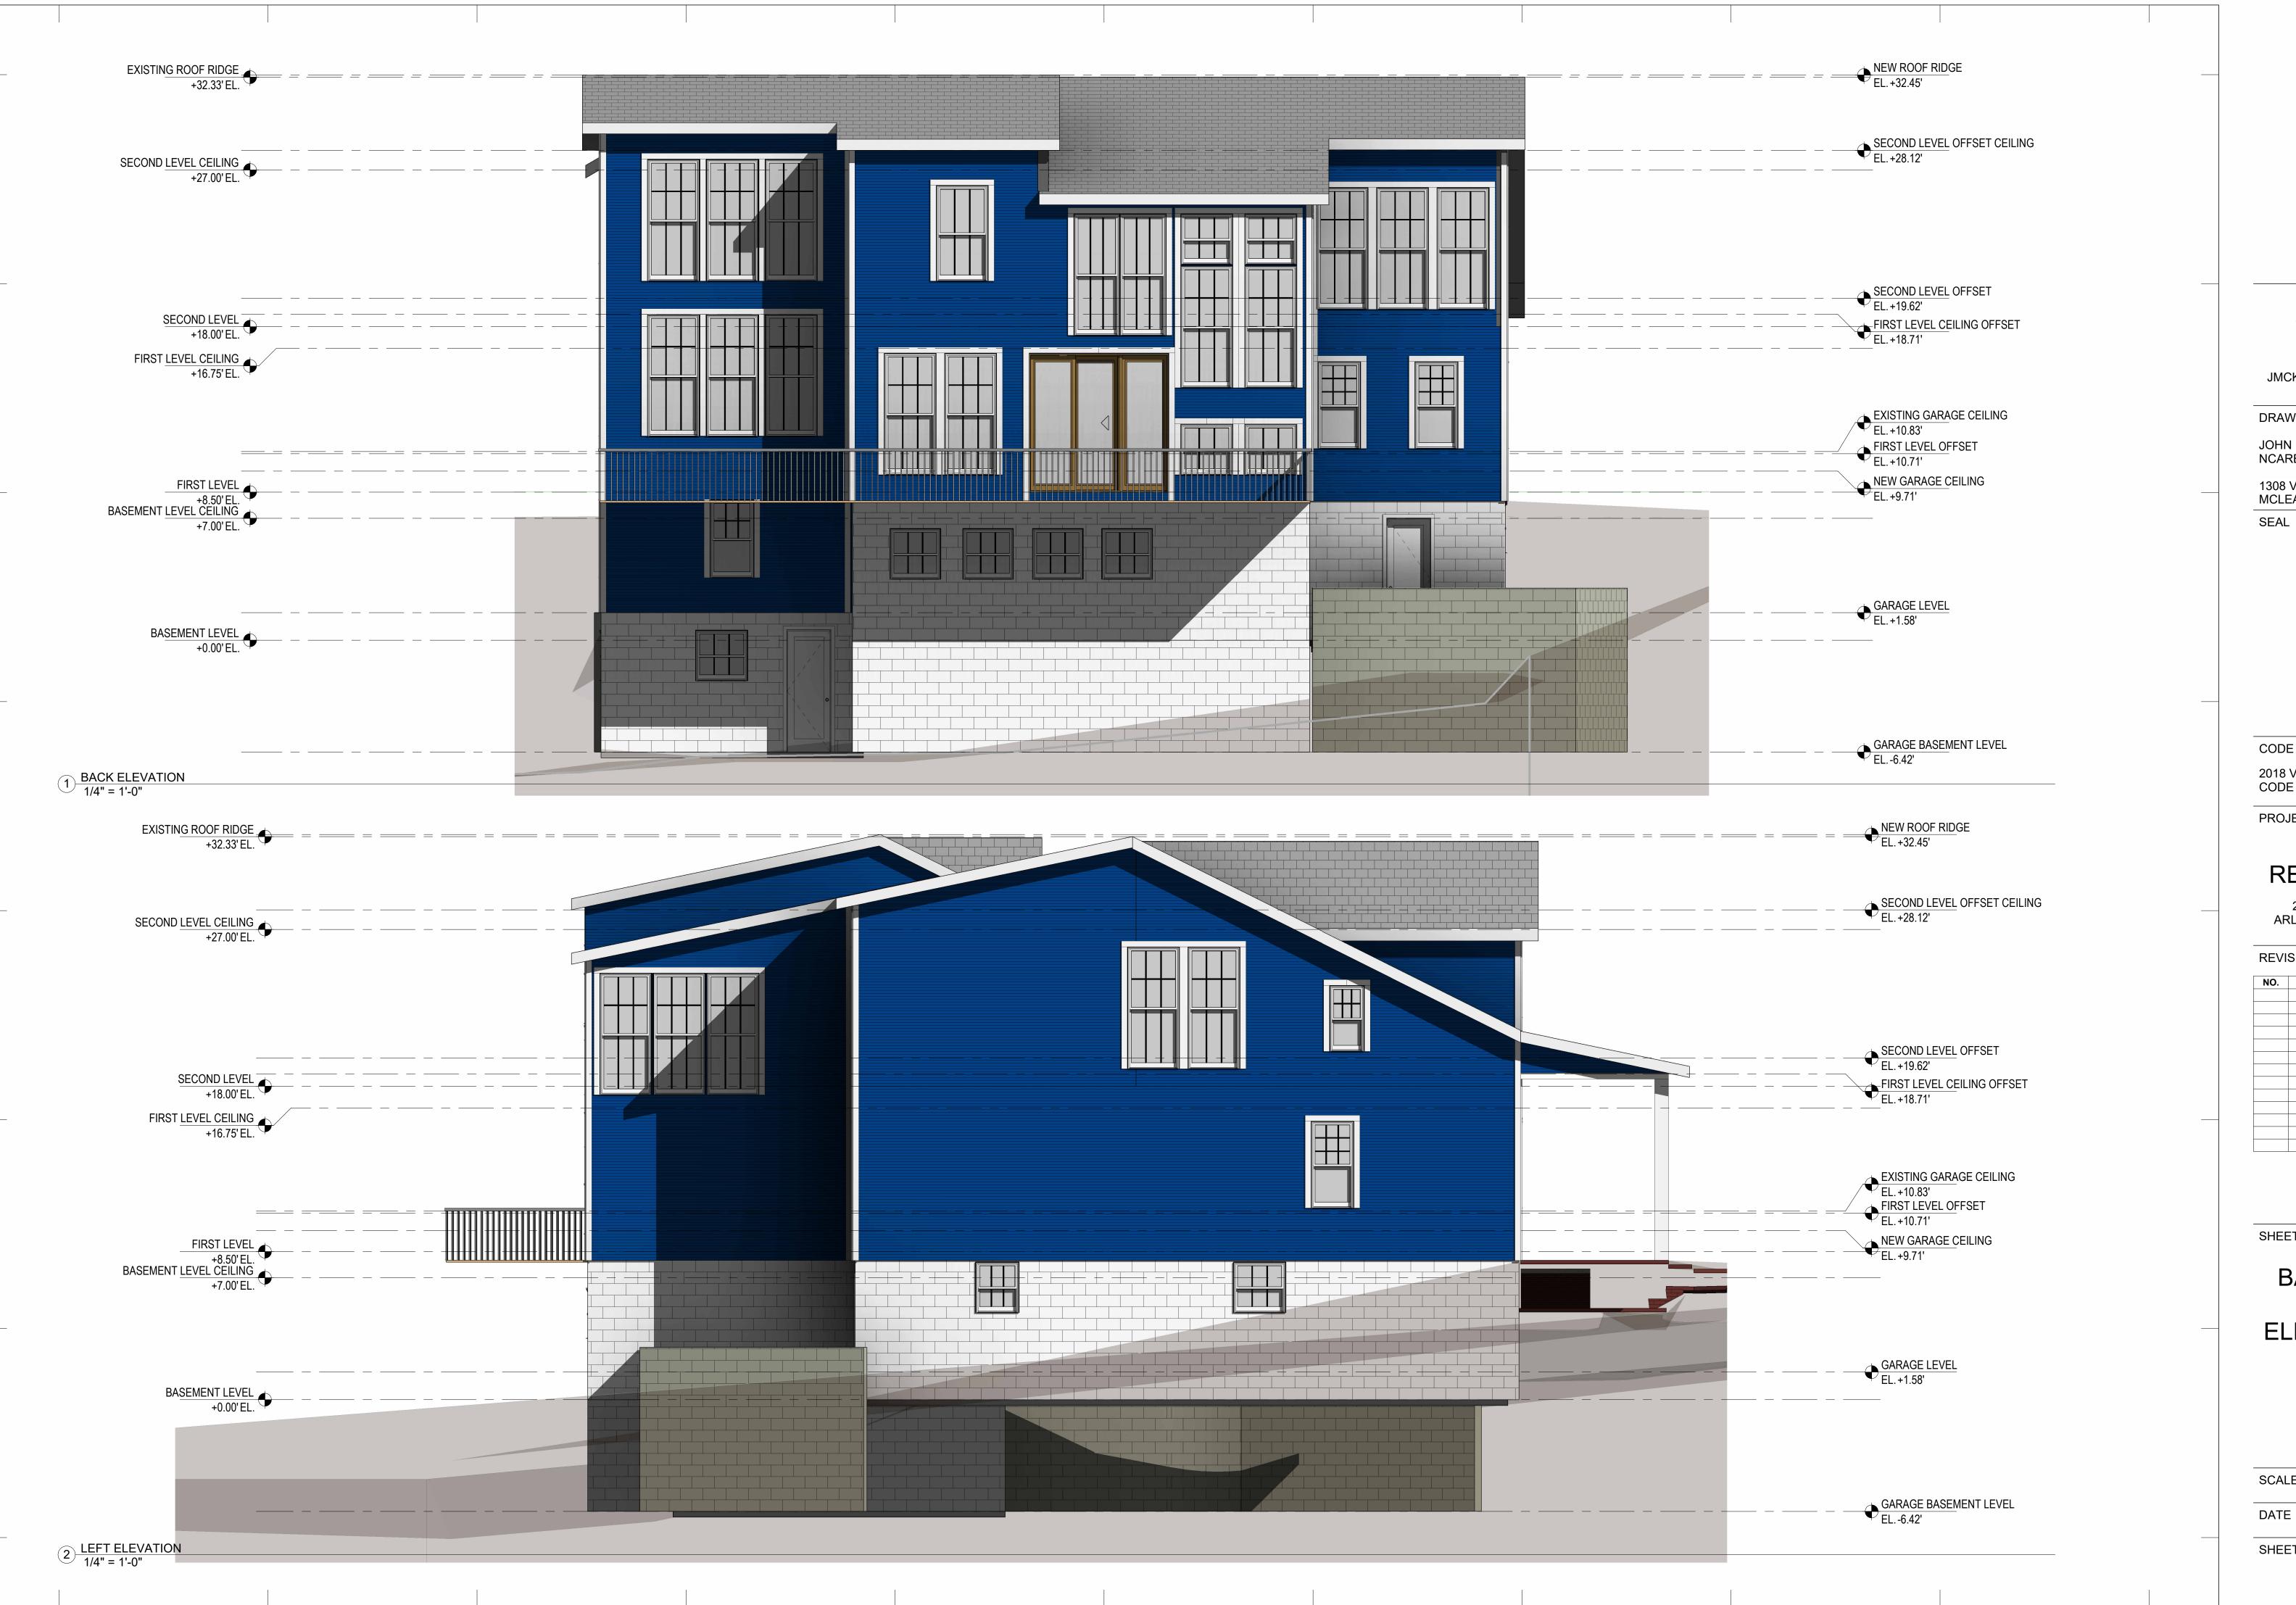
NO. DESCRIPTION DATE

SHEET TITLE

FRONT AND RIGHT **ELEVATIONS**

1/4" = 1'-0" 02.16.2024

SHEET NO.





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COE RESIDENCE

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REVISIONS

NO.	DESCRIPTION	DATE

SHEET TITLE

BACK AND LEFT **ELEVATIONS**

SCALE 1/4" = 1'-0" 02.16.2024

SHEET NO.

2 PROPOSED SECTION 01 1/4" = 1'-0"



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RESIDENCE

2725 23RD RD N ARLINGTON, VA 22201

REVISIONS

NO.	DESCRIPTION	DATE

SHEET TITLE

SECTION 01

SCALE 1/4" = 1'-0" DATE 02.16.2024

SHEET NO.

		A4	101 - COMPLETE EXISTING T	O DEMO DOOR SCHEDULI	Ξ
DOOR NUMBER	HEADER HEIGHT	WIDTH	LEVEL	CREATED	DEMO
D1	80	26	FIRST LEVEL	EXISTING	NEW CONSTRUCTION
D2	77	24	FIRST LEVEL	EXISTING	NEW CONSTRUCTION
D3	0	84	FIRST LEVEL	EXISTING	NEW CONSTRUCTION
D5	0	0	FIRST LEVEL	EXISTING	NEW CONSTRUCTION
D6	0	0	FIRST LEVEL	EXISTING	NEW CONSTRUCTION
D7	77	24	FIRST LEVEL	EXISTING	NEW CONSTRUCTION
D8	80	30	FIRST LEVEL	EXISTING	NEW CONSTRUCTION
D9	0	0	FIRST LEVEL	EXISTING	NEW CONSTRUCTION
D11	0	0	FIRST LEVEL	EXISTING	NEW CONSTRUCTION
D12	80	30	SECOND LEVEL	EXISTING	NEW CONSTRUCTION
D13	80	28	SECOND LEVEL	EXISTING	NEW CONSTRUCTION
D14	96	60	SECOND LEVEL	EXISTING	NEW CONSTRUCTION
D15	77	24	SECOND LEVEL	EXISTING	NEW CONSTRUCTION
D17	0	0	SECOND LEVEL	EXISTING	NEW CONSTRUCTION
D19	84	30	BASEMENT LEVEL	EXISTING	NEW CONSTRUCTION
D25	80	36	SECOND LEVEL	EXISTING	NEW CONSTRUCTION
D44	77	24	FIRST LEVEL	EXISTING	NEW CONSTRUCTION
TOTAL: 17					
		A40	01 - COMPLETE EXISTING TO	REMAIN DOOR SCHEDUL	E
DOOR NUMBER	HEADER HEIGHT	WIDTH	LEVEL	CREATED	DEMO
D4	0	0	FIRST LEVEL	EXISTING	None
D10	90	36	FIRST LEVEL	EXISTING	None
D16	77	24	SECOND LEVEL	EXISTING	None
- 40		100	0.10.10.10.10.10.10.10.10.10.10.10.10.10	=> (10=1) 10	

NUMBER	HEIGHT	WIDTH	LEVEL	CREATED	DEMO
D4	0	0	FIRST LEVEL	EXISTING	None
D10	90	36	FIRST LEVEL	EXISTING	None
D16	77	24	SECOND LEVEL	EXISTING	None
D18	84	120	GARAGE LEVEL	EXISTING	None
D20	84	30	GARAGE BASEMENT LEVEL	EXISTING	None
D21	84	30	BASEMENT LEVEL	EXISTING	None
TOTAL: 6			A401 - COMPLETE NEW	DOOR SCHEDULE	
DOOR NUMBER	HEADER HEIGHT	WIDTH	LEVEL	CREATED	N/A
D22	84	30	FIRST LEVEL	NEW CONSTRUCTION	None
D23	96	96	FIRST LEVEL	NEW CONSTRUCTION	None
D24	80	28	BASEMENT LEVEL	NEW CONSTRUCTION	None
D26	80	36	SECOND LEVEL	NEW CONSTRUCTION	None
D27	80	33	SECOND LEVEL OFFSET	NEW CONSTRUCTION	None
D28	84	30	FIRST LEVEL	NEW CONSTRUCTION	None
D29	80	30	FIRST LEVEL	NEW CONSTRUCTION	None
D30	96	90	FIRST LEVEL	NEW CONSTRUCTION	None
D31	84	36	SECOND LEVEL OFFSET	NEW CONSTRUCTION	None
D32	80	30	SECOND LEVEL OFFSET	NEW CONSTRUCTION	None
D33	80	30	SECOND LEVEL OFFSET	NEW CONSTRUCTION	None
D34	96	36	SECOND LEVEL	NEW CONSTRUCTION	None
D35	80	36	SECOND LEVEL	NEW CONSTRUCTION	None
D36	80	28	BASEMENT LEVEL	NEW CONSTRUCTION	None
D37	80	30	SECOND LEVEL	NEW CONSTRUCTION	None
D38	80	30	SECOND LEVEL	NEW CONSTRUCTION	None
D39	80	36	SECOND LEVEL	NEW CONSTRUCTION	None
D40	80	36	SECOND LEVEL	NEW CONSTRUCTION	None
D41	80	60	SECOND LEVEL	NEW CONSTRUCTION	None
D42	80	60	SECOND LEVEL	NEW CONSTRUCTION	None
TOTAL: 20					

		A4	01 - COMPLE	ETE EXISTIN	IG TO DEMO WINDOW SCHEDU	JLE	
LABEL	WIDTH	HEIGHT	SILL HEIGHT	HEADER HEIGHT	LEVEL	CREATED	DEMO
W1	30	60	30	90	FIRST LEVEL	EXISTING	NEW CONSTRUCTION
W8	44	45	30	75	FIRST LEVEL	EXISTING	NEW CONSTRUCTION
W9	44	45	30	75	FIRST LEVEL	EXISTING	NEW CONSTRUCTION
W10	24	48	30	78	FIRST LEVEL	EXISTING	NEW CONSTRUCTION
W11	30	48	45	93	FIRST LEVEL	EXISTING	NEW CONSTRUCTION
W12	24	24	36	60	FIRST LEVEL	EXISTING	NEW CONSTRUCTION
W16	44	45	30	75	FIRST LEVEL	EXISTING	NEW CONSTRUCTION
W22	24	60	24	84	SECOND LEVEL	EXISTING	NEW CONSTRUCTION
TOTAL: 8							

		A40	1 - COMPLE	TE EXISTING	G TO REMAIN WINDOW SCHE	DULE	
LABEL	WIDTH	HEIGHT	SILL HEIGHT	HEADER HEIGHT	LEVEL	CREATED	DEMO
W2	35	32	55	87	FIRST LEVEL	EXISTING	None
W3	30	60	30	90	FIRST LEVEL	EXISTING	None
W4	30	62	30	92	FIRST LEVEL	EXISTING	None
W5	30	62	30	92	FIRST LEVEL	EXISTING	None
W6	30	60	30	90	FIRST LEVEL	EXISTING	None
W7	30	60	30	90	FIRST LEVEL	EXISTING	None
W13	24	62	30	92	FIRST LEVEL	EXISTING	None
W14	24	62	30	92	FIRST LEVEL	EXISTING	None
W15	24	62	30	92	FIRST LEVEL	EXISTING	None
W17	34	54	47	101	SECOND LEVEL	EXISTING	None
W18	34	54	47	101	SECOND LEVEL	EXISTING	None
W19	34	54	47	101	SECOND LEVEL	EXISTING	None
W20	31	62	34	95	SECOND LEVEL	EXISTING	None
W21	31	62	34	95	SECOND LEVEL	EXISTING	None
W23	24	46	24	70	SECOND LEVEL	EXISTING	None
W25	31	54	24	78	GARAGE LEVEL	EXISTING	None
W26	31	54	24	78	GARAGE LEVEL	EXISTING	None
W27	36	35	60	95	BASEMENT LEVEL	EXISTING	None
W28	36	35	60	95	BASEMENT LEVEL	EXISTING	None
W29	36	35	60	95	BASEMENT LEVEL	EXISTING	None
W30	30	35	60	95	BASEMENT LEVEL	EXISTING	None
W31	30	35	48	83	BASEMENT LEVEL	EXISTING	None
W32	36	35	49	84	GARAGE BASEMENT LEVEL	EXISTING	None
W33	36	35	49	84	GARAGE BASEMENT LEVEL	EXISTING	None
W34	36	35	49	84	GARAGE BASEMENT LEVEL	EXISTING	None
W42	35	32	55	87	FIRST LEVEL	EXISTING	None
W87	31	54	24	78	GARAGE LEVEL	EXISTING	None
TOTAL: 27							

		**10111	IILIOIII		11210111		OI (L) (I LD	DEIVIO
N	W24	36	84	12	96	FIRST LEVEL OFFSET	NEW CONSTRUCTION	None
N	W35	36	84	12	96	FIRST LEVEL	NEW CONSTRUCTION	None
N	W36	36	84	12	96	FIRST LEVEL	NEW CONSTRUCTION	None
N	W37	30	62	30	92	FIRST LEVEL	NEW CONSTRUCTION	None
N	W38	30	62	30	92	FIRST LEVEL	NEW CONSTRUCTION	None
N	W39	36	35	49	84	BASEMENT LEVEL	NEW CONSTRUCTION	None
N	W40	36	35	49	84	BASEMENT LEVEL	NEW CONSTRUCTION	None
N	W41	35	35	42	77	BASEMENT LEVEL	NEW CONSTRUCTION	None
	W43	35	35	42	77	BASEMENT LEVEL	NEW CONSTRUCTION	None
.	W44	32	84	-6	78	SECOND LEVEL	NEW CONSTRUCTION	None
	W45	36	84	12	96	SECOND LEVEL OFFSET	NEW CONSTRUCTION	None
	W46	36	84	12	96	SECOND LEVEL OFFSET	NEW CONSTRUCTION	None
	W47	36	84	12	96	SECOND LEVEL OFFSET	NEW CONSTRUCTION	None
	W49	36	84	44	128	SECOND LEVEL	NEW CONSTRUCTION	None
	W50	36	84	44	128	SECOND LEVEL	NEW CONSTRUCTION	None
'	W51	36	84	12	96	FIRST LEVEL	NEW CONSTRUCTION	None
	W52	35	35	55	90	SECOND LEVEL OFFSET	NEW CONSTRUCTION	None
	W53	35	35	55	90	SECOND LEVEL OFFSET	NEW CONSTRUCTION	None
	W54	35	35	55	90	SECOND LEVEL OFFSET	NEW CONSTRUCTION	None
	W55	36	84	12	96	SECOND LEVEL	NEW CONSTRUCTION	None
	W56	36	84	12	96	SECOND LEVEL	NEW CONSTRUCTION	None
	W57	36	84	12	96	SECOND LEVEL	NEW CONSTRUCTION	None
	W58	36	84	-6	78	SECOND LEVEL	NEW CONSTRUCTION	None
	W59	36	84	-6	78	SECOND LEVEL	NEW CONSTRUCTION	None
	W60	36	84	-6	78	SECOND LEVEL	NEW CONSTRUCTION	None
	W61	36	35	43	78	SECOND LEVEL	NEW CONSTRUCTION	None
	W62	36	35	43	78	SECOND LEVEL	NEW CONSTRUCTION	None
	W63	36	84	72	156	FIRST LEVEL	NEW CONSTRUCTION	None
	W64	36	84	72	156	FIRST LEVEL	NEW CONSTRUCTION	None
	W65	36	35	12	47	FIRST LEVEL	NEW CONSTRUCTION	None
	W66	36	35	12	47	FIRST LEVEL	NEW CONSTRUCTION	None
	W67	36	66	12	78	SECOND LEVEL OFFSET	NEW CONSTRUCTION	None
	W68	36	84	12	96	SECOND LEVEL	NEW CONSTRUCTION	None
	W69	36	84	12	96	SECOND LEVEL	NEW CONSTRUCTION	None
	W70	36	84	12	96	FIRST LEVEL OFFSET	NEW CONSTRUCTION	None
	W71	36	84	12	96	FIRST LEVEL OFFSET	NEW CONSTRUCTION	None
	W73	36	84	12	96	FIRST LEVEL OFFSET	NEW CONSTRUCTION	None
	W74	36	84	12	96	FIRST LEVEL OFFSET	NEW CONSTRUCTION	None
	W75	36	84	12	96	FIRST LEVEL OFFSET	NEW CONSTRUCTION	None
	W77	30	62	30	92	FIRST LEVEL OFFSET	NEW CONSTRUCTION	None
	W78	30	62	30	92	FIRST LEVEL OFFSET	NEW CONSTRUCTION	None
	W79	30	62	30	92	FIRST LEVEL OFFSET	NEW CONSTRUCTION	None
	W80	32	84	-6	78	SECOND LEVEL	NEW CONSTRUCTION	None
	W81	34	54	44	97	SECOND LEVEL OFFSET	NEW CONSTRUCTION	None
	W82	34	54	44	97	SECOND LEVEL OFFSET	NEW CONSTRUCTION	None
	W83	34	54	44	97	SECOND LEVEL OFFSET	NEW CONSTRUCTION	None
	W84	35	35	42	77	BASEMENT LEVEL	NEW CONSTRUCTION	None
	W85	35	35	42	77	BASEMENT LEVEL	NEW CONSTRUCTION	None
	W86	30	60	30	90	FIRST LEVEL	NEW CONSTRUCTION	
		l	I		<u> </u>		<u> </u>	

A401 - COMPLETE NEW WINDOW SCHEDULE

LEVEL

WIDTH HEIGHT HEIGHT HEIGHT

LABEL



MC3 DESIGN 1308 VINCENT PLACE MCLEAN, VA 22101

202.599.7779 JMCKENNA@MC3.DESIGN

DRAWN BY:

DEMO

CREATED

JOHN MCKENNA, AIA, NCARB ARCHITECT

1308 VINCENT PLACE MCLEAN, VA 22101

SEAL

CODE

2018 VIRGINIA RESIDENTIAL CODE (IRC)

PROJECT

COE RESIDENCE

2725 23RD RD N ARLINGTON, VA 22201

REVISIONS

NO.	DESCRIPTION	DATE

SHEET TITLE

WINDOW DOOR SCHEDULES

SCALE

DATE

SHEET NO.

02.16.2024

MATERIAL NAME	AREA	COMMENTS
BRICK PAVER HERRINGBONE	382 SF	
CONCRETE	60 SF	
02 - COMP	LETE DEMOLITION WALL MATERIA	L TAKEOFFS
MATERIAL NAME	AREA	LINEAR FOOTAGE
1/2" WALL SHEATHING PLYWOOD	835 SF	166.805 LF
2X4 DIMENSIONAL LUMBER	1073 SF	150.523 LF
2X6 DIMENSIONAL LUMBER	1282 SF	223.141 LF
AIR FILTRATION BARRIER	847 SF	166.805 LF
EXISTING RETAINING WALL	219 SF	23.208 LF
EXTERIOR SIDING	834 SF	166.805 LF
GYPSUM WALL BOARD 1/2"	3854 SF	373.664 LF
TEXTURED 8" CMU	187 SF	24.623 LF
VAPOR RETARDER	847 SF	166.805 LF
02 - COMPL	ETE DEMOLITION CEILING MATER	IAL TAKEOFF
MATERIAL NAME	AREA	COMMENT
GYPSUM WALL BOARD 1/2"	60 SF	
02 - COMF	PLETE DEMOLITION ROOF MATERIA	AL TAKEOFF
MATERIAL NAME	AREA	COMMENTS
ASPHALT SHINGLES	1023 SF	
GYPSUM WALL BOARD 1/2"	1023 SF	

MATERIAL NAME		AREA	COMMENTS
BRICK PAVER HERRINGBONE	15 SF		
CONCRETE	434 SF		
DECKING FINISH	446 SF		
FLOOR SHEATHING PLYWOOD	1362 SF		
WOOD FINISH FLOOR	1362 SF		
03 - C0	OMPLETE NE	W WALL MATERI	AL TAKEOFFS
MATERIAL NAME		AREA	LINEAR FOOTAGE
1/2" WALL SHEATHING PLYWOOD	1772 SF		283.837 LF
2X4 DIMENSIONAL LUMBER	1872 SF		275.276 LF
2X6 DIMENSIONAL LUMBER	2178 SF		329.610 LF
AIR FILTRATION BARRIER	1786 SF		283.837 LF
EXTERIOR SIDING	1773 SF		283.837 LF
GYPSUM WALL BOARD 1/2"	5966 SF		665.593 LF
SHOWER GLASS	121 SF		17.073 LF
STONE 01	112 SF		11.969 LF
TEXTURED 8" CMU	705 SF		103.592 LF
VAPOR RETARDER	1786 SF		283.837 LF
03 - CC	MPLETE NE	W CEILING MATE	RIAL TAKEOFF
MATERIAL NAME		AREA	COMMENT
GYPSUM WALL BOARD 1/2"	1799 SF		
03 - C	OMPLETE NI	EW ROOF MATER	RIAL TAKEOFF
MATERIAL NAME		AREA	COMMENTS
ASPHALT SHINGLES	1533 SF		
GYPSUM WALL BOARD 1/2"	1526 SF		

MC3 DESIG



1308 VINCENT PLACE MCLEAN, VA 22101

202.599.7779 JMCKENNA@MC3.DESIGN

DRAWN BY:

JOHN MCKENNA, AIA, NCARB ARCHITECT

1308 VINCENT PLACE MCLEAN, VA 22101

SEAL

CODE

2018 VIRGINIA RESIDENTIAL CODE (IRC)

PROJECT

COE RESIDENCE

2725 23RD RD N ARLINGTON, VA 22201

REVISIONS

NO.	DESCRIPTION	DATE

SHEET TITLE

MATERIAL TAKEOFFS

SCALE

DATE

SHEET NO.

A402

02.16.2024







6 EXTERIOR - FRONT PERSPECTIVE 02







5 EXTERIOR - BACK PERSPECTIVE 02

COE

CODE

CODE (IRC)

PROJECT

RESIDENCE 2725 23RD RD N ARLINGTON, VA 22201

2018 VIRGINIA RESIDENTIAL

MC3 DESIGN

1308 VINCENT PLACE MCLEAN, VA 22101

202.599.7779 JMCKENNA@MC3.DESIGN

DRAWN BY:

SEAL

JOHN MCKENNA, AIA, NCARB ARCHITECT

1308 VINCENT PLACE MCLEAN, VA 22101

REVISIONS

NO.	DESCRIPTION	DATE


SHEET TITLE


PROPOSED PERSPECTIVES

SCALE


DATE 02.16.2024

SHEET NO.

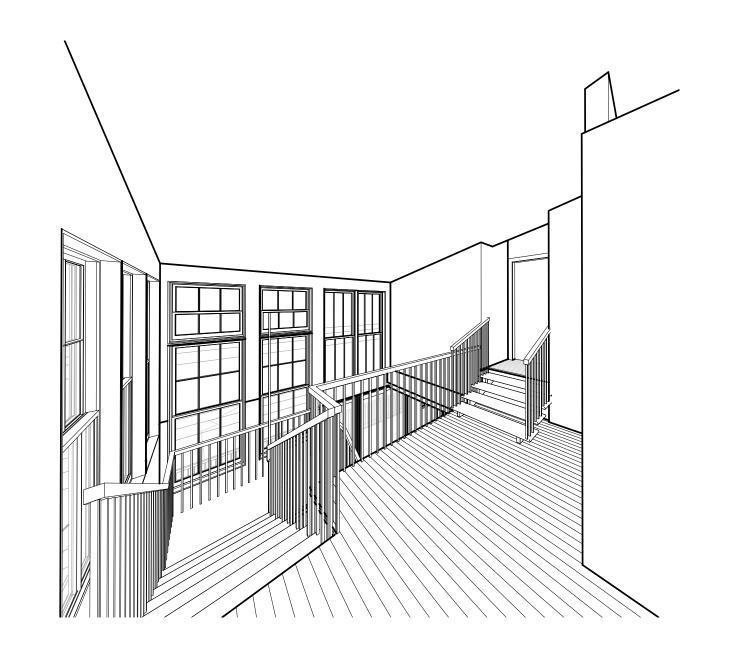


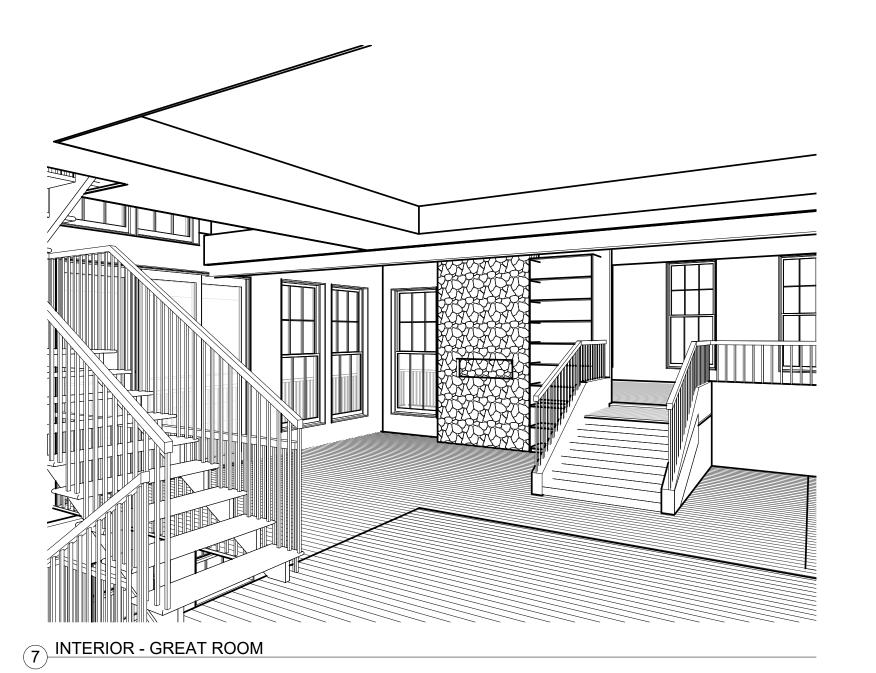


3 INTERIOR - LOFT 01

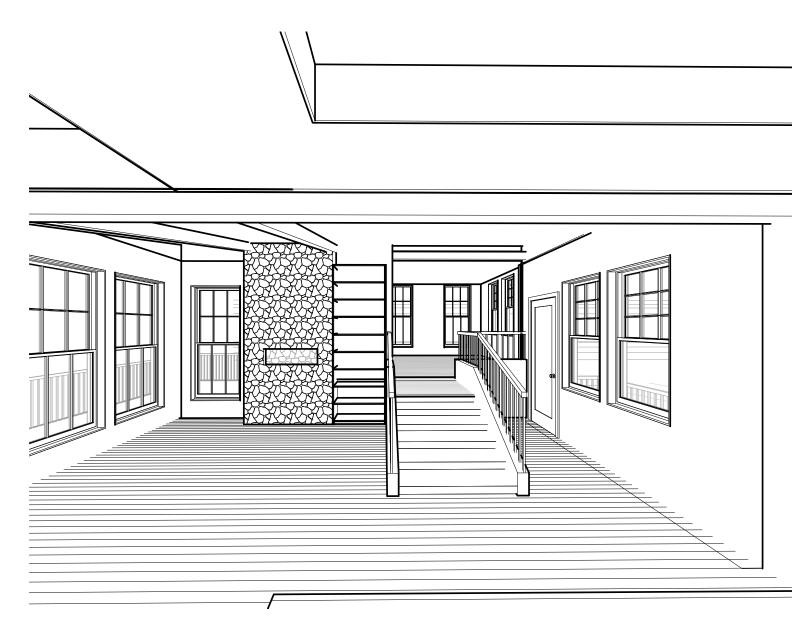


2 INTERIOR - INTO PLAY ROOM VIEW

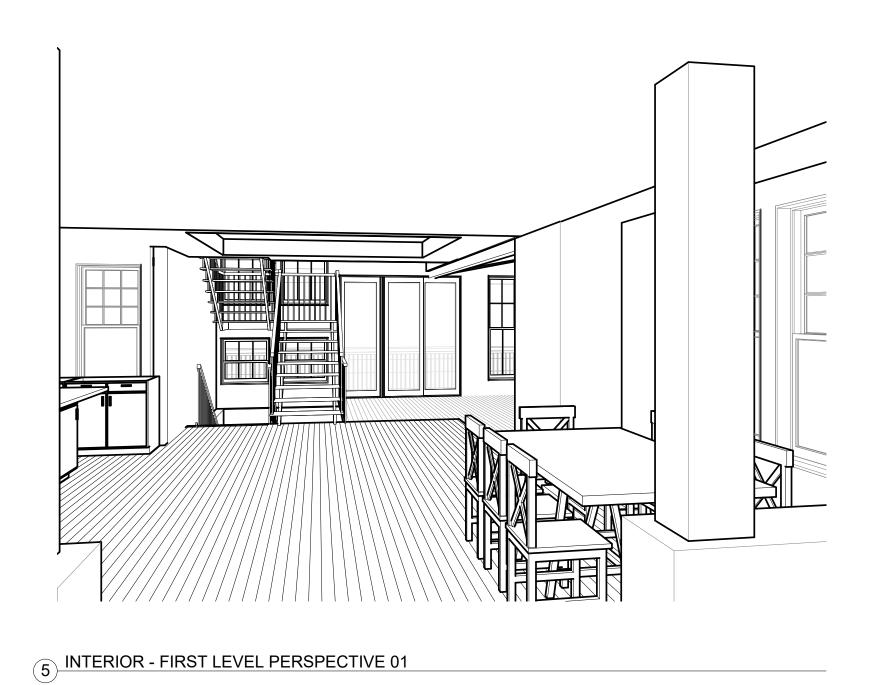


8 INTERIOR - PLAY ROOM

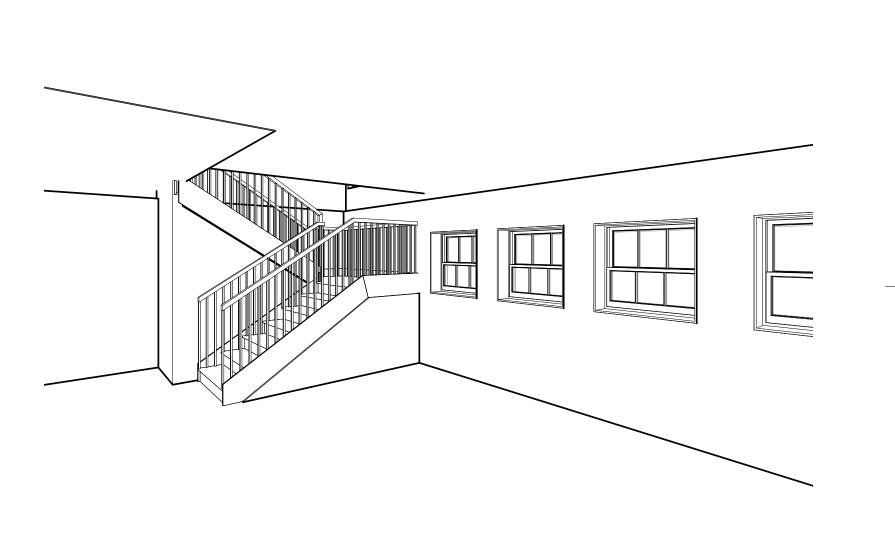

6 INTERIOR - BASEMENT DEN STAIRS 01

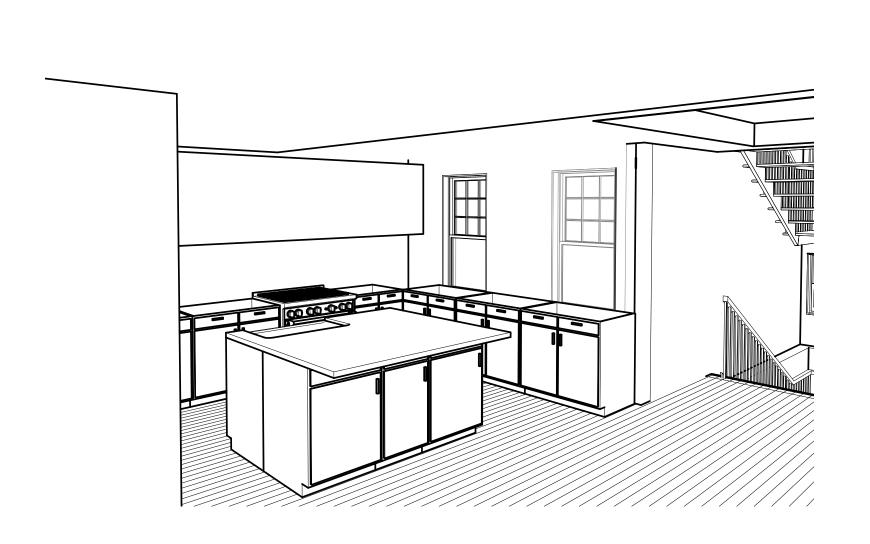

4 INTERIOR - KITCHEN

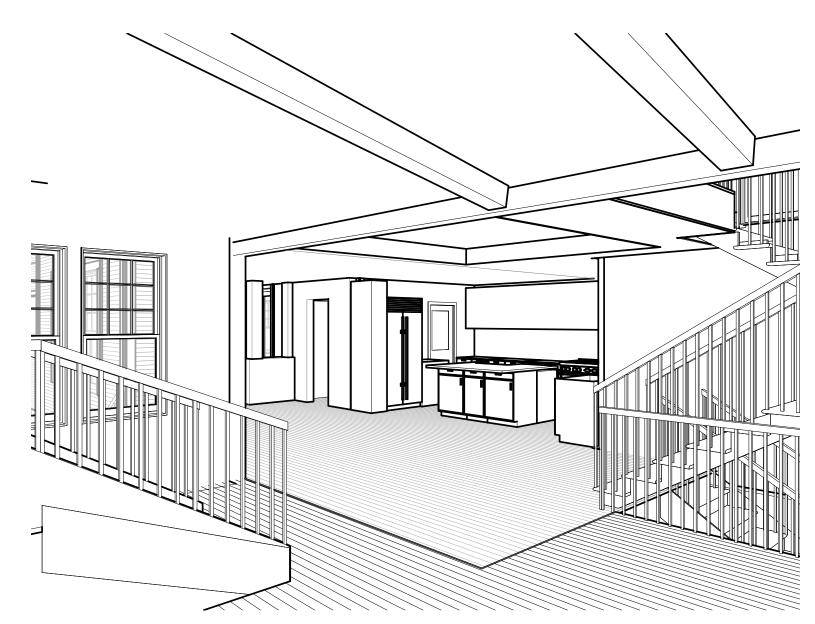

9 INTERIOR - GREAT ROOM 02



1308 VINCENT PLACE MCLEAN, VA 22101

202.599.7779 JMCKENNA@MC3.DESIGN

DRAWN BY:

JOHN MCKENNA, AIA, NCARB ARCHITECT

1308 VINCENT PLACE MCLEAN, VA 22101

SEAL

CODE

2018 VIRGINIA RESIDENTIAL CODE (IRC)

PROJECT

COE RESIDENCE

2725 23RD RD N ARLINGTON, VA 22201

REVISIONS

NO.	DESCRIPTION	DATE

SHEET TITLE

PROPOSED INTERIOR PERSPECTIVES

SCALE

DATE 02.16.2024

SHEET NO.



How to Calculate Lot Coverage

For adopted ZOA on 11/15/05: Revised 6/2014

R-6 Districts: What is the zoning of your lot? Check the zoning map, or your assessment record. If your lot is zoned "R-6," go to #1.

Max Lot Coverage	Max Lot Coverage w/ Front Porch	Max Lot Coverage w/ Rear Detached Garage	Max Lot Coverage w/ Front Porch and Detached Rear Garage	Max Main Building Footprint Coverage	Max Main Building Footprint Coverage w/ Front Porch	Main Building Footprint Cap	Main Building Footprint Cap w/ Front Porch
40%	43%	45%	48%	30%	33%	2,520 sq. ft.	2,772 sq. ft.

Your property must meet the requirements for the lot and for the house (main building). The main building footprint shall include all parts of a main building that rest, directly or indirectly, on the ground, including, by way of illustration and not by limitation, attached garages, bay and oriel windows with floor space, chimneys, porches, decks with floor heights that are four feet or higher above finished grade, balconies with horizontal projections that are four feet or more, and covered breezeways connected to a main building. Total lot coverage includes the footprint of the main building, and the total footprints of all accessory buildings that have either footprints larger than 150 sq. ft., or heights of two stories or more, driveways and parking pads, including, without limitation, any unpaved center strip or other portion of the driveway and any lot area regularly used for maneuvering or parking of vehicles, whether paved or unpaved, patios that are eight inches or higher above finished grade, decks that are four feet or higher from finished grade that are not attached to a main building, gazebos and pergolas, whether enclosed or unenclosed and with or without foundations, stoops and landings (including those associated with stairs) that are four feet or higher above finished grade, and in-ground swimming pools.

- #1 How many square feet is your lot?
- #2 How many square feet is the footprint of your main building?
 - -Main dwelling
 - -Attached garages
 - -Bay or oriel windows with floor space
 - -Chimneys
 - -Porches
 - -Decks that are four feet or higher above finished grade
 - -Balconies with horizontal projections that are four feet or more
 - -Covered breezeways connected to a main building

Do you have a front porch with a footprint of at least 60 sq. ft.? If so, you are permitted to cover 2,772 sq. ft. or 33% of the lot.

Is your front porch footprint less than 60 sq. ft.? If so, you are permitted to cover 2,520 sq. ft. or 30% of the lot.

Add all items in #2.

Divide the main building footprint (#2) by your lot size (#1) and multiply by 100. If your lot is smaller than 6,000 sq. ft. divide (#2) by the required lot size (6,000 sq. ft.) as permitted by Section 3.2.5.A.2.

28,651	_ sq. ft.
291 34 0 217 402 43 0	_ sq. ft. _ sq. ft.
Subtotal =2,436	_ sq. ft.
YES / NO	
YES /NO	
Main Building Footprint = 2,436 sq. ft.	=
Main Building Footprint (Coverage=



How to Calculate Lot Coverage

For adopted ZOA on 11/15/05: Revised 6/2014

- #3 What is your total lot coverage?
 - -Main building footprint (answer for #2)
 - -Accessory buildings that have either footprints larger than 150 sq. ft., or heights of two stories or more
 - -Driveways and parking pads
 - -Patios that are eight inches or higher above finished grade
 - -Decks that are four feet or higher from finished grade that are not attached to a main building
 - -Gazebos or pergolas
 - -Stoops and landings (including those associated with stairs) that are four feet or higher above finished grade
 - -In-ground swimming pools

Do you have a front porch with a footprint of at least 60 sq. ft.? If so, you are permitted a total coverage of 43%.

Do you have a rear detached garage with a footprint of at least 150 sq. ft.?

If so, you are permitted a total coverage of 45%.

Do you have a front porch with a footprint of at least 60 sq. ft. and a detached garage with a footprint of at least 150 sq. ft.? If so, you are permitted a total coverage of 48%

If you answered no to all of the above you are permitted a total lot coverage of 40%.

Add all items in #3.

Divide the total lot coverage (#3) by your lot size (#1) and multiply by 100.

sq. ft.
N/A , , sq. ft. 849 , , sq. ft. N/A , , sq. ft.
N/A ,
Subtotal = $3,285$ sq. ft.
YES / NO
YES / NO
YES NO
Total Lot Coverage = 3,208 sq. ft. Lot Coverage Percentage = 11.5 %