
ABBREVIATIONS

A	AD ADJ AFG ALT	AREA DRAIN ADJACENT ABOVE FINISHED GRADE ALTERNATE	L	L LT LP	LENGTH LIGHT LOW POINT	DI
	ALUM APPROX	ALUMINUM APPROXIMATE	М	MAS	MASONRY	
	ARCH	ARCHITECT(URAL)	IVI	MATL MAX MECH	MATERIAL MAXIMUM MECHANICAL	
В	BC BLDG BLKG BOC	BOTTOM OF CURB BUILDING BLOCKING BACK OF CURB		MED MFR MIN MISC	MEDIUM MANUFACTURER MINIMUM MISCELLANEOUS	
	BOT BR BS	BOTTOM BOTTOM OF RAMP BOTTOM OF STAIR		MTL	METAL	S
	BW	BOTTOM OF WALL	Ν	N NIC NO	NORTH NOT IN CONTRACT NUMBER	
С	CEM CIP CJ CMU	CEMENT CAST IN PLACE CONTROL JOINT CONCRETE MASONRY UNIT		NOM NTS	NOMINAL NOT TO SCALE	Ē
	CO COL	CLEANOUT	0	OC	ON CENTER	
	CONT	CONTINUOUS CONCRETE		OD OPNG	OUTSIDE DIAMETER OPENING	
	CU FT	CUBIC FEET		OPP	OPPOSITE	
D	DD		Р	PB PERF	PLANT BED PERFORATED	D
	DE DI	DRAINAGE EASEMENT DRAIN INLET		PNL PNT	PANEL PAINT(ED)	
	DIA DIAG	DIAMETER DIAGONAL		PSI PT	POUNDS/SQUARE INCH PRESSURE TREATED	
	DIM DN	DIMENSION DOWN		POB POC	POINT OF BEGINNING POINT OF CURVATURE	
	DS DWG(S)	DOWN SPOUT DRAWING(S)		PROP	PROPOSED	Ē
Е	E	EAST	Q	QTY	QUANTITY	
	EA EJ	EACH EXPANSION JOINT	R	RAD	RADIUS	
	EL ELEC	ELEVATION ELECTRIC(AL)		REINF REQD	REINFORC(E), (ING) REQUIRED	
	EOP EQ	EDGE OF PAVEMENT EQUAL		REV	REVISION	
	EQUIP ESMT	EQUIPMENT EASEMENT		R.O.W	RIGHT OF WAY	D
	EW EXP	EACH WAY EXPANSION	S	S	SOUTH	
	EXIST EXT	EXISTING EXTERIOR		SB SCHED	SETBACK SCHEDUL(E), (ED)	
				SD SF	STORM DRAIN SQUARE FOOT, FEET	
F	FAB FDC	FABRIC FIRE DEPT. CONNECTION		SIM SQ	SIMILAR SQUARE	
	FH FN	FIRE HYDRANT FINISH		SSMH STL	SANITARY SEWER MANHOLE STEEL	<u>N</u>
	FOC	FACE OF CURB		SSTL STD	STAINLESS STEEL STANDARD	
	FT FTG	FOOT, FEET FOOTING		SUSP SW	SUSPENDED SIDEWALK	
				SYM	SYMBOL	
G	GA GAL	GAUGE GALLON	т	TOD		
	GALV GC	GALVANIZED GENERAL CONTRACTOR	I	TBD TC	TO BE DETERMINED TOP OF CURB	
	GV	GATE VALVE		THK TR	THICK(NESS) TOP OF RAMP	R
		1		TS TW	TOP OF STAIR TOP OF WALL	
Н	HDW HDWD	HARDWARE HARDWOOD		TYP	TYPICAL	
	HORZ HP	HORIZONTAL HIGH POINT	U	UE	UTILITY EASEMENT	
	HT	HEIGHT	0	U.N.O	UNLESS NOTED OTHERWISE	
Ι	ID	INSIDE DIAMETER	V	VERT	VERTICAL	I
	INCL INSUL	INCLUDE INSULATION	·	VIF	VERIFY IN FIELD	-
	INT INV	INTERIOR INVERT				-
		1	W	W W/	WEST, WIDE, WIDTH WITH	-
J	JB	JUNCTION BOX		W/O WD	WITHOUT WOOD	
	JT	JOINT		WL WM	WATER LINE WATER METER	
K	ко	KNOCK OUT		WT	WEIGHT	
IX.	NU			WWM	WELDED WIRE MESH	
		EVIATIONS APPLY TO LANDDESIGN NOTA				

NOTE: ABBREVIATIONS APPLY TO LANDDESIGN NOTATIONS ONLY. SURVEY, ARCHITECTURAL AND OTHER ABBREVIATIONS MAY VARY.

SYMBOLS

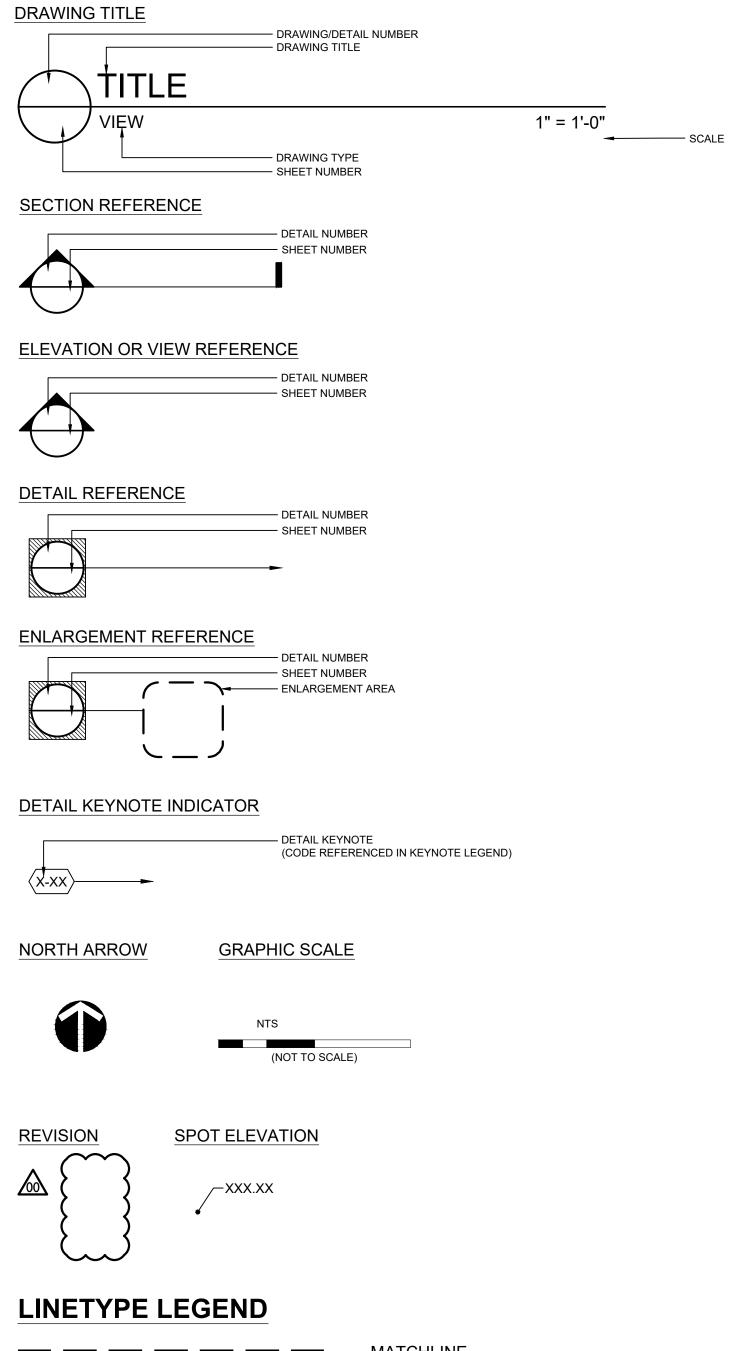

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MATCHLINE PROPERTY LINE RIGHT OF WAY

LandDesign	200 S. PEYTON STREET ALEXANDRIA, VA 22314 200 S. PEYTON STREET DATE: 2023-05-17 DATE: 2023-05-17	(703) 249-7784 www.LANDDESIGN.com		
4600 FAIRFAX DRIVE	4.1 SITE PLAN COUNTY BOARD SUBMISSION	ARLINGTON COUNTY, VIRGINIA		
SUBMISS	IONS			
NO.DESCRIPTIONDATE4.1 SITE PLAN SUBMISSION2021-11-234.1 SITE PLAN ACCEPTANCE2022-05-234.1 SITE PLAN POST ACCEPTANCE2022-05-234.1 SITE PLAN RESUBMISSION2022-12-23COUNTY BOARD SUBMISSION2023-05-17COUNTY BOARD SUBMISSION2023-05-17COUNTY BOARD SUBMISSION2023-05-17SCALE:Image: Country Board SubmissionSHEET TITLE: GENERAL NOTESSHEET #:LOOD1				

MATERIALS + PAVING NOTES:

- 1. ALL MATERIALS, CONSTRUCTION METHODS, WORKMANSHIP, EQUIPMENT SERVICES AND TESTING FOR ALL IMPROVEMENTS SHALL BE IN ACCORDANCE WITH THE PROJECT DOCUMENTS AND THE GOVERNING AUTHORITIES' REQUIREMENTS. IN THE EVENT OF A CONFLICT BETWEEN THE PROJECT DOCUMENTS AND THE GOVERNING AUTHORITIES' REQUIREMENTS, THE MORE STRINGENT SHALL APPLY.
- SUBGRADE PREPARATION, PAVEMENT STRENGTH AND THICKNESS SHALL BE IN ACCORDANCE WITH THE GEOTECHNICAL REPORT PREPARED FOR THIS PROJECT.
- 2.1. PROOF-ROLL SUBGRADE: PRIOR TO PREPARATION OF THE SUBBASE, THE SUBGRADE SHALL BE PROOF-ROLLED WITH HEAVY PNEUMATIC EQUIPMENT. ANY SOFT OR PUMPING AREAS SHALL BE EXCAVATED TO FIRM SUBGRADE AND BACKFILLED AND COMPACTED IN
- ACCORDANCE WITH THE GEOTECHNICAL REPORT. 2.2. PAVEMENT SUBGRADE SHALL BE GRADED TO PREVENT PONDING AND INFILTRATION OF EXCESSIVE MOISTURE ON OR ADJACENT TO THE PAVEMENT SUBGRADE.
- 3. THE USE OF "LEVEL UP" SAND UNDER PAVEMENT WILL NOT BE ACCEPTED, UNLESS NOTED OTHERWISE..
- 4. CONCRETE SHALL NOT BE PLACED WHEN THE TEMPERATURE IS BELOW 40 DEGREES FAHRENHEIT AND FALLING. BUT MAY BE PLACED WHEN THE TEMPERATURE IS ABOVE 35 DEGREES FAHRENHEIT AND RISING. THE TEMPERATURE READING SHALL BE TAKEN IN THE SHADE AWAY FROM ARTIFICIAL HEAT.
- 4.1. DO NOT PLACE CONCRETE WHILE IT IS RAINING OR WHEN RAIN IS IMMINENT.
- 5. CAST IN PLACE CONCRETE SHALL MEET THE FOLLOWING REQUIREMENTS:
- 5.1. MINIMUM 3,000 PSI COMPRESSIVE STRENGTH AT 28 DAYS, UNLESS NOTED OTHERWISE
- 5.2. AGGREGATES: ASTM C33 MAX 3/4" IN SIZE, UNLESS NOTED OTHERWISE 5.3. SLUMP: 3 TO 5 INCHES
- 5.4. AIR CONTENT: 4 TO 6 PERCENT BY VOLUME
- 6. CONCRETE THICKNESS:
- 6.1. PEDESTRIAN AREA: 4" THICK, UNLESS NOTED OTHERWISE.
- 6.2. ALL OTHER CONCRETE COMPONENTS INSTALL PER SIZE SPECIFIED IN DRAWINGS
- 7. CONCRETE REINFORCING:
- 7.1. 4" THICK PAVING: #3's AT 24" SPACING UNLESS NOTED OTHERWISE IN DRAWINGS
- 7.2. 6" THICK PAVING: #4s AT 24" SPACING UNLESS NOTED OTHERWISE IN DRAWINGS
- 7.3. 8" THICK PAVING: #5's AT 24" SPACING UNLESS NOTED OTHERWISE IN DRAWINGS
- 7.4. ALL PAVEMENT REINFORCING BARS SHALL BE GRADE 60 KSI DEFORMED BILLET STEEL BARS, UNCOATED FINISH. SIZE AND SPACING SHALL BE IN ACCORDANCE WITH THE PAVING PLAN AND DETAILS.
- 7.5. ALL REINFORCING STEEL AND DOWEL BARS IN PAVEMENT SHALL BE SUPPORTED AND MAINTAINED AT THE CORRECT CLEARANCES BY THE USE OF BAR CHAIRS.
- 8. CONTROL JOINTS (TROWEL OR SAW CUT)
- 8.1. TO BE PLACED AS INDICATED ON PLANS AND DETAILS TO A MINIMUM DEPTH OF 1/8 OF CONCRETE THICKNESS.
- 8.2. SAW CUT JOINTS TO BE EXECUTED WITHIN 12 HOURS OF CONCRETE PLACEMENT. SAWN JOINTS ARE TO BE TRUE IN ALIGNMENT AND SHALL CONTINUE THROUGH ADJACENT CURBS. RADIAL JOINTS SHALL BE NO 8.3. SHORTER THAN 18".
- 9. EXPANSION JOINTS
- 9.1. PLACE AT A MAXIMUM SPACING OF 30' O.C. AND COORDINATE WITH OVERALL PAVING PATTERN AND COLOR.
- 9.2. PROVIDE DOWELS AS SPECIFIED IN DRAWING DETAILS.
- EXPANSION JOINTS TO BE CLEANED OF DEBRIS, DIRT, DUST, SCALE, CURING COMPOUND AND CONCRETE, BLOWN DRY AND IMMEDIATELY 9.3. SEALED WITH A SELF-LEVELING, ELASTOMERIC POLYURETHANE OR EQUIVALENT. SEALANT COLOR SHALL MATCH PAVEMENT. CONTRACTOR SHALL PREPARE A JOINT LAYOUT AND PROVIDE IT TO THE ENGINEER FOR REVIEW. THE JOINT LAYOUT SHALL BE 9.4.
- PROVIDED A MINIMUM OF ONE WEEK PRIOR TO PLACING CONCRETE. PATTERN SHALL BE CAREFULLY DESIGNED BY THE CONTRACTOR
- TO AVOID IRREGULAR SHAPES. EXPANSION JOINTS SHALL NOT BE LOCATED ALONG VALLEYS IN PAVEMENT. 10. ALL CONSTRUCTION JOINTS SHALL BE SAWN, CONCRETE FINISHES TO BE PER DRAWING DETAILS AND SPECIFICATIONS.
- 11. CONCRETE SHALL BE BROOM FINISHED AND CURED FOR A MINIMUM OF 72 HOURS UNLESS NOTED OTHERWISE
- 12. BREAKOUTS FOR REMOVAL OF EXISTING PAVEMENT AND CURBS SHALL BE MADE BY FULL DEPTH SAW CUT WHEN ADJACENT TO PROPOSED PAVEMENT AND/OR CURBS.
- 13. PROPOSED PAVEMENT AND/OR CURBS INTENDED TO TIE INTO EXISTING SHALL MATCH SHALL MATCH THE ELEVATION OF EXISTING PAVEMENT AND/OR CURBS.
- 14. CONTRACTOR SHALL REFER TO THE SITE CIVIL, MEP AND IRRIGATION PLANS FOR CONDUIT TO BE INSTALLED UNDER PAVEMENT PRIOR TO COMMENCING PAVEMENT SUBGRADE PREPARATION.
- 15. ALL TESTING SHALL BE PERFORMED BY A QUALIFIED TESTING LABORATORY, EMPLOYED AND PAID DIRECTLY BY THE OWNER. UNLESS NOTED OTHERWISE, TESTING SHALL BE PERFORMED, AT A MINIMUM, IN ACCORDANCE WITH THE RECOMMENDATIONS IN THE GEOTECHNICAL REPORT. IN THE EVENT THE RESULTS OF THE INITIAL TESTING DO NOT COMPLY WITH THE PLANS AND THE SPECIFICATIONS, SUBSEQUENT TEST NECESSARY TO DETERMINE THE ACCEPTABILITY OF CONSTRUCTION SHALL BE AT THE CONTRACTOR'S EXPENSE. PAVEMENT FOUND TO BE DEFICIENT IN STRENGTH OR THICKNESS SHALL BE REMOVED AND REPLACED SOLELY AT THE EXPENSE OF THE CONTRACTOR.

ACCESSIBILITY NOTES:

- 1. MAX CROSS SLOPE ON PAVED SURFACES SHALL BE 2% MAXIMUM, UNLESS NOTED OTHERWISE
- 2. MAX RUNNING SLOPE ON PAVED SURFACES SHALL BE 5% MAXIMUM, UNLESS NOTED OTHERWISE.
- 3. ACCESSIBLE PATH OF TRAVEL SHALL BE MAINTAINED FREE OF OVERHANGING OBSTRUCTIONS TO 80" MINIMUM, AND PROTRUDING OBJECTS GREATER THAN 4" PROJECTION FROM WALL AND ABOVE 27" AND LESS THAN 80". CONTRACTOR SHALL VERIFY THAT THERE ARE NO BARRIERS IN THE PATH OF TRAVEL.
- 4. ALL CURB RAMPS SHALL BE BROOM FINISHED PERPENDICULAR TO SLOPE.
- 5. ALL CURB RAMPS SHALL HAVE A 1:12 MAX SLOPE IN THE DIRECTION OF TRAVEL, 2% MAX CROSS SLOPE.
- 6. IT IS THE INTENT OF THE CONTRACT DOCUMENTS TO COMPLY WITH ALL APPROPRIATE FAIR HOUSING ACCESSIBILITY GUIDELINES AND GENERAL NOTES FOR PUBLIC AND COMMON USE FACILITIES. REPORT ANY DISCREPANCIES TO LANDDESIGN.

PLANTING NOTES:

PLANTERS/POTS/SEASONAL PLANTING NOTES:

- 1. SOIL SHOULD BE NUTRIENT-RICH, MOISTURE CONTAINING PLANTING MEDIUM AND BE A MINIMUM 18" DEPTH FOR SEASONALS, PERENNIALS AND SMALL SHRUBS; MINIMUM 36" DEPTH FOR ALL TREES. A LAYER OF RIVER ROCK SHALL BE PLACED IN THE BASE OF EACH PLANTER POT TO A MINIMUM 6" DEPTH OR AS ALLOWABLE BY REQUIRED SOIL DEPTH. PLACE FILTER FABRIC BETWEEN SOIL MEDIUM AND RIVER ROCK AND SOIL MEDIUM AND PLANTER EDGES. OVERLAP FABRIC 6" MINIMUM TO MINIMIZE SOIL WASH.
- PLANTERS POTS WHICH DO NOT RECEIVE IRRIGATION SHALL BE HAND-WATERED. HAND WATERING SHOULD OCCUR MINIMUM 2 TIMES PER WEEK DURING COOLER AND RAINY SEASONS AND INCREASED TO EVERY 2-3 DAYS DURING HOT/DRY WEATHER. ALWAYS CHECK SOIL 6" BELOW SURFACE FOR SATURATION PRIOR TO WATERING TO PREVENT OVERWATERING/DROWNING OF PLANT MATERIAL.
- 4. WHEN APPLICABLE, PLANTS TO REMAIN IN CONTAINERS FOR DURATION OF SEASON ARE SHOWN IN THE "PERMANENT" LAYOUT. EACH SEASON WILL HAVE ITS OWN PLANT MATERIAL, SOME OF WHICH MAY LAST ALL YEAR. ROTATE IN THE PLANTS NOTED FOR EACH SEASON. 5. IF PLANT MATERIAL DIES DURING A SEASON AND IS EXPECTED TO REMAIN FOR AN ADDITIONAL SEASON, CONTRACTOR IS TO REPLACE AT TIME OF NEXT SEASONAL ROTATION.

- 7. ALL PLANTS SHOULD BE FULL AT TIME OF INSTALLATION AND COVER 75% OF POT SURFACE AREA.
- 8. AVOID PLANTING IN THE ROOT ZONE OF ANY PERMANENT TREES, SHRUBS, OR PERENNIALS.
- 9. SEASONAL PLANTS SHOULD BE REMOVED FOLLOWING THE FIRST MAJOR FROST DIEBACK AND REPLACED WITH EVERGREEN BOUGHS OR OTHER OWNER APPROVED WINTER DECOR. TREES, SHRUBS AND PERENNIALS SHOULD REMAIN IN THE CONTAINERS YEAR ROUND AND REPLACED ONLY AS NECESSARY.

IRRIGATION NOTES:

- A FULLY AUTOMATED IRRIGATION SYSTEM PROVIDING 100% COVERAGE SHALL BE PROVIDED FOR ALL PLANTING AREAS, UNLESS NOTED OTHERWISE. SYSTEM SHALL BE IN OPERATION PRIOR TO INSTALLATION OF ANY PLANT MATERIAL OTHER THAN CANOPY TREES.
- 2. ALL PLANTING BEDS/ SHRUB AND GROUNDCOVER AREAS TO BE IRRIGATED WITH EITHER 12" SPRAY POP-UPS AND/OR A LANDSCAPE
- DRIP-LINE SYSTEM, UNLESS NOTED OTHERWISE. 3. ALL PLANTER POTS AND RAISED PLANTERS TO BE IRRIGATED WITH MICRO SPRAY SPRINKLER HEADS.

1. SEE SHEET L603 PLANTING NOTES

- 6. CONTACT LANDDESIGN FOR ANY REQUIRED SUBSTITUTIONS.

- 4. IRRIGATION SYSTEM IS DESIGN/BUILD. CONTRACTOR TO PROVIDE DRAWINGS AND CUT SHEETS OF ALL COMPONENTS.
- 5. PROVIDE AS-BUILT DRAWINGS OF IRRIGATION AFTER INSTALLATION

GENERAL NOTES:

- BY: WALTER L. PHILLIPS ON APRIL 5, 2021
- ARCHITECTURAL INFORMATION IS FROM PLANS BY: HORD, COPLAN, MACHT
- 4. DIMENSIONS ARE TO FACE OF OBJECT, UNLESS NOTED OTHERWISE.
- INACCURATE CONSTRUCTION.
- DISCREPANCIES
- TO BE USED, SHALL BE VERIFIED WITH THE OWNER OR LANDDESIGN PRIOR TO BIDDING.
- PRECAUTIONS AND PROGRAMS IN CONNECTION WITH THE WORK.

- CONSTRUCTION.

LAYOUT NOTES

- ARLINGTON COUNTY.
- ANY EXCAVATION TO REQUEST EXACT FIELD LOCATION OF UTILITIES.
- EQUAL TO OR BETTER THAN CONDITION PRIOR TO CONSTRUCTION.
- 5. ALL CURB RADII AND SIDEWALK RETURNS ARE 2' UNLESS NOTED OTHERWISE. 6. ALL PAVING AND EARTHWORK OPERATIONS SHALL CONFORM TO THE PROJECT GEOTECHNICAL REPORT.
- TO PLACEMENT OF LAID PAVERS WITH RUBBER HAMMERS AS REQUIRED.
- WIDE TO ACHIEVE STRAIGHT BOND LINES.
- 11. FILL GAPS AT THE EDGES OF THE PAVED AREA WITH CUT PAVERS OR EDGE UNITS.
- 12. CUT PAVERS TO BE PLACED ALONG THE EDGE WITH A MASONRY SAW
- 13. ADJUST BOND PATTERN AT PAVEMENT EDGES SUCH THAT CUTTING OF EDGE PAVERS IS MINIMIZED.
- 14. IN NO CASE SHALL A CUT PAVER BE LESS THAN 1/3 FULL PAVER SIZE.
- PAVER SIZES. NOTIFY LANDDESIGN IMMEDIATELY OF DISCREPANCIES AND/OR ADJUSTMENTS.

GRADING NOTES:

- FI EVATIONS ARE TO EDGE OF PAVEMENT
- MATERIAL, DEEP FILLS, EXCAVATION, AND FOUNDATIONS.
- GRADING, PERMISSION MUST BE OBTAINED FROM THE AFFECTED PROPERTY OWNERS.
- 6. IN ORDER TO ASSURE PROPER DRAINAGE, KEEP A MINIMUM OF .5% SLOPE ON THE CURB. 7. ALL PLANTING ISLANDS SHALL BE GRADED TO MOUND TO PROVIDE POSITIVE DRAINAGE.
- CONTRACTOR TO VERIFY 2% MAX. CROSS-SLOPE ON ALL SIDEWALKS.
- 10. CONCRETE SIDEWALKS ADJACENT TO TREE SAVE LOCATIONS SHOULD BE POURED ON TOP OF EXISTING GRADE. 11. REFER TO LANDSCAPE PLAN FOR ALL TREE PROTECTION FENCE LOCATIONS AND INSTALLATION PROCEDURES. BEFORE ZONE.
- TOPS OF EXISTING MANHOLES AS REQUIRED TO MATCH FINISHED GRADES.
- PROPER AND TIMELY COMPLETION OF THIS PROJECT.

BASE INFORMATION, INCLUDING EXISTING CONDITIONS, TOPOGRAPHY, EXISTING UTILITIES, AND BOUNDARY INFORMATION IS FROM PLANS

WRITTEN DIMENSIONS PREVAIL OVER SCALED DIMENSIONS. NOTIFY LANDDESIGN OF ANY DISCREPANCIES.

5. THE CONTRACTOR IS RESPONSIBLE FOR VERIFYING ALL UNDERGROUND UTILITIES, PIPES, STRUCTURES, AND LINE RUNS IN THE FIELD PRIOR TO CONSTRUCTION. ANY DAMAGE TO NEW AND EXISTING UTILITIES ARE TO BE REPAIRED IMMEDIATELY AT NO ADDITIONAL EXPENSE TO THE OWNER, LANDDESIGN ASSUMES NO RESPONSIBILITY FOR ANY UTILITIES NOT SHOWN ON PLANS.

6. ALL PROPOSED FINISHED GRADES ARE BASED ON INFORMATION PROVIDED BY THE OWNER'S SURVEY AND OR CIVIL ENGINEER. ANY DISCREPANCIES IN ACTUAL FIELD MEASUREMENTS ARE TO BE REPORTED TO LANDDESIGN IMMEDIATELY.

PRIOR TO COMMENCEMENT OF HARDSCAPE CONSTRUCTION, ALL PIERS, FOOTINGS, AND WALLS SPECIFIC TO THE SCOPE OF THIS DRAWING PACKAGE ARE TO BE SURVEYED, LAID OUT, AND STAKED IN THE FIELD FOR REVIEW BY LANDDESIGN. CONTRACTOR SHALL ASSUME ALL RESPONSIBILITY FOR ANY DEMOLITION, ADJUSTMENTS, OR RECONSTRUCTION OF HARDSCAPE CONSTRUCTION RESULTING FROM

8. CONTRACTOR IS RESPONSIBLE TO PROVIDE AND INSTALL ALL ITEMS PER DRAWINGS AND SPECIFICATION. NOTIFY LANDDESIGN OF ANY MAJOR DISCREPANCIES BETWEEN CONTRACTOR'S VERIFIED QUANTITIES, BID BOOK, AND INTENT OF DRAWING.

CONTRACTOR IS RESPONSIBLE FOR ALL FINAL QUANTITIES PER DRAWINGS AND SPECIFICATIONS ANY QUANTITIES PROVIDE BY LANDDESIGN ARE PROVIDED FOR CONVENIENCE ONLY AND SHALL NOT BE CONSIDERED ABSOLUTE. LANDDESIGN SHOULD BE NOTIFIED OF ANY GRADING

10. THE CONTRACTOR SHALL EXAMINE AND BECOME FAMILIAR WITH ALL CONTRACT DOCUMENTS IN THEIR ENTIRETY. SURVEY THE PROJECT AND BECOME FAMILIAR WITH THE EXISTING CONDITIONS AND SCOPE OF WORK. ALL COSTS SUBMITTED SHALL BE BASED ON THOROUGH KNOWLEDGE OF ALL WORK AND MATERIALS REQUIRED ANY DISCREPANCY AND/ OR UNCERTAINTY AS TO WHAT MATERIAL OR PRODUCT IS

11. THE CONTRACTOR SHALL BE SOLELY RESPONSIBLE FOR CONSTRUCTION MEANS, METHODS, TECHNIQUES, SEQUENCES AND PROCEDURES REQUIRED FOR SAFE EXECUTION AND COMPLETION OF WORK, AND FOR INITIATING, MAINTAINING AND SUPERVISING ALL SAFETY

12. IN THE EVENT A DISCREPANCY IS FOUND IN THE CONTRACT DOCUMENTS, THE OWNER & LANDDESIGN SHALL BE NOTIFIED IMMEDIATELY. 13. CONTRACTOR SHALL VERIFY ALL DIMENSIONS IN THE FIELD AND NOTIFY LANDDESIGN OF ANY DISCREPANCIES PRIOR TO CONSTRUCTION. 14. CONTRACTOR SHALL VERIFY ALL MEASUREMENTS AT THIS SITE AND AND BE RESPONSIBLE FOR ACCURACY AND CORRECTNESS OF SAME. 15. CONTRACTOR SHALL COORDINATE WORK WITH ALL OTHER TRADES AND NOTIFY OWNER & LANDDESIGN OF ANY DISCREPANCIES PRIOR TO

16. ALL EXISTING WORK OR LANDSCAPING NOT SHOWN TO BE ALTERED OR REMOVED SHALL BE PROTECTED FROM DAMAGE DURING CONSTRUCTION. THE CONTRACTOR(S) SHALL BEAR THE TOTAL EXPENSE FOR, AND SHALL REPAIR ANY DAMAGE TO EXISTING CONDITIONS, OR IMPROVEMENTS NOT INDICATED IN THE DRAWINGS OR SPECIFICATIONS TO RECEIVE ALTERATION, ADDITIONS OR REMOVAL.

ALL MATERIALS AND CONSTRUCTION WITHIN RIGHT OF WAYS SHALL BE IN ACCORDANCE WITH THE ARLINGTON COUNTY STANDARD SPECIFICATIONS AND CONSTRUCTION STANDARDS, AND STANDARD SPECIFICATIONS FOR PUBLIC WORKS CONSTRUCTION PREPARED BY

EXISTING UTILITIES ARE SHOWN SCHEMATICALLY AND ARE FOR THE CONTRACTOR'S GUIDANCE ONLY. THE LOCATION AND/OR ELEVATION OF EXISTING UTILITIES AS SHOWN ON THESE PLANS ARE BASED ON RECORDS OF THE VARIOUS UTILITY COMPANIES, AND, WHERE POSSIBLE, MEASUREMENTS TAKEN IN THE FIELD. THE CONTRACTOR MUST CALL THE APPROPRIATE UTILITY COMPANY AT LEAST 48 HOURS PRIOR TO

CONTRACTOR SHALL BE RESPONSIBLE FOR PROTECTING ALL EXISTING IMPROVEMENTS IN THE CONSTRUCTION OF THIS PROJECT. THE CONTRACTOR IS RESPONSIBLE FOR REPAIRS OF DAMAGE TO ANY EXISTING IMPROVEMENTS DURING CONSTRUCTION. REPAIRS SHALL BE

4. ALL ONSITE PAVING DIMENSIONS ARE TO THE FACE OF CURB, WHERE APPLICABLE, UNLESS NOTED OTHERWISE.

7. BUILDING DIMENSIONS: THE CONTRACTOR SHALL REFER TO THE ARCHITECTURAL PLANS TO VERIFY THE EXACT BUILDING DIMENSIONS. 8. LAY PAVERS IN PATTERN(S) SHOWN ON DRAWINGS. PLACE UNITS HAND TIGHT WITHOUT USING HAMMERS. MAKE HORIZONTAL ADJUSTMENTS

9. PROVIDE JOINTS BETWEEN PAVERS BETWEEN 1/16 IN. AND 3/16 IN. (2 AND 5 MM) WIDE. NO MORE THAN 5% OF THE JOINTS SHALL EXCEED 1/4"

10. JOINT (BOND) LINES SHALL NOT DEVIATE MORE THAN ±1/2 IN. (±15 MM) OVER 50 FT. (15 M) FROM STRING LINES.

15. PAVER DIMENSIONS ARE NOMINAL, PRIOR TO POURING SLABS, BANDING, OR OTHERWISE SETTING PAVER FIELDS, VERIFY ACTUAL PAVER SIZES AND LAYOUT OF THE PAVER FIELDS. MAKE MINOR ADJUSTMENTS TO EDGE CONSTRAINTS AS REQUIRED TO ACCOMMODATE ACTUAL

1. STAKE PER SPOT ELEVATIONS AND NOTED SLOPES. CONTOURS ARE PROVIDED FOR MASS GRADING/INTENT ONLY.

2. WRITTEN DIMENSIONS AND GRADES PREVAIL OVER SCALED DIMENSIONS, NOTIFY LANDDESIGN OF ANY DISCREPANCIES. 3. ALL SPOT ELEVATIONS SHOWN ON GRADING PLAN ARE TO BOTTOM OF CURB/TOP OF PAVEMENT UNLESS OTHERWISE NOTED. ALL RIM

4. REFER TO GEOTECHNICAL ENGINEER AND GEOTECH REPORT FOR INFORMATION ON SUBSURFACE MATERIALS, TOPSOIL, STRUCTURAL

5. APPROVAL OF THIS PLAN IS NOT AN AUTHORIZATION TO GRADE ADJACENT PROPERTIES. WHEN FIELD CONDITIONS WARRANT OFF-SITE

9. CONTRACTOR TO VERIFY THAT ALL SIDEWALK SLOPES, HANDICAP RAMPS, AND HANDICAP PARKING SPACES MEET ADA REQUIREMENTS.


GRADING/CONSTRUCTION BEGINS, CALL FOR INSPECTION OF TREE PROTECTION BARRICADES. NO SOIL DISTURBANCE OR COMPACTION, CONSTRUCTION MATERIALS, TRAFFIC, BURIAL PITS, TRENCHING, OR OTHER LAND DISTURBING ACTIVITY ALLOWED IN THE TREE PROTECTION

12. DIMENSIONS ON BUILDINGS ARE FOR GRADING PURPOSES ONLY AND ARE NOT TO BE USED TO LAYOUT FOOTINGS.

13. GRADING CONTRACTORS SHALL NOTIFY AND COOPERATE WITH ALL UTILITY COMPANIES OR FIRMS HAVING FACILITIES ON OR ADJACENT TO THE SITE BEFORE DISTURBING, ALTERING, REMOVING, RELOCATING, ADJUSTING OR CONNECTING TO SAID FACILITIES. CONTRACTORS SHALL PAY ALL COSTS IN CONNECTION WITH THE ALTERATION OF OR RELOCATION OF THE FACILITIES. CONTRACTORS SHALL RAISE OR LOWER

14. GRADING CONTRACTOR SHALL COOPERATE AND WORK WITH ALL OTHER CONTRACTORS PERFORMING WORK ON THIS PROJECT TO INSURE

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SUBMISSIONSNO.DESCRIPTIONDATE4.1 SITE PLAN SUBMISSION2021-11-234.1 SITE PLAN ACCEPTANCE2022-01-254.1 SITE PLAN ACCEPTANCE2022-05-234.1 SITE PLAN RESUBMISSION2022-12-234.1 SITE PLAN RESUBMISSION2022-12-23COUNTY BOARD SUBMISSION2023-05-17COUNTY BOARD SUBMISSION2023-05-17SCALE:Image: Sheet title:SHEET TITLE:SHEET title:GENERAL NOTESSHEET #:LOOD2					

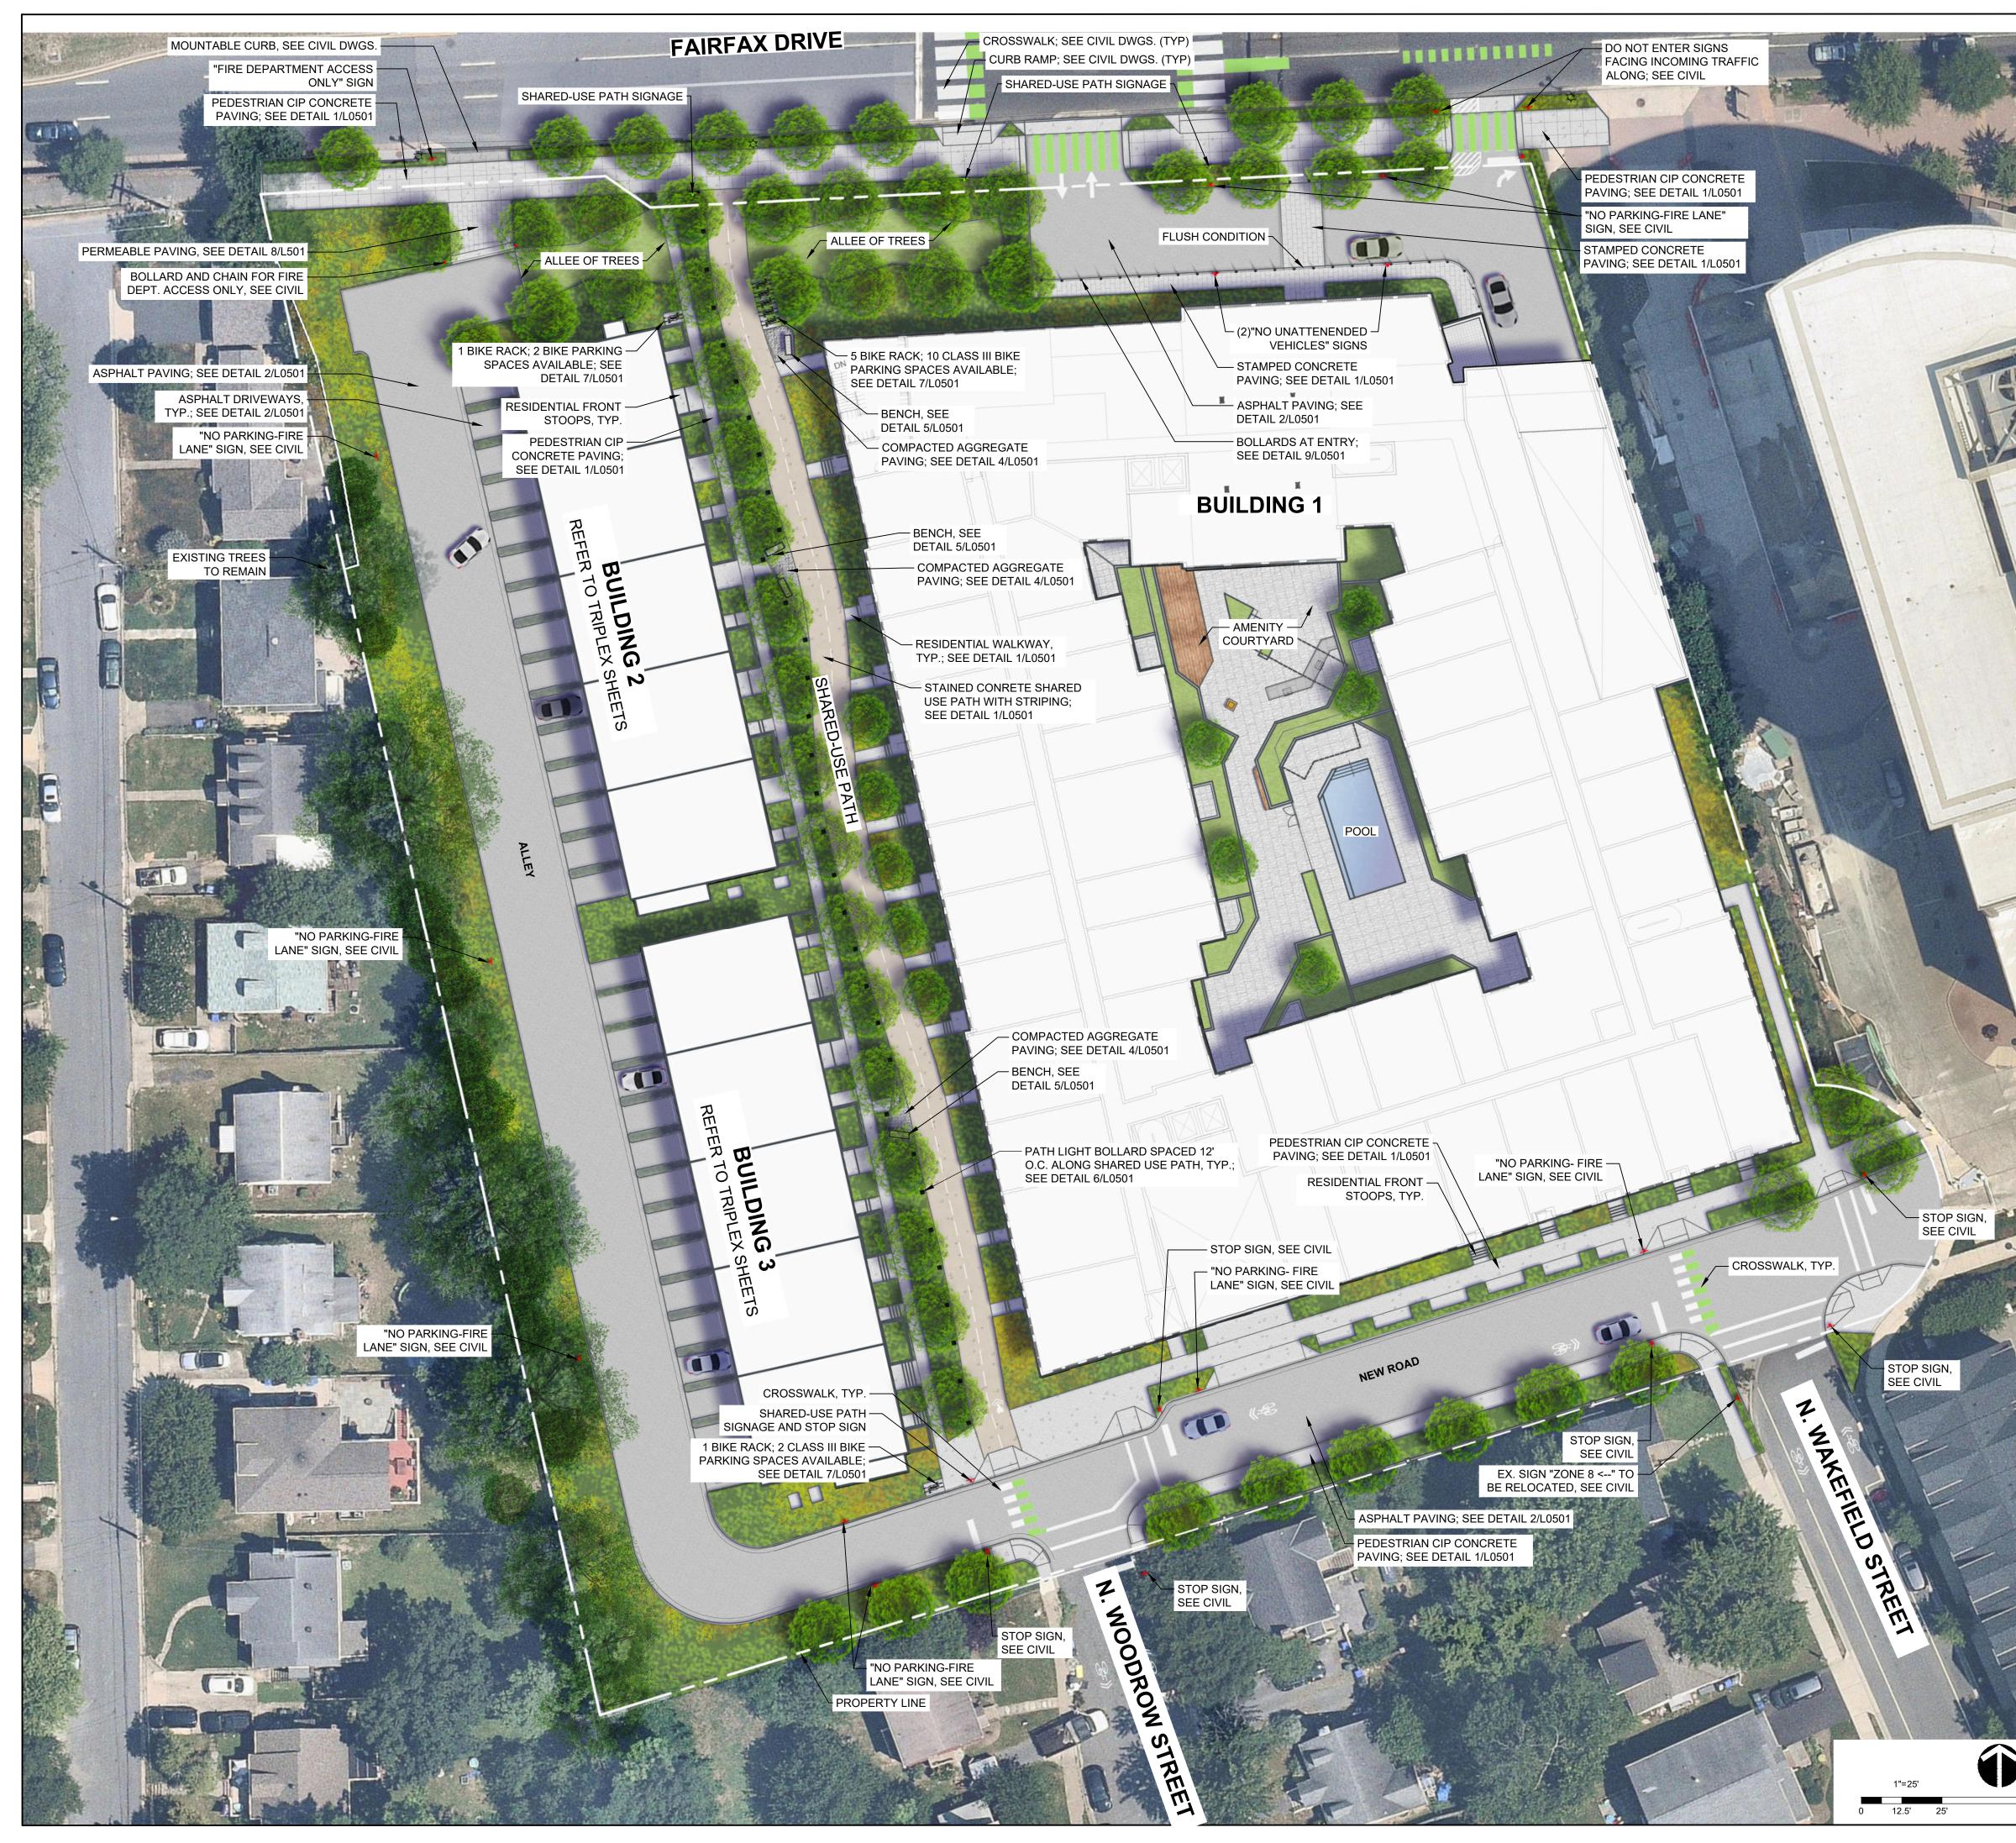


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BICYCLE FACILITIES						
TYPE	QUANTITY	BIKE SPACES				
CLASS III BIKE RACK - BUILDING 1	5	10				
CLASS III BIKE RACK - BUILDING 2	1	2				
CLASS III BIKE RACK - BUILDING 3	1	2				

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SHEET #: SHEET #: L101					

NOTES:

- 1. ALL STREET TREES WILL PROVIDE A MINIMUM OF 600 CUBIC FEET OF SOIL PER TREE. SOIL DEPTHS FOR STREET TREES TO BE 36" MINIMUM. SEE SOIL VOLUME TABULATION TABLE ON SHEET L402.
- ALL ON SITE TREES (OUTSIDE STREETSCAPE) THAT ARE COUNTED TOWARD TREE REPLACEMENT AND/OR CANOPY CREDITS WILL PROVIDE A MINIMUM 300 CUBIC FEET OF SOIL PER TREE AND A MINIMUM 36" SOIL DEPTH. SEE SOIL VOLUME TABULATION TABLE ON SHEET L402.
- 3. UTILITY INFORMATION SHOWN FOR REFERENCE ONLY. SEE CIVIL DRAWINGS FOR ALL UTILITY INFORMATION AND ASSESSMENT.
- 4. ALL HATCHES ARE FOR GRAPHIC REPRESENTATION ONLY.
- 5. ALL DRAWINGS ARE PROVIDED FOR INFORMATIONAL PURPOSES ONLY AND ARE SUBJECT TO CHANGE PER FINAL ARCHITECTURE, CIVIL AND SITE DESIGN.
- DRAWINGS ARE NOT FOR CONSTRUCTION.
 PROPOSED STREET TREES LOCATED OUTSIDE OF SITE PROPERTY LINE WILL NOT COUNT TOWARDS TREE CANOPY CREDIT. SEE SOIL VOLUME TABULATION TABLE AND TREE CANOPY CALCULATION TABLE ON SHEET L402.
- 8. INDICATED PROPOSED STREET TREES ARE SUBJECT TO UTILITY CONFIRMATION AND COORDINATION.

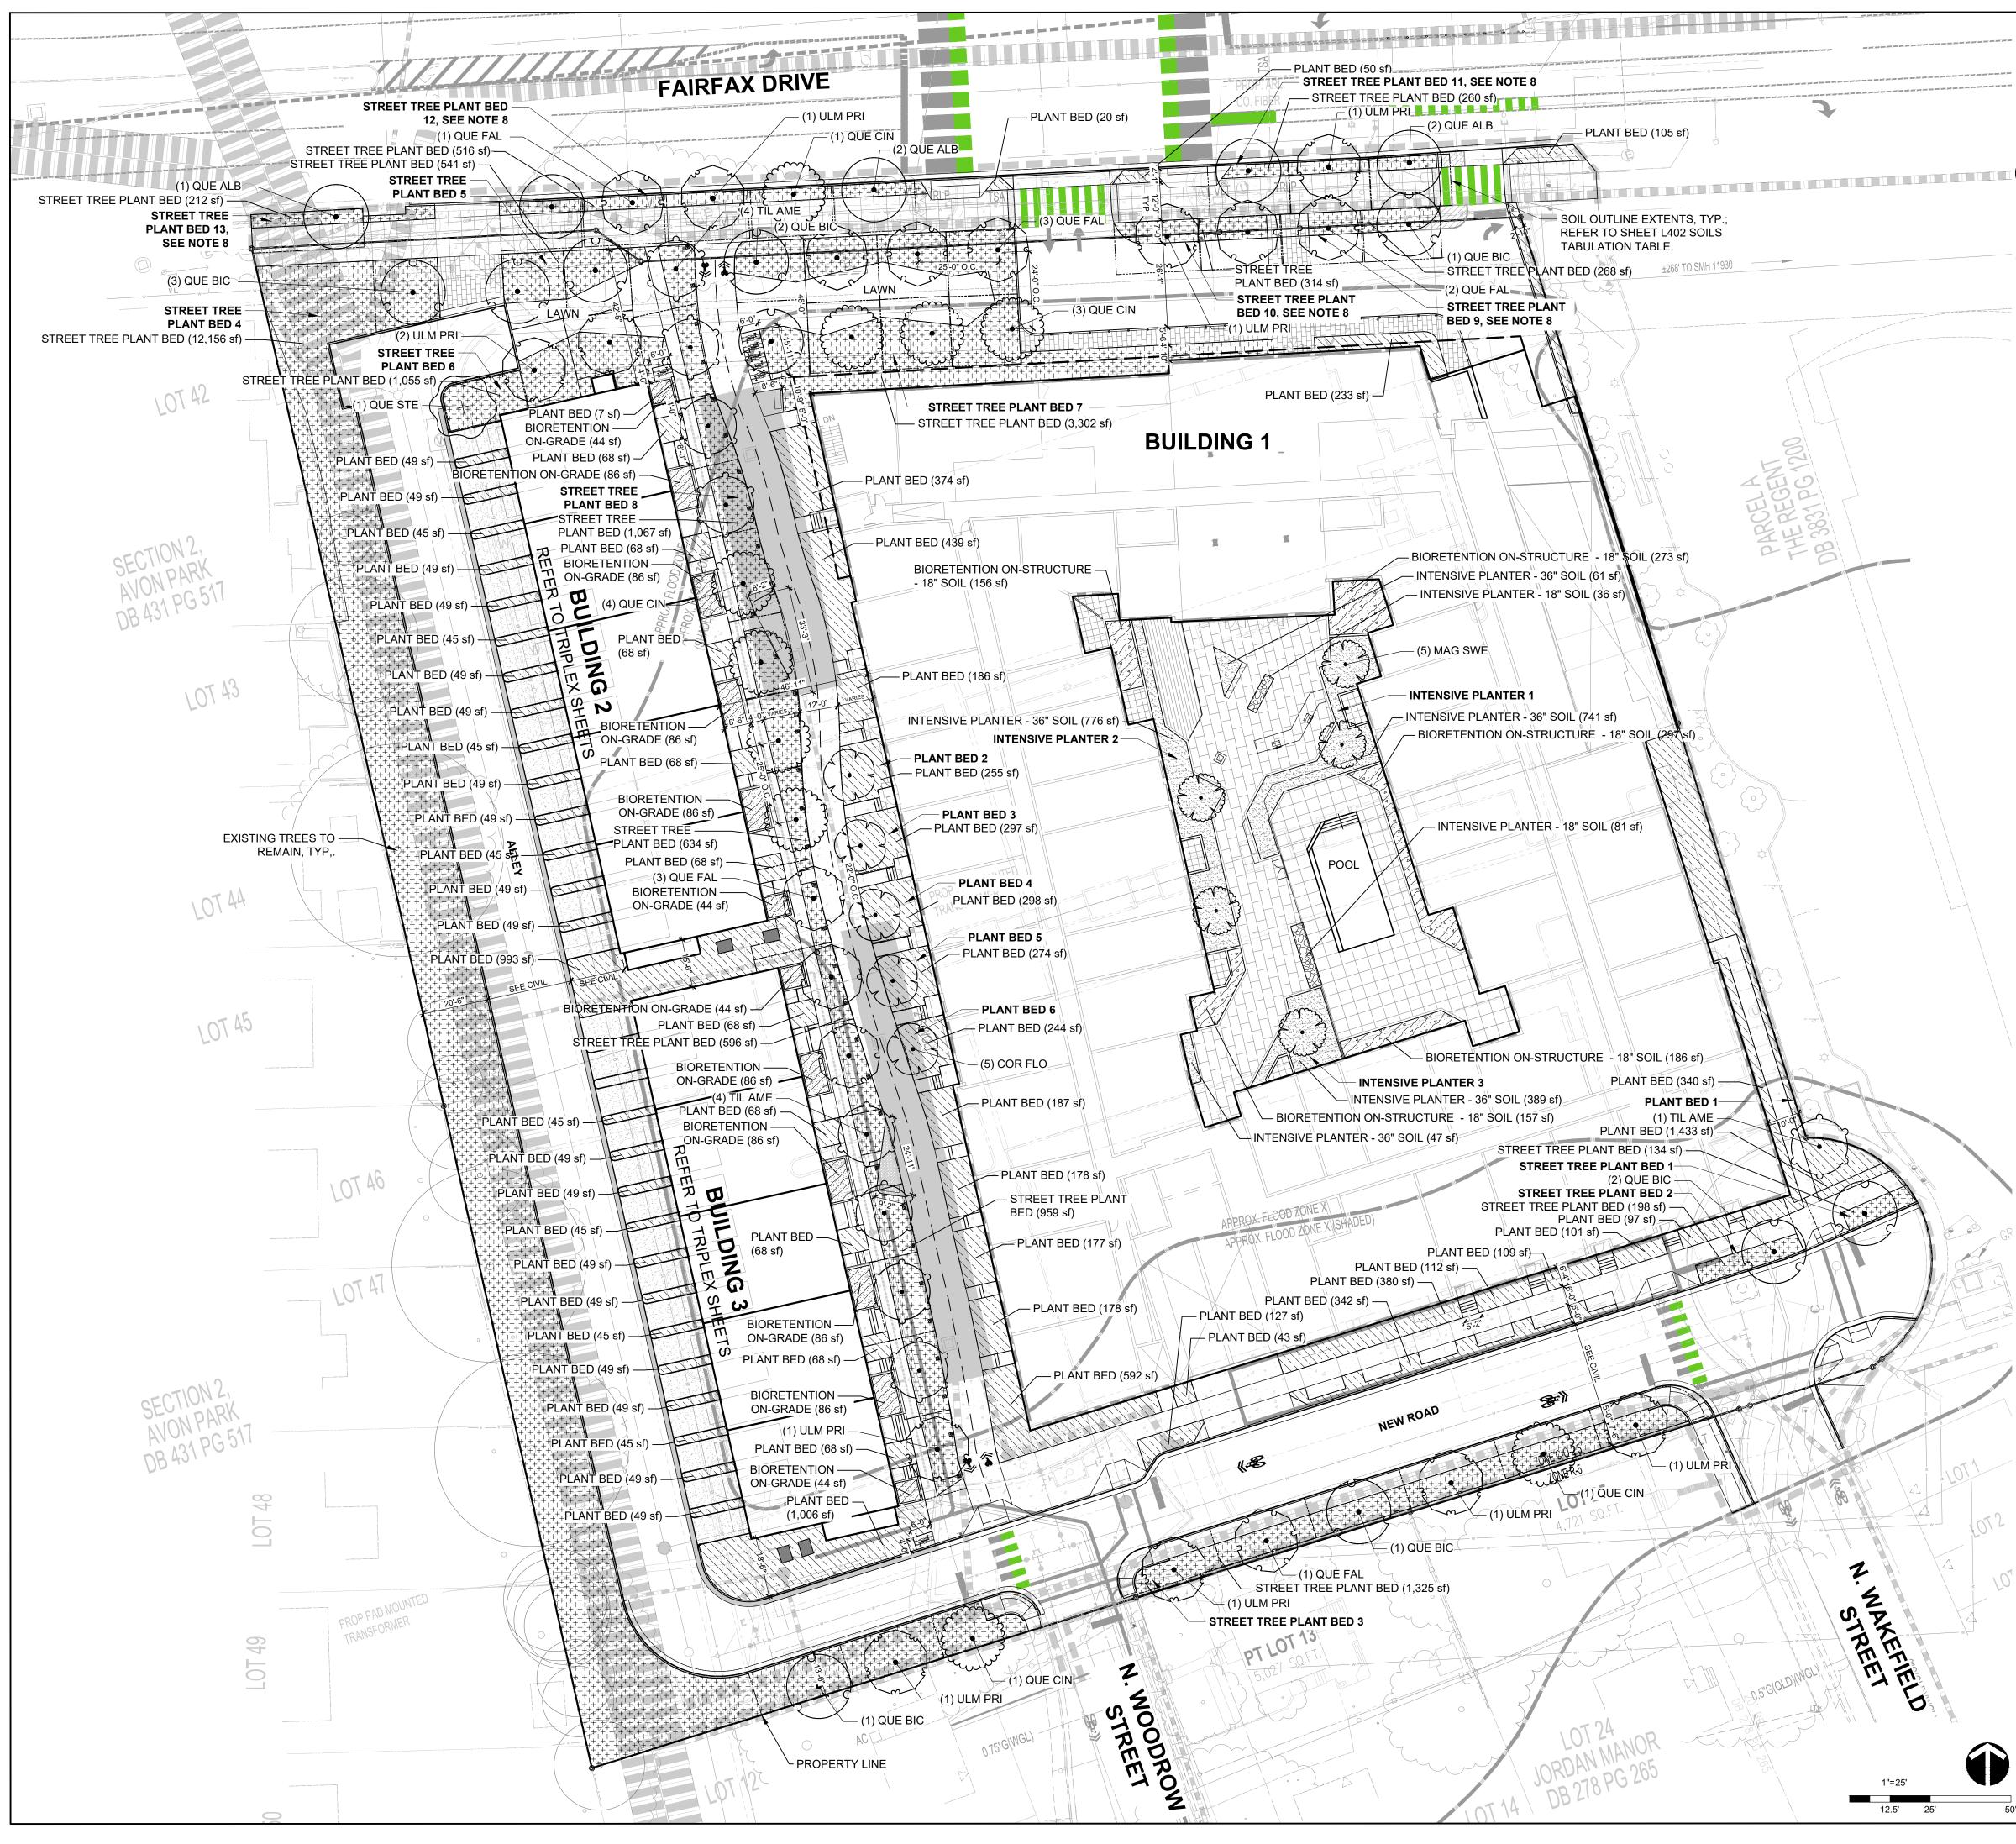

12/15/2022 4:06 PM CECILIA TRAN P:\ALX_2021\2021083\CAD\DOCUMENTATION\1083-PLAN-PLNT-L1.DWG

PLANT SCHEDULE SITE

CODE	<u>QTY</u>	BOTANICAL NAME
TIL AME	9	TILIA AMERICANA
COR FLO	5	CORNUS FLORIDA
QUE STE	1	QUERCUS STELLATA
ULM PRI	10	ULMUS AMERICANA 'PRINCETON'
QUE CIN	10	QUERCUS COCCINEA
QUE FAL	10	QUERCUS FALCATA
QUE BIC	10	QUERCUS BICOLOR
MAG SWE	5	MAGNOLIA VIRGINIANA
QUE ALB	5	QUERCUS ALBA

1. ALL PROPOSED TREES WILL PROVIDE A MINIMUM OF SOIL VOLUME REQUIRED PER TREE. SEE SOIL VOLUME TABULATION TABLE ON SHEET L402.

CONCEPT PLANT LEGEND



TREES

STREET TREE PLANT BED SEE PLANTING DETAILS ON SHEET


SEE PLANTING DETAILS ON SHEET L601 & L602



BIORETENTION ON-STRUCTURE - 18" SOIL SEE DETAIL 2/L602

INTENSIVE PLANTER - 36" SOIL



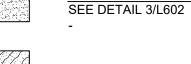

BIORETENTION ON-GRADE SEE CIVIL DWG(S)

NTENSIVE PLANTER - 18" SOIL SEE DETAIL 5/L602

TRE 223 ່∾ ∢ 200 S. ALEX/ (703) ! SITE PLAN OARD SUBMISSION Ϋ́́ **4** ≻ N Ο Ō Õ 46

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NOTES

- 1. ALL STREET TREES WILL PROVIDE A MINIMUM OF 600 CUBIC FEET OF SOIL PER TREE. SOIL DEPTHS FOR STREET TREES TO BE 36" MINIMUM. SEE SOIL VOLUME TABULATION TABLE ON SHEET L402.
- 2. ALL ON SITE TREES (OUTSIDE STREETSCAPE) THAT ARE COUNTED TOWARD TREE REPLACEMENT AND/OR CANOPY CREDITS WILL PROVIDE A MINIMUM 300 CUBIC FEET OF SOIL PER TREE AND A MINIMUM 36" SOIL DEPTH. SEE SOIL VOLUME TABULATION TABLE ON SHEET L402.
- 3. UTILITY INFORMATION SHOWN FOR REFERENCE ONLY. SEE CIVIL DRAWINGS FOR ALL UTILITY INFORMATION AND ASSESSMENT.
- 4. ALL HATCHES ARE FOR GRAPHIC REPRESENTATION ONLY. 5. ALL DRAWINGS ARE PROVIDED FOR INFORMATIONAL PURPOSES ONLY
- AND ARE SUBJECT TO CHANGE PER FINAL ARCHITECTURE, CIVIL AND SITE DESIGN. 6. DRAWINGS ARE NOT FOR CONSTRUCTION.
- 7. PROPOSED STREET TREES LOCATED OUTSIDE OF SITE PROPERTY LINE WILL NOT COUNT TOWARDS TREE CANOPY CREDIT. SEE SOIL VOLUME TABULATION TABLE AND TREE CANOPY CALCULATION TABLE ON SHEET L402.
- 8. INDICATED PROPOSED STREET TREES ARE SUBJECT TO UTILITY CONFIRMATION AND COORDINATION.

SHEET #:	
_40	1

SHEET TITLE:

PLANTING PLAN - SITE

SCALE:

NO. DESCRIPTION

SUBMISSIONS

4.1 SITE PLAN POST ACCEPTANCE | 2022-05-23

4.1 SITE PLAN SUBMISSION

4.1 SITE PLAN ACCEPTANCE

4.1 SITE PLAN RESUBMISSION

COUNTY BOARD SUBMISSION

DATE

2021-11-23

2022-01-25

2022-12-23

2023-05-17



<u>SC⊦</u>	IEDI	JLE							SOIL VC	LUME TA	BULATIC	N
CODE COR FLO	<u>QTY</u>	BOTANICAL / COMI	<u>MON NAME</u> / FLOWERING DOGWOOD	CONTAINER	<u>CAL</u> .75" - 1"	<u>HT.</u>	<u>SPD.</u> 2` - 3`	REMARKS	LOCATION	TREE	TREE SOIL AREA	TREE SOIL VOLUME (3 FT DEPTH)
0011120	0						2 0		INTENSIVE PLANTER 1	MAG SWE 1	370	1110
MAG SWE	5	MAGNOLIA VIRGIN	IANA / SWEETBAY MAGNOLIA	B & B		6` - 7`	3` - 5`			MAG SWE 2	370	1110
QUE ALB	5	QUERCUS ALBA / V	νηίτε υακ	B & B	1 3/4" - 2"		4` - 5`	3.5" CALIPER FOR STREET TREES**	INTENSIVE PLANTER 2	MAG SWE 3	387	1161
	0				10/4 2		- 0	3.3 OALII EITI OITOITALLI IITALO		MAG SWE 4	387	1161
QUE BIC	10	QUERCUS BICOLO	R / SWAMP WHITE OAK	B & B	1 3/4" - 2"		4` - 5`	3.5" CALIPER FOR STREET TREES**	INTENSIVE PLANTER 3	MAG SWE 5	387	1161
QUE CIN	10	QUERCUS COCCIN		B & B	1 3/4" - 2"		4` - 5`	3.5" CALIPER FOR STREET TREES**	PLANT BED 1	TIL AME 1*	457	1371
	10				13/4 - 2		4 - 5	3.3 GALIFER FOR STREET TREES	PLANT BED 2	COR FLO 1*	303	909
QUE FAL	10	QUERCUS FALCAT	A / SOUTHERN RED OAK	B & B	1 3/4" - 2"		4` - 5`	3.5" CALIPER FOR STREET TREES**	PLANT BED 3	COR FLO 2*	331	993
	4				0.4/0"				PLANT BED 4	COR FLO 3*	332	996
QUE STE	1	QUERCUS STELLA	TA/POST OAK	B & B	3 1/2"		3` - 5`	3.5" CALIPER FOR STREET TREES**	PLANT BED 5	COR FLO 4*	321	963
TIL AME	9	TILIA AMERICANA	AMERICAN LINDEN	B & B	2"-2 1/2"		3` - 5`	3.5" CALIPER FOR STREET TREES**	PLANT BED 6	COR FLO 5*	300	900
									STREET TREE PLANT BED 1	QUE BIC 1*°	436	1308
ULM PRI	10	ULMUS AMERICAN	A 'PRINCETON' / PRINCETON AMERICAN ELM	B & B	2"-2 1/2"		3` - 5`	3.5" CALIPER FOR STREET TREES**	STREET TREE PLANT BED 2	QUE BIC 2*°	44	132
									STREET TREE PLANT BED 3	ULM PRI 1*°	404	1212
	A N 1-									QUE CIN 1*°	404	1212
I PL		I SCHED	<u>ULE SITE</u>							ULM PRI 2 *°	401	1203
ст трсс	PLANT B	=D	23,537 SF							QUE BIC 3 *°	400	1200
PLANTING		ON SHEET	23,337 36							QUE FAL 1 *°	402	1206
1										ULM PRI 3 *°	400	1200
			14 000 05						STREET TREE PLANT BED 4	QUE CIN 2 °	408	1224
	DETAILS	ON SHEET	11,099 SF							ULM PRI 4 °	400	1200
1 & L602										QUE BIC 4 °	400	1200
			4 222 25							QUE BIC 5 °	400	1200
<u>RETENTIOI</u> E DETAIL 2/		UCTURE - 18" SOIL	1,069 SF						STREET TREE PLANT BED 5	QUE BIC 6 °	420	1260
										QUE BIC 7 °	403	1209
NSIVE PL/		<u>6" SOIL</u>	2,014 SF						STREET TREE PLANT BED 6	QUE STE 1 °	321	963
DETAIL 3/	L602									ULM PRI 5 °	410	1230
										ULM PRI 6 °	440	1320
DRETENTIO		<u>ADE</u>	864 SF						STREET TREE PLANT BED 7	QUE BIC 8 °	403	1209
	· /									QUE BIC 9 °	400	1200
										QUE FAL 2°	454	1362

++++++++++++++++++++++++++++++++++++	<u>STREET TREE PLANT BED</u> SEE PLANTING DETAILS ON SHEET L601 -	23,537 SF
	<u>PLANT BED</u> SEE PLANTING DETAILS ON SHEET L601 & L602 -	11,099 SF
9 / 1 9 / 1 9 / 2 9	BIORETENTION ON-STRUCTURE - 18" SOIL SEE DETAIL 2/L602 -	1,069 SF
	INTENSIVE PLANTER - 36" SOIL SEE DETAIL 3/L602 -	2,014 SF
	BIORETENTION ON-GRADE SEE CIVIL DWG(S) -	864 SF
	INTENSIVE PLANTER - 18" SOIL SEE DETAIL 5/L602 -	117 SF

20-YEAR	TREE CANOPY	COVERAGE	WORK

				-				
KEY	TREE SPECIES	COMMON NAME	PLANTING SIZE HEIGHT (ft.)	CALIPER SIZE AT PLANTING (in.)	SPREAD AT PLANTING (ft.)	CANOPY SIZE	20 YEAR COVERAGE (sq. ft.)	SUBTOTAL COVERAGE (sq. ft.)
COR FLO	CORNUS FLORIDA	FLOWERING DOGWOOD		³ / ₄ "-1"	2-3	MEDIUM	218.75	1,093.75
MAG SWE	MAGNOLIA VIRGINIANA	SWEETBAY MAGNOLIA	6'-7'	³ / ₄ "-1"	3-4	SMALL-MEDIUM	137.50	687.50
QUE BIC	QUERCUS BICOLOR	SWAMP WHITE OAK		1 ³ / ₄ "-2"	4-5	LARGE	393.75	3,937.50
QUE CIN	QUERCUS COCCINEA	SCARLET OAK		1 ³ / ₄ "-2"	4-5	LARGE	393.75	3,543.75
QUE FAL	QUERCUS FALCATA	SOUTHERN RED OAK		1 ³ / ₄ "-2"	4-5	LARGE	393.75	3,543.75
QUE STE	QUERCUS STELLATA	POST OAK		3 ¹ / ₂ "	3-5	MEDIUM-LARGE	312.50	312.50
TIL AME	TILIA AMERICANA	AMERICAN LINDEN		2"-2 ¹ / ₂ "	3-4	LARGE	393.75	3,543.75
ULM PRI	ULMUS AMERICANA 'PRINCETON'	PRINCETON AMERICAN ELM		2"-2 ¹ / ₂ "	3-5	LARGE	393.75	3,150.00
TOTAL TREE QUA	NTITY PROVIDED							
					TOT	AL TREE CANOPY COVE	RAGE PROVIDED	19,812.50
MINIMUM TREE CANOPY COVERAGE REQUIRED (SEE NOTE 1)								17,167
	KEY COR FLO MAG SWE QUE BIC QUE CIN QUE CIN QUE FAL QUE STE TIL AME ULM PRI	KEYTREE SPECIESCOR FLOCORNUS FLORIDAMAG SWEMAGNOLIA VIRGINIANAQUE BICQUERCUS BICOLORQUE CINQUERCUS COCCINEAQUE FALQUERCUS FALCATAQUE STEQUERCUS STELLATATIL AMETILIA AMERICANAULMUS AMERICANAULMUS AMERICANA	KEYTREE SPECIESCOMMON NAMECOR FLOCORNUS FLORIDAFLOWERING DOGWOODMAG SWEMAGNOLIA VIRGINIANASWEETBAY MAGNOLIAQUE BICQUERCUS BICOLORSWAMP WHITE OAKQUE CINQUERCUS COCCINEASCARLET OAKQUE FALQUERCUS FALCATASOUTHERN RED OAKQUE STEQUERCUS STELLATAPOST OAKTIL AMETILIA AMERICANA 'PRINCETON'PRINCETON AMERICAN ELM	KEYTREE SPECIESCOMMON NAMEPLANTING SIZE HEIGHT (ft.)COR FLOCORNUS FLORIDAFLOWERING DOGWOODSIZE HEIGHT (ft.)MAG SWEMAGNOLIA VIRGINIANASWEETBAY MAGNOLIA6'-7'QUE BICQUERCUS BICOLORSWAMP WHITE OAK6'-7'QUE CINQUERCUS COCCINEASCARLET OAKQUE FALQUERCUS FALCATASOUTHERN RED OAK	KEYTREE SPECIESCOMMON NAMESIZE HEIGHT (ft.)CALFER STILG AT PLANTING (in.)COR FLOCORNUS FLORIDAFLOWERING DOGWOOD34"-1"MAG SWEMAGNOLIA VIRGINIANASWEETBAY MAGNOLIA6'-7'34"-1"QUE BICQUERCUS BICOLORSWAMP WHITE OAK134"-2"QUE CINQUERCUS COCCINEASCARLET OAK114"-2"QUE FALQUERCUS FALCATASOUTHERN RED OAK114"-2"QUE STEQUERCUS STELLATAPOST OAK31"TIL AMETILIA AMERICANAAMERICAN LINDEN2"-2 1/2"ULM PRIULMUS AMERICANAPRINCETON ELM2"-2 1/2"TOTAL TREE QUANTITY PROVIDEDTOTAL TREE QUANTITY PROVIDEDSUITHERN PRINCETON2"-2 1/2"	KEYTREE SPECIESCOMMON NAMEPLANTING SIZE HEIGHT (ft.)CALIPER SIZE 	KEYTREE SPECIESCOMMON NAMEPLANTING SIZE HEIGHT (ft.)CALIPER SIZE AT PLANTING (in.)SPREAD AT PLANTING (ft.)CANOPY SIZECOR FLOCORNUS FLORIDAFLOWERING DOGWOOD	KEYTREE SPECIESCOMMON NAMEPLANTING SIZE HEIGHT (ft.)CALIPER SIZE AT PLANTING (in.)SPREAD AT PLANTING (ft.)CANOPY SIZE20 YEAR COVERAGE (sq. ft.)COR FLOCORNUS FLORIDAFLOWERING DOGWOOD3"-1"2-3MEDIUM218.75MAG SWEMAGNOLIA VIRGINIANASWETBAY MAGNOLIA6'-7"3"-1"3-4SMALL-MEDIUM137.50QUE BICQUERCUS BICOLORSWAMP WHITE OAK6'-7"3"-2"4-5LARGE393.75QUE CINQUERCUS COCCINEASCARLET OAK11 3"-2"4-5LARGE393.75QUE FALQUERCUS FALCATASOUTHERN RED OAK13 3"-2"4-5LARGE393.75QUE STEQUERCUS STELLATAPOST OAK13 3"-2"3-5MEDIUM-LARGE312.50TIL AMETILIA AMERICANA PRINCETONAMERICAN ELM2"-2 3"3-4LARGE393.75TOTAL TREE QUAUTITY PROVIDEDTOTAL TREE CANOPY COVERAGE PROVIDED

NOTES:

1. ARLINGTON COUNTY CODE PER CHAPTER 61 CHESAPEAKE BAY PRESERVATION ORDINANCE MINIMUM TREE CANOPY REQUIREMENTS 61-10.C.1.a.: MINIMUM LOT COVERAGE OF TREE CANOPY IS TEN PERCENT (10%). 2. FOR CALIPER, SEE PLANTING SCHEDULE SHEET L402

RKSHEET PER CHESAPEAKE BAY PRESERVATION ORDINANCE


171,665 TOTAL SITE AREA PERCENT OF TREE CANOPY COVERAGE PROVIDED 11.5% PERCENTAGE TREE CANOPY COVERAGE REQUIRED (SEE NOTE 1) 10%

	QUE FAL 3 °	427	1281
	QUE FAL 4 $^{\circ}$	422	1266
	QUE CIN 3 °	457	1371
	QUE CIN 4 °	466	1398
	QUE CIN 5 °	493	1479
TREE PLANT BED 8	TIL AME 2* ⁰	400	1200
	TIL AME 3*°	413	1239
	TIL AME 4*	404	1212
	TIL AME 5*	414	1242
	QUE CIN 6*	416	1248
	QUE CIN 7*	470	1410
	QUE CIN 8*	440	1320
	QUE CIN 9*	406	1218
	QUE FAL 5*	403	1209
	QUE FAL 6*	400	1200
	QUE FAL 7*	422	1266
	TIL AME 6*	423	1269
	TIL AME 7*	401	1203
	TIL AME 8*	402	1206
	TIL AME 9*	406	1218
	ULM PRI 7*	403	1209
TREE PLANT BED 9	QUE BIC 10* ^o	400	1200
	QUE FAL 8*°	400	1200
REE PLANT BED 10	QUE FAL 9* ⁰	400	1200
	ULM PRI 8*°	400	1200
REE PLANT BED 11~	QUE ALB 1*°	400	1200
	ULM PRI 9*°	400	1200
	QUE ALB 2*°	400	1200
REE PLANT BED 12~	QUE ALB 3*°	400	1200
	QUE CIN 10*°	400	1200
	ULM PRI 10*°	400	1200
	QUE FAL 10*°	400	1200
	QUE ALB 4*°	400	1200
REE PLANT BED 13~	QUE ALB 5* ⁰	400	1200

INDICATES TREE BED WILL NEED SOIL EXPANSION TECHNOLOGY TO REACH REQUIRED SOIL VOLUME. FINAL LOCATION TO BE CONFIRMED AT LANDSCAPE PLAN. o INDICATES STREET TREE OF 3.5" CALIPER MIN. PER SCHEDULE.

~ INDICATES PLANT BEDS WITH PROPOSED STREET TREES LOCATED OUTSIDE OF SITE PROPERTY LINE THAT WILL NOT COUNT TOWARDS TREE CANOPY CREDIT.

Data Data Description 200 S. PEYTON STREET DRAWN CT CHECKED: GC 201 S. S49-7784 WWW.LANDDESIGN.com DRAWN CT		
4600 FAIRFAX DRIVE	4.1 SITE PLAN COUNTY BOARD SUBMISSION	ARLINGTON COUNTY, VIRGINIA
SUBMISS NO. DESCRIPTION 4.1 SITE PLAN SUBMIS 4.1 SITE PLAN SUBMIS 4.1 SITE PLAN ACCEPT 4.1 SITE PLAN ACCEPT 4.1 SITE PLAN RESUBN COUNTY BOARD SUBN COUNTY BOARD SUBN SCALE: SHEET TITLE: PLANTING SCHEDULE TABULATIONS SHEET #: L402	SION ANCE CCEPTANCE /IISSION /IISSION	DATE 2021-11-23 2022-01-25 2022-05-23 2022-12-23 2023-05-17

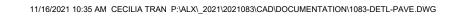



NOTES:






NTS


1. IMAGE FOR DESIGN INTENT ONLY 2. OR APPROVED EQUAL





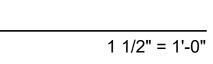



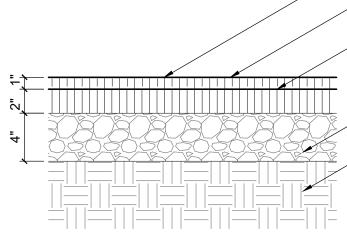

ASPHALT PAVING

- COMPACTED AGGREGATE BASE - COMPACTED SUB-BASE, 95% PROCTOR OR BETTER - TO BE VERIFIED BY A QUALIFIED LAB

- ASPHALT CONCRETE BASE, AS SPECIFIED

- RESILIENT TOPPING, AS SPECIFIED

- SAW-CUT CONTROL JOINT, TYP.

– SURFACE FINISH, AS SPECIFIED


- POLYETHYLENE VAPOR BARRIER

- COMPACTED AGGREGATE BASE

- REINFORCED CONCRETE SLAB, (SEE STRUCT.)

COMPACTED SUB-BASE, 95% PROCTOR OR BETTER - TO BE VERIFIED BY A QUALIFIED LAB

- FINISHED GRADE; SEE GRADING PLANS

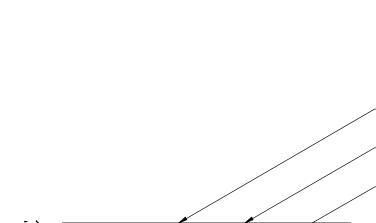



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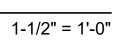
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L501 SECTION

L501 SECTION





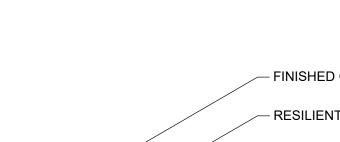


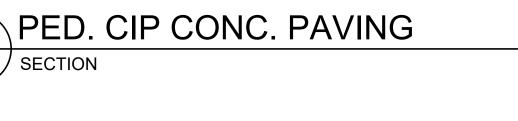

6 PATH LIGHT BOLLARD L501 / PICTORIAL



NOTES: 1. IMAGE FOR DESIGN INTENT ONLY 2. OR APPROVED EQUAL

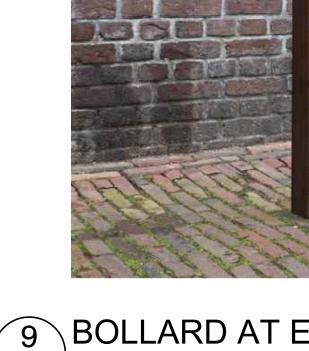


L501 / PICTORIAL



NTS

8 PERMEABLE F L501 SECTION

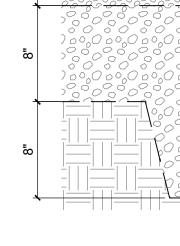





NOTES: 1. IMAGE FOR DESIGN INTENT ONLY 2. OR APPROVED EQUAL

NOTES BEDDING COURSE TO CONSIST OF 2. SEPARATION COURSE TO CONSIST OPEN GRADED BASE TO CONSIST C
 JOINT MATERIAL TO BE 1/4"-3/8" CRU



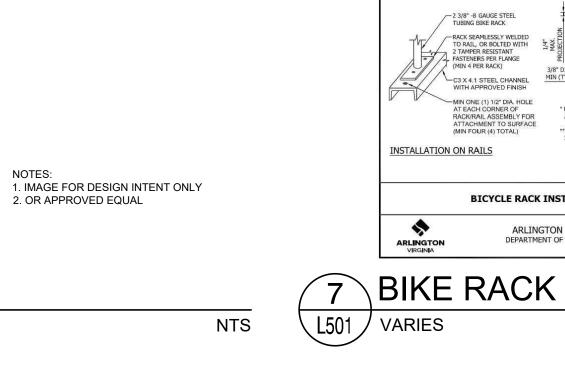


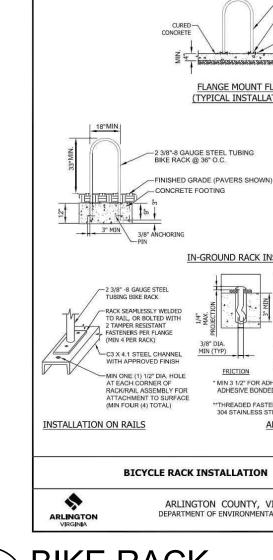




4 COMPACTED AGGREGATE PAVING

238'S GAUGE STEEL TUBING INCROMENSA SS PECIFICI INTERNASS OF CARGE INTERNASS INTERNASS OF THICK FLANGE INTE INTERNASS OF THI	Landbesign.	200 S. PEYTON STREET ALEXANDRIA, VA 22314 (703) 549-7784	www.LANDDESIGN.com
Image:	4600 FAIRFAX DRIVE	4.1 SITE PLAN COUNTY BOARD SUBMISSION	ARLINGTON COUNTY, VIRGINIA
NULL ENTER	SHEET #: SHEET #: SHEET #: L501	SSION 2 TANCE 2 ACCEPTANCE 2 MISSION 2 MISSION 2	DATE 021-11-23 022-01-25 022-05-23 022-12-23 023-05-17

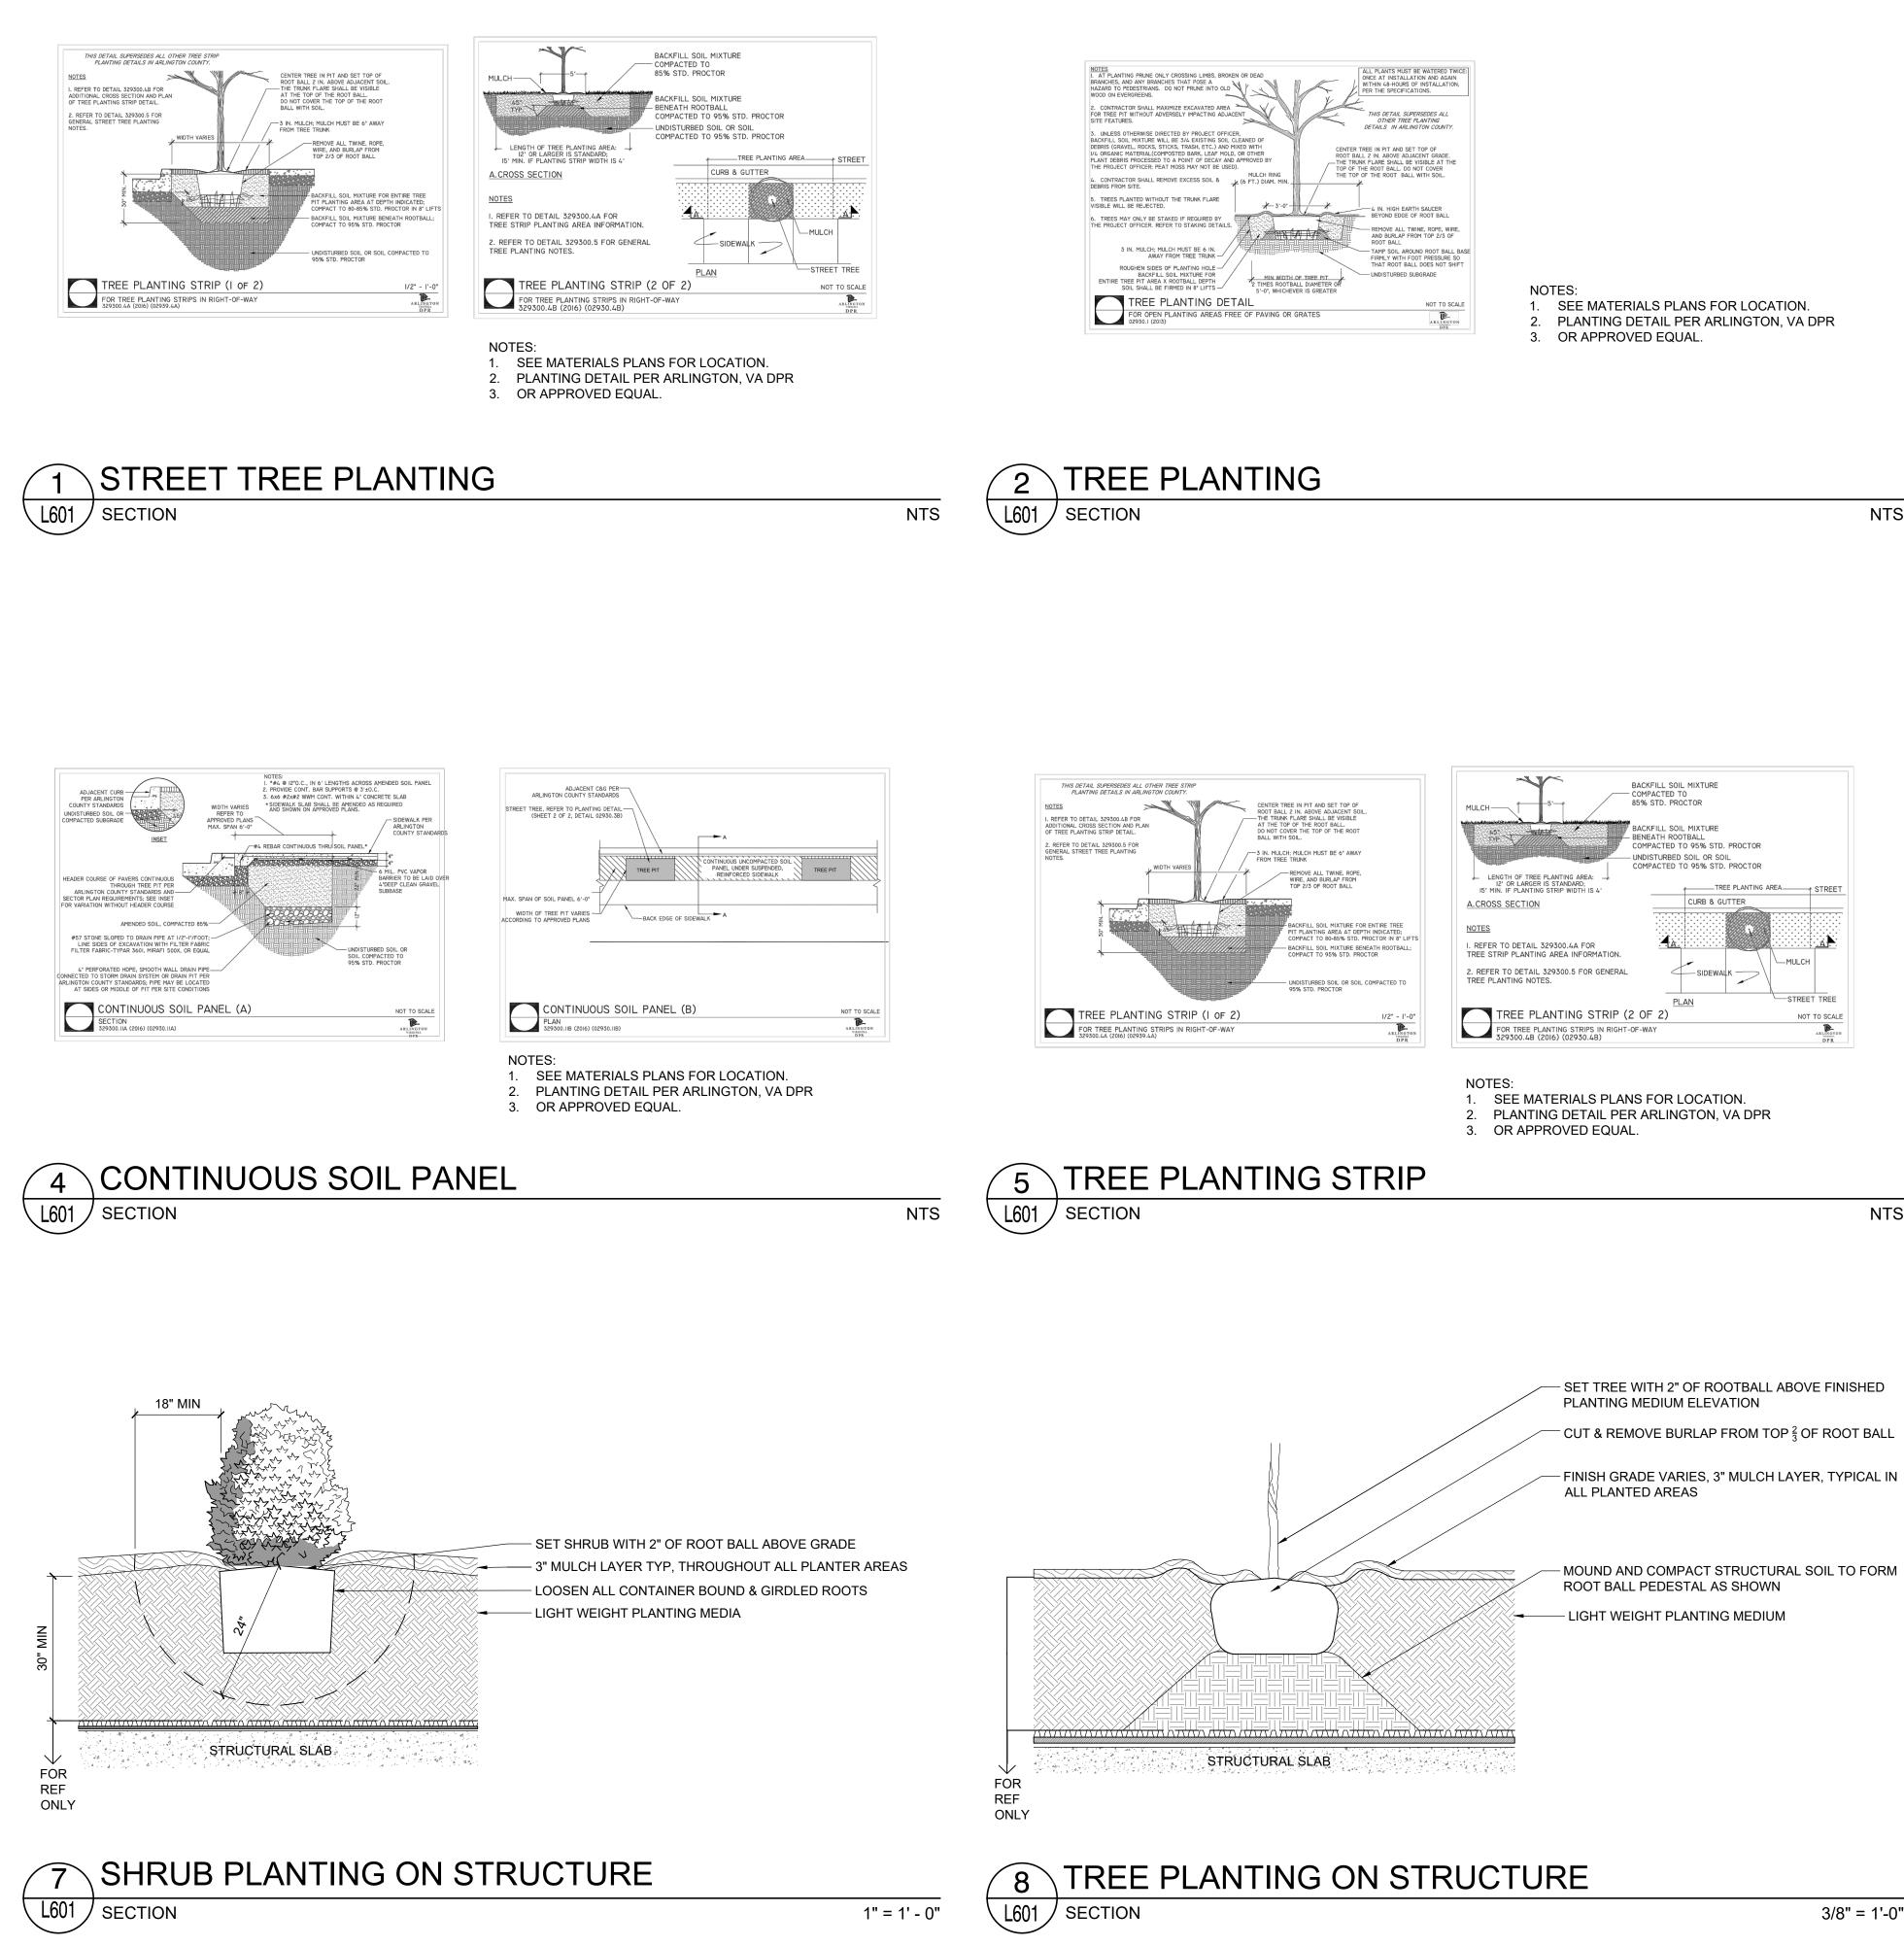

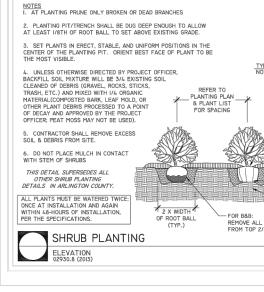

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PLACE TOP I/8 OF ROOT BALL ABOVE FINISHED GRADE (TYP.) 3° MULCH OVER ENTIRE SHRUB BED FINISHED GRADE BACKFILL SOLI MIXTURE (TYP.) FOR CONTAINER: LOOSEN THE ROOT BALL OF ANY ROOT BOUND PLANTS UNDISTUREED SUBGRADE OR COMPACTED SACKFILL SOLI MIXTURE TWINE, ROPE, WIRE, AND BURLAP S OF ROOT BALL NOT TO SCALE
LOOSEN THE ROOT BALL OF ANY ROOT BOUND PLANTS UNDISTURBED SUBGRADE OR COMPACTED BACKFILL SOIL MIXTURE TWINE, ROPE, WIRE, AND BURLAP S OF ROOT BALL NOT TO SCALE
ARLINGTON
ARLINGTON
DPR

NOTES: 1. SEE MATERIALS PLANS FOR LOCATION.


2. PLANTING DETAIL PER ARLINGTON, VA DPR 3. OR APPROVED EQUAL.

NTS

NOT	E:
1.	THESE DOCUMENTS ARE REFERENCED
	FROM "ARLINGTON COUNTY DESIGN
	STANDARDS, DPR"

Landbesign	200 S. PEYTON STREET ALEXANDRIA, VA 22314 200 S. PEYTON STREET DATE: 2023-05-17	(703) 349-7784 www.LANDDESIGN.com
4600 FAIRFAX DRIVE	4.1 SITE PLAN COUNTY BOARD SUBMISSION	ARLINGTON COUNTY, VIRGINIA
SUBMIS NO. DESCRIPTION 4.1 SITE PLAN SUBMI 4.1 SITE PLAN ACCEF 4.1 SITE PLAN POST / 4.1 SITE PLAN RESUE COUNTY BOARD SUB	SSION PTANCE ACCEPTANCE BMISSION	DATE 2021-11-23 2022-01-25 2022-05-23 2022-12-23 2023-05-17
SCALE: SHEET TITLE: DETAILS - PLANTING SHEET #: L601		

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1" = 1' - 0"

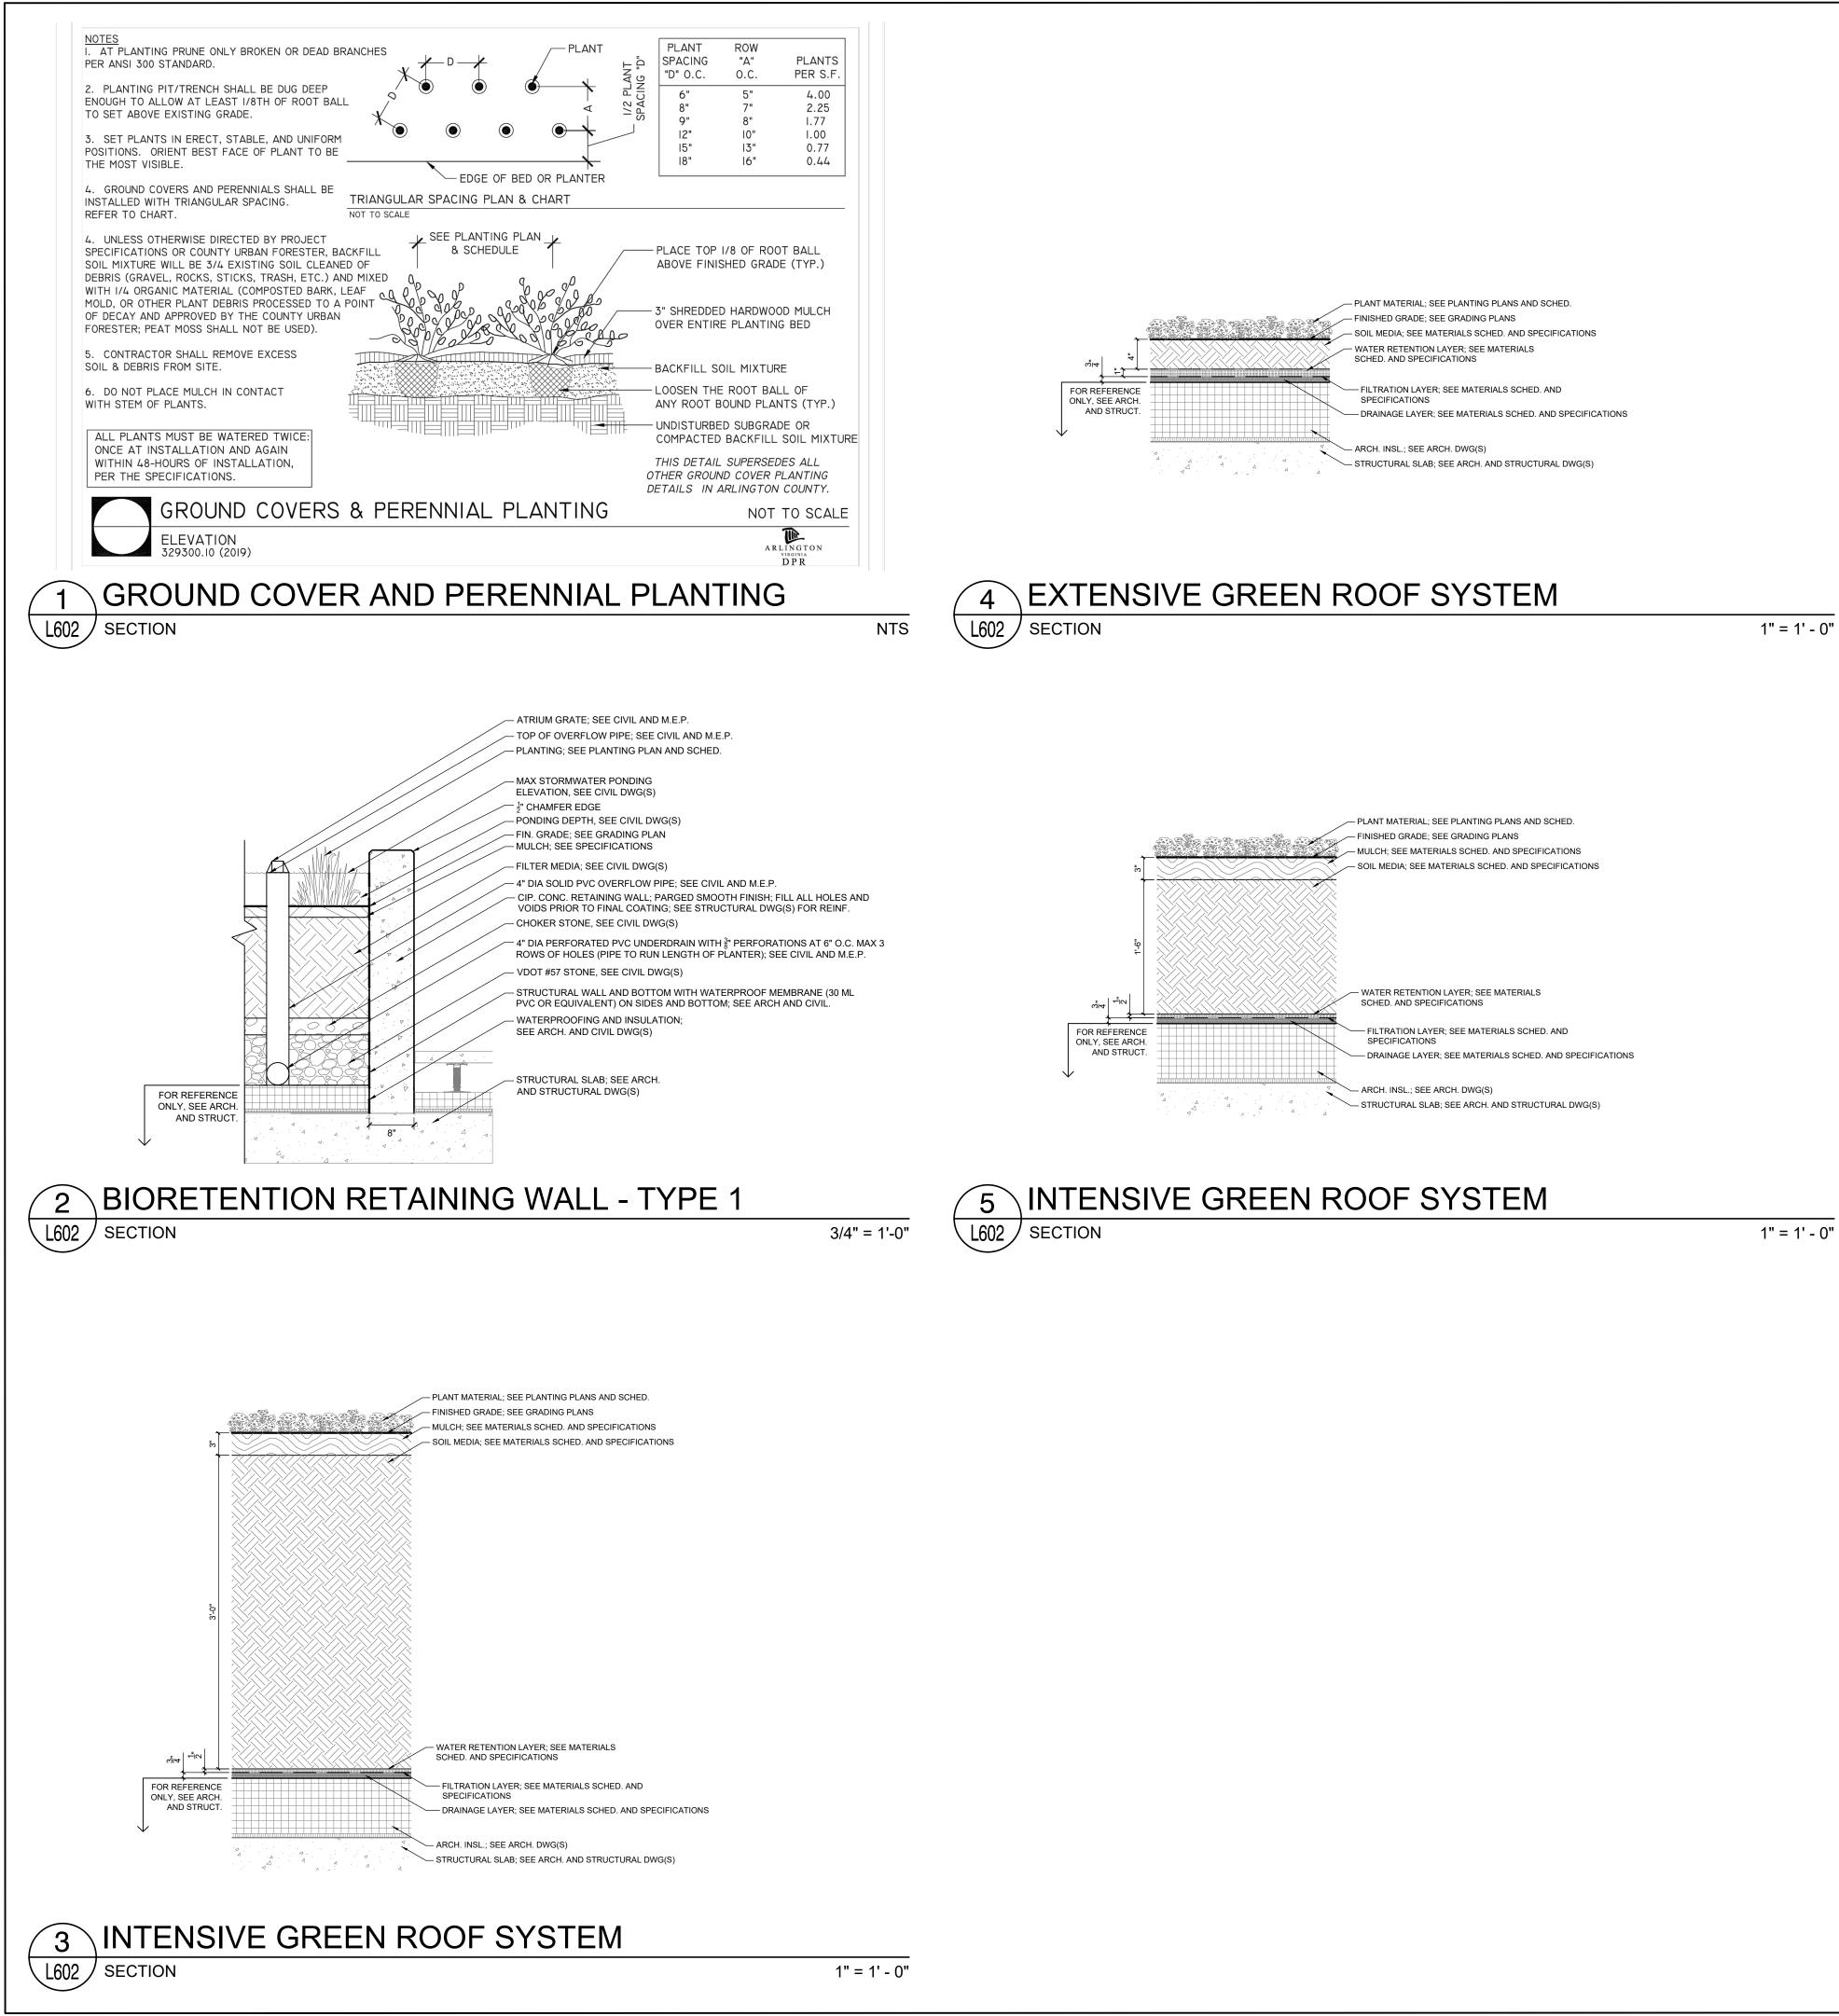Landbesign.	200 S. PEYTON STREET ALEXANDRIA, VA 22314 200 S. PEYTON STREET DATE: 2023-05-17	(703) 249-7784 www.LANDDESIGN.com
4600 FAIRFAX DRIVE	4.1 SITE PLAN COUNTY BOARD SUBMISSION	ARLINGTON COUNTY, VIRGINIA
SUBMISSIONSNO.DESCRIPTIONDATE4.1 SITE PLAN SUBMISSION2021-11-234.1 SITE PLAN ACCEPTANCE2022-01-254.1 SITE PLAN ACCEPTANCE2022-05-234.1 SITE PLAN RESUBMISSION2022-12-234.1 SITE PLAN RESUBMISSION2023-05-174.1 SITE PLAN RESUBMISSION2023-05-17COUNTY BOARD SUBMISSION2023-05-17Image: SCALE:Image: State Stat		
SHEET #: L602		

Landscape Plan Notes and Details

LANDSCAPE AND PLANTING NOTES

- MATERIAL SHALL BE FURNISHED AND INSTALLED AS INDICATED ON PLANS, INCLUDING ALL LABOR, MATERIALS, PLANTS, EQUIPMENT, INCIDENTALS, AND CLEAN-UP.
- GRADING AND PLANTING OPERATIONS SHALL BE PERFORMED DURING PERIODS WHEN WEATHER AND SOIL 2. CONDITIONS ARE SUITABLE, AND IN ACCORDANCE WITH ACCEPTED LOCAL PRACTICE AND STANDARDS. THE ACCEPTABLE PLANTING RANGE IS FROM MARCH-JUNE 15 AND SEPTEMBER-DECEMBER, FOR NON-TREE MATERIAL, AND OCTOBER - JUNE 15 FOR TREES. PLANTS SHALL NOT BE INSTALLED IN TOPSOIL THAT IS MUDDY OR FROZEN. CARE SHALL BE TAKEN TO PROVIDE PLANTS WITH ENOUGH WATER TO COMBAT HEAT STRESS DURING HOT/DRY WEATHER.
- ALL LAWN AND PLANTING AREAS SHALL BE GRADED TO A SMOOTH, EVEN, AND UNIFORM PLANE WITH 3. NO ABRUPT CHANGE OF SURFACE UNLESS OTHERWISE DIRECTED BY THE LANDSCAPE ARCHITECT OR REPRESENTATIVE. SOIL AREAS ADJACENT TO BUILDINGS SHALL SLOPE AWAY FROM BUILDING. ALL PLANTING AREAS SHALL BE GRADED AND MAINTAINED TO ALLOW FREE FLOW OF SURFACE WATER. CONTRACTOR SHALL REPORT ANY SOIL OR DRAINAGE CONDITIONS CONSIDERED DETRIMENTAL TO GROWTH OF PLANT MATERIAL.
- THE CONTRACTOR SHALL BE RESPONSIBLE FOR PLANTING AT CORRECT GRADES AND ALIGNMENT PER APPROVED 4. PLANS, NO TREES SHALL BE PLANTED LESS THAN TWO FEET FROM EXISTING STRUCTURES AND SIDEWALKS. LAYOUT OF PLANTS SHALL BE APPROVED BY LANDSCAPE ARCHITECT OR REPRESENTATIVE PRIOR TO INSTALLATION.
- 5. PLANTS SHALL BE TYPICAL OF THEIR SPECIES AND VARIETY, HAVE NORMAL GROWTH HABITS, WELL-DEVELOPED DENSELY FOLIATED BRANCHES, VIGOROUS ROOT SYSTEMS, AND BE FREE FROM DEFECTS AND INJURIES. QUALITY AND SIZE OF PLANTS, SPREAD OF ROOTS AND SIZE OF ROOTBALL SHALL BE IN ACCORDANCE WITH THE MOST RECENT VERSION OF ANSI "AMERICAN STANDARD FOR NURSERY STOCK" PUBLISHED BY THE AMERICAN ASSOCIATION OF NURSERYMEN, INC.
- ALL PLANT MATERIAL SHALL BE GUARANTEED BY THE INSTALLER TO BE IN VIGOROUS GROWING CONDITION. 6. PROVISION SHALL BE MADE FOR A GROWTH GUARANTEE OF AT LEAST ONE YEAR FROM THE DATE OF ACCEPTANCE FOR ALL PLANT MATERIAL. REPLACEMENTS SHALL BE MADE AT THE BEGINNING OF THE FIRST SUCCEEDING PLANTING SEASON. ALL REPLACEMENTS SHALL HAVE A GUARANTEE EQUAL TO THAT STATED ABOVE.
- PLANT MATERIAL SHALL BE PLANTED ON THE DAY OF DELIVERY IF PRACTICAL. IF THIS IS NOT POSSIBLE, THE 7. CONTRACTOR SHALL PROTECT STOCK NOT PLANTED. PLANTS SHALL NOT REMAIN UNPLANTED FOR LONGER THAN A THREE-DAY PERIOD AFTER DELIVERY. ANY PLANTS NOT INSTALLED DURING THIS PERIOD SHALL BE REJECTED, UNLESS OTHERWISE DIRECTED BY THE ARLINGTON COUNTY LANDSCAPE ARCHITECT OR REPRESENTATIVE.
- 8. ALL INJURED ROOTS SHALL BE PRUNED USING ANSI A300 STANDARDS.
- CONTRACTOR SHALL PROVIDE 4 IN. MINIMUM THICK TOPSOIL LAYER IN ALL PLANTING AREAS. TOPSOIL SHALL 9. BE FREE OF WEEDS, DEBRIS, ROCKS LARGER THAN 2 IN., WOOD, ROOTS, VEGETABLE MATTER, AND CLAY CLODS. CLEAN, FERTILE TOPSOIL PRESENT AT THE SITE, IF ANY, MAY BE USED TO SUPPLEMENT TOTAL AMOUNT REQUIRED.

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Landscape Plan Notes and Details

County Standards Details

Certain Arlington County standard details must be shown on landscape and tree preservation plans, depending on the project. The standard details can be found on the webpages below:


Department of Parks and Recreation Design Standards

Department of Environmental Services Infrastructure Design Standards

Department of Environmental Servies Bicycle Parking Standards

What details are required will depend on the elements of each specific project, but typically, the most relevant details for tree preservation and landscape plans include:

- Tree Protection and Trimming Details
- Exterior Plants
- Horizontal Standards sidewalks, curb ramps, crosswalks, street lights
- Bicycle Parking

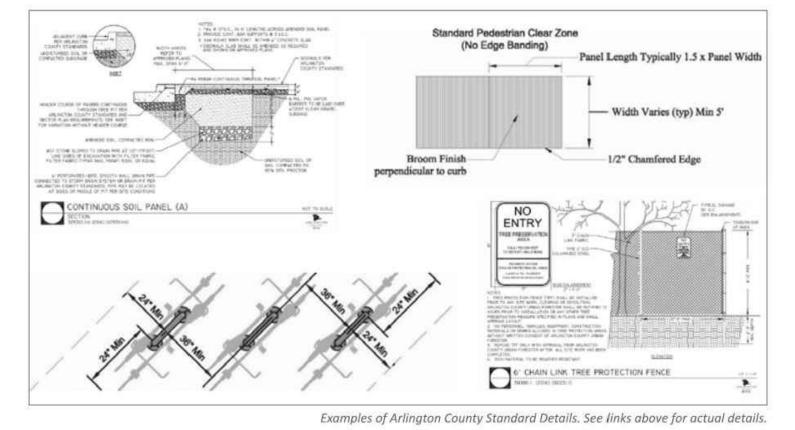

Landscape Plan Notes and Details

- SHARP TOOLS. MAINTENANCE AND WARRANTY PERIOD.
- CONDITION.

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10. PLANTING PITS SHALL BE DUG PER COUNTY DETAILS. SET PLANTS PLUMB AND STRAIGHT, WITH ROOT FLARES SLIGHTLY ABOVE GRADE, DO NOT COVER THE ROOT FLARE WITH SOIL OR MULCH, BACKFILL PLANTING PITS WITH AMENDED TOPSOIL, AND THOROUGHLY WATER AND TAMP AS BACK-FILLING PROGRESSES. WATER AGAIN TO ACHIEVE SOIL SATURATION IMMEDIATELY FOLLOWING PLANTING.

- 11. PLANTS SHALL NOT BE BOUND WITH WIRE OR ROPE AT ANY TIME, SO AS NOT TO DAMAGE THE BARK OR BREAK BRANCHES. PLANTS SHALL BE HANDLED FROM THE BOTTOM OF THE ROOT BALL ONLY.
- 12. EACH TREE AND SHRUB SHALL BE PRUNED IN ACCORDANCE WITH ANSI A300: STANDARDS FOR TREE CARE PRACTICES, TO PRESERVE THE HEALTH AND APPEARANCE OF THE PLANT. PRUNING SHALL BE DONE WITH CLEAN,
- 13. TREES SHALL BE SUPPORTED AFTER PLANTING ONLY AS DIRECTED BY THE URBAN FORESTER. IF INSTALLED, THE LANDSCAPE CONTRACTOR SHALL REMOVE STAKING, GUYING AND TREE WRAP AT THE END OF THE ONE-YEAR
- 14. ALL PLANTING BEDS SHALL BE MULCHED WITH A 3 IN. LAYER OF WEED-FREE DOUBLE SHREDDED HARDWOOD BARK MULCH, OR OTHER EQUIVALENT AS APPROVED BY THE LANDSCAPE ARCHITECT OR REPRESENTATIVE. KEEP MULCH AWAY FROM TRUNKS OF TREES AND OTHER PLANT MATERIALS.
- 15. NEW PLANTINGS AND TURF SHALL BE ADEQUATELY IRRIGATED OR WATERED THROUGHOUT ESTABLISHMENT.
- 16. UPON COMPLETION OF ALL PLANTING AND BEFORE FINAL ACCEPTANCE, THE CONTRACTOR SHALL REMOVE ALL MATERIAL, EQUIPMENT AND DEBRIS. ALL PAVED AREAS SHALL BE BROOM-SWEPT AND LEFT IN A NEAT

17. URBAN FORESTER NOTIFICATION: THE DEVELOPER AGREES TO NOTIFY THE URBAN FORESTER AT LEAST 72 HOURS IN ADVANCE OF THE INSTALLATION OF DRAINAGE, SPECIAL SOIL EXPANSION EQUIPMENT, TREE PIT CREATION, AND SCHEDULED PLANTING OF ANY TREES IN THE PUBLIC RIGHT OF WAY, AND TO BE AVAILABLE AT THE TIME OF PLANTING TO MEET WITH DPR STAFF TO INSPECT THE PLANT MATERIAL, TREE PIT AND PLANTING TECHNIQUES. SOIL USED IN THE TREE PIT MUST MEET THE SPECIFICATIONS FOR STREET TREE PLANTING IN THE "STANDARDS FOR PLANTING AND PRESERVATION OF TREES ON SITE PLAN PROJECTS" AVAILABLE FROM THE URBAN FORESTER.

Landscape Plan Notes and Details

LANDSCAPE MAINTENANCE MANAGEMENT PROGRAM

GENERAL:

A. ALL PLANTING AREAS, INCLUDING LAWNS, BUFFERS, AND PARKING LOTS, SHALL BE PERIODICALLY INSPECTED A MINIMUM OF ONCE PER MONTH. A FALL CLEAN-UP SHALL BE PERFORMED EACH YEAR. B. REMOVE ALL LITTER, DEBRIS AND WEEDS. C. MAINTAIN A MINIMUM OF A 2 INCH DEPTH OF ORGANIC HARDWOOD MULCH OR EQUIVALENT IN ALL PLANTING BEDS.

- IRRIGATION:
- A. KEEP NEW TURF MOIST UNTIL ALL SEED GERMINATES AND BECOMES AN ESTABLISHED STAND OF TURF. B. AUTOMATIC SPRINKLERS SHALL BE CLEANED OUT AND TURNED OFF IN THE FALL PRIOR TO THE FIRST FROST, AND TESTED WHEN TURNED ON IN THE SPRING. C. EVALUATE SUCCESS OF IRRIGATION SYSTEM AND MODIFY AS NECESSARY.
- PRUNING: ALL PRUNING SHALL BE DONE IN ACCORDANCE WITH ANSI PRUNING STANDARDS. REMOVAL OF DEAD, DISEASED, INSECT INFESTED OR WEAK WOOD SHALL TAKE PLACE WHEN APPROPRIATE FOR THE SPECIES. THE VIRGINIA TECH PRUNING CALENDAR SHALL BE USED FOR GUIDANCE ON APPROPRIATE TIMING. EXCESSIVE SHOOTS AND SUCKERS SHALL BE REMOVED.
- INSECT AND DISEASE CONTROL: THE CONTROL OF INSECTS AND DISEASE ASSOCIATED WITH ALL PLANTING 4 AREAS SHALL BE A MAINTENANCE PRIORITY. ALL PLANTINGS, INCLUDING EXISTING MATURE TREES, SHALL BE PERIODICALLY INSPECTED FOR INSECT OR DISEASE INFESTATION. METHODS USED TO CONTROL INSECTS OR DISEASE MAY RANGE FROM SPRAYING AND PRUNING TO PLANT REMOVAL. SAFETY AND CONTROL SHALL BE OF PRIME CONCERN. TRAINED AND CERTIFIED PERSONNEL SHALL PERFORM THESE TASKS.
- **RENOVATION:** 5.

A. RENOVATION INCLUDES THE RESEEDING OR REPLANTING OF LANDSCAPE AREAS DAMAGED, DESTROYED OR FAILING DUE TO INSECTS, DISEASE, WEATHER OR PHYSICAL DAMAGE. B. ALL LAWN AREAS WHERE SOIL HAS BEEN EXPOSED SHALL BE RENOVATED DURING THE NEXT PLANTING SEASON. PROPER HORTICULTURAL AND SOIL EROSION PREVENTION METHODS SHALL BE USED. IF SOIL EROSION HAS OCCURRED, THE AREA SHALL BE REPAIRED WITH A SEED MIXTURE COMPATIBLE WITH EXISTING SOIL. C. ALL PLANTINGS WHICH ARE DAMAGED OR DESTROYED SHALL BE REPLACED DURING OR BEFORE THE NEXT

GROWING SEASON.

D. CARE SHALL BE TAKEN TO AVOID DAMAGE TO ESTABLISHED TREE ROOTS DURING RENOVATION OF LANDSCAPE

- 6. SITE AMENITIES: BENCHES, PATHS, BICYCLE RACKS, TRASH RECEPTACLES, AND SIGNS SHALL BE INSPECTED AT LEAST TWICE A YEAR, ONCE IN SPRING AND ONCE IN AUTUMN, TO DETERMINE THEIR CONDITION. ANY DAMAGED, WORN, OR UNSAFE CONDITIONS SHALL BE RECTIFIED IMMEDIATELY.
- PAVED SURFACES:

A. ALL PAVED SURFACES SHALL BE INSPECTED ON A MONTHLY-BASIS FOR TRASH, STAINS, DAMAGE, CRACKS, POT HOLES, AND OBSTRUCTIONS, AND RETURNED TO THEIR ORIGINAL CONDITIONS. ANY UNSAFE CONDITIONS, SUCH AS UNEVEN SURFACES OR TRIPPING HAZZARDS, SHALL BE RECTIFIED IMMEDIATELY.

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THESE DOCUMENTS ARE REFERENCED FROM "ARLINGTON COUNTY LANDSCAPE STANDARDS, DECEMBER 2017 EDITION"

LandDesign	200 S. PEYTON STREET ALEXANDRIA, VA 22314 (703) 549-7784	www.LANDDESIGN.com
4600 FAIRFAX DRIVE	4.1 SITE PLAN COUNTY BOARD SUBMISSION	ARLINGTON COUNTY, VIRGINIA
SUBMISSIONS NO. DESCRIPTION DATE 4.1 SITE PLAN SUBMISSION 2021-11-23 4.1 SITE PLAN SUBMISSION 2022-01-25 4.1 SITE PLAN ACCEPTANCE 2022-02-23 4.1 SITE PLAN POST ACCEPTANCE 2022-05-23 4.1 SITE PLAN RESUBMISSION 2022-12-23 COUNTY BOARD SUBMISSION 2022-12-23 COUNTY BOARD SUBMISSION 2023-05-17 SCALE: SHEET TITLE: PLANTING NOTES SHEET #: L603 L603		