

NOTES:

1. THE SUBJECT PROPERTY IS IDENTIFIED ON ARLINGTON COUNTY REAL PROPERTY IDENTIFICATION MAP NO. 044-11 AS REAL PROPERTY CODE (RPC) 17-027-008, WHICH IS ZONED RA6-15.
2. THE SUBJECT PROPERTY IS LOCATED IN ZONE "X" AS SHOWN ON THE FEDERAL EMERGENCY MANAGEMENT AGENCY, FLOOD INSURANCE RATE MAP (FIRM), COMMUNITY PANEL NO. 510130039C, FOR ARLINGTON COUNTY, VA, DATED AUGUST 19, 2013. ZONE "X" IS NOT IDENTIFIED AS A "SPECIAL FLOOD HAZARD ZONE AREA."
3. THE HORIZONTAL DATUM SHOWN HEREON IS REFERENCED TO VIRGINIA COORDINATE SYSTEM OF 1983 (VCS83) NORTH ZONE.
4. THE VERTICAL DATUM SHOWN HEREON IS REFERENCED TO THE NORTH AMERICAN VERTICAL DATUM OF 1988 (NAVD88).
5. THE HORIZONTAL AND VERTICAL DATUMS SHOWN HEREON ARE BASED ON A GPS SURVEY PERFORMED BY VIKI VIRGINIA, LLC ON MARCH 15, 2022.
6. BOUNDARY INFORMATION SHOWN HEREON IS BASED UPON A FIELD RUN SURVEY BY VIKI VIRGINIA, LLC. THE SURVEY CONTROL ESTABLISHED BY VIKI VIRGINIA, LLC AND USED TO DETERMINE THE BOUNDARY HAS A HORIZONTAL PRECISION OF 1:70,208 WHICH EXCEEDS THE MINIMUM HORIZONTAL PRECISION OF 1:20,000 AS REQUIRED BY THE COMMONWEALTH OF VIRGINIA.
7. FIRST AMERICAN TITLE INSURANCE COMPANY ALTA COMMITMENT FOR TITLE INSURANCE, COMMITMENT NO. VA-21-3199A (REVISION 1) WITH AN EFFECTIVE DATE OF NOVEMBER 29, 2021 AT 8:00 AM HAS BEEN INCORPORATED INTO THIS SURVEY. ALL KNOWN PLOTTABLE EASEMENTS OF RECORD ARE SHOWN HEREON.
8. CONTOUR INTERVAL SHOWN HEREON IS 2'-0".
9. THE AVERAGE SITE ELEVATION TAKEN AT THE PERIMETER OF THE SUBJECT PROPERTY IS 111.14'.
10. ELEVATION HEIGHT CALCULATIONS FOR THE SUBJECT PROPERTY ARE BASED UPON THE VERTICAL DIFFERENCE BETWEEN THE ROOF ELEVATION AND THE AVERAGE SITE ELEVATION (111.14').
11. THE SUBJECT PROPERTY IS NOT LOCATED WITHIN A HISTORIC DISTRICT PER ARLINGTON COUNTY HISTORIC SITES AND DISTRICTS MAP ACCESSSED SEPTEMBER 14, 2022.
12. THE SUBJECT PROPERTY DOES NOT LIE IN A RESOURCE PROTECTION AREA (RPA) PER ARLINGTON COUNTY RESOURCE PROTECTION AREAS MAP ACCESSSED SEPTEMBER 14, 2022.
13. UTILITIES SHOWN HEREON ARE BASED UPON: SUE QUALITY LEVEL B (QL-B) - FIELD SURVEY UTILIZING SURFACE GEOPHYSICAL TECHNIQUES TO DETERMINE THE EXISTENCE AND APPROXIMATE HORIZONTAL POSITION OF UNDERGROUND UTILITIES WITHIN THE AREA OF INTEREST. UTILITIES LOCATED OUTSIDE THE AREA OF INTEREST ARE QL-C OR QL-D. GRAVITY DEPENDENT UTILITY SYSTEMS (STORM AND SANITARY SEWERS) SHOWN HEREON ARE NOT INCLUDED IN THE QL-B SURVEY; FIELD SURVEY OF VISIBLE ABOVE-GROUND UTILITY FACILITIES, SUCH AS MANHOLES, VALVE BOXES, POSTS, ETC., IN ADDITION TO EXISTING UTILITY RECORDS.

LEGEND:

	BUILDING LINE		ELECTRICAL MANHOLE		STORM DRAIN MANHOLE		TREE
	CABLE TV CONDUIT		ELECTRICAL JUNCTION BOX		CATCH BASIN RIM		HANDICAP
	ELECTRICAL CONDUIT		GUY POLE		INLETS		PARKING METER
	EDGE OF PAVEMENT		LIGHT POLE		CURB INLET		HVAC UNIT
	FENCE LINE		GROUND LIGHT		SANITARY MANHOLE		UNKNOWN UTILITY MANHOLE
	NATURAL GAS CONDUIT		UTILITY POLE		SANITARY CLEANOUT		WATER METER
	OVERHEAD WIRES		PHONE MANHOLE		WATER MANHOLE		WATER VALVE
	TELECOM CONDUIT		PHONE PEDESTAL		FIRE HYDRANT		FIRE DEPARTMENT CONNECTION
	PROPERTY LINES		CABLE TELEVISION PEDESTAL		GAS VALVE		IRRIGATION CONTROL VALVE
	PUBLIC UTILITIES EASEMENTS		GAS MANHOLE		GAS MARKER		TRAFFIC CONTROL BOX
	SANITARY SEWER CONDUIT		TRAFFIC SIGNAL POLE		SIGN POST		WOOD POST
	STORM DRAIN CONDUIT		IRON PIPE FOUND		REBAR FOUND		PKNAL FOUND
	WATER CONDUIT		DRILL HOLE FOUND		CONC		C&G

ZONING AREA TABULATION:

LOT 11	6,138 SF OR 0.14091 AC	EXISTING ZONE: RA6-15
LOT 12	5,275 SF OR 0.12109 AC	EXISTING ZONE: RA6-15
LOT 13	4,575 SF OR 0.10503 AC	EXISTING ZONE: RA6-15
LOT 14	4,062 SF OR 0.09325 AC	EXISTING ZONE: RA6-15
TOTAL AREA	20,050 SF OR 0.46028 AC	EXISTING ZONE: RA6-15

AREA TABULATION:

RPC NO. 17-027-008 20,050 SF OR 0.46028 AC


PARKING TABULATION:

STANDARD STRIPED PARKING SPACES	31
HANDICAP STRIPED PARKING SPACES	0
TOTAL STRIPED PARKING SPACES ON SITE	31

* PARKING SPACES SHOWN HEREON ARE BASED ON FIELD LOCATIONS AND VISUAL INSPECTION. VIKI VIRGINIA, LLC DOES NOT CERTIFY THAT SPACES ARE STRIPED IN ACCORDANCE WITH REQUIRED JURISDICTIONAL STANDARDS.

LEGAL DESCRIPTION:

THE LAND REFERRED TO HEREIN BELOW IS SITUATED IN THE COUNTY OF ARLINGTON, COMMONWEALTH OF VIRGINIA, AND IS DESCRIBED AS FOLLOWS:
 LOTS NUMBERED 11, 12, 13 AND 14 IN BLOCK 6, FORT MYER HEIGHTS SUBDIVISION, AS THE SAME APPEARS DULY DEDICATED, PLATTED AND RECORDED ACCORDING TO THE ORIGINAL PLAT IN LIBER N. NO. 4 AT PAGES 322 AND 323, AS AMENDED BY PLAT IN LIBER N. NO. 4, AT PAGES 50 AND 51, AMONG THE LAND RECORDS OF ARLINGTON COUNTY, VIRGINIA.

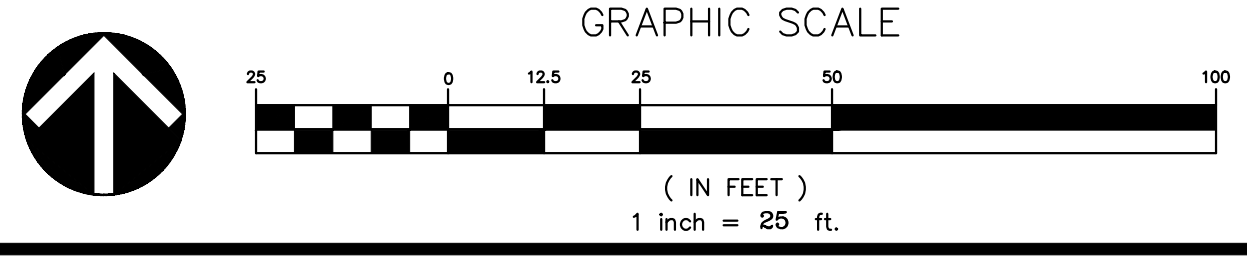

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PLAN STATUS

PLAN STATUS	DATE
1st 4.1 SUBMISSION	10/19/2022
2nd 4.1 SUBMISSION	01/13/2023

POST-APPROVAL SHEET STATUS

POST-APPROVAL SHEET STATUS	DATE

PROFESSIONAL SEAL



1601 FAIRFAX DRIVE
 4.1 SITE PLAN

ARLINGTON COUNTY, VIRGINIA

CERTIFIED SURVEY

DRAWN BY:	LMG
DESIGNED BY:	SURVEYS
DATE ISSUED:	10/19/2022
DWG. SCALE:	1" = 25'
VTKA NO.:	VV8348C
SHEET NO.:	C-01

NOTES:


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- FIRST AMERICAN TITLE INSURANCE COMPANY ALTA COMMITMENT FOR TITLE INSURANCE, COMMITMENT NO. VA-21-3199A (REVISION 1) WITH AN EFFECTIVE DATE OF NOVEMBER 29, 2021 AT 8:00 AM HAS BEEN INCORPORATED INTO THIS SURVEY. ALL KNOWN PLOTTABLE EASEMENTS OF RECORD ARE SHOWN HEREON.
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AREA TABULATION:

RPC NO. 17-027-008	20,050 SF OR 0.46028 AC
PORTION OF FAIRFAX DRIVE TO BE VACATED	595 SF OR 0.01366 AC
TOTAL	20,645 SF OR 0.47394 AC

RPC 17-027-011
PROPERTY OF
PQ APARTMENTS
DB 4801 PG 499
ZONE: RA6-15
USE: APARTMENTS-GARDEN

EX ESMT FOR PUBLIC SIDEWALK
AND UTILITIES PURPOSES
DB 4799 PG 825

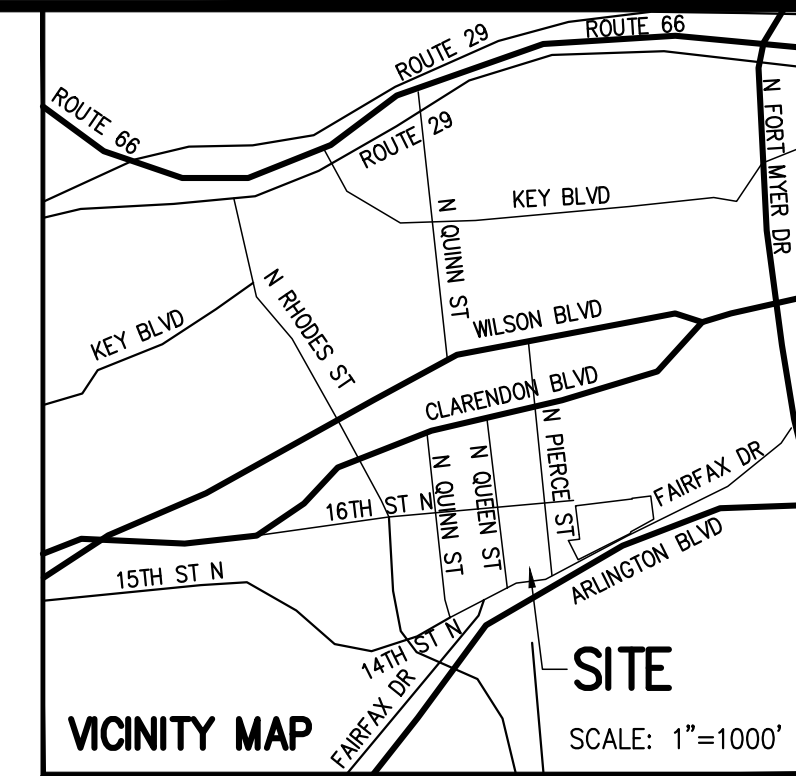

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V 12.00

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2nd 4.1 SUBMISSION	01/13/2023

POST-APPROVAL SHEET STATUS	DATE

PROFESSIONAL SEAL



1601 FAIRFAX DRIVE

4.1 SITE PLAN

ARLINGTON COUNTY, VIRGINIA

ENCROACHMENT EXHIBIT


DRAWN BY: LMG
DESIGNED BY: SURVEYS
DATE ISSUED: 10/19/2022

DWC.



SCALE: 1" = 10'

VIKA NO. VV8348C

SHEET NO. C-01A

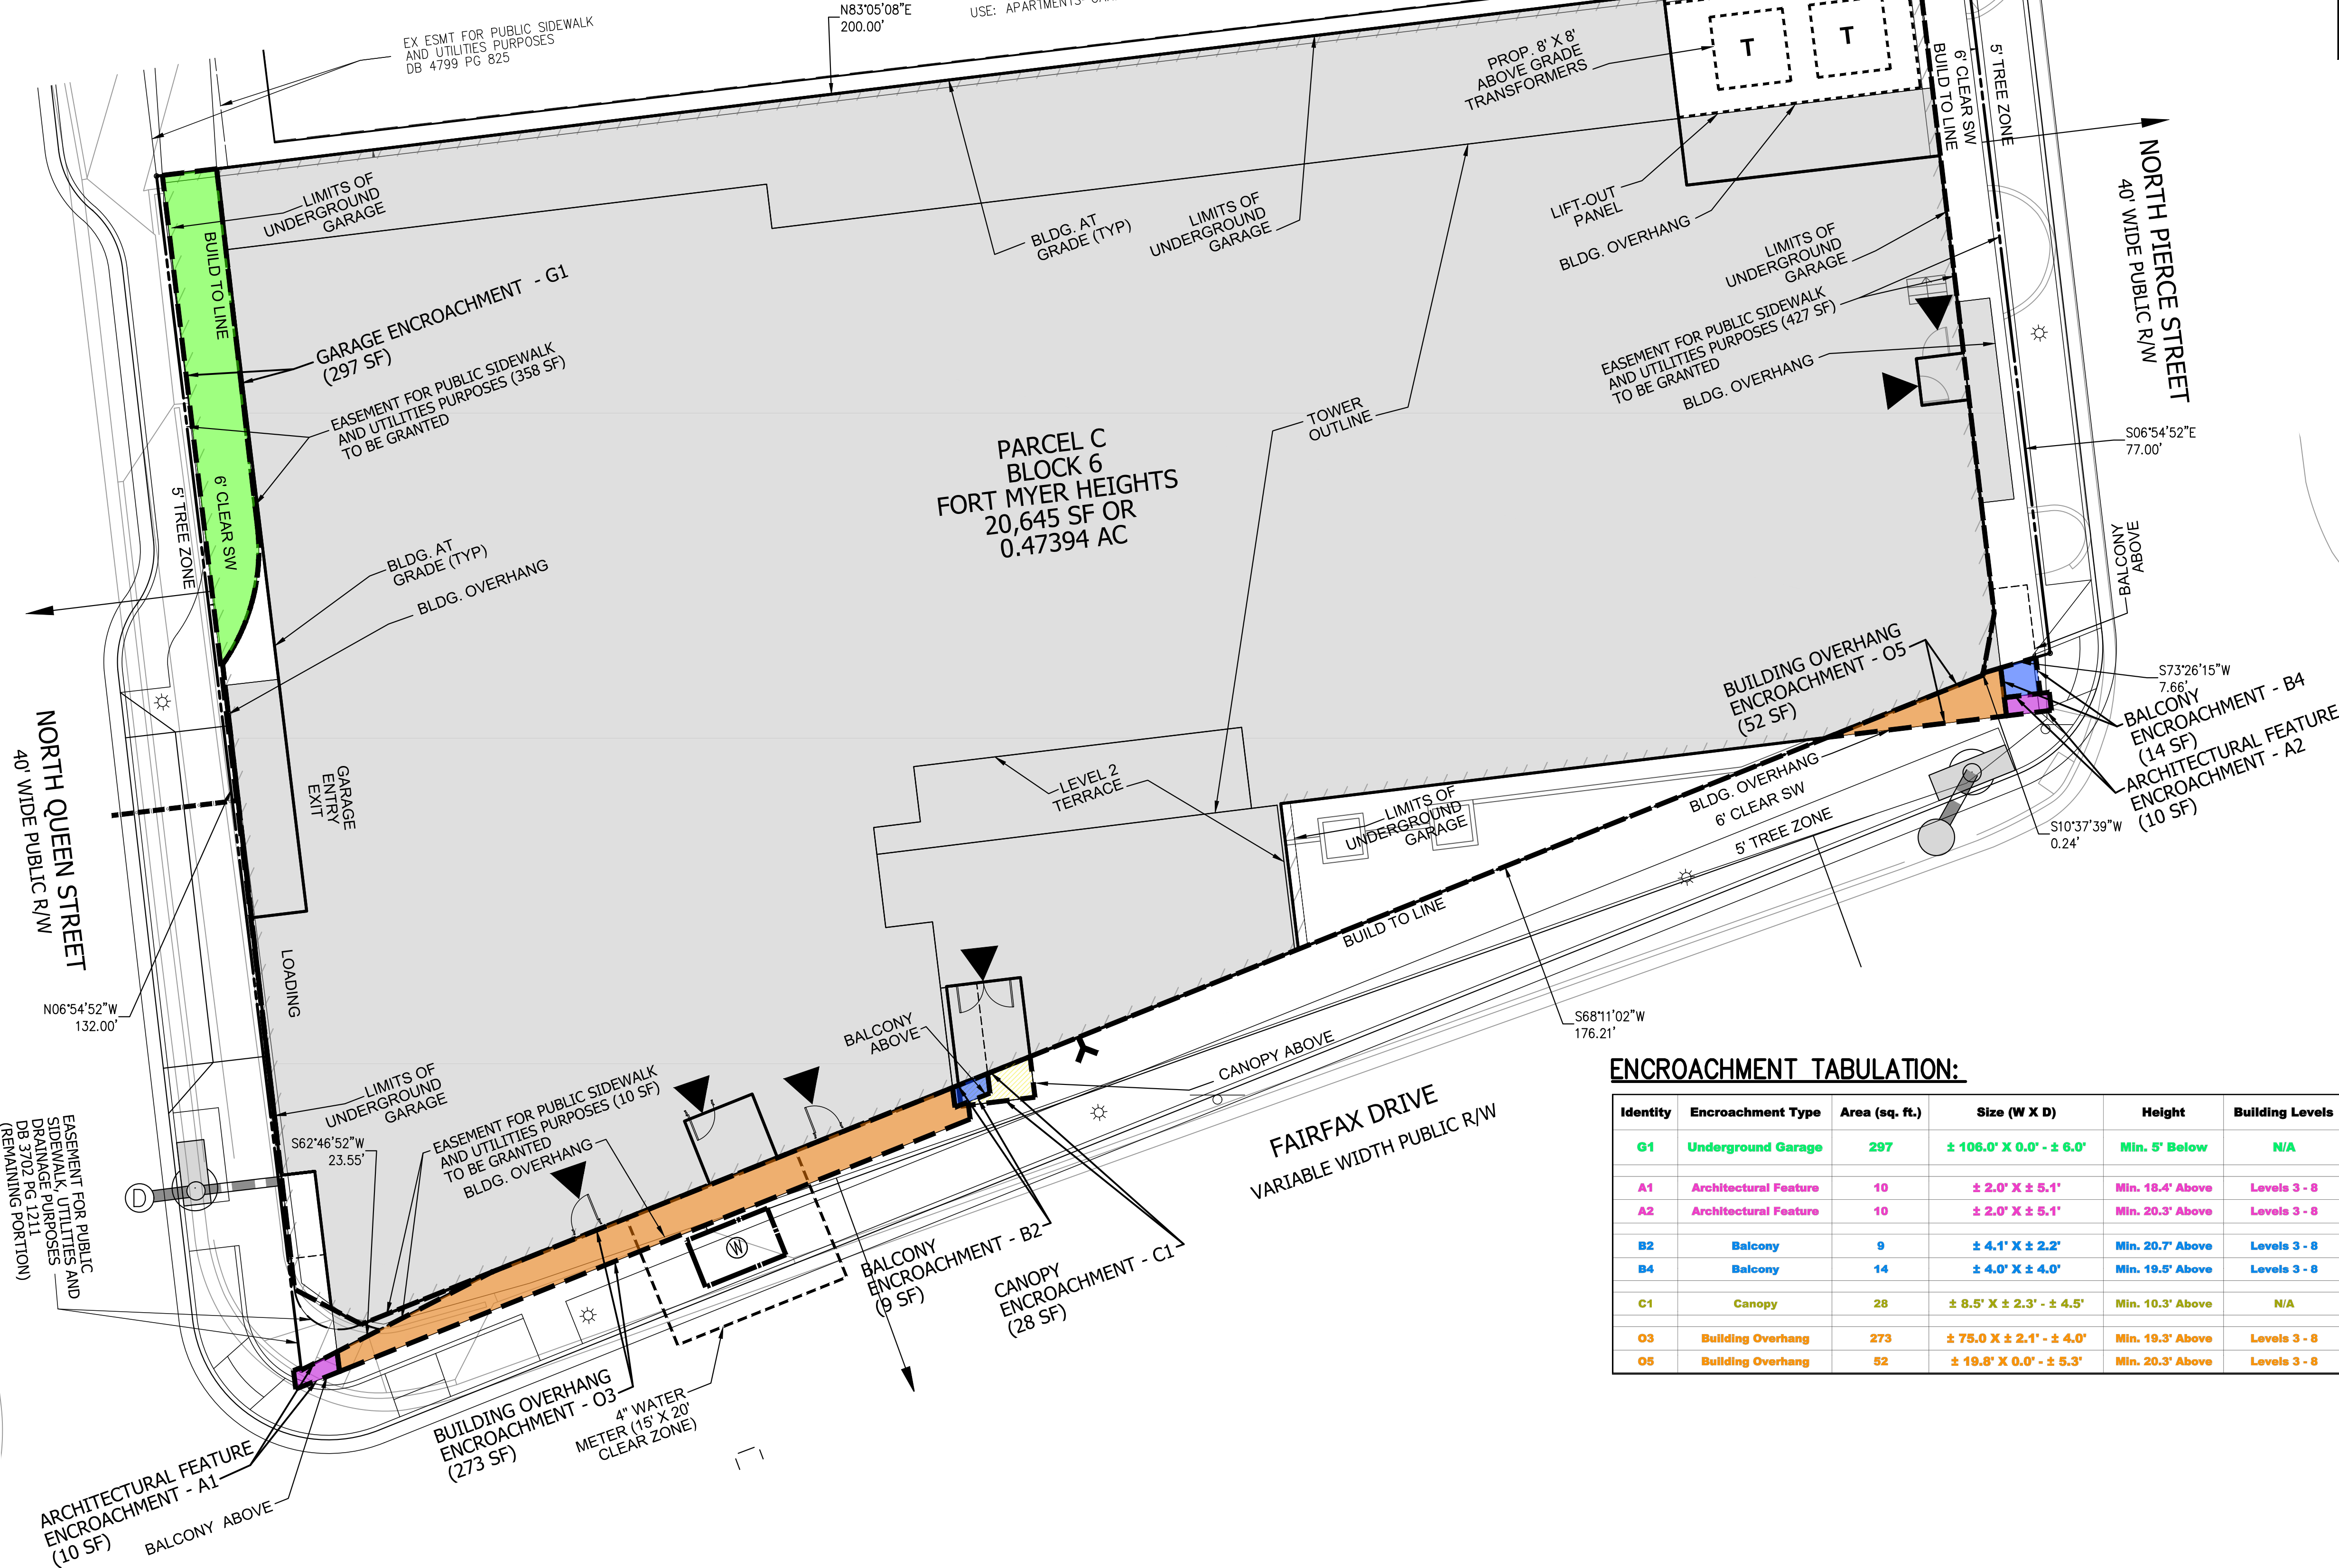**ENCROACHMENT TABULATION:**

Identity	Encroachment Type	Area (sq. ft.)	Size (W X D)	Height	Building Levels	Permanent/Removable	Easement Type
G1	Underground Garage	297	± 106.0' X 0.0' - ± 6.0'	Min. 5' Below	N/A	Permanent	Proposed Easement for Public Sidewalk & Utilities Purposes
A1	Architectural Feature	10	± 2.0' X ± 5.1'	Min. 18.4' Above	Levels 3 - 8	Permanent	Existing Fee Right of Way
A2	Architectural Feature	10	± 2.0' X ± 5.1'	Min. 20.3' Above	Levels 3 - 8	Permanent	Existing Fee Right of Way
B2	Balcony	9	± 4.1' X ± 2.2'	Min. 20.7' Above	Levels 3 - 8	Permanent	Existing Fee Right of Way
B4	Balcony	14	± 4.0' X ± 4.0'	Min. 19.5' Above	Levels 3 - 8	Permanent	Existing Fee Right of Way
C1	Canopy	28	± 8.5' X ± 2.3' - ± 4.5'	Min. 10.3' Above	N/A	Removable	Existing Fee Right of Way
O3	Building Overhang	273	± 75.0' X ± 2.1' - ± 4.0'	Min. 19.3' Above	Levels 3 - 8	Permanent	Existing Fee Right of Way
O5	Building Overhang	52	± 19.6' X 0.0' - ± 5.3'	Min. 20.3' Above	Levels 3 - 8	Permanent	Existing Fee Right of Way

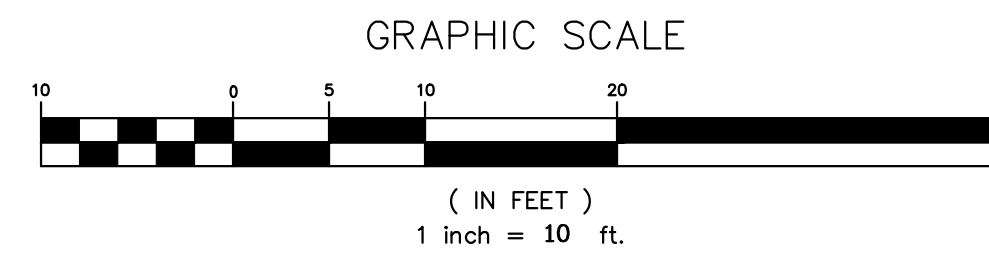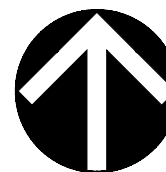


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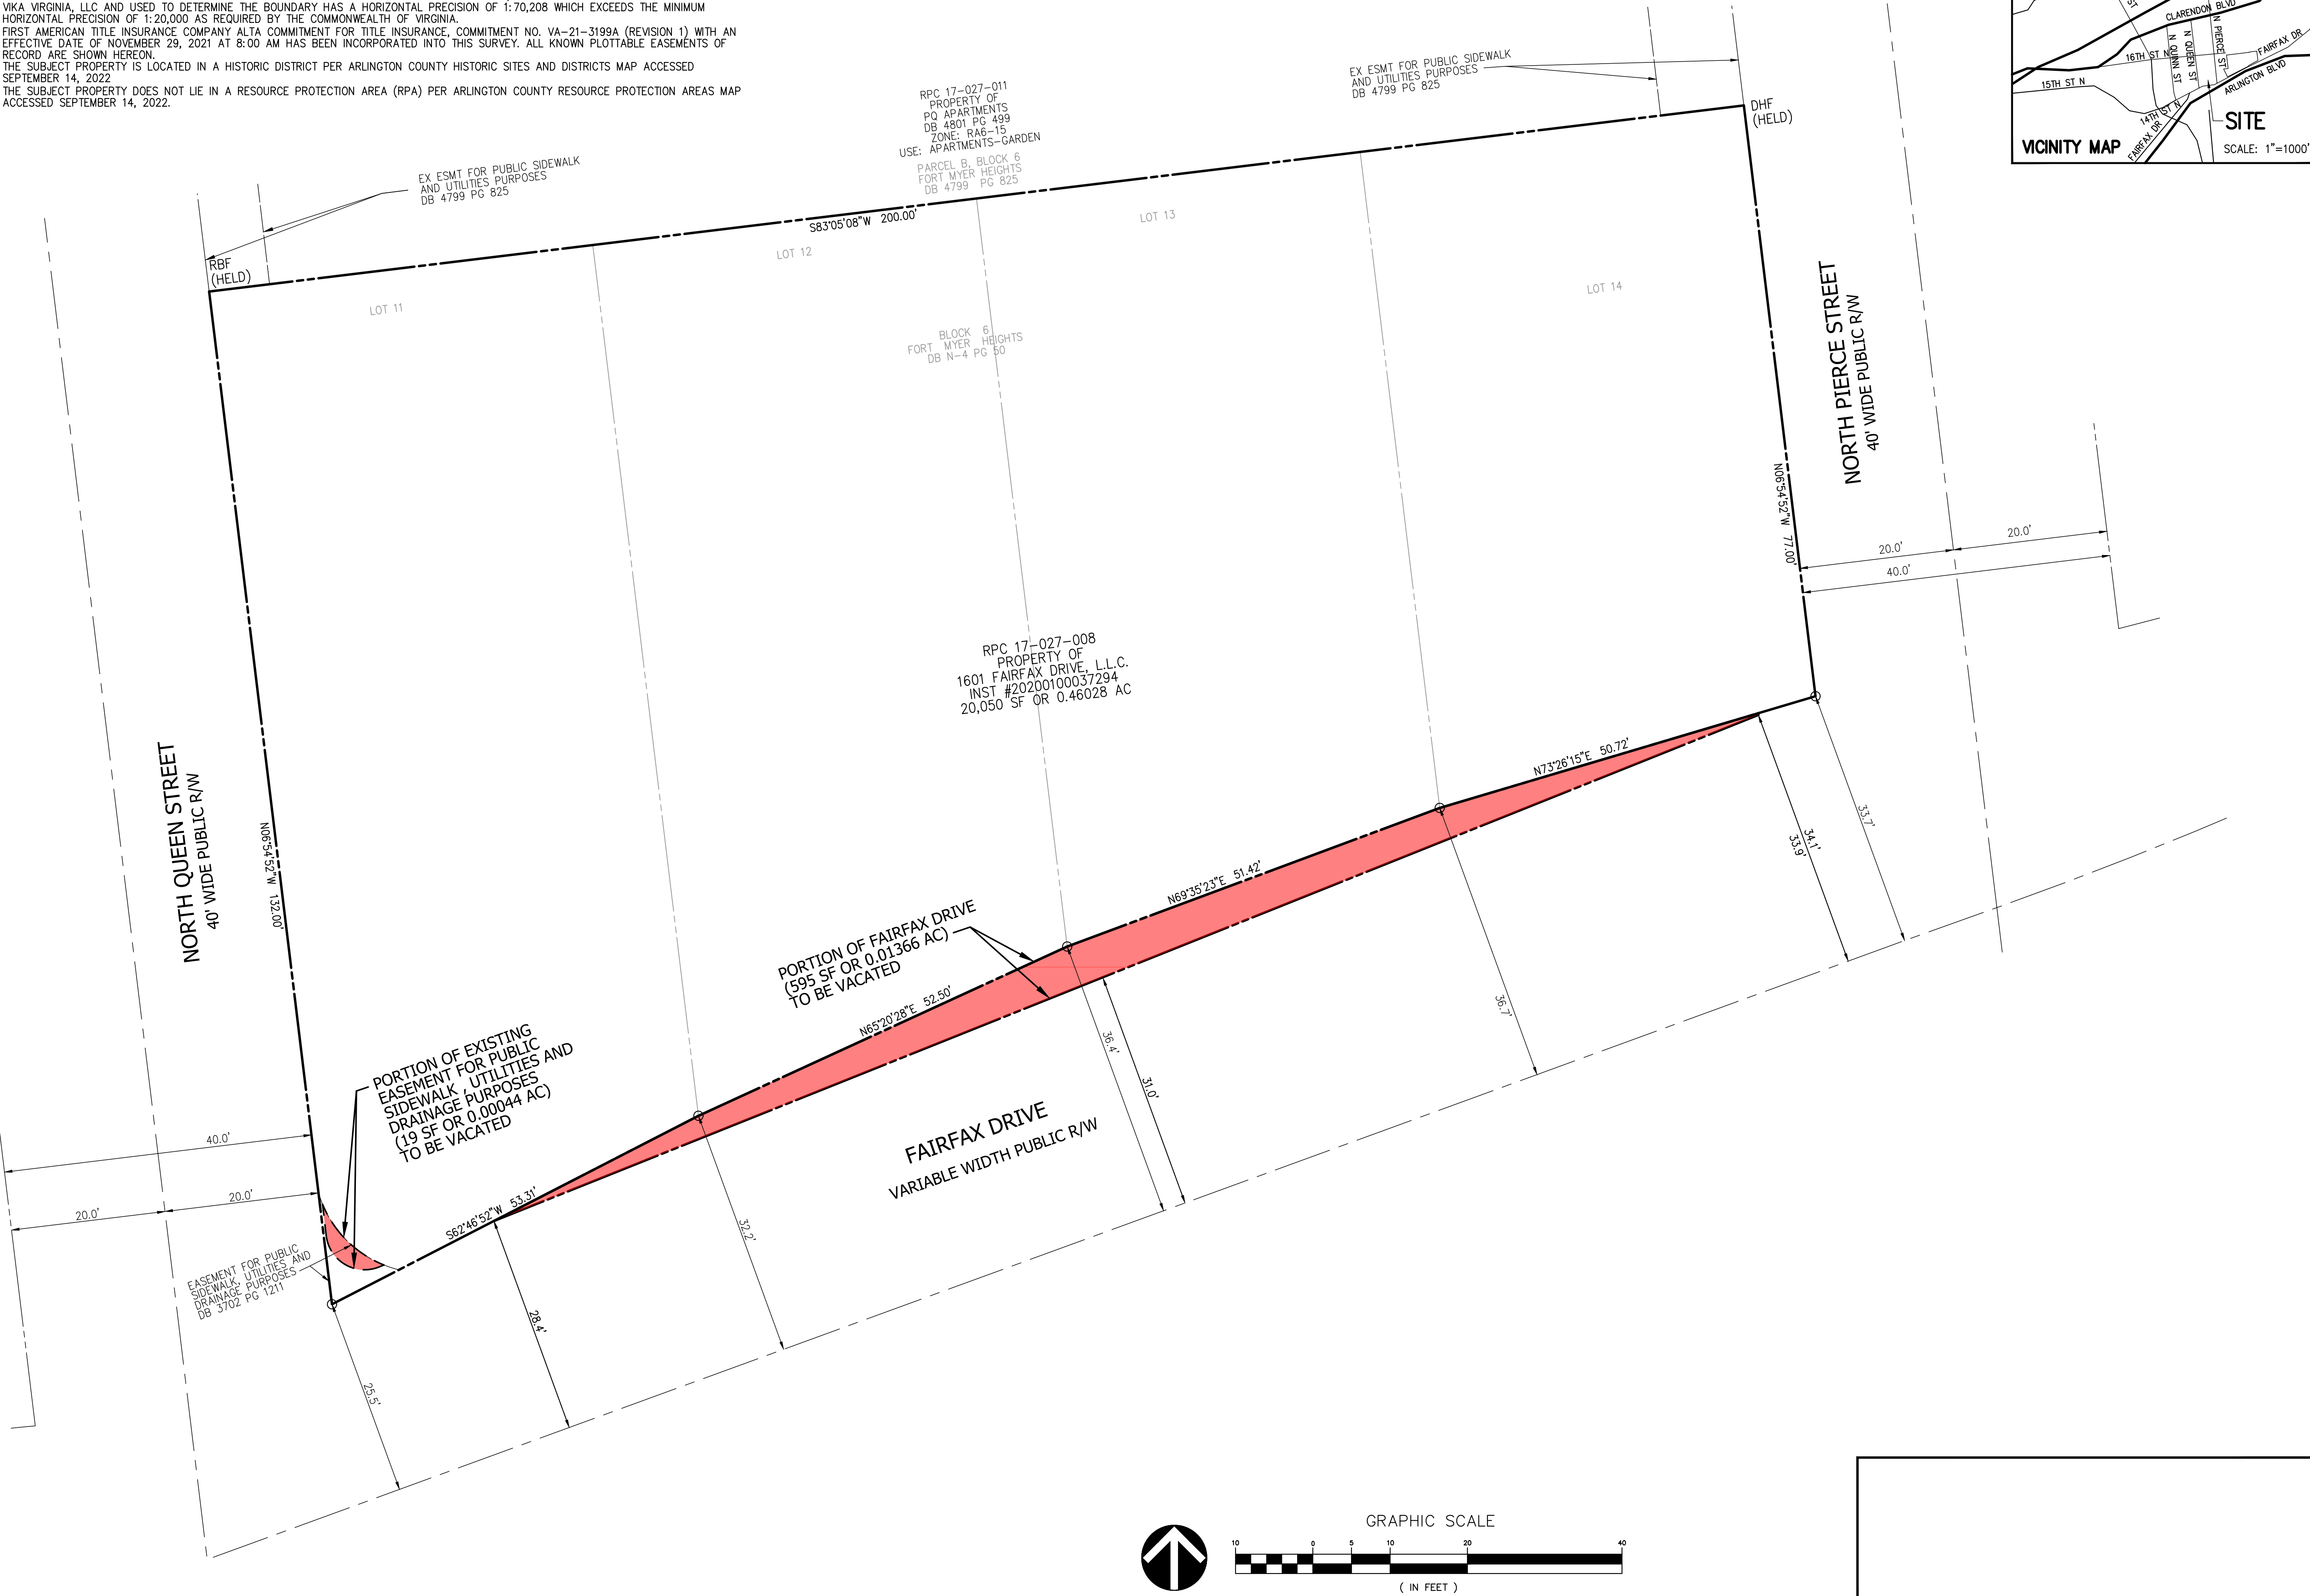
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TOTAL 20,645 SF OR 0.47394 AC



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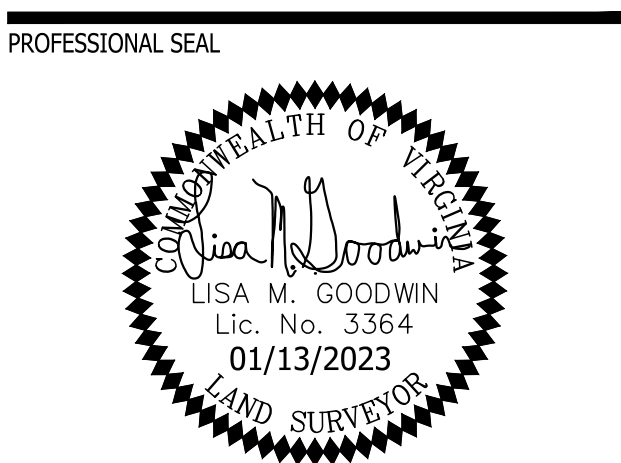


PLAN STATUS
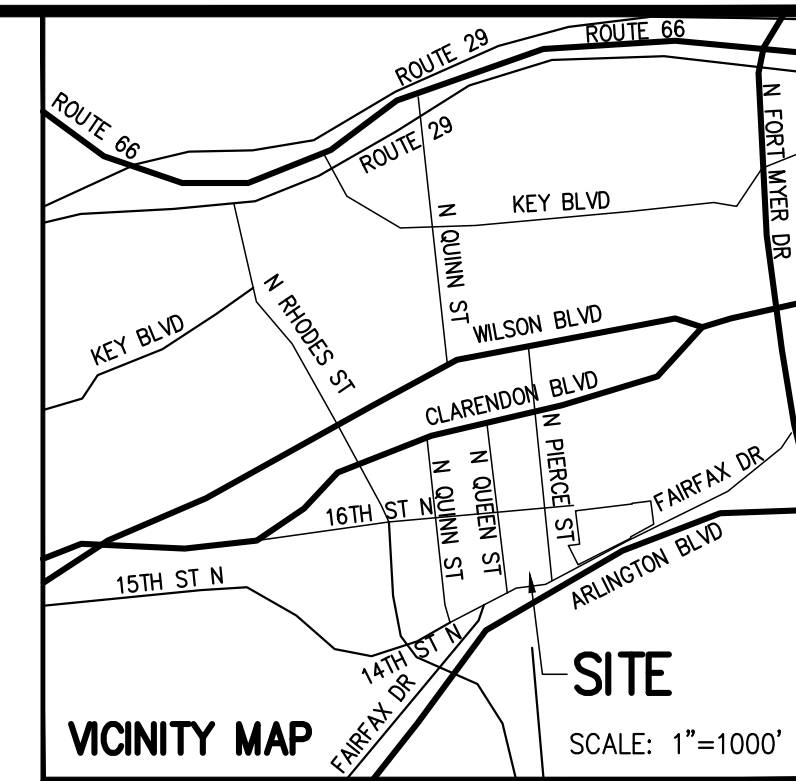
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2nd 4.1 SUBMISSION	01/13/2023

POST-APPROVAL SHEET STATUS

POST-APPROVAL SHEET STATUS	DATE
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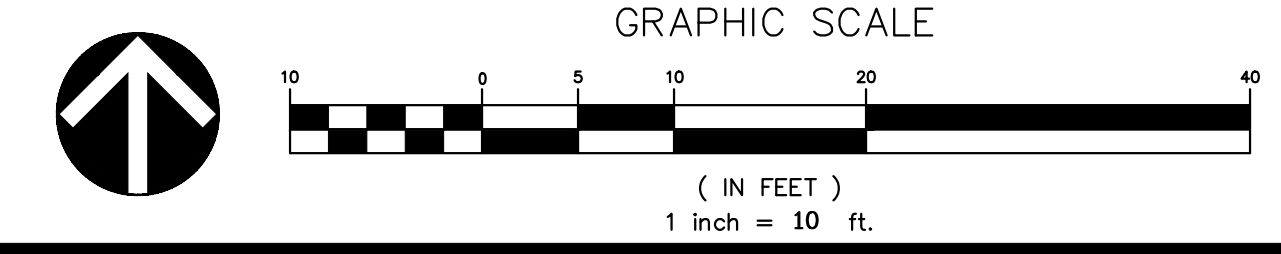



1601 FAIRFAX DRIVE
4.1 SITE PLAN

ARLINGTON COUNTY, VIRGINIA

VACATION EXHIBIT

DRAWN BY:	IMG
DESIGNED BY:	SURVEYS
DATE ISSUED:	10/19/2022
DWG. SCALE:	1" = 10'
VIKA NO.:	VV8348C
SHEET NO.:	C-02



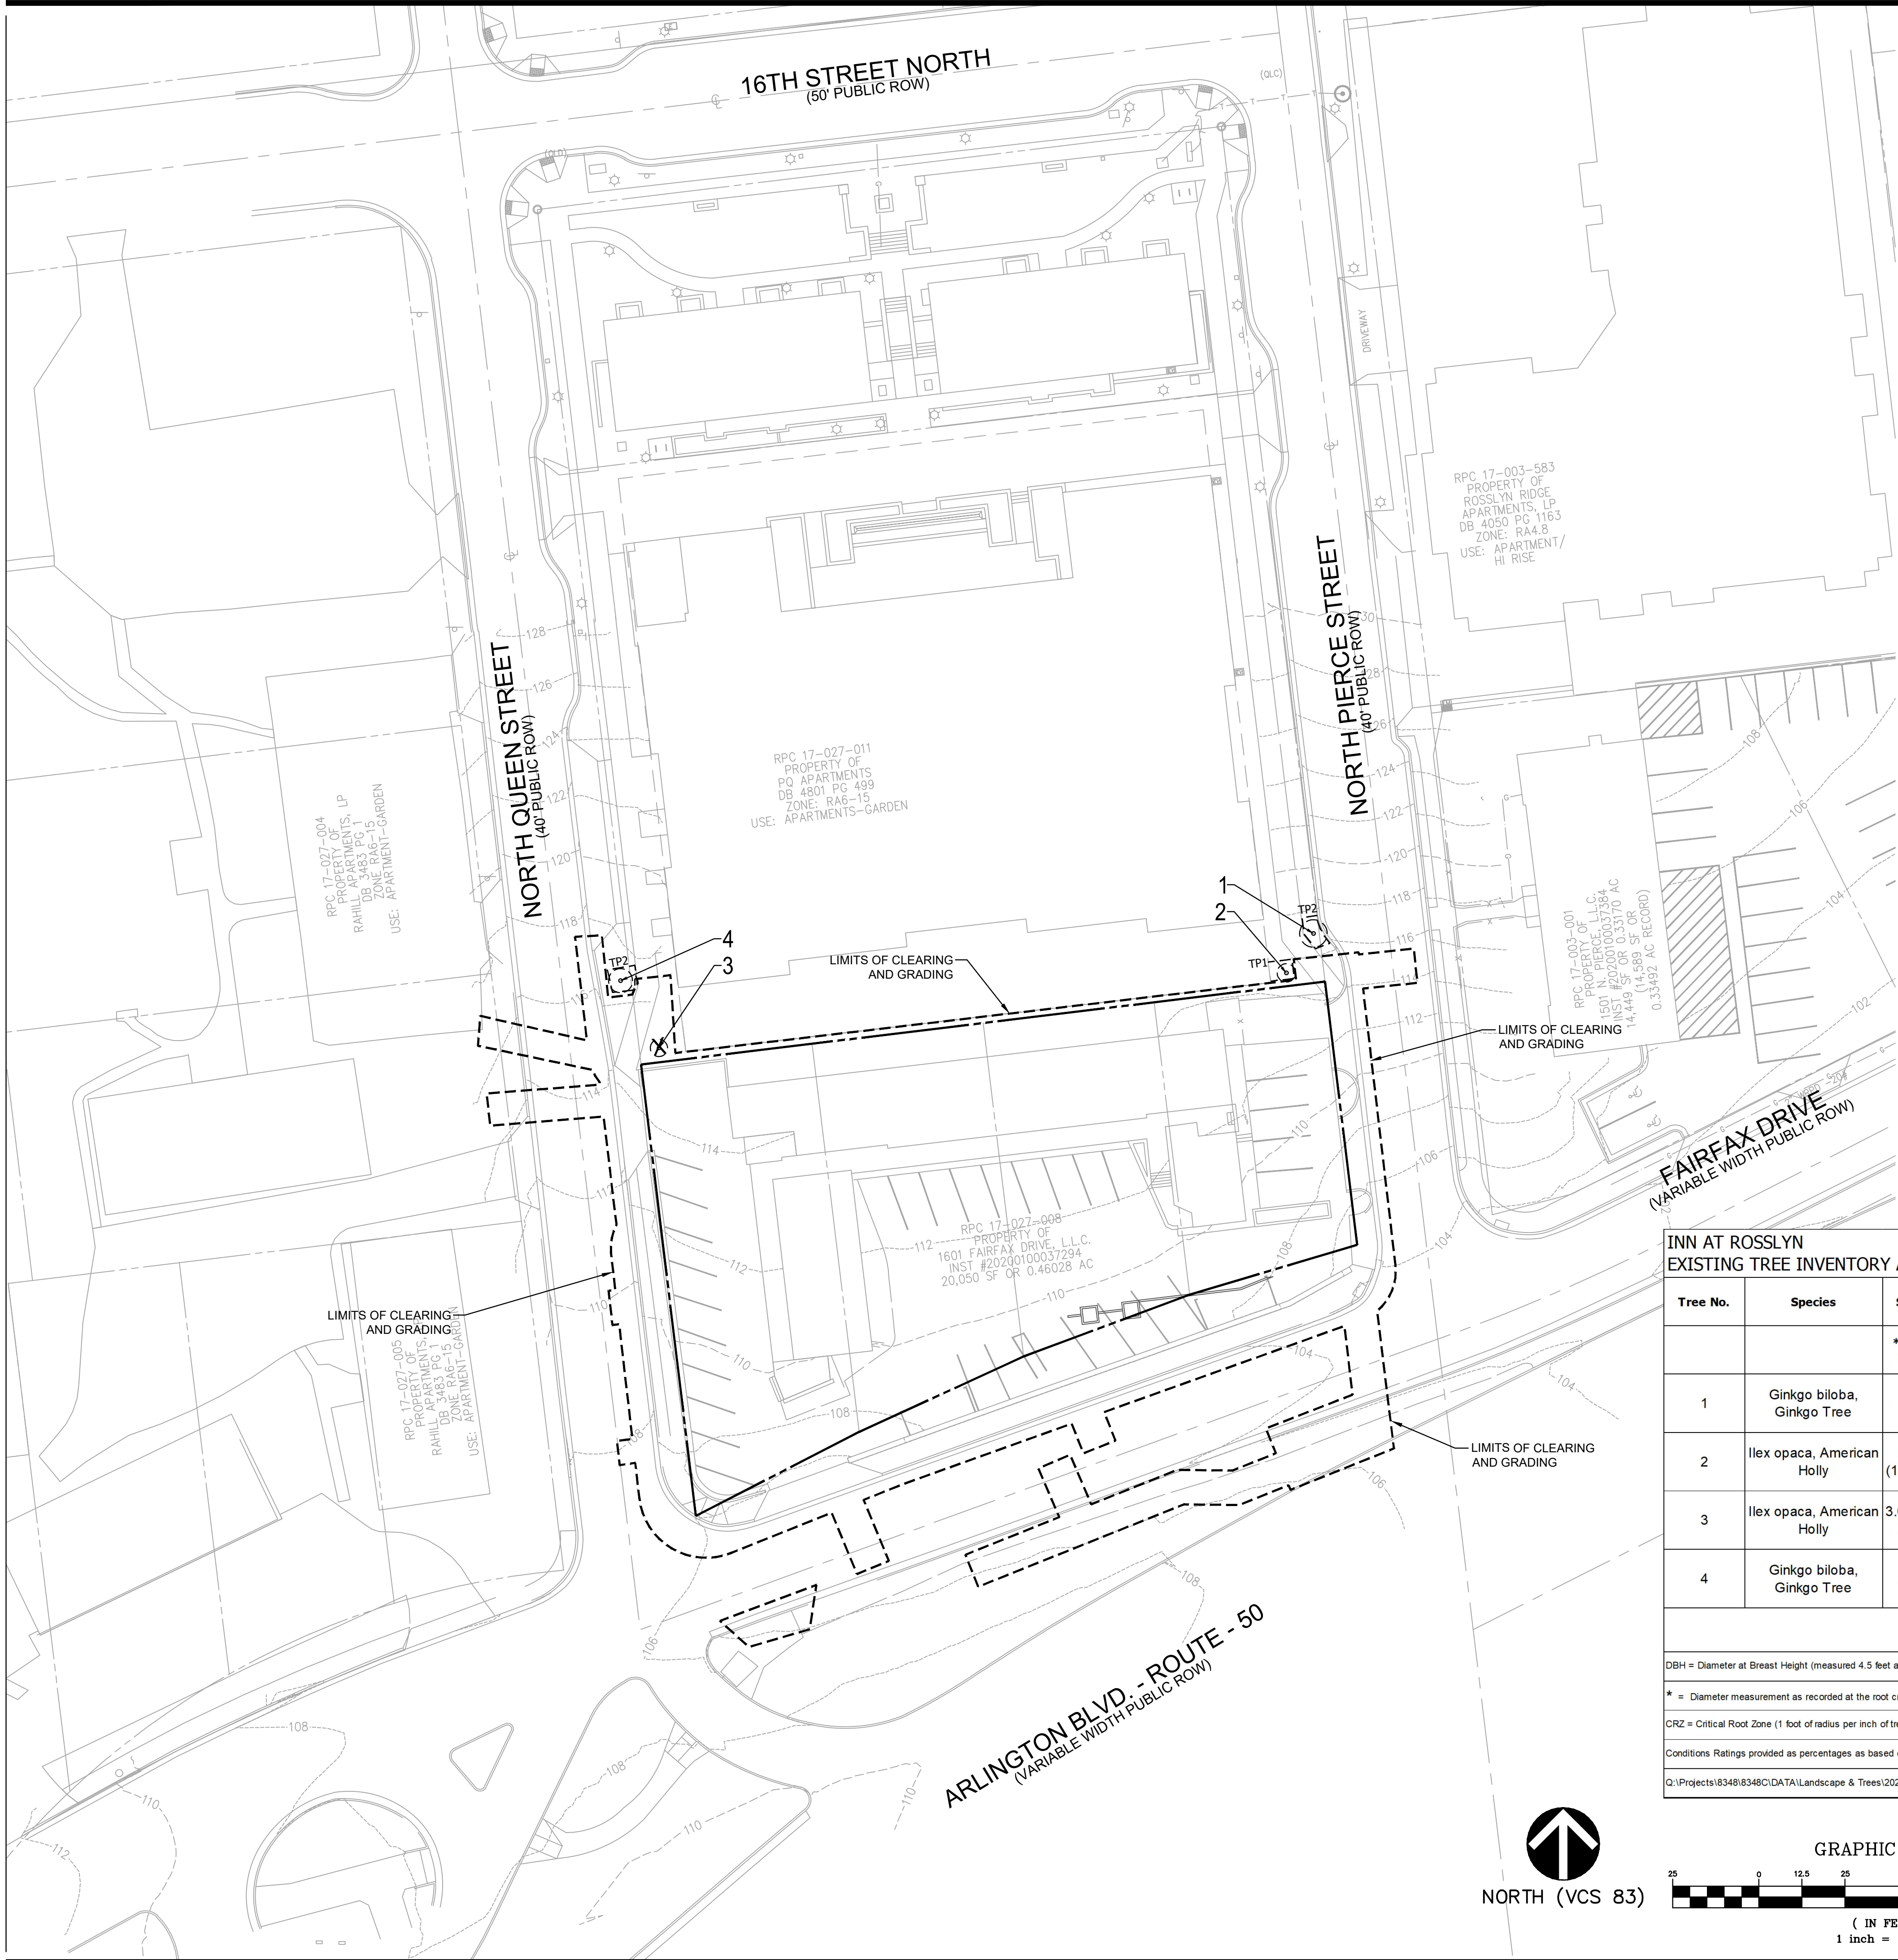

INN AT ROSSLYN EXISTING TREE INVENTORY AND REPLACEMENT DATA

January 13, 2023

Tree No.	Species	Size	CRZ	Field Condition	Species Rating	Avg Crown Radius (Ft)	Total Score	Status	Replacement trees	Existing Tree Condition Observations
		*DBH (in)	R (ft)	%						
1	Ginkgo biloba, Ginkgo Tree	4.6	8	0.68	0.70	4	2.19	Preserve	0	No apparent biotic issues observed. Good color, vigor, vitality & structure. Tree is off site
2	Ilex opaca, American Holly	2.6 (11'HT)	8	0.68	0.73	3	1.29	Preserve	0	No apparent biotic issues observed. Good color, vigor, vitality & structure. Tree is off site
3	Ilex opaca, American Holly	3.0 (11' HT)	8	0.68	0.73	2.5	1.49	Remove	1	No apparent biotic issues observed. Good color, vigor, vitality & structure. Tree is off site
4	Ginkgo biloba, Ginkgo Tree	2.8	8	0.68	0.70	3.5	1.33	Preserve	0	No apparent biotic issues observed. Good color, vigor, vitality & structure. Tree is off site
Computed Replacement Tree Total:									1	


DBH = Diameter at Breast Height (measured 4.5 feet above existing grade or as noted).

* = Diameter measurement as recorded at the root crown where tree has a codominant, or multi-stem trunk which precludes a measurement at 4.5 feet above existing grade.







CRZ = Critical Root Zone (1 foot of radius per inch of tree diameter) CRZ for trees with multiple stems were calculated based on the diameter of a tree with the basal area equal to the sum of the basal areas for all stems measured.

Conditions Ratings provided as percentages as based on methods outlined in the 9th edition of the "Guide for Plant Appraisal", published by the International Society of Arboriculture.

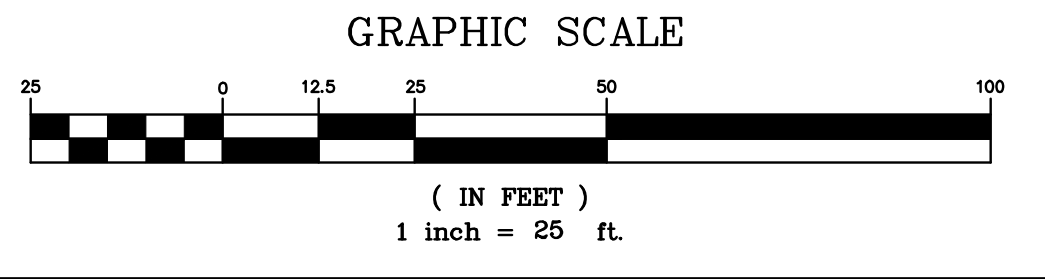Q:\Projects\8348\8348\CADD\PLANNING\PLANNING\DATA\Trees\2023-01-13[Ex Tree Inventory (2023-01-13).xls]Sheet1

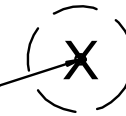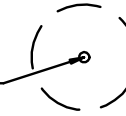

- NOTES:**
- ALL TREES NOTED FOR REMOVAL ARE TO BE REMOVED DUE TO NEW CONSTRUCTION IMPACTS.
 - CONTRACTOR IS RESPONSIBLE FOR ENSURING THAT ALL ON-SITE STORAGE OR CONSTRUCTION MATERIALS AND/OR BUILDING EQUIPMENT IS IN CONFORMANCE WITH ARLINGTON COUNTY STANDARDS, AND THAT, IN NO EVENT, SHALL STORAGE OF SAID MATERIALS OR EQUIPMENT ENCRUSH INTO ANY AREAS DESIGNATED FOR TREE PRESERVATION.
 - CONSTRUCTION EQUIPMENT (TRACKED OR WHEELED) SHALL NOT ENTER OR ENCRUSH INTO THE TREE PRESERVATION AREAS. TREE REMOVAL WITHIN THE PRESERVATION AREA SHALL BE EXECUTED USING HAND OPERATED EQUIPMENT SUCH AS CHAIN SAWS, WHEEL BARROWS, RAKES AND SHOVELS IN A MANNER SO AS NOT TO DISTURB OR IMPACT LAND OR EXISTING TREES TO BE SAVED.
 - ALL OFF-SITE TREES SHALL BE PRESERVED UNLESS SPECIFIED OTHERWISE.

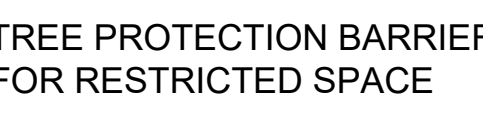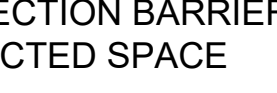- LEGEND:**
-  EXISTING TREE TO BE REMOVED
 -  EXISTING OFF-SITE TREE TO BE PRESERVED
 - TP1-----TP1  6' CHAIN LINK TREE PROTECTION FENCE 
 - TP2-----TP2  TREE PROTECTION BARRIER FOR RESTRICTED SPACE 
 - LIMITS OF CLEARING AND GRADING

CONDITION RATING SCALE

(0.2) 20% = POOR
(0.4) 40% = IN DECLINING
(0.6) 60% = GOOD
(0.8) 80% = VERY GOOD
(1.0) 100% = EXCELLENT/SPECIMEN

TREE REPLACEMENT RATES

RATING:	1 - 4.9	=	1 TREE
	5 - 9.9	=	2 TREE
	10 - 14.9	=	3 TREE
	15 - 19.9	=	4 TREE
	20 - 24.5	=	5 TREE
	25 +	=	6 TREE




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PROFESSIONAL SEAL



1601 FAIRFAX DRIVE

4.1 SITE PLAN

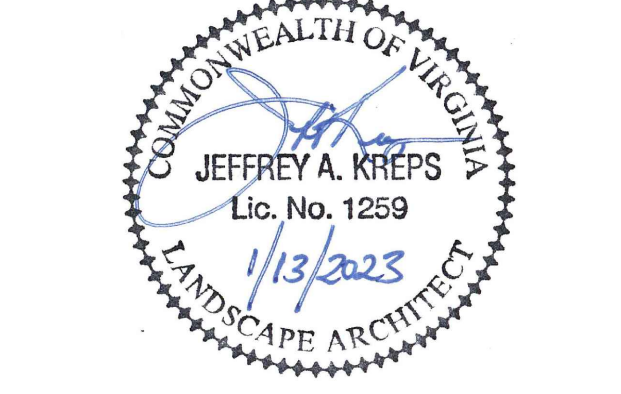ARLINGTON COUNTY, VIRGINIA

EXISTING TREE INVENTORY PLAN

DRAWN BY:	NDR
DESIGNED BY:	VIKA
DATE ISSUED:	10/19/2022
DWG. SCALE:	1"=25'
VIKA NO.:	VV8348C
SHEET NO.:	C-03



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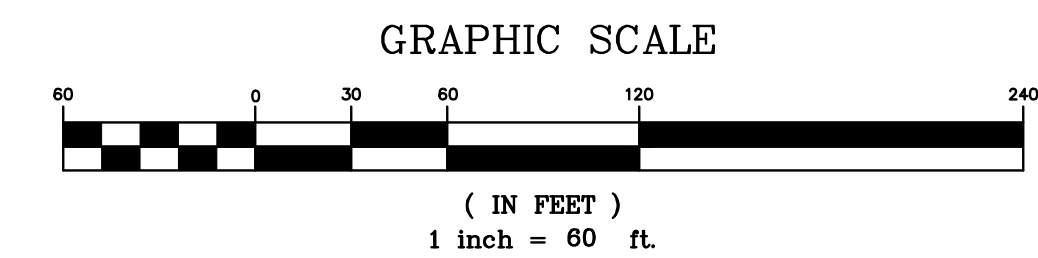
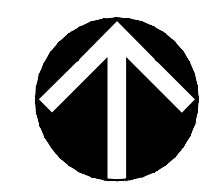
PROFESSIONAL SEAL



NOTE:
 BLDG. HEIGHTS ARE
 TAKEN FROM AVERAGE
 GRADE OF 111.14'

LEGEND:

	EX. BIKE ROUTE
	EX. ART BUS ROUTE
	EX. METRO BUS ROUTE
	EX. WMATA BUS STOP
	EX. ART BUS STOP




1601 FAIRFAX DRIVE

4.1 SITE PLAN

ARLINGTON COUNTY, VIRGINIA

**OVERALL
 CONTEXT PLAN**

DRAWN BY:	NDR
DESIGNED BY:	VIKA
DATE ISSUED:	10/19/2022
DWG. SCALE:	1" = 60'
VIKA NO.:	VV8348C
SHEET NO.:	C-04

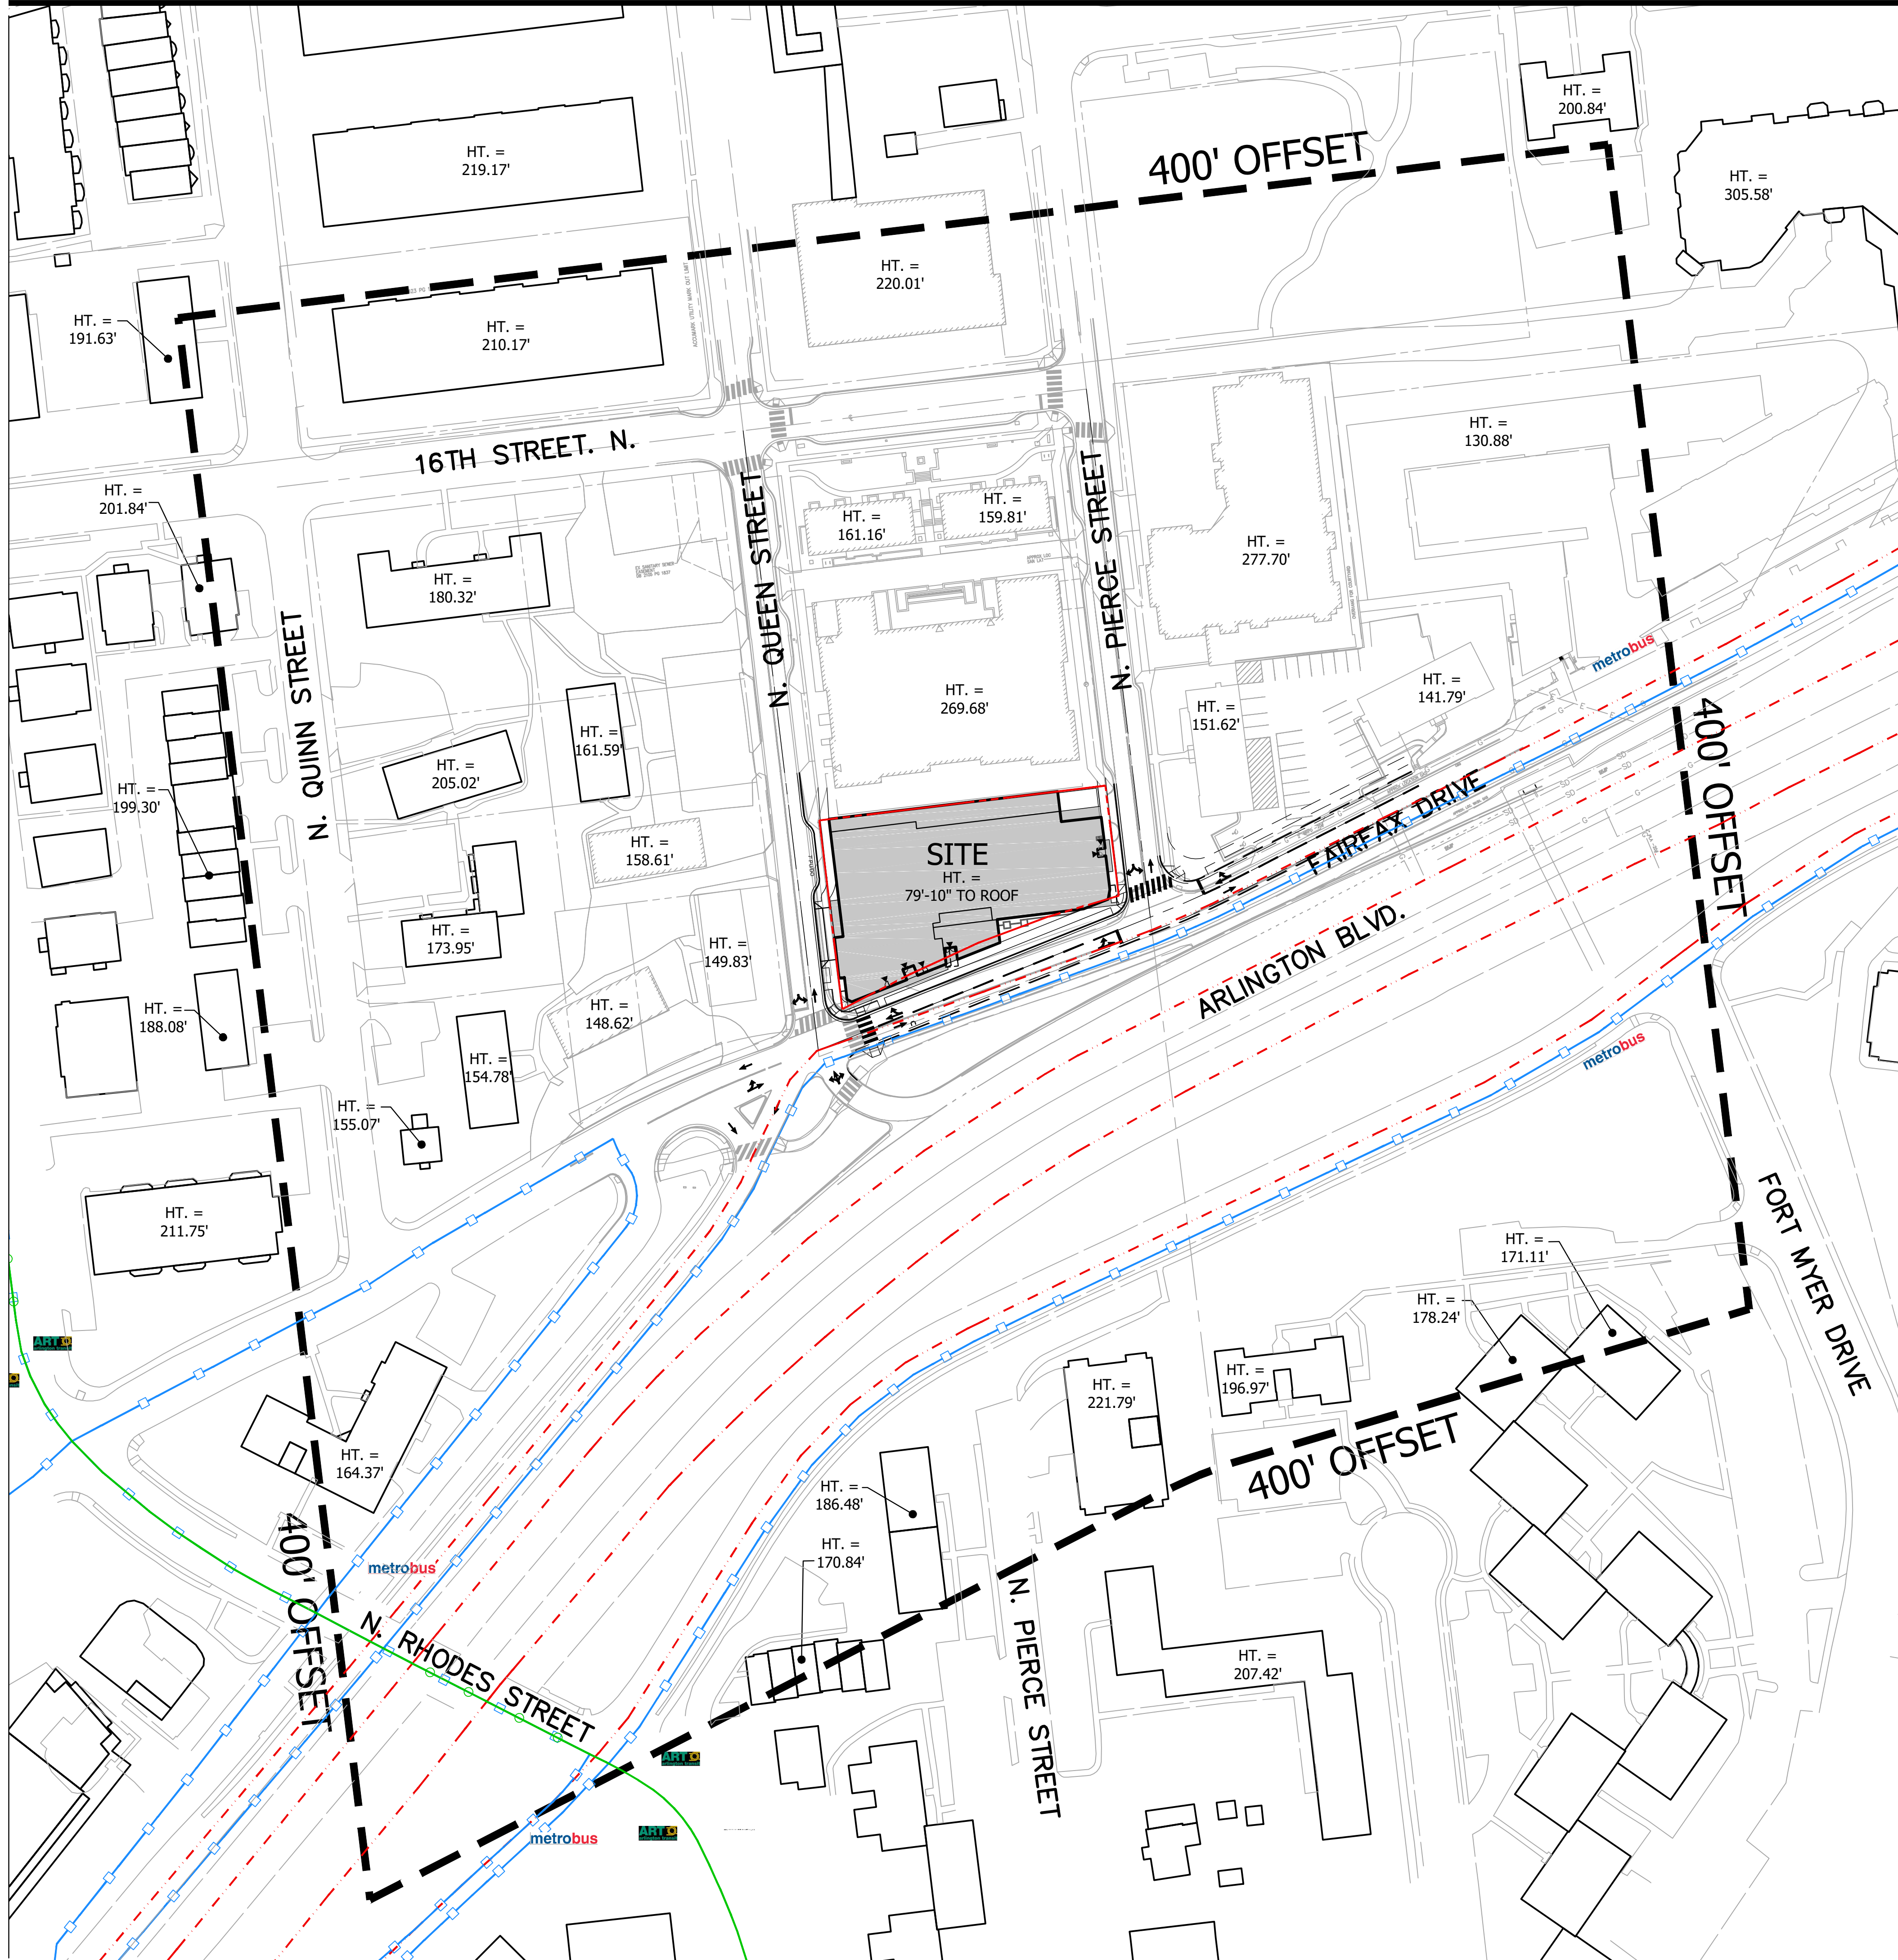



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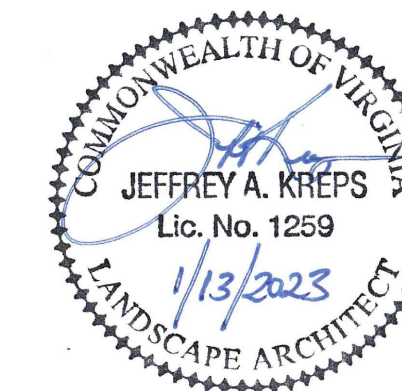
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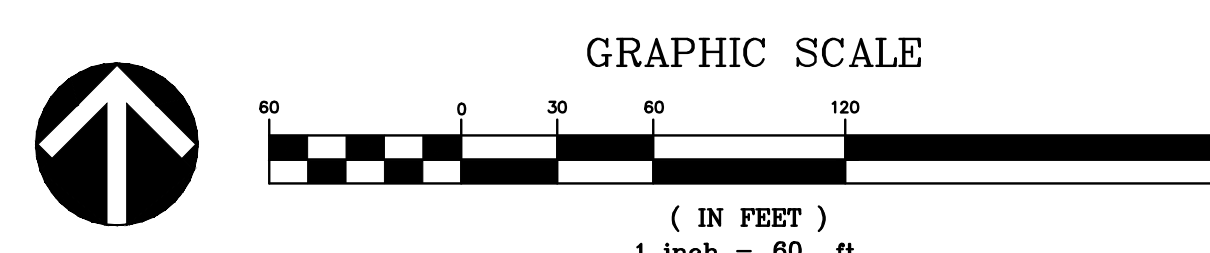
1601 FAIRFAX DRIVE


4.1 SITE PLAN

ARLINGTON COUNTY, VIRGINIA

AERIAL CONTEXT PLAN

DRAWN BY:	
DESIGNED BY:	VIKA
DATE ISSUED:	10/19/2022
DWG. SCALE:	1" = 60'
VIKA NO.:	VV8348C
SHEET NO.:	C-05



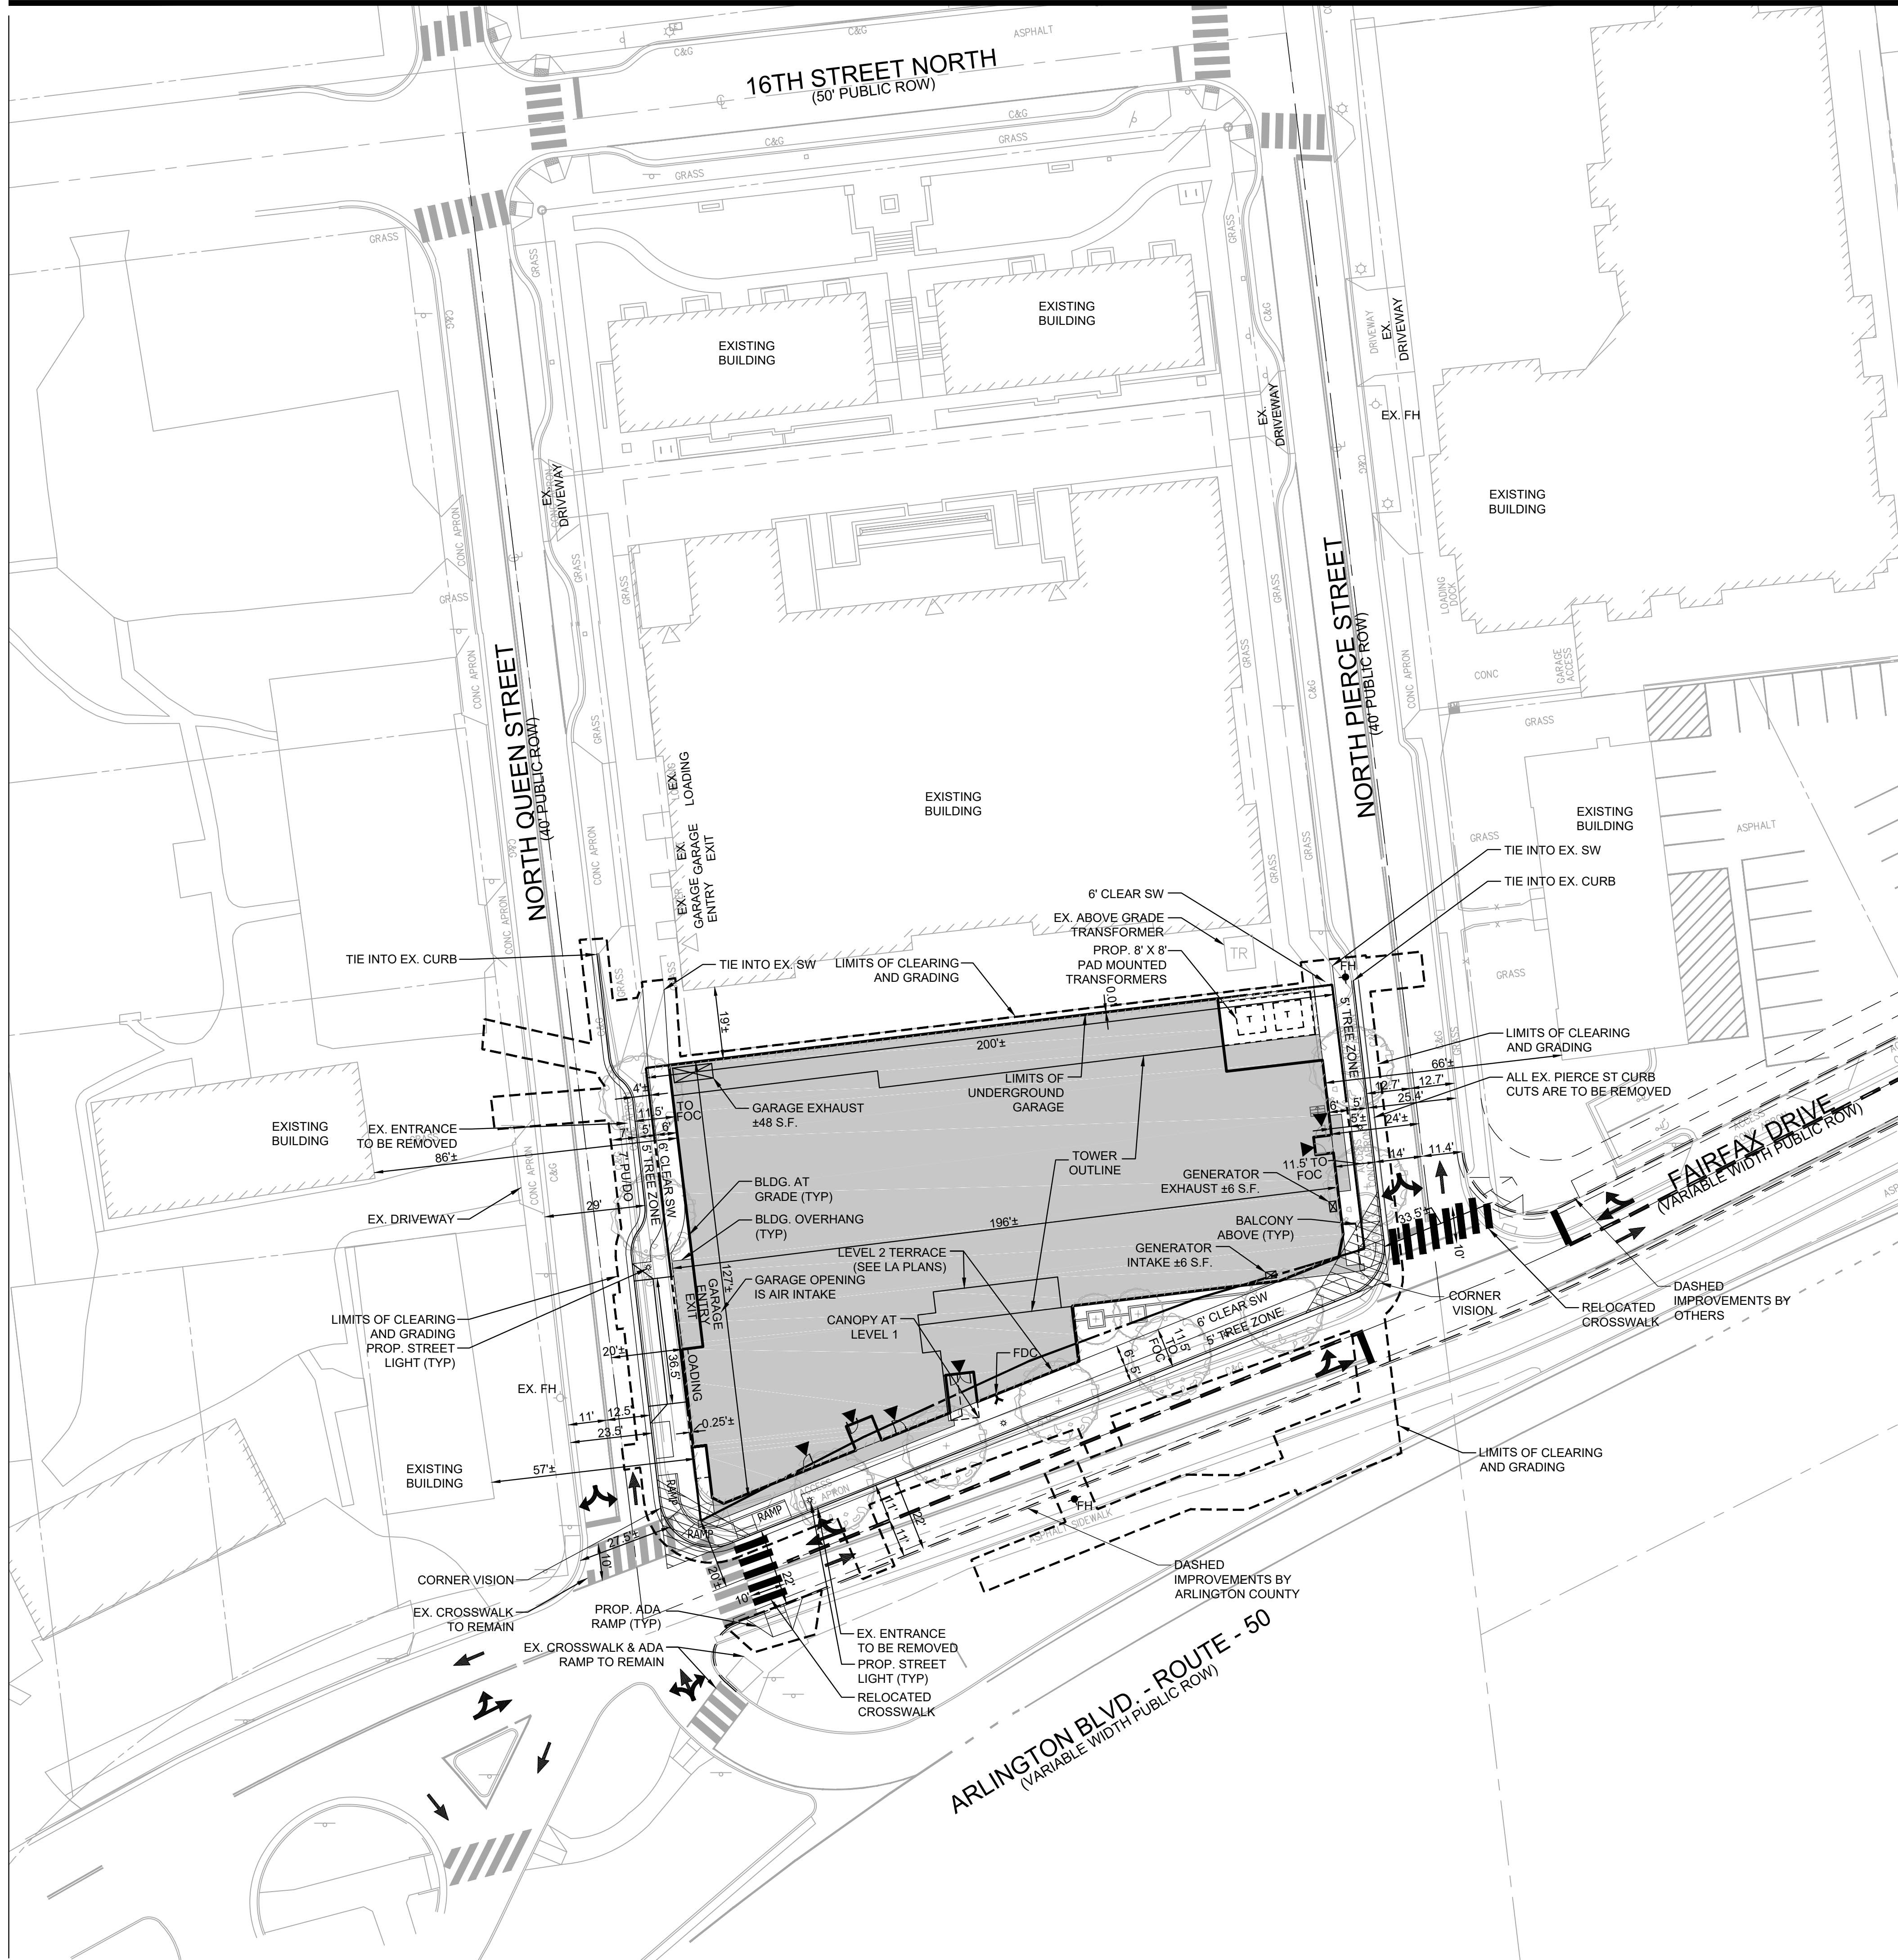

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PLAN STATUS	DATE
1st 4.1 SUBMISSION	10/19/2022
2nd 4.1 SUBMISSION	01/13/2023

POST-APPROVAL SHEET STATUS	DATE
----------------------------	------

PROFESSIONAL SEAL



1601 FAIRFAX DRIVE

4.1 SITE PLAN


ARLINGTON COUNTY, VIRGINIA

PRESENTATION PLAN

DRAWN BY:	NDR
DESIGNED BY:	VIKA
DATE ISSUED:	10/19/2022
DWG. SCALE:	1"=25'
VIKA NO.:	VV8348C
SHEET NO.:	C-07


LEGEND

	PROPOSED BUILDING AT GRADE
	PROPOSED BUILDING OVERHANG ABOVE
	PROPOSED BALCONY ABOVE
	PROPOSED LIMITS OF UNDERGROUND GARAGE
	PROPOSED PEDESTRIAN ENTRANCE

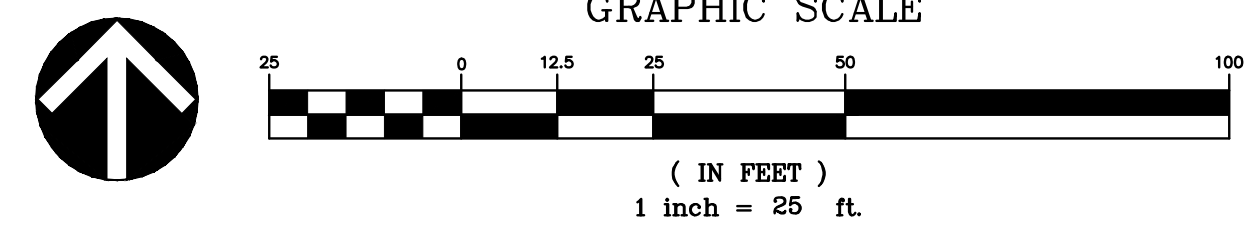


FILE: Q:\Projects\8348348C\CADD\PLANNING\PLANNING DRAWINGS\8348C - PRESENTATION PLAN.dwg USER: Richardson DATE: January 13, 2023 TIME: 5:06:35 PM LAYOUT: C-07 PRESENTATION PLAN

LAYOUT: C-07 PRESENTATION PLAN. Plotted By: Richardson

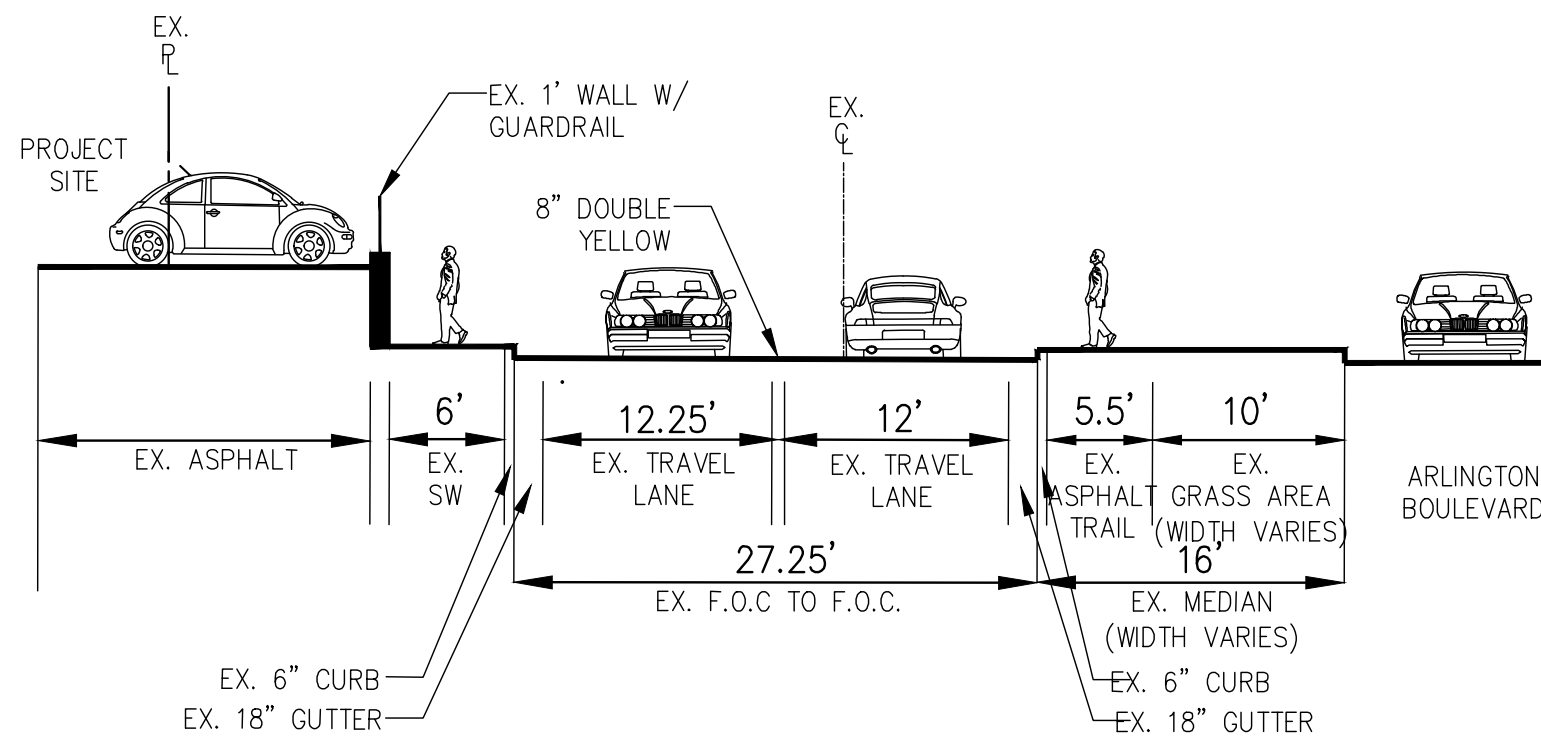

SECTION A-A (LOOKING EAST)


EXISTING - FAIRFAX DRIVE

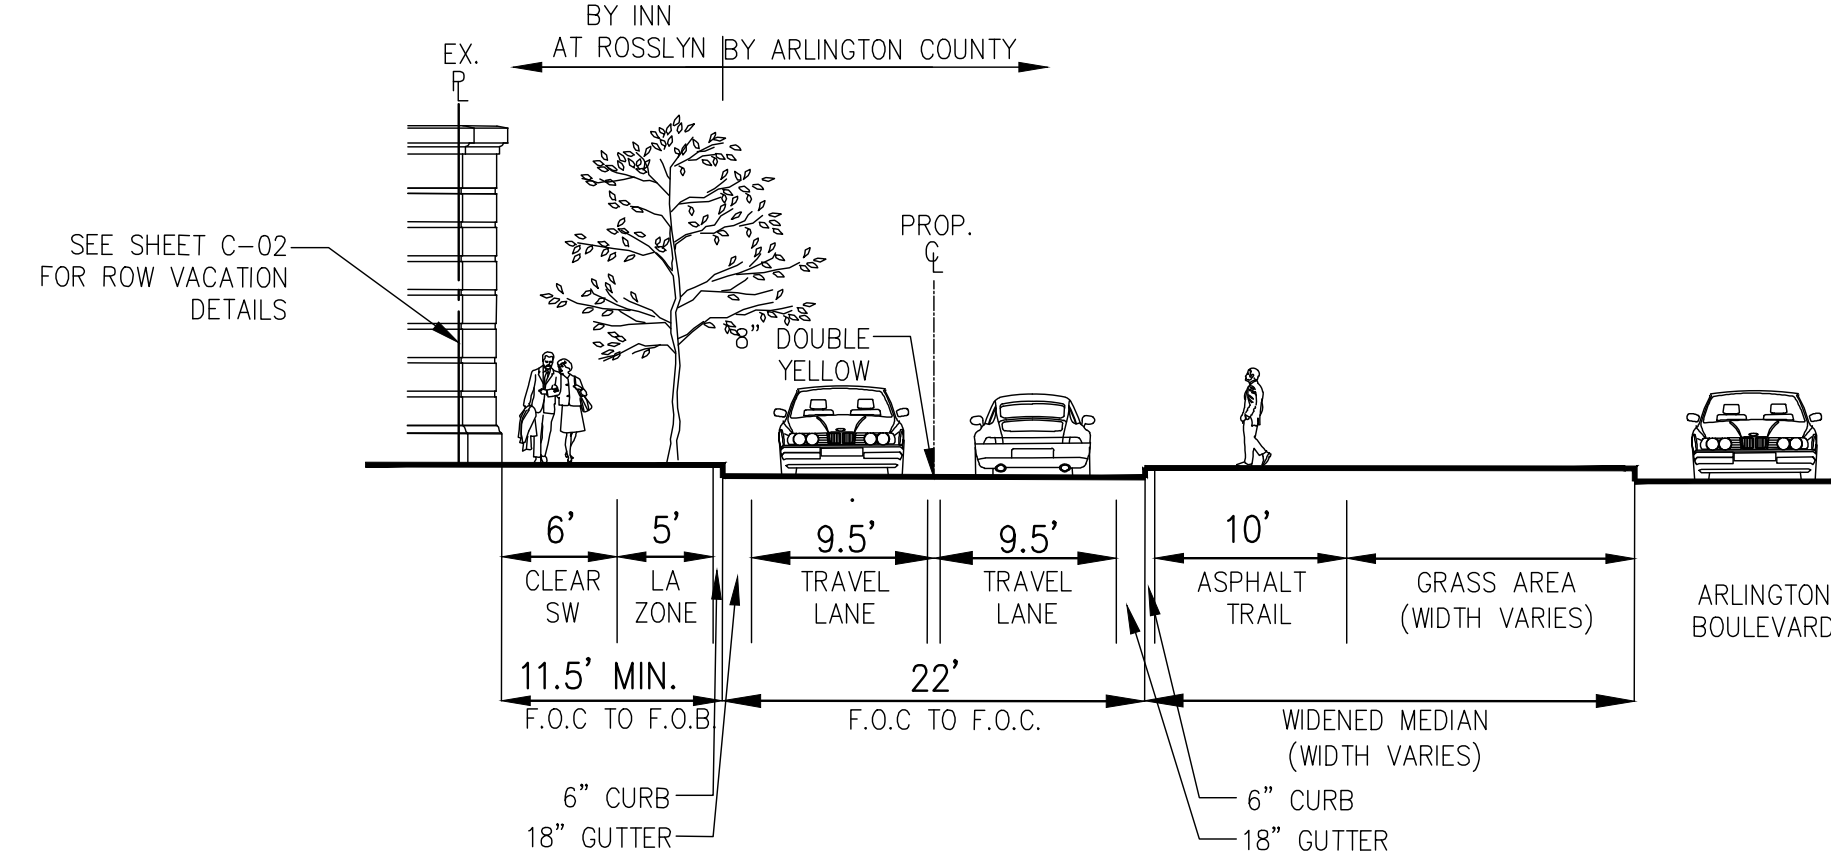


SECTION A-A (LOOKING EAST)

***PROPOSED - FAIRFAX DRIVE**

***PROPOSED ROADWAY IMPROVEMENTS SOUTH OF PROJECT FRONTAGE FACE OF CURB WILL BE CONSTRUCTED BY ARLINGTON COUNTY.**

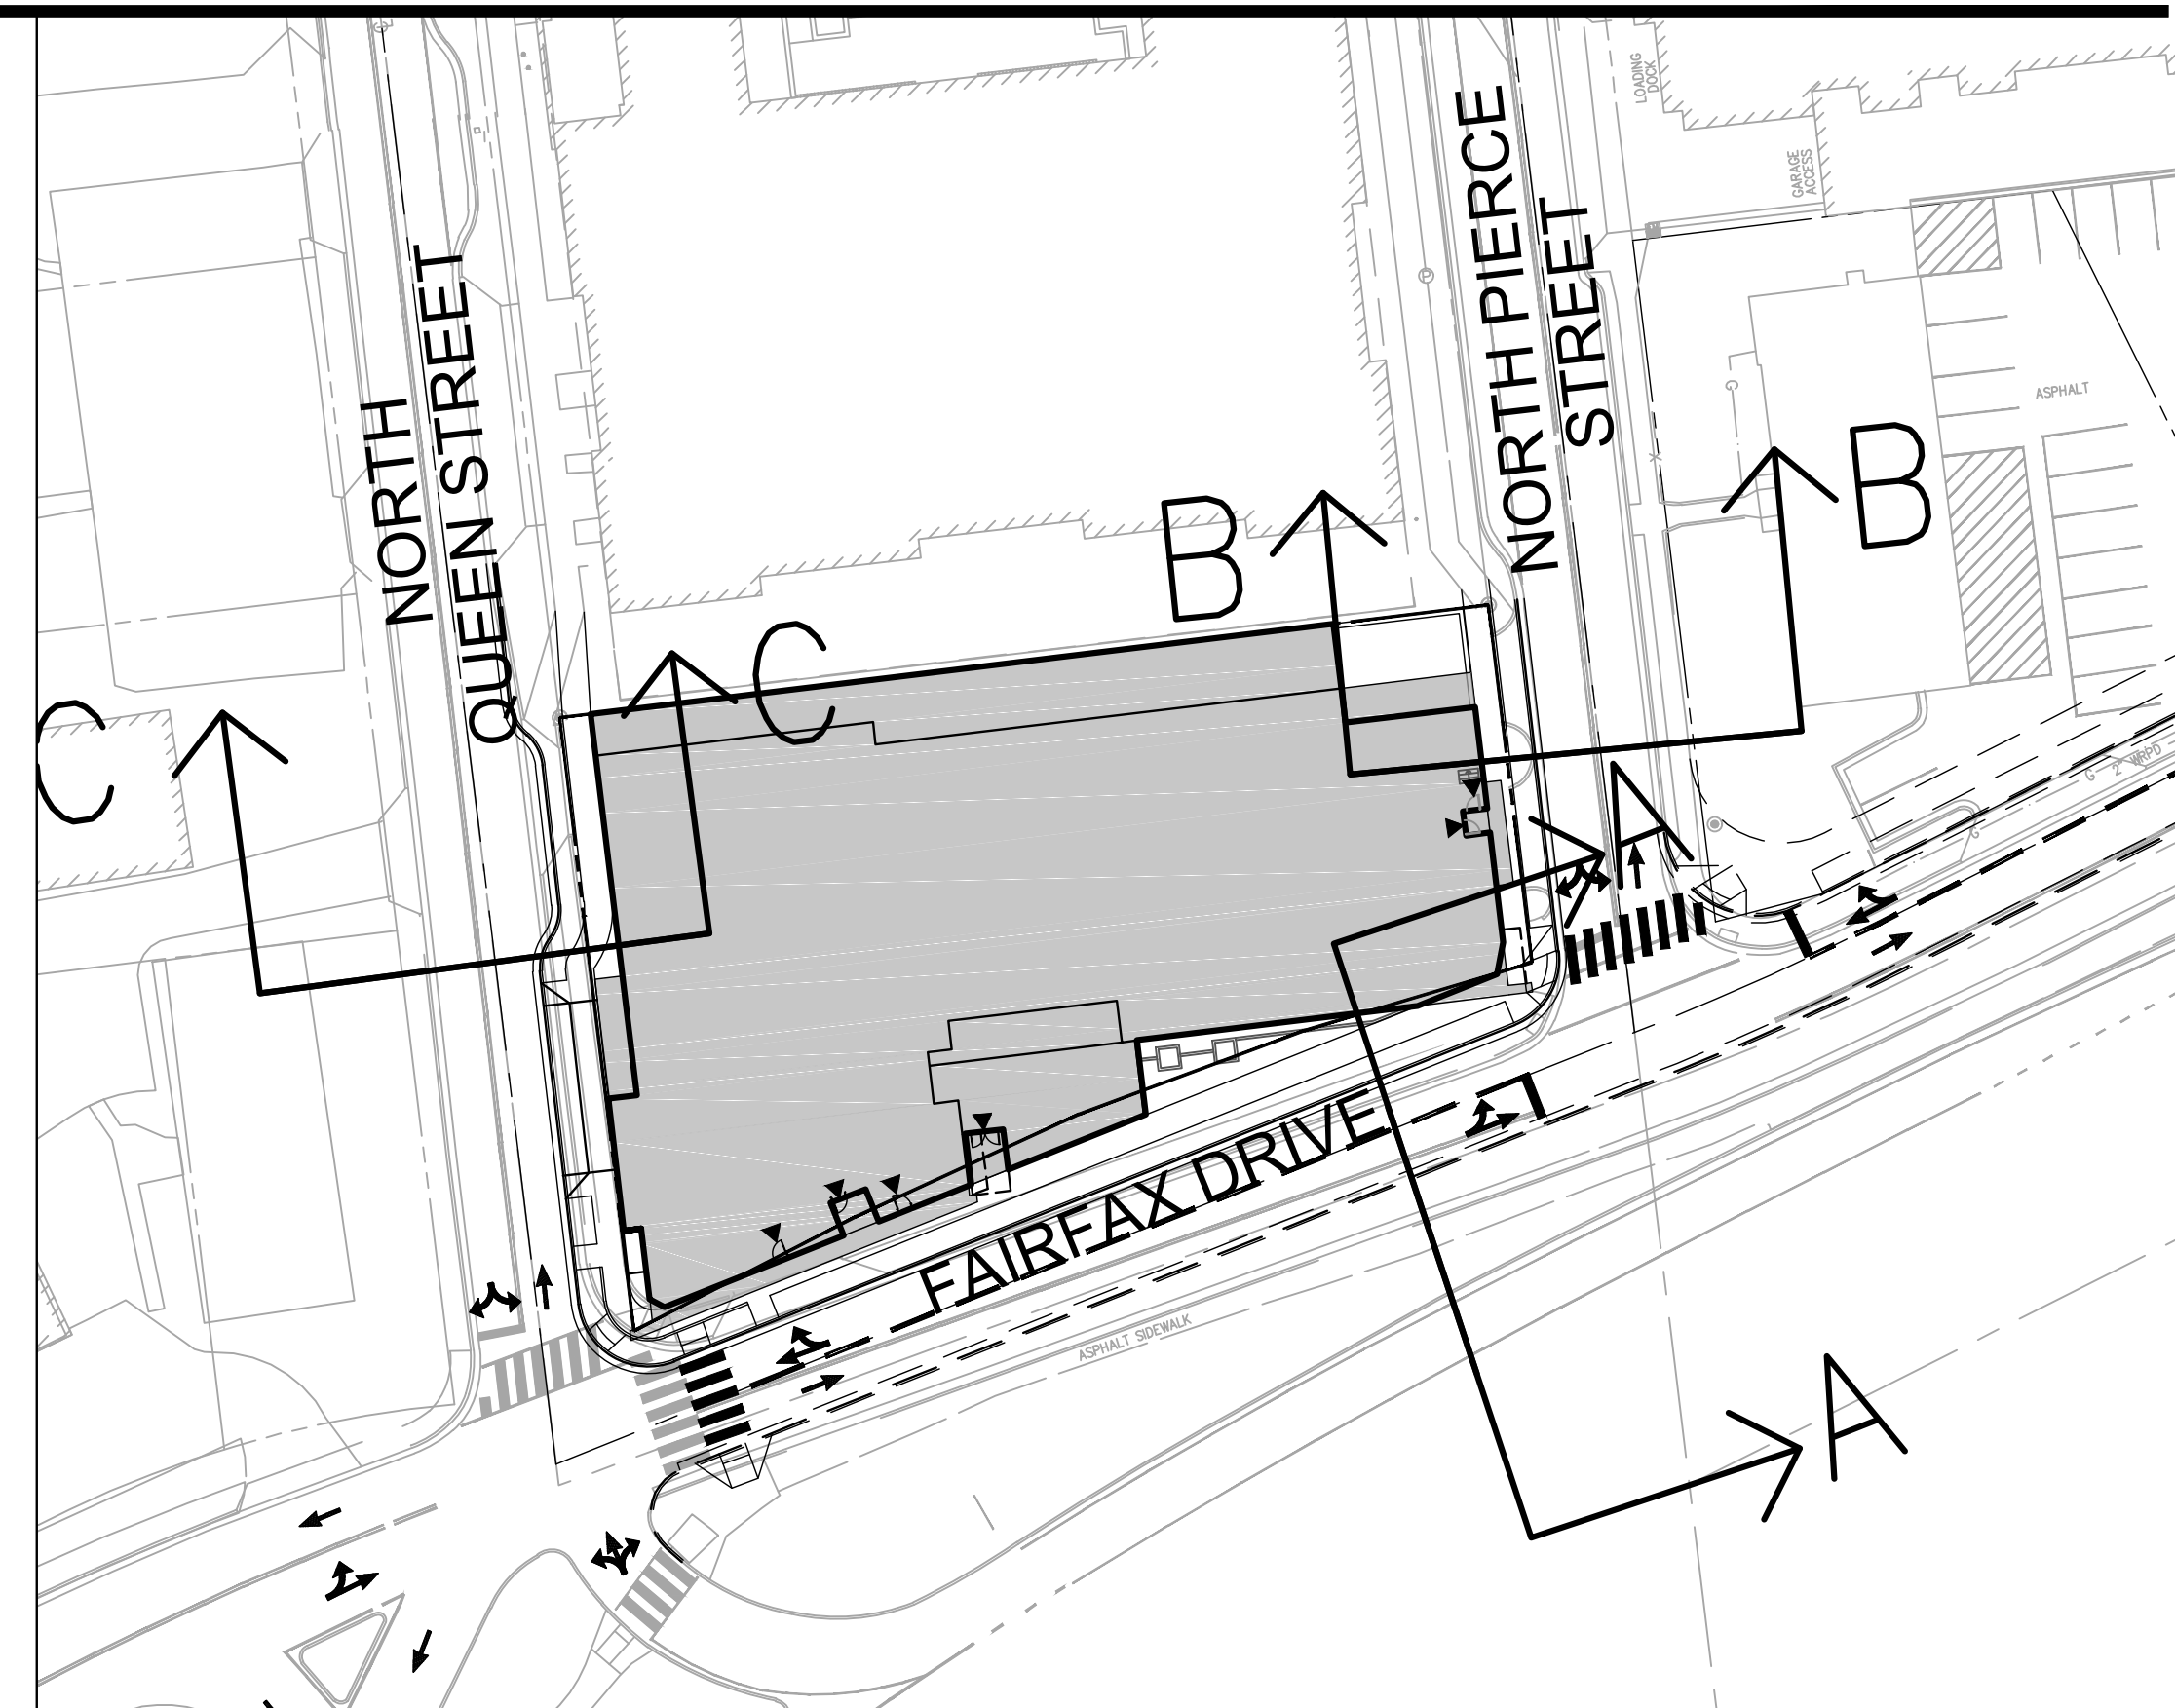


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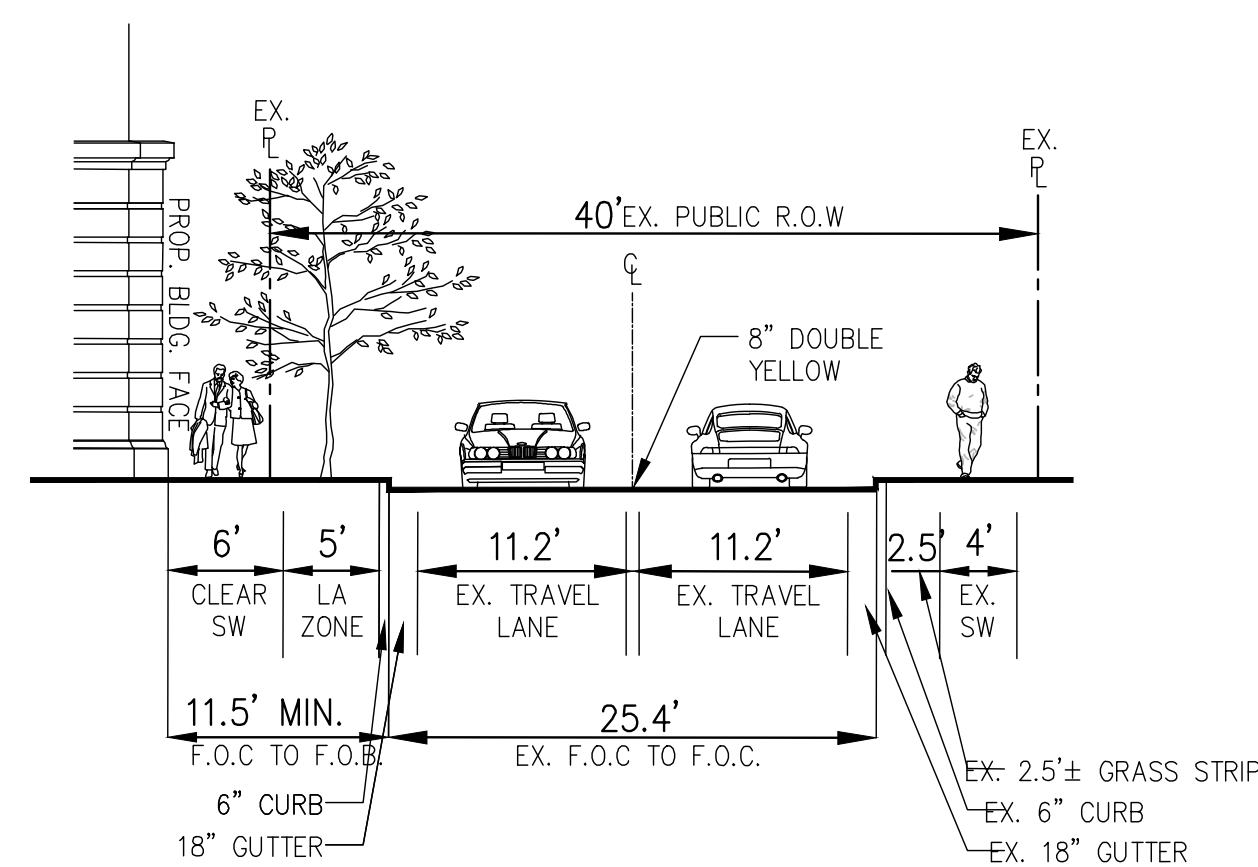
SECTION B-B (LOOKING NORTH)

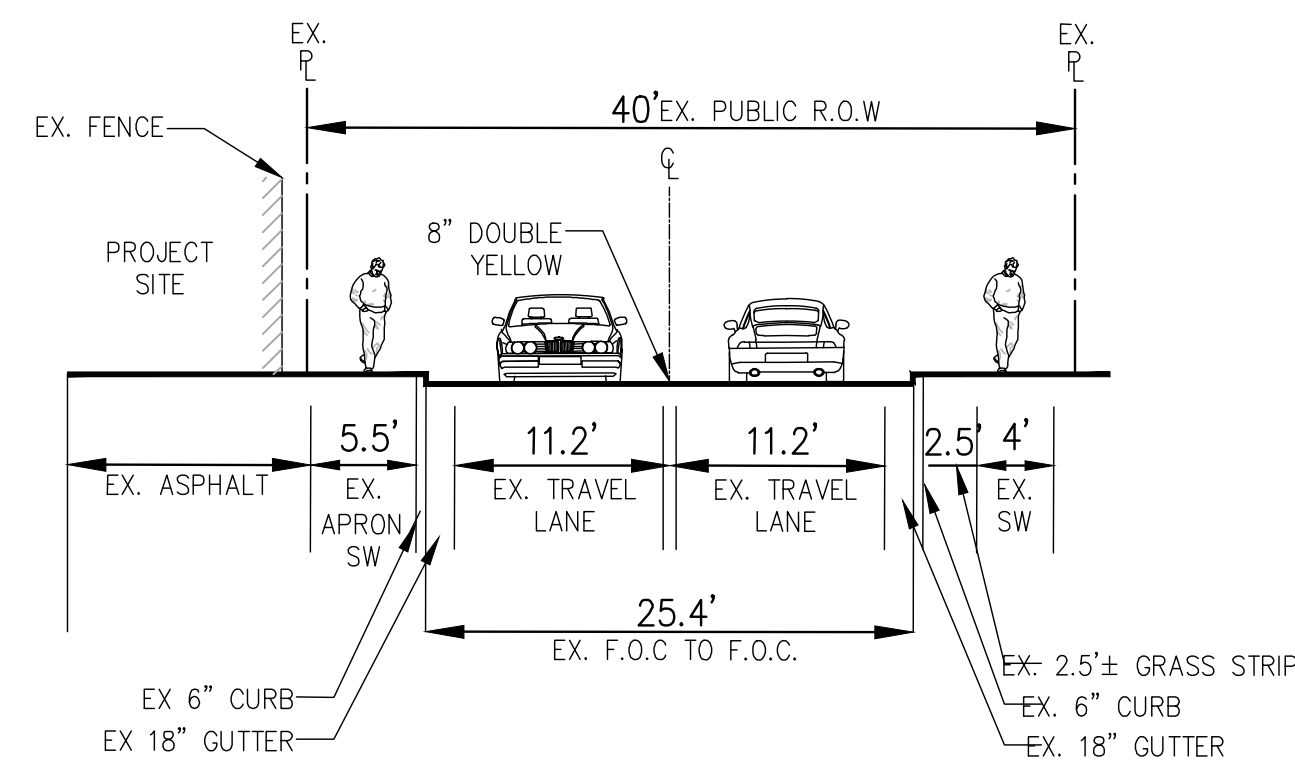EXISTING - NORTH PIERCE STREET




SECTION C-C (LOOKING NORTH)

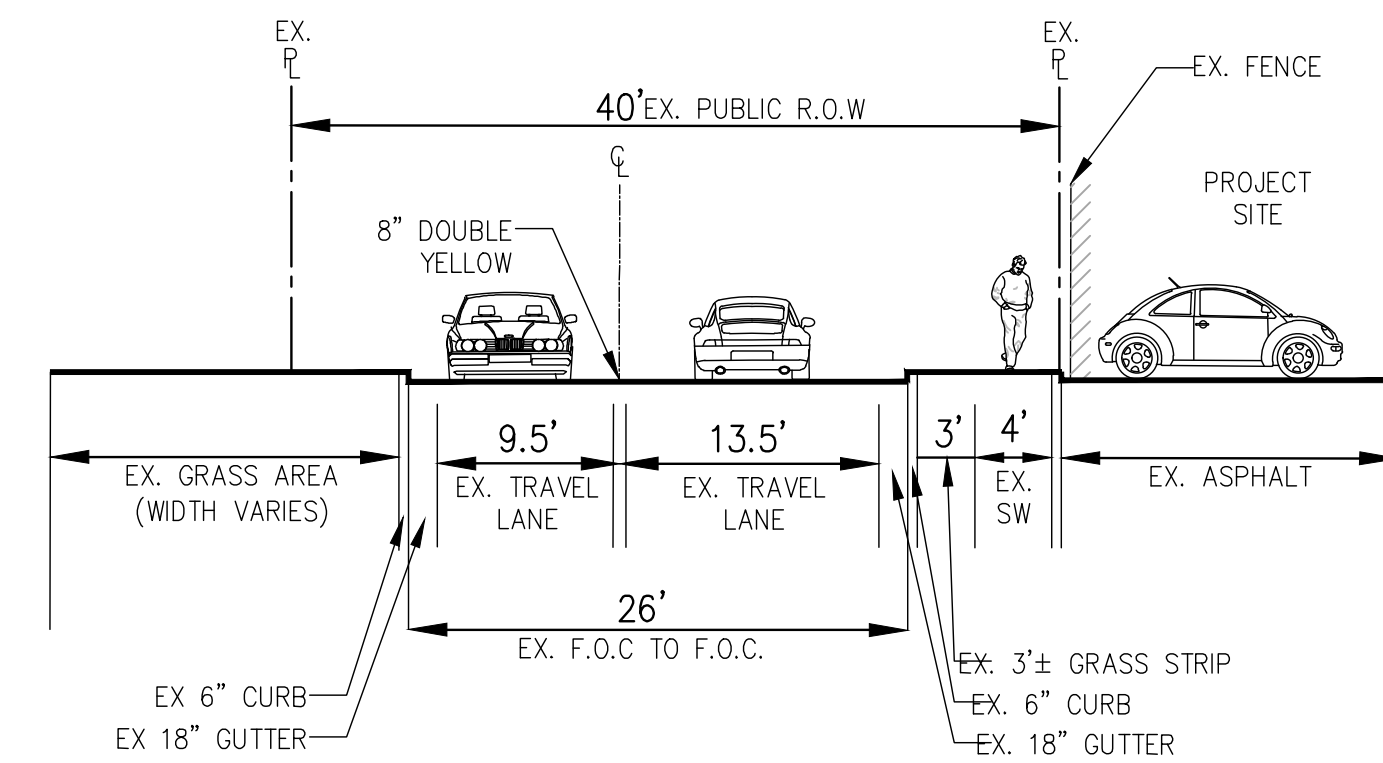EXISTING - NORTH QUEEN STREET




SECTION B-B (LOOKING NORTH)

PROPOSED - NORTH PIERCE STREET

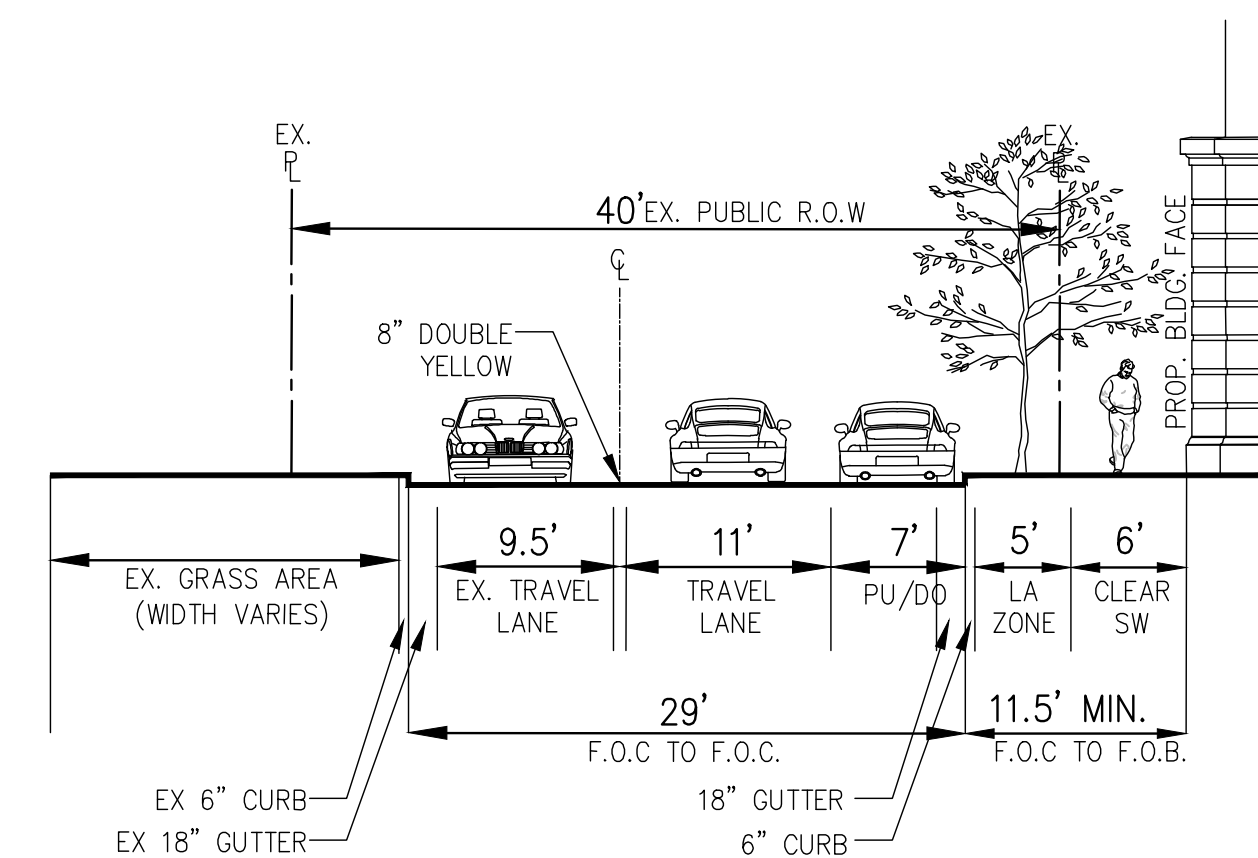

SECTION C-C (LOOKING NORTH)

PROPOSED - NORTH QUEEN STREET

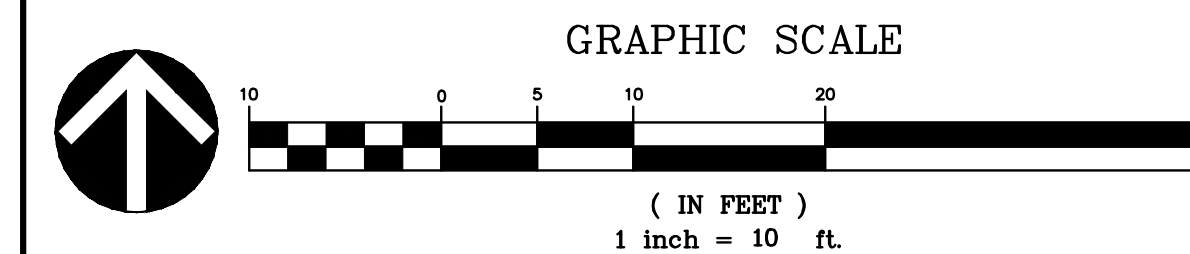


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PLAN STATUS	DATE
1st 4.1 SUBMISSION	10/19/2022
2nd 4.1 SUBMISSION	01/13/2023

POST-APPROVAL SHEET STATUS	DATE

PROFESSIONAL SEAL



1601 FAIRFAX DRIVE
4.1 SITE PLAN

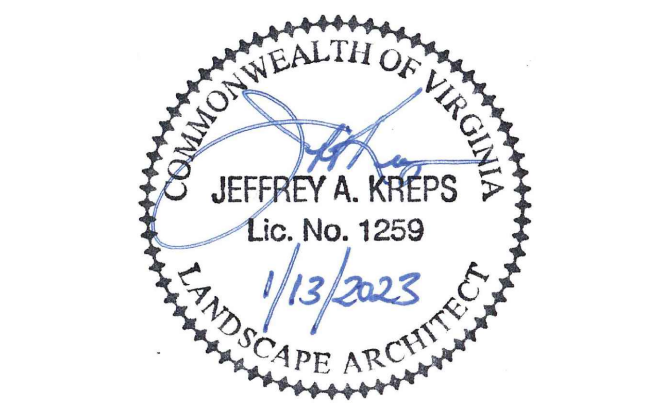ARLINGTON COUNTY, VIRGINIA

EXISTING & PROPOSED
STREET SECTIONS

DRAWN BY:	NDR
DESIGNED BY:	VIKA
DATE ISSUED:	10/19/2022
DWG. SCALE:	AS NOTED
VIKA NO.:	VV8348C
SHEET NO.:	C-09



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1st 4.1 SUBMISSION	10/19/2022
2nd 4.1 SUBMISSION	01/13/2023

POST-APPROVAL SHEET STATUS	DATE

PROFESSIONAL SEAL

1601 FAIRFAX DRIVE

4.1 SITE PLAN

ARLINGTON COUNTY, VIRGINIA


FIRE LANE MARKING PLAN


DRAWN BY:	NDR
DESIGNED BY:	VIKA
DATE ISSUED:	10/19/2022
DWG. SCALE:	1" = 25'
VIKA NO.:	VV8348C
SHEET NO.:	C-10



- LEGEND:**
- AERIAL FIRE APPARATUS ACCESS AREA
 - PROPOSED BUILDING LESS THAN 75' IN HEIGHT (ACCESS TO WITHIN 100' OF MAIN ENTRANCE)
 - PROPOSED BUILDING OVERHANG ABOVE
 - PROPOSED BLDG CANOPY/BALCONY
 - PROPOSED LIMITS OF UNDERGROUND GARAGE
 - PROPOSED STREET TREE
 - PEDESTRIAN ENTRANCE
 - PROPOSED WATER LINE
 - PROPOSED FIRE DEPARTMENT CONNECTION (FDC)
 - PROPOSED FIRE HYDRANT
 - 15' PROPOSED BUILDING OFFSET
 - 30' PROPOSED BUILDING OFFSET

NOTE:
 TOWER AND PODIUM HEIGHTS DERIVED FROM AVERAGE GRADE

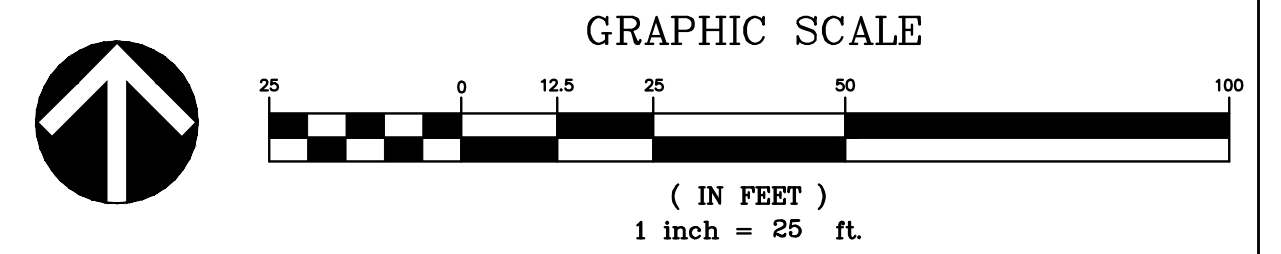
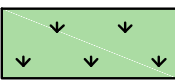


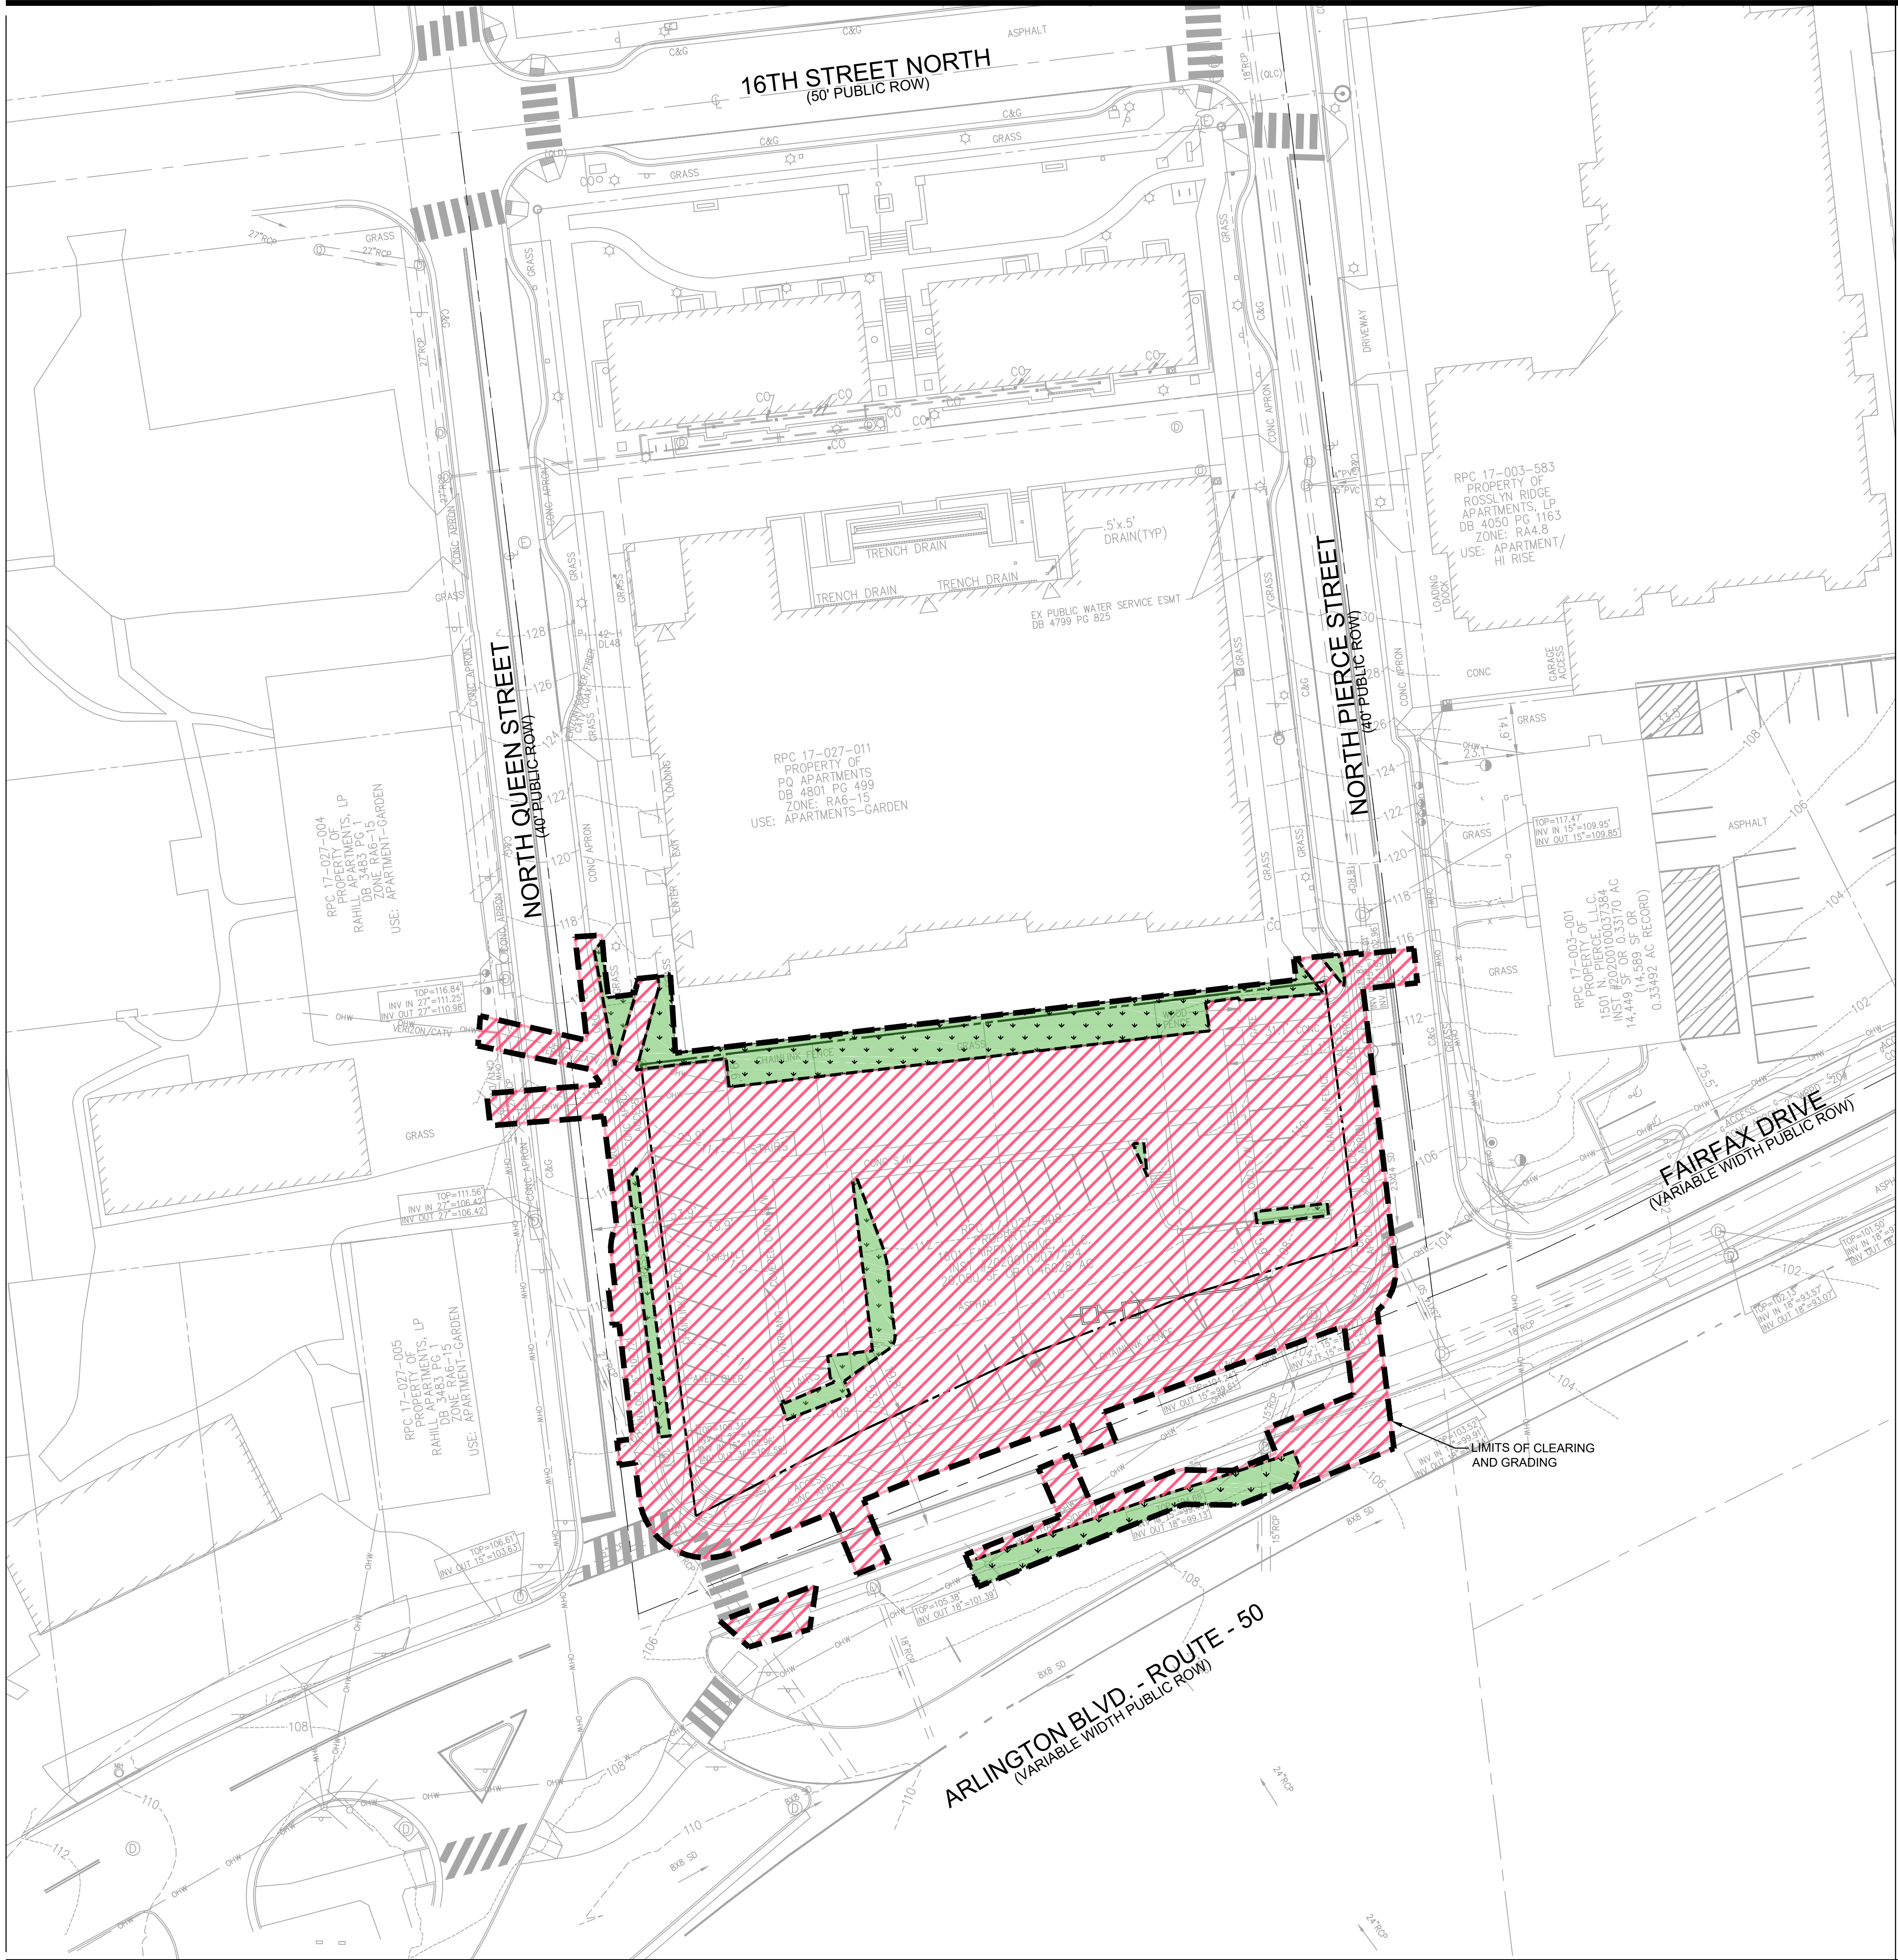

EXISTING CONDITIONS LAND USE MAP

EXISTING CONDITIONS LEGEND:

SWM BOUNDARY= 0.75 ACRES

-  EXISTING IMPERVIOUS AREA = 0.66 ACRES
-  EXISTING PERVIOUS AREA (MANAGED TURF) = 0.09 ACRES

V 12.00

PLAN STATUS	DATE
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2nd 4.1 SUBMISSION	01/13/2023

POST-APPROVAL SHEET STATUS	DATE


PROFESSIONAL SEAL




1601 FAIRFAX DRIVE
4.1 SITE PLAN

ARLINGTON COUNTY, VIRGINIA

PRE-SWM
BMP MAP

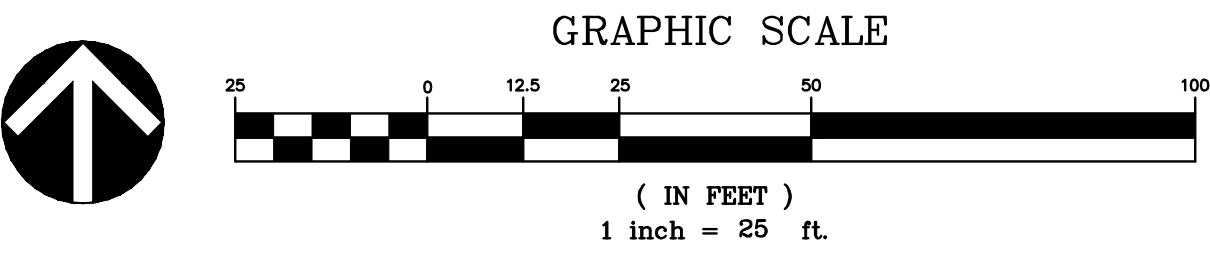

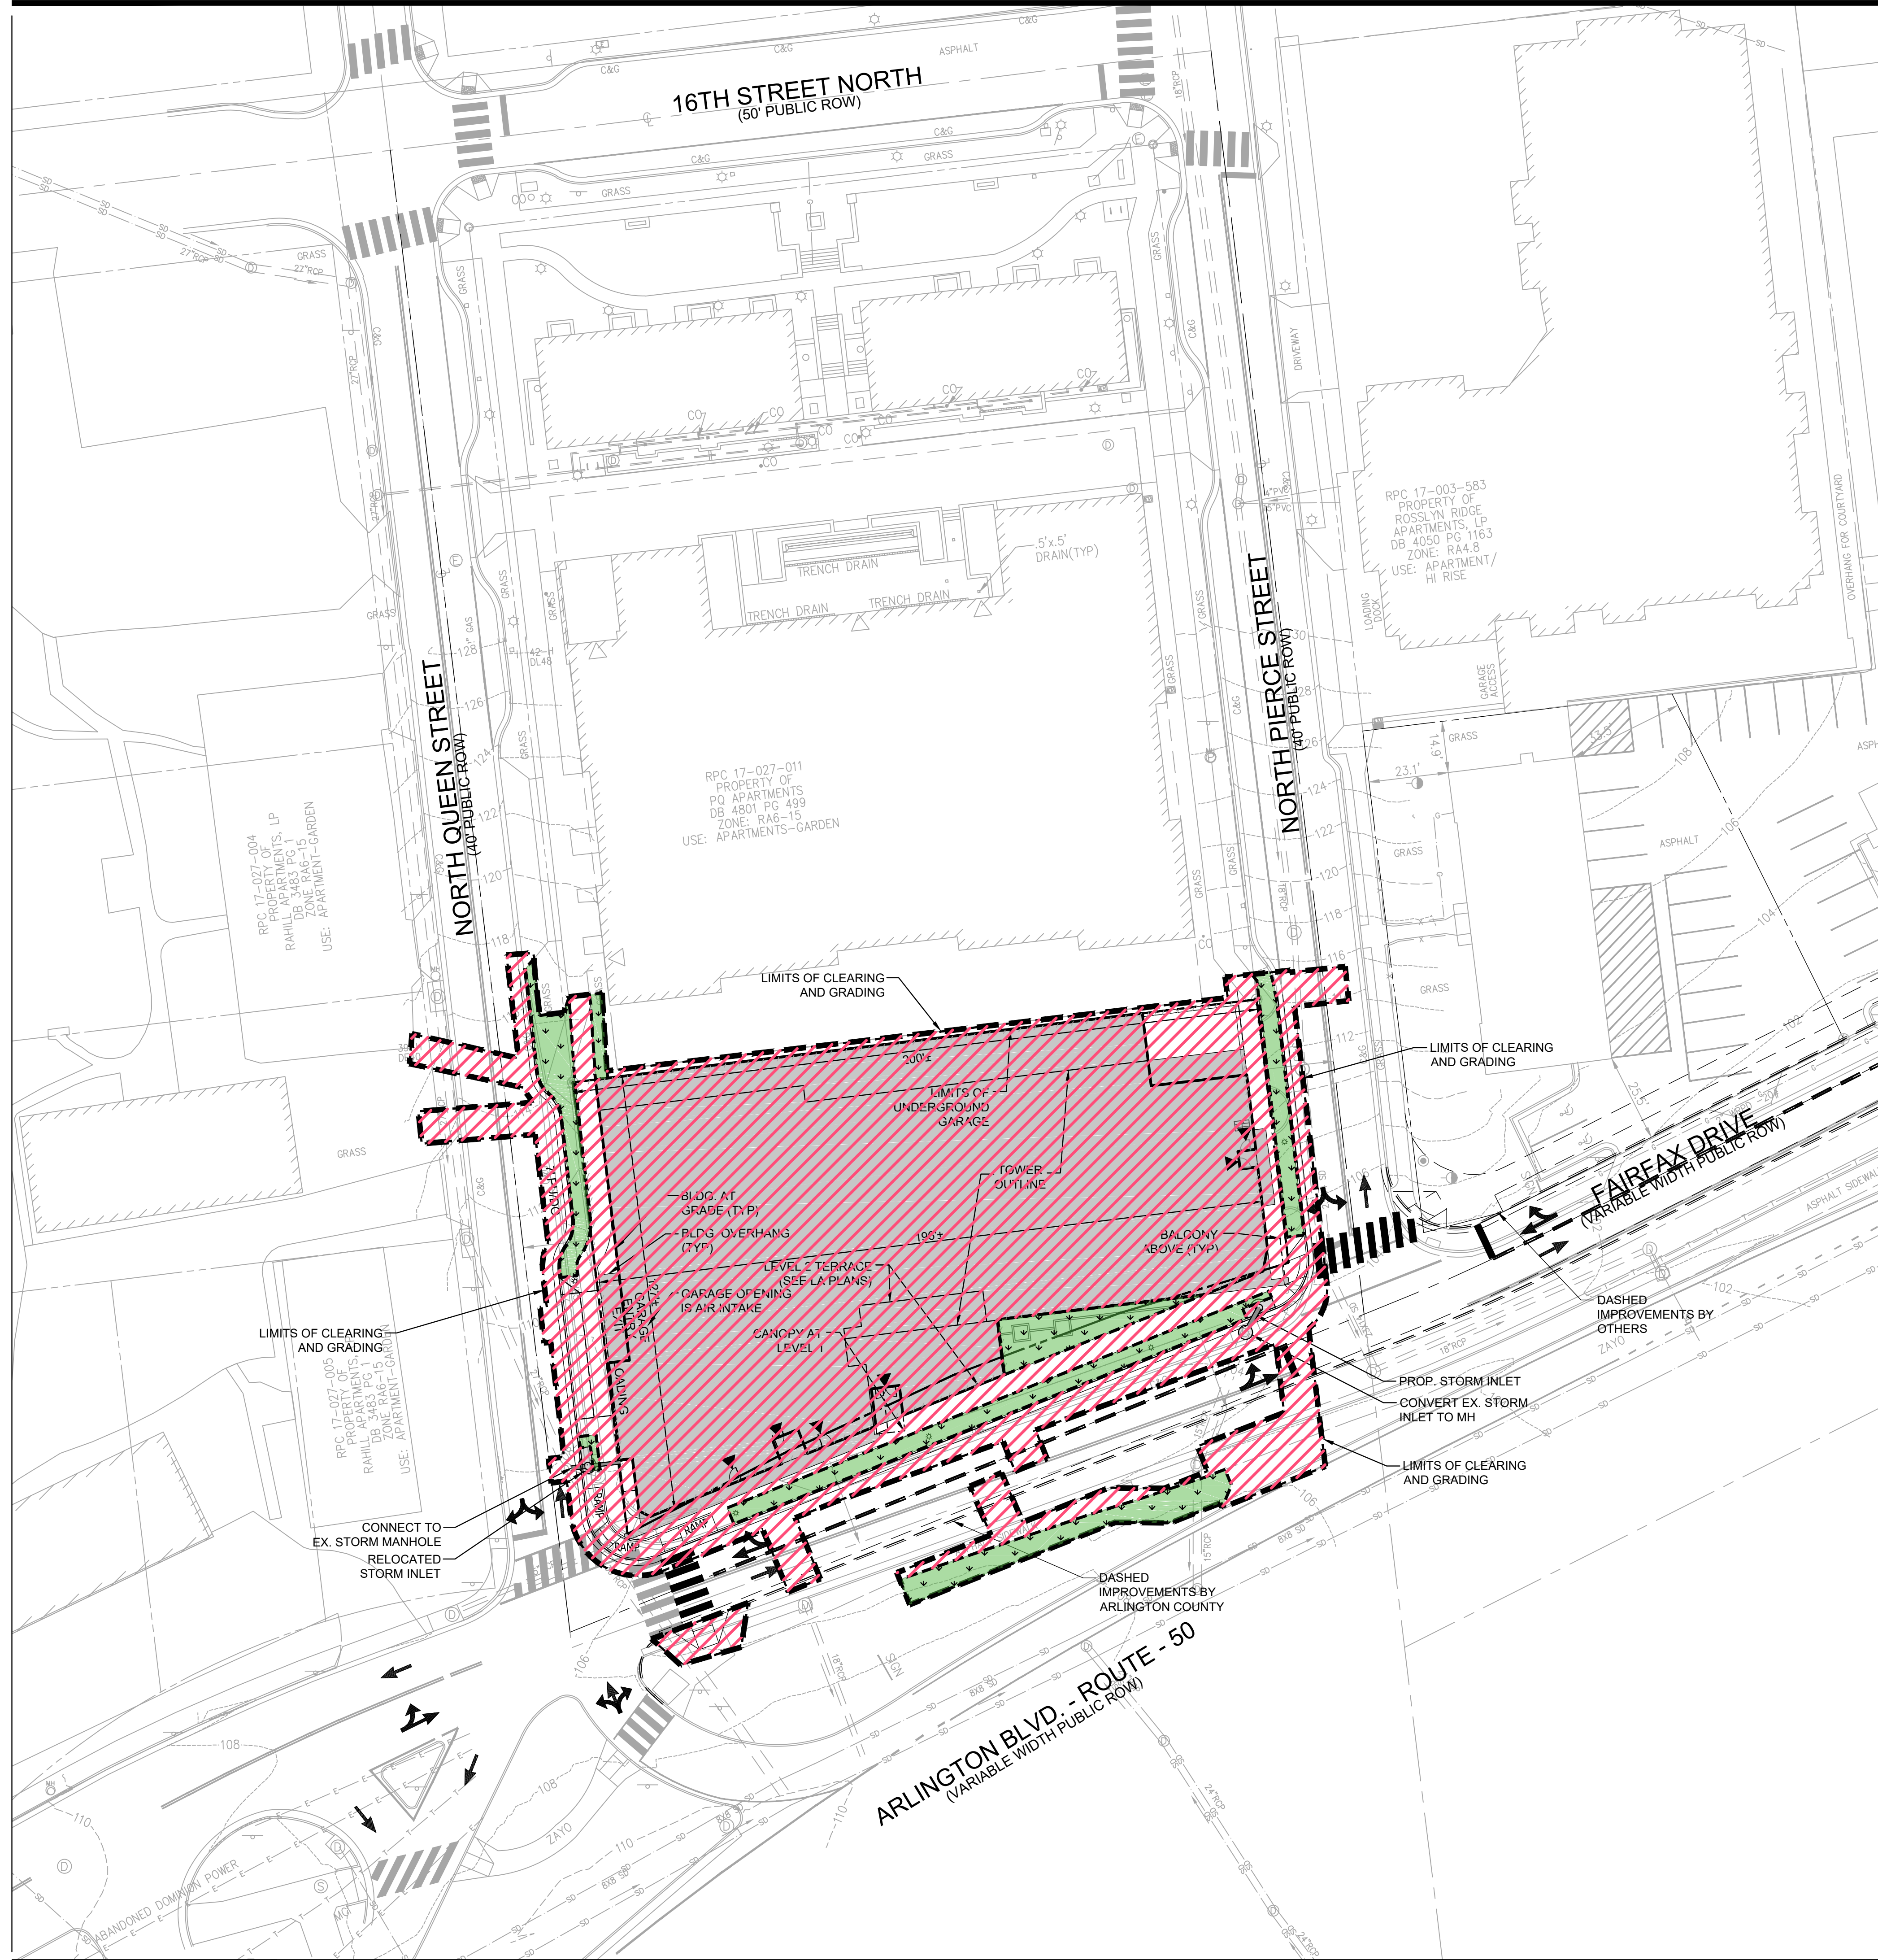

DRAWN BY:	NDR
DESIGNED BY:	VKA
DATE ISSUED:	10/19/2022
DWG. SCALE:	1"=25'
VKA NO.	VV8348C
SHEET NO.	C-11



PROPOSED CONDITIONS LAND USE MAP

PROPOSED CONDITIONS LEGEND:

-  PROPOSED IMPERVIOUS AREA = 0.68 ACRES
-  PROPOSED PERVIOUS AREA (MANAGED TURF) = 0.07 ACRES



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2nd 4.1 SUBMISSION	01/13/2023

POST-APPROVAL SHEET STATUS	DATE

PROFESSIONAL SEAL



1601 FAIRFAX DRIVE

4.1 SITE PLAN

ARLINGTON COUNTY, VIRGINIA

POST-SWM BMP MAP



DRAWN BY:	NRD
DESIGNED BY:	VIKA
DATE ISSUED:	10/19/2022
DWG. SCALE:	1" = 25'
VIKA NO.:	VV8348C
SHEET NO.:	C-12



PROPOSED SWM/BMP MAP

- DEVICE DCR STD./SPEC. (COMMON NAME)
- VEGETATED ROOF 1 (43) (EXTENSIVE GREEN ROOF)
 - CONTRIBUTING DRAINAGE (92)
 - URBAN BIORETENTION (ROOFTOP DISCONNECT TO SWM PLANTER)

STORMWATER MANAGEMENT NARRATIVE

THE SUBJECT SITE IS APPROXIMATELY 0.46 ACRES AND IS LOCATED BETWEEN FAIRFAX DRIVE, NORTH QUEEN STREET AND NORTH PIERCE STREET. THE APPROXIMATE LIMITS OF LAND DISTURBANCE OF THE SUBJECT APPLICATION IS 0.75 ACRES AND INCLUDES DISTURBANCE IN THE ROADWAYS. THE EXISTING SITE CURRENTLY CONSISTS OF A 3 STORY MOTEL WITH SURFACE PARKING. THE RUNOFF FROM THE PARKING LOT IS DIRECTED TO THE EXISTING STORM INLETS AT THE CORNERS OF FAIRFAX DRIVE AND NORTH PIERCE/NORTH QUEEN STREET.

THE PROPOSED DEVELOPMENT CONSISTS OF A TWO STORY UNDERGROUND PARKING STRUCTURE, A 2 STORY PODIUM AND ONE MULTI-STORY RESIDENTIAL TOWER. THE REQUIRED PHOSPHOROUS REMOVAL REDUCTION IS 10% IN ACCORDANCE WITH THE CURRENT VIRGINIA STATE REGULATIONS AND ARLINGTON COUNTY ORDINANCE REQUIREMENTS FOR REDEVELOPMENT OF AREAS LESS THAN ONE ACRE. AS SHOWN ON SHEET C-14, THE REQUIRED PHOSPHOROUS REDUCTION IS 0.1813 LB /YEAR. PHOSPHOROUS REDUCTION WILL BE ACHIEVED THROUGH A COMBINATION OF RUNOFF REDUCTION STRATEGIES INCLUDING BUT NOT LIMITED TO STORMWATER PLANTERS (ROOFTOP DISCONNECT) AND VEGETATED ROOFS. AS SHOWN ON SHEET C-15, ADDITIONAL DETENTION IS REQUIRED TO COMPLY WITH CHANNEL PROTECTION AND FLOOD PROTECTION REQUIREMENTS PER THE ENERGY BALANCE EQUATION.

IF NEEDED, ADDITIONAL STRUCTURAL BMPS MAY BE UTILIZED TO COMPLY WITH STATE AND COUNTY REGULATIONS.

THE FINAL SIZES, LOCATIONS AND TYPES OF THE PROPOSED SWM/BMP FACILITIES MAY BE ADJUSTED WITH THE FINAL CIVIL ENGINEERING PLAN (CEP). THE VRRM SPREADSHEET AND OTHER APPLICABLE COMPUTATIONS WILL ALSO BE FINALIZED WITH THE CEP BASED ON THE FINAL LIMITS OF DISTURBANCE. ADDITIONAL SWM/BMP FACILITIES WILL BE PROVIDED WITH THE CEP AS REQUIRED TO COMPLY WITH CURRENT SWM/BMP REGULATIONS.



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POST-APPROVAL SHEET STATUS	DATE

PROFESSIONAL SEAL




1601 FAIRFAX DRIVE

4.1 SITE PLAN

ARLINGTON COUNTY, VIRGINIA

STORMWATER MANAGEMENT PLAN

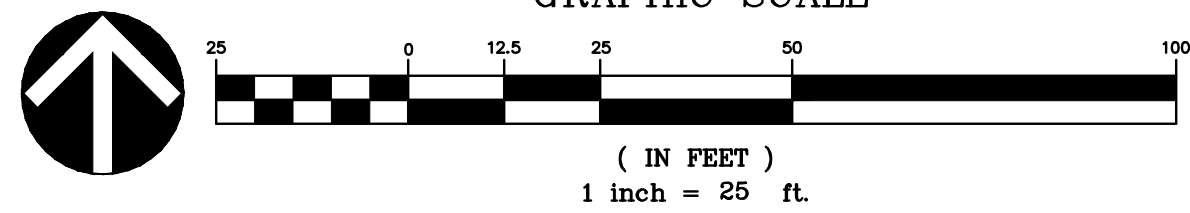

DRAWN BY:	NR
DESIGNED BY:	VIKA
DATE ISSUED:	10/19/2022
DWG. SCALE:	1" = 25'
VIKA NO.:	VV8348C
SHEET NO.:	C-13

Project Name: **INN AT ROSSLYN**
 Date: **10/19/2022**
 Linear Development Project? **No**

CLEAR ALL
 (Ctrl+Shift+R)

data input cells
constant values
calculation cells
final results

Site Information

Post-Development Project (Treatment Volume and Loads)

Enter Total Disturbed Area (acres) → **0.7500**

Maximum reduction required: 10%
The site's net increase in impervious cover (acres) is: 0.0200
Post-Development TP Load Reduction for Site (lb/yr): 0.1813

Check:
BMP Design Specifications List: 2013 Draft Stds & Specs
 Linear project? **No**
 Land cover areas entered correctly? **✓**
 Total disturbed area entered? **✓**

Pre-ReDevelopment Land Cover (acres)

	A Soils	B Soils	C Soils	D Soils	Totals
Forest/Open Space (acres) -- undisturbed, protected forest/open space or reforested					0.0000
Managed Turf (acres) -- disturbed, graded for yards or other turf to be				0.0950	0.0950
Impervious Cover (acres)				0.6550	0.6550
Totals					0.7500

Post-Development Land Cover (acres)

	A Soils	B Soils	C Soils	D Soils	Totals
Forest/Open Space (acres) -- undisturbed, protected forest/open space or reforested					0.0000
Managed Turf (acres) -- disturbed, graded for yards or other turf to be				0.0750	0.0750
Impervious Cover (acres)				0.6750	0.6750
Area Check	OK.	OK.	OK.	OK.	0.7500

Constants

Annual Rainfall (inches)	43
Target Rainfall Event (inches)	1.00
Total Phosphorus (TP) EMC (mg/L)	0.26
Total Nitrogen (TN) EMC (mg/L)	1.85
Target TP Load (lb/acre/yr)	0.41
Pj (unitless correction factor)	0.90

Runoff Coefficients (Rv)

	A Soils	B Soils	C Soils	D Soils
Forest/Open Space	0.02	0.03	0.04	0.05
Managed Turf	0.15	0.20	0.22	0.25
Impervious Cover	0.95	0.95	0.95	0.95

LAND COVER SUMMARY -- PRE-REDEVELOPMENT

Land Cover Summary-Pre		
Pre-ReDevelopment	Listed	Adjusted ¹
Forest/Open Space Cover (acres)	0.0000	0.0000
Weighted Rv(forest)	0.0000	0.0000
% Forest	0%	0%
Managed Turf Cover (acres)	0.0950	0.0750
Weighted Rv(turf)	0.2500	0.2500
% Managed Turf	13%	10%
Impervious Cover (acres)	0.6550	0.6550
Rv(impervious)	0.9500	0.9500
% Impervious	87%	90%
Total Site Area (acres)	0.7500	0.7300
Site Rv	0.8613	0.8781

LAND COVER SUMMARY -- POST DEVELOPMENT

Land Cover Summary-Post (Final)		Land Cover Summary-Post		Land Cover Summary-Post	
Post ReDev. & New Impervious		Post-ReDevelopment		Post-Development New Impervious	
Forest/Open Space Cover (acres)	0.0000	Forest/Open Space Cover (acres)	0.0000		
Weighted Rv(forest)	0.0000	Weighted Rv(forest)	0.0000		
% Forest	0%	% Forest	0%		
Managed Turf Cover (acres)	0.0750	Managed Turf Cover (acres)	0.0750		
Weighted Rv (turf)	0.2500	Weighted Rv (turf)	0.2500		
% Managed Turf	10%	% Managed Turf	10%		
Impervious Cover (acres)	0.6750	ReDev. Impervious Cover (acres)	0.6550	New Impervious Cover (acres)	0.0200
Rv(impervious)	0.9500	Rv(impervious)	0.9500	Rv(impervious)	0.9500
% Impervious	90%	% Impervious	90%		
Final Site Area (acres)	0.7500	Total ReDev. Site Area (acres)	0.7300		
Final Post Dev Site Rv	0.8800	ReDev Site Rv	0.8781		

Treatment Volume and Nutrient Load

Pre-ReDevelopment	Listed	Adjusted ¹
Pre-ReDevelopment Treatment Volume (acre-ft)	0.0538	0.0534
Pre-ReDevelopment Treatment Volume (cubic feet)	2,344.9800	2,326.8300
Pre-ReDevelopment TP Load (lb/yr)	1.4733	1.4619
Pre-ReDevelopment TP Load per acre (lb/acre/yr)	1.9600	2.0000
Baseline TP Load (lb/yr) <i>(0.41 lbs/acre/yr applied to pre-redevelopment area excluding pervious land proposed for new impervious cover)</i>		0.2993

Treatment Volume and Nutrient Load

Final Post-Development Treatment Volume (acre-ft)	0.0550	Post-ReDevelopment Treatment Volume (acre-ft)	0.0534	Post-Development Treatment Volume (acre-ft)	0.0016
Final Post-Development Treatment Volume (cubic feet)	2,395.8000	Post-ReDevelopment Treatment Volume (cubic feet)	2,326.8300	Post-Development Treatment Volume (cubic feet)	68.9700
Final Post-Development TP Load (lb/yr)	1.5053	Post-ReDevelopment TP Load (lb/yr)*	1.4619	Post-Development TP Load (lb/yr)	0.0433
Final Post-Development TP Load per acre (lb/acre/yr)	2.0100	Post-ReDevelopment TP Load per acre (lb/acre/yr)	2.0000		
		Max. Reduction Required (Below Pre-Development Load)	0.1000		

¹ Adjusted Land Cover Summary: Pre ReDevelopment land cover minus pervious land cover (forest/open space or managed turf) acreage proposed for new impervious cover.

Adjusted total acreage is consistent with Post-ReDevelopment acreage (minus acreage of new impervious cover).

Column 1 shows load reduction requirement for new impervious cover (based on new development load limit, 0.41 lbs/acre/year).

Post-Development Requirement for Site Area

TP Load Reduction Required (lb/yr) 0.1813

Drainage Area A

Drainage Area A Land Cover (acres)	A Soils	B Soils	C Soils	D Soils	Totals	Land Cover Rv
Forest/Open Space (acres)					0.0000	0.0000
Managed Turf (acres)				0.0500	0.0500	0.2500
Impervious Cover (acres)				0.6500	0.6500	0.9500
Total					0.7000	

CLEAR BMP AREAS

Total Phosphorus Available for Removal in D.A. A (lb/yr) **1.4369**
 Post Development Treatment Volume in D.A. A (ft³) **2,286.9000**

Stormwater Best Management Practices (RR = Runoff Reduction)

Practice	Runoff Reduction Credit (%)	Managed Turf Credit Area (acres)	Impervious Cover Credit Area (acres)	Volume from Upstream Practice (ft ³)	Runoff Reduction (ft ³)	Remaining Runoff Volume (ft ³)	Total BMP Treatment Volume (ft ³)	Phosphorus Removal Efficiency (%)	Phosphorus Load from Upstream Practices (lb)	Untreated Phosphorus Load to Practice (lb)	Phosphorus Removed By Practice (lb)	Remaining Phosphorus Load (lb)	Downstream Practice to be Employed
1. Vegetated Roof (RR)													
1.a. Vegetated Roof #1 (Spec #5)	45		0.0400		62.0730	75.8670	137.9400	0		0.0866	0.0390	0.0476	
1.b. Vegetated Roof #2 (Spec #5)	60				0.0000	0.0000	0.0000	0		0.0000	0.0000	0.0000	
2. Rooftop Disconnection (RR)													
2.1. To Stormwater Planter, Urban Bioretention (Spec #9, Appendix A)	40		0.2500	0.0000	344.8500	517.2750	862.1250	25	0.0000	0.5411	0.2976	0.2435	

Site Results (Water Quality Compliance)

Area Checks	D.A. A	D.A. B	D.A. C	D.A. D	D.A. E	AREA CHECK
FOREST/OPEN SPACE (ac)	0.0000	0.0000	0.0000	0.0000	0.0000	OK.
IMPERVIOUS COVER (ac)	0.6500	0.0000	0.0000	0.0000	0.0000	OK.
IMPERVIOUS COVER TREATED (ac)	0.2900	0.0000	0.0000	0.0000	0.0000	OK.
MANAGED TURF AREA (ac)	0.0500	0.0000	0.0000	0.0000	0.0000	OK.
MANAGED TURF AREA TREATED (ac)	0.0000	0.0000	0.0000	0.0000	0.0000	OK.
AREA CHECK	OK.	OK.	OK.	OK.	OK.	

Site Treatment Volume (ft³) **2,395.8000**

Runoff Reduction Volume and TP By Drainage Area

	D.A. A	D.A. B	D.A. C	D.A. D	D.A. E	TOTAL
RUNOFF REDUCTION VOLUME ACHIEVED (ft³)	406.9230	0.0000	0.0000	0.0000	0.0000	406.9230
TP LOAD AVAILABLE FOR REMOVAL (lb/yr)	1.4369	0.0000	0.0000	0.0000	0.0000	1.4369
TP LOAD REDUCTION ACHIEVED (lb/yr)	0.3365	0.0000	0.0000	0.0000	0.0000	0.3365
TP LOAD REMAINING (lb/yr)	1.1003	0.0000	0.0000	0.0000	0.0000	1.1003
NITROGEN LOAD REDUCTION ACHIEVED (lb/yr)	2.7559	0.0000	0.0000	0.0000	0.0000	2.7559

Total Phosphorus

FINAL POST-DEVELOPMENT TP LOAD (lb/yr) 1.5053
TP LOAD REDUCTION REQUIRED (lb/yr) 0.1813
TP LOAD REDUCTION ACHIEVED (lb/yr) 0.3365
TP LOAD REMAINING (lb/yr) 1.1687
REMAINING TP LOAD REDUCTION REQUIRED (lb/yr): 0.0000 **
**** TARGET TP REDUCTION EXCEEDED BY 0.1552 LB/YEAR ****

Total Nitrogen (For Information Purposes)
POST-DEVELOPMENT LOAD (lb/yr) 10.7685
NITROGEN LOAD REDUCTION ACHIEVED (lb/yr) 2.7559
REMAINING POST-DEVELOPMENT NITROGEN LOAD (lb/yr) 8.0126



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2nd 4.1 SUBMISSION	01/13/2023

POST-APPROVAL SHEET STATUS	DATE

PROFESSIONAL SEAL



1601 FAIRFAX DRIVE
4.1 SITE PLAN

ARLINGTON COUNTY, VIRGINIA

STORMWATER MANAGEMENT COMPUTATIONS

DRAWN BY:	NDR
DESIGNED BY:	VIKA
DATE ISSUED:	10/19/2022
DWG. SCALE:	N/A
VIKA NO.:	VV8348C
SHEET NO.:	C-14



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INN AT ROSSLYN

PRE-DEVELOP

Fairfax NOAA-C County, Virginia

Sub-Area Land Use and Curve Number Details

Table with columns: Sub-Area Identifier, Land Use, Hydrologic Soil Group, Sub-Area Area (ac), Curve Number. Includes rows for PRE (Open space, grass cover > 75%, Paved parking lots, roofs, driveways) and Total Area / Weighted Curve Number.

Hydrograph Peak/Peak Time Table

Table with columns: Sub-Area Identifier, Peak Flow and Peak Time (hr) by Rainfall Return Period or Reach (10-Yr, 1-Yr). Includes rows for SUBAREAS and PRE.

EJI

INN AT ROSSLYN

POST DEVELOPED

Fairfax NOAA-C County, Virginia

Sub-Area Land Use and Curve Number Details

Table with columns: Sub-Area Identifier, Land Use, Hydrologic Soil Group, Sub-Area Area (ac), Curve Number. Includes rows for POST (User defined urban) and Total Area / Weighted Curve Number.

Hydrograph Peak/Peak Time Table

Table with columns: Sub-Area Identifier, Peak Flow and Peak Time (hr) by Rainfall Return Period or Reach (10-Yr, 1-Yr). Includes rows for SUBAREAS and POST.

SWM Water Quantity Energy Balance Worksheet

Complex worksheet table with columns: SITE AREA, PRE, POST (adjusted), Qpre-development, QPost Development, RVPost Development, Qallowable. Includes sub-sections for CHANNEL PROTECTION and FLOOD CONTROL.

Drainage Area Curve Numbers and Runoff Depths*
Curve numbers (CN, CNadj) and runoff depths (RV Developed) are computed with and without reduction practices.

Drainage Area A table showing soil types (A, B, C, D) and runoff depths for 1-year, 2-year, and 10-year storms. Includes Total Area and Runoff Reduction Volume.

NOTE:

A DETENTION VAULT (APPROXIMATELY 700 CUBIC FEET) WILL BE LOCATED IN THE PROPOSED GARAGE. FINAL LOCATION AND SIZE IS SUBJECT TO CHANGE AND WILL BE FINALIZED WITH THE CEP.

V 12.00

PLAN STATUS table with columns: PLAN STATUS, DATE. Includes rows for 1st and 2nd 4.1 SUBMISSION.

POST-APPROVAL SHEET STATUS table with columns: POST-APPROVAL SHEET STATUS, DATE.

PROFESSIONAL SEAL



1601 FAIRFAX DRIVE

4.1 SITE PLAN

ARLINGTON COUNTY, VIRGINIA

STORMWATER MANAGEMENT COMPUTATIONS

Metadata table with columns: DRAWN BY, DESIGNED BY, DATE ISSUED, DWG. SCALE, VIKA NO., SHEET NO. Includes values like NDR, VIKA, 10/19/2022, N/A, VV8348C, C-15.

