

- 1. BASE TOPOGRAPHICAL AND EXISTING CONDITIONS TAKEN FROM DRAWING FURNISHED BY
- 2. DRAWINGS PREPARED FROM CIVIL AND ARCHITECTURAL DRAWINGS, NOT AS-BUILT DATA PREPARED BY WALTER L. PHILIPS, INC., RECEIVED 08.27.2024 AND DCS DESIGNS,
- 3. UTILITY WORK IS NOT INDICATED ON THIS DRAWING. REFER TO CIVIL DRAWINGS FOR
- PAVEMENTS; FROM COLUMN CENTERLINES TO HARDSCAPE CENTERLINES, TO CENTERLINE OF PAVEMENTS, TO OUTSIDE EDGE OF PAVEMENTS, TO CENTERLINES OF STAIRS; FROM EDGE OF PAVEMENT TO FACE OF WALL UNLESS OTHERWISE SPECIFIED.
- 6. ALL CURVES TO BE TRUE RADII WITHOUT STRAIGHT SEGMENTS.
- 8. CHANGES IN LAYOUT MAY BE MADE AT THIS TIME TO ACCOMMODATE DESIGN INTENT OR
- CONTRACTOR TO NOTIFY LANDSCAPE ARCHITECT IMMEDIATELY OF ANY DISCREPANCIES FOUND IN PLANS AND ANY CONFLICTS ENCOUNTERED IN FIELD.
- RESPONSIBLE FOR VERIFYING ALL QUANTITIES.
- 11. CONTRACTOR SHALL VERIFY ALL DIMENSIONS PRIOR TO CONSTRUCTION.
- 12. ALL WALLS, SIDEWALKS, PATHWAYS, FENCES, AND STAIRWAYS SHALL BE COMPLETELY LAID OUT AND STAKED WITH VISIBLE MARKERS. THE STAKES SHALL BE APPROVED IN THE FIELD BY LANDSCAPE ARCHITECT PRIOR TO CONSTRUCTION. THE CONTRACTOR SHALL NOTIFY LANDSCAPE ARCHITECT 48 HOURS PRIOR TO SITE VISIT.
- 13. CONTRACTOR IS RESPONSIBLE FOR ALL WIRING, CONDUIT, FOOTINGS, PERMITS, ETC. POWER CONNECTIONS WITH ELECTRICAL ENGINEER AND OWNER.
- 14. BENCH AND LITTER RECEPTACLE LAYOUT SHOWN IS APPROXIMATE. LAYOUT TO BE
- 15. ALL MATERIALS' SPECIFICATIONS SHALL BE IN ACCORDANCE WITH THE INDUSTRY STANDARD FOR GRADING PLANT MATERIAL - THE AMERICAN STANDARD FOR NURSERY
- 16. MAINTENANCE OF ALL TREES AND LANDSCAPE MATERIALS SHALL CONFORM TO ACCEPTED INDUSTRY STANDARDS SET FORTH BY THE LANDSCAPE CONTRACTORS ASSOCIATION, AMERICAN SOCIETY OF LANDSCAPE ARCHITECTS, THE INTERNATIONAL SOCIETY OF ARBORICULTURE, AND THE AMERICAN NATIONAL STANDARDS INSTITUTE.

- 5. DIMENSIONS ARE FROM BACK OF CURB, TO FACE OF WALL, TO OUTSIDE EDGE OF
- FIELD CONDITIONS. NO ADDITIONAL PAYMENT WILL BE MADE TO THE CONTRACTOR FOR
- 10. QUANTITIES REFERENCED IN PLANS ARE SHOWN AS A COURTESY ONLY. CONTRACTOR IS
- NECESSARY TO COMPLETE SITE LIGHTING INSTALLATION. CONTRACTOR TO COORDINATE
- APPROVED IN THE FIELD BY LANDSCAPE ARCHITECT.

750 23RD STREET SOUTH


750 23RD STREET SOUTH ARLINGTON, VA 22202 ARLINGTON COUNTY

CLIENT

WESLEY HOUSING

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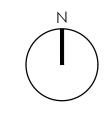
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DAVID JUDD

DRAWN: APPROVED/CHECKED:

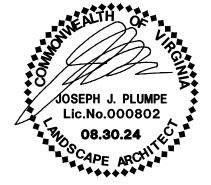CONTACT:


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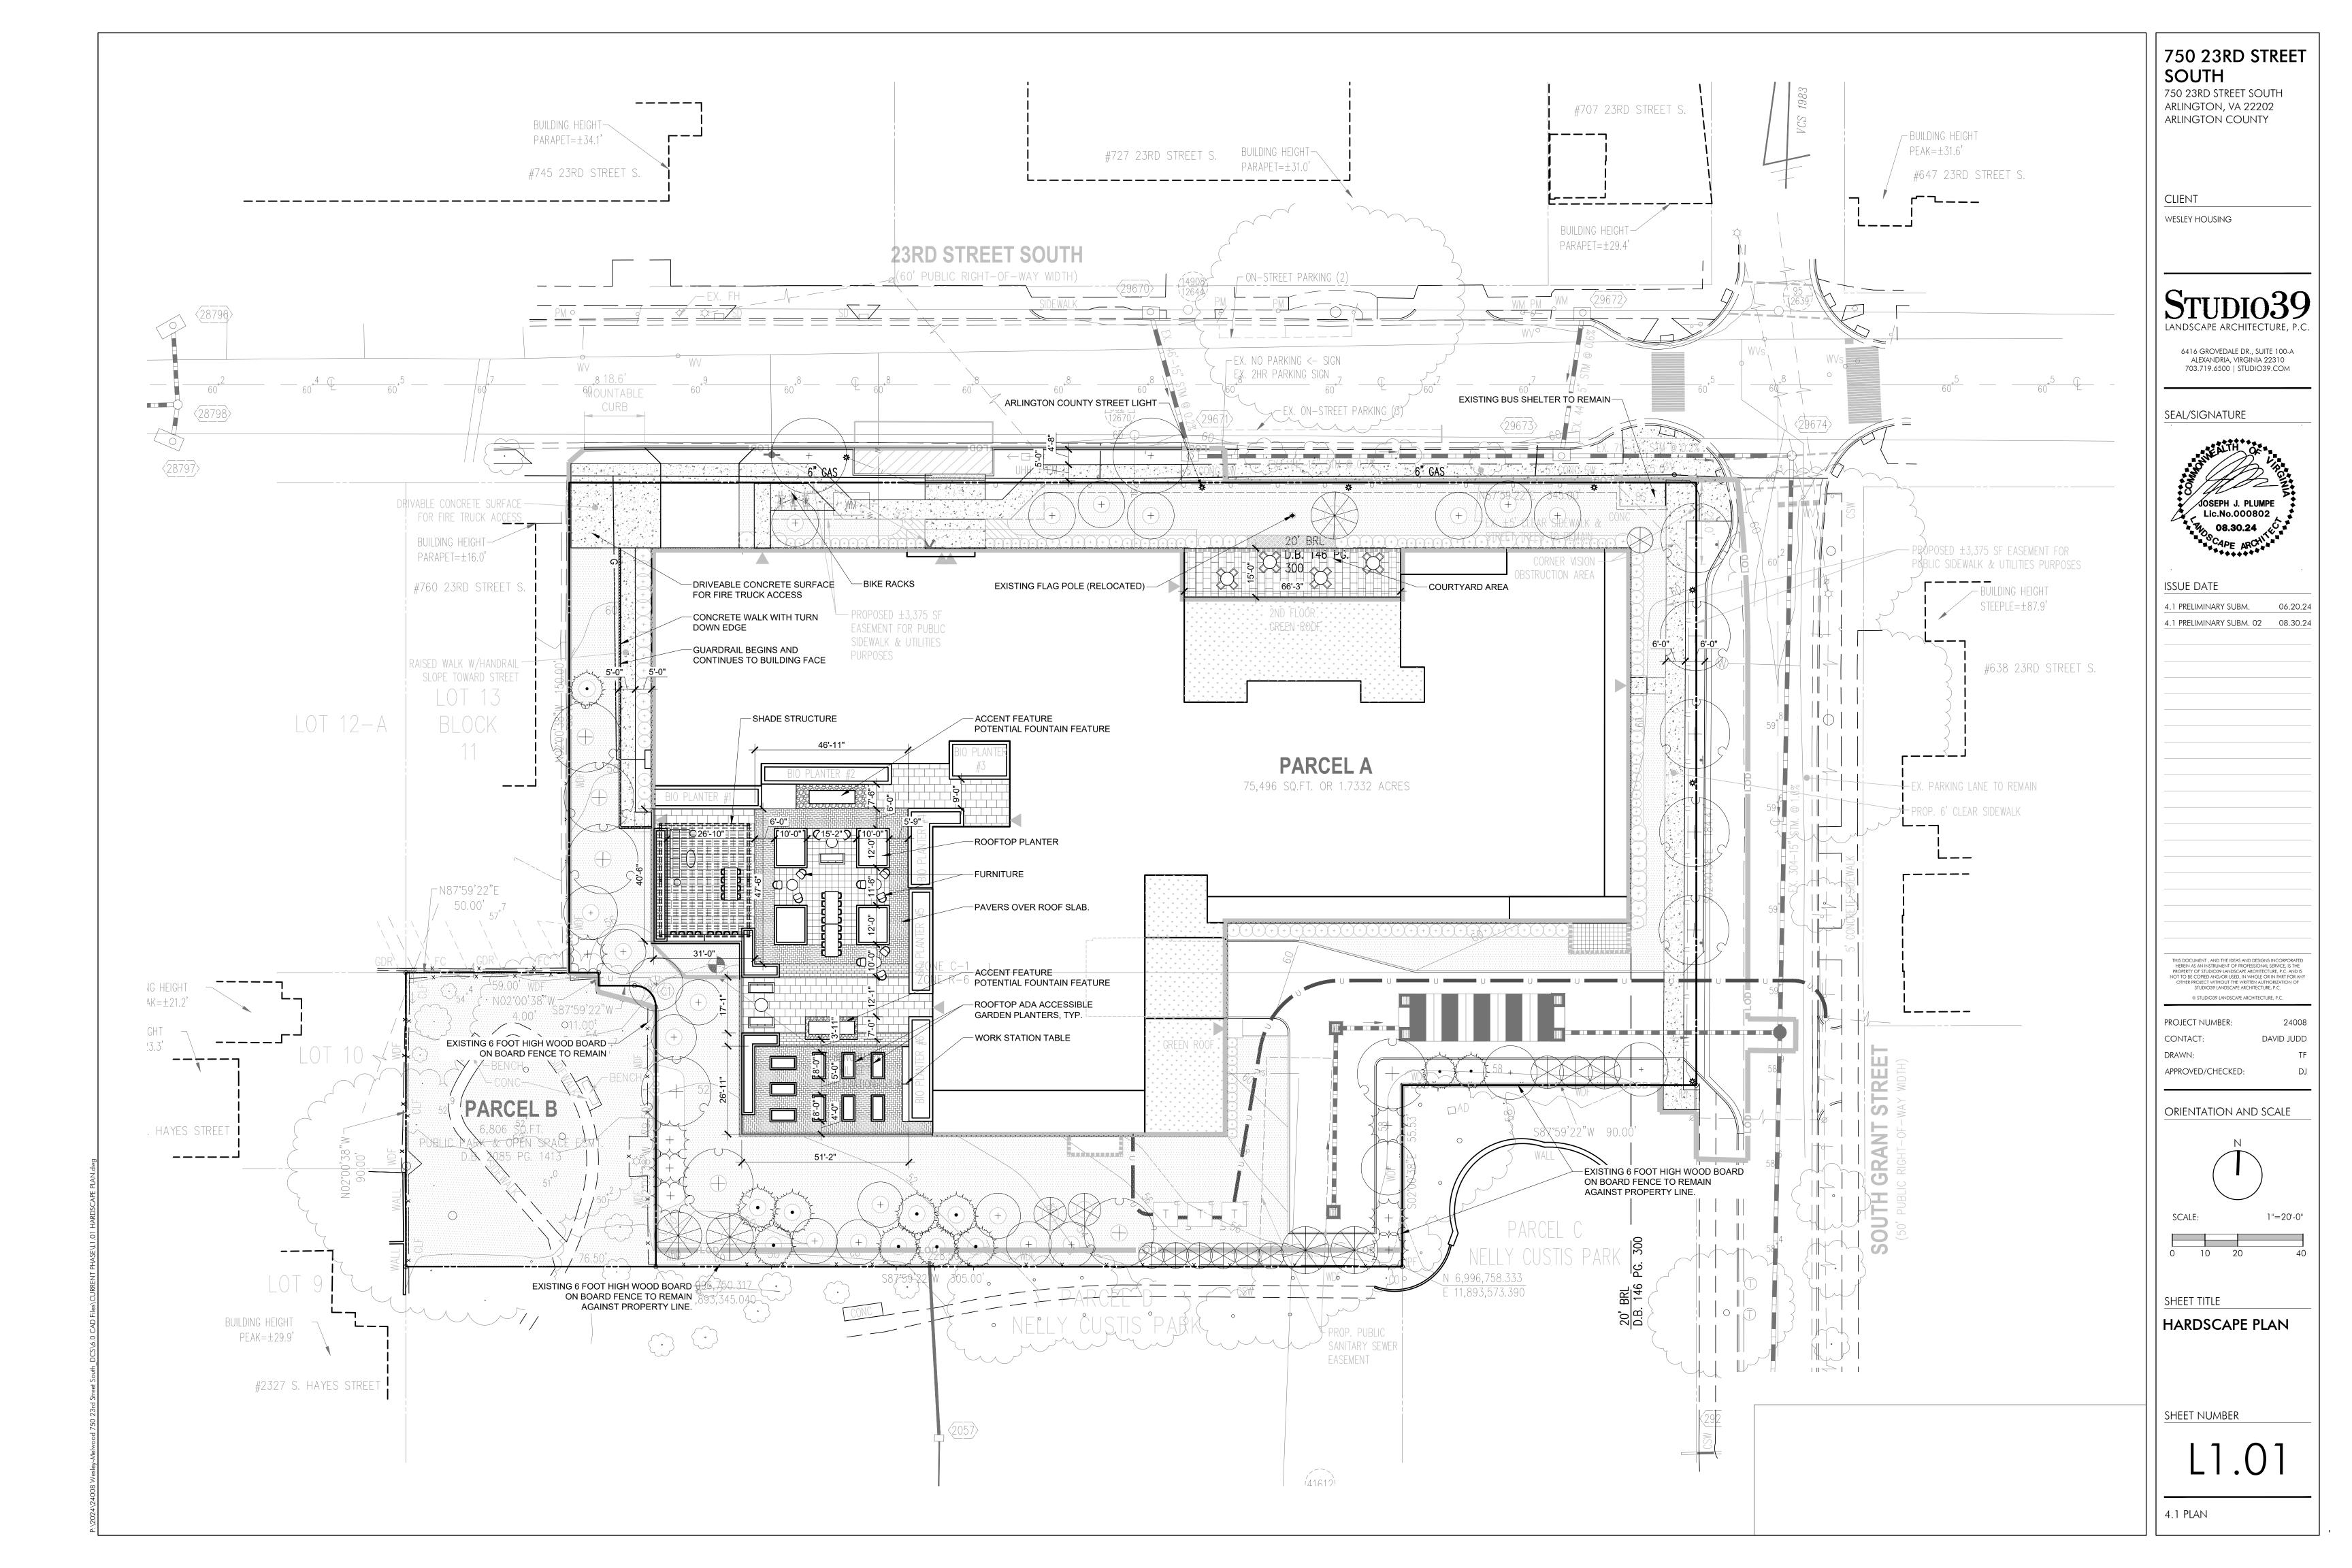



SHEET TITLE

GENERAL NOTES

SHEET NUMBER



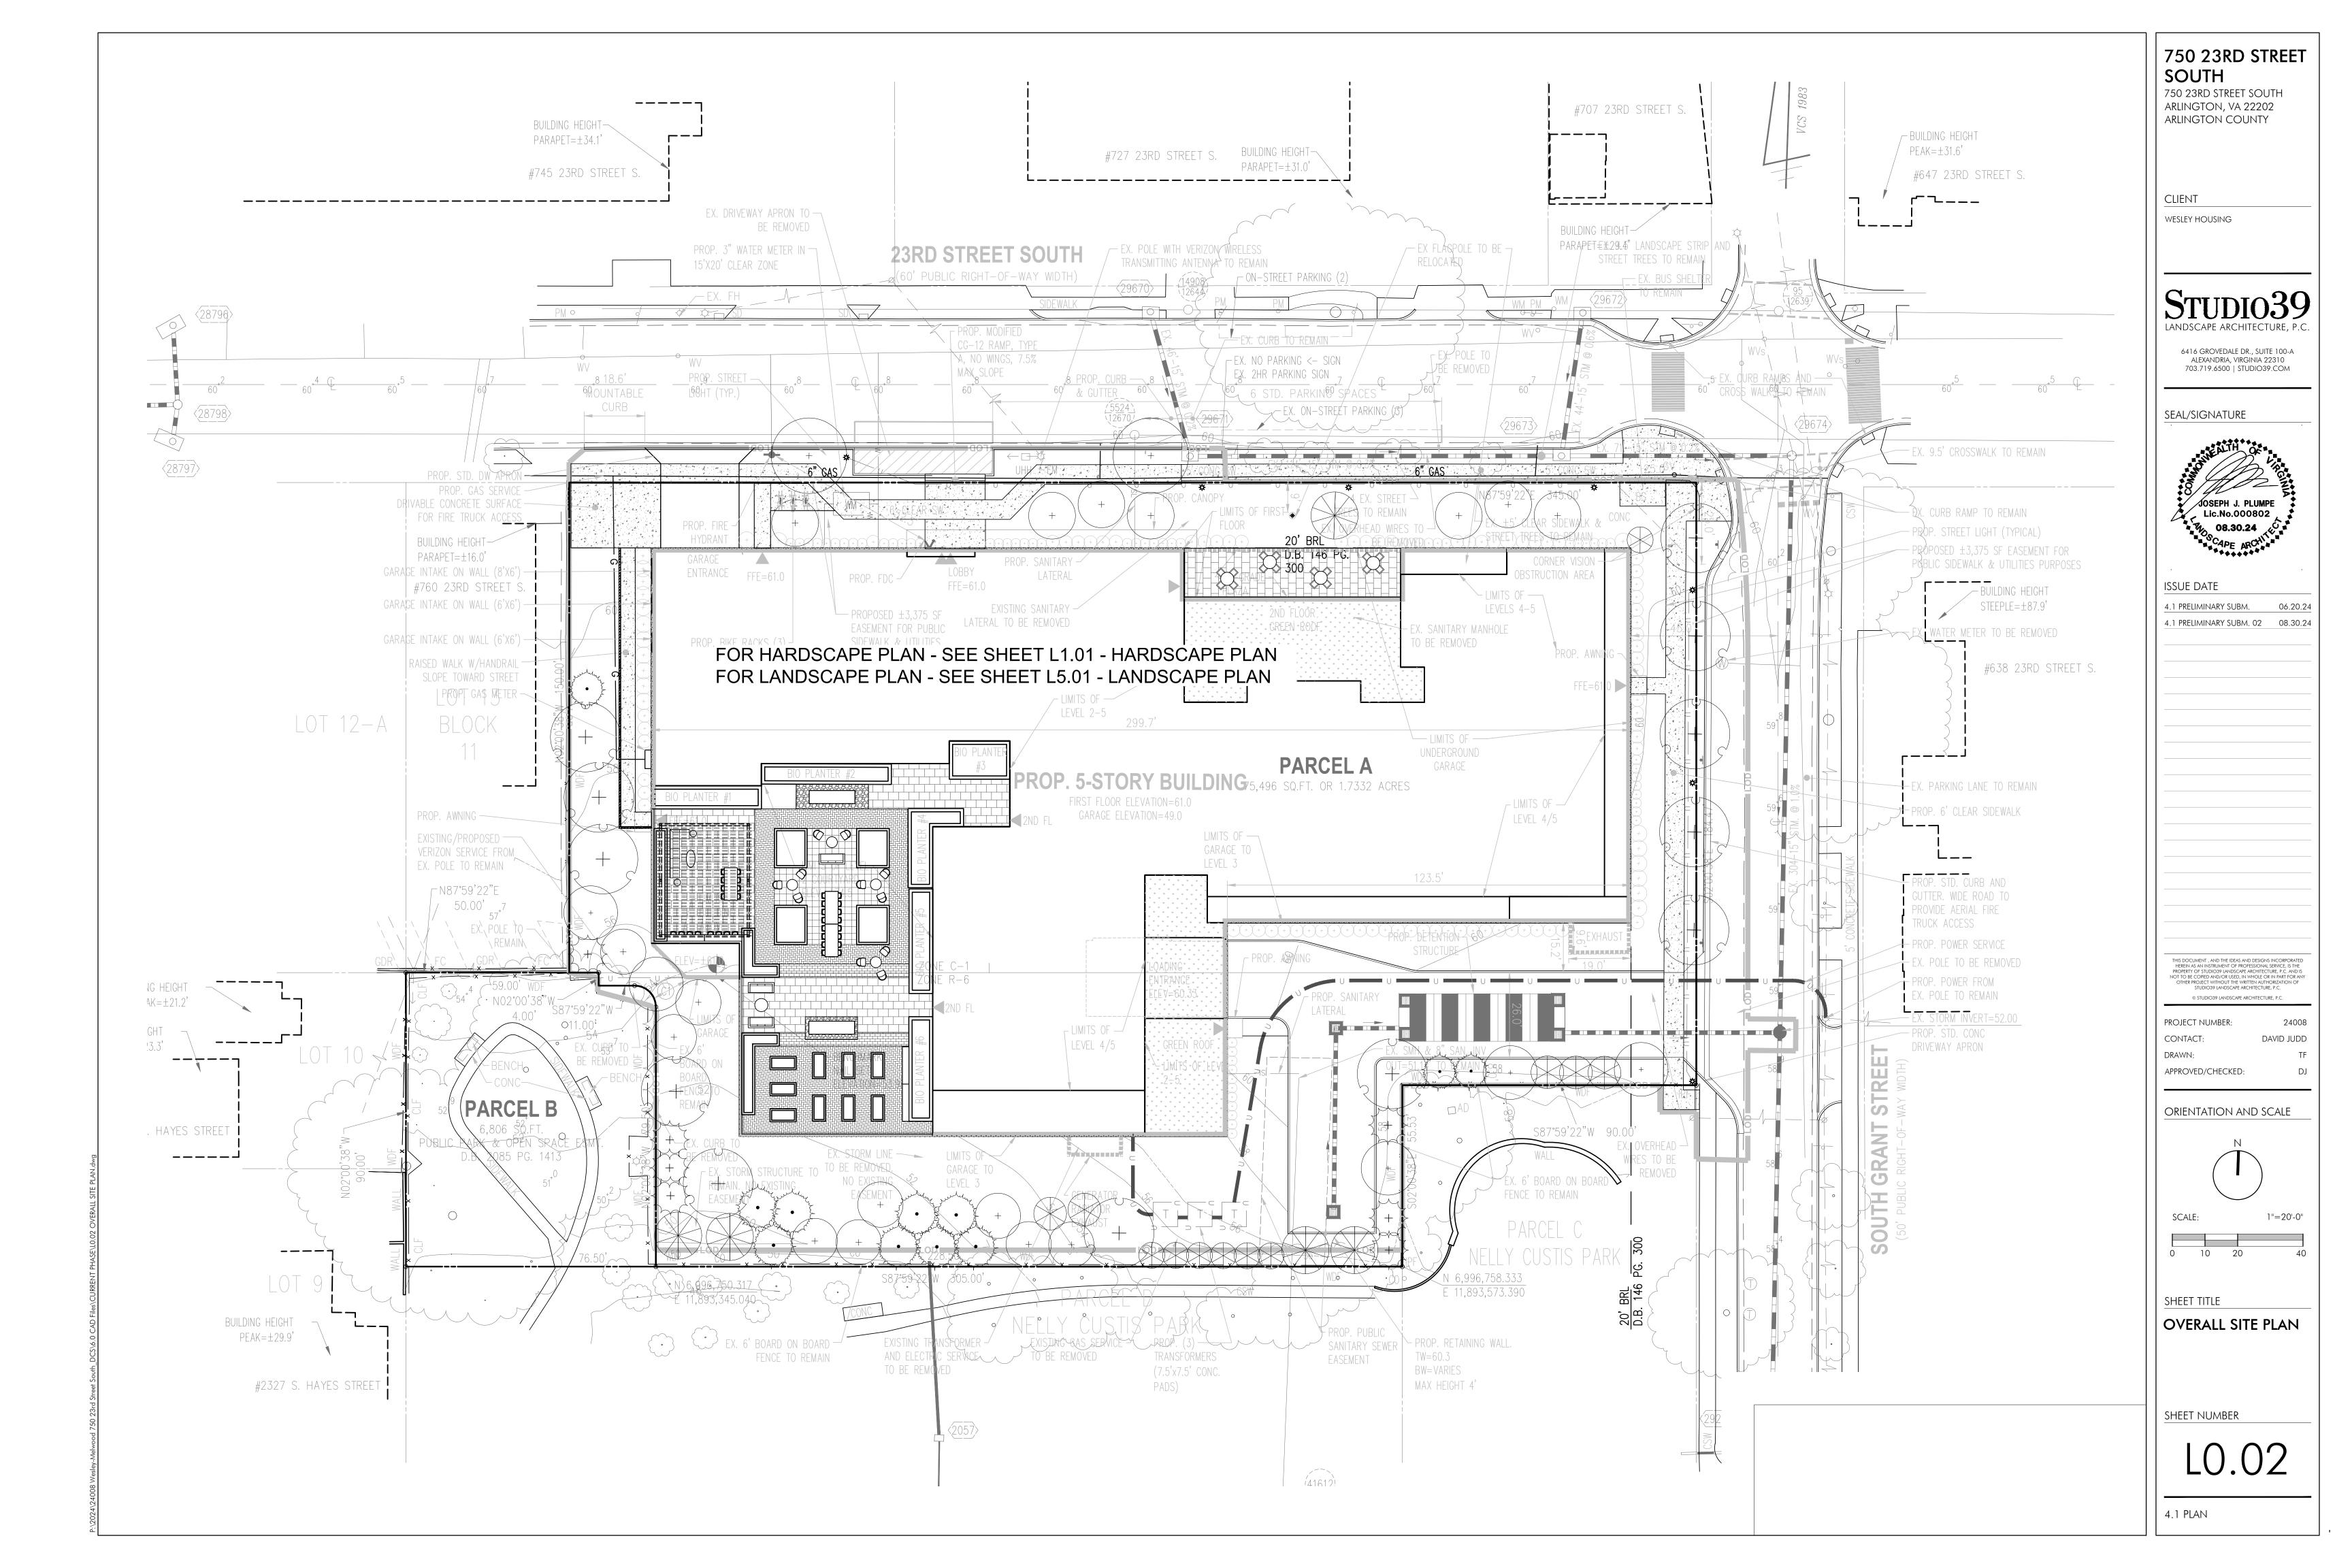

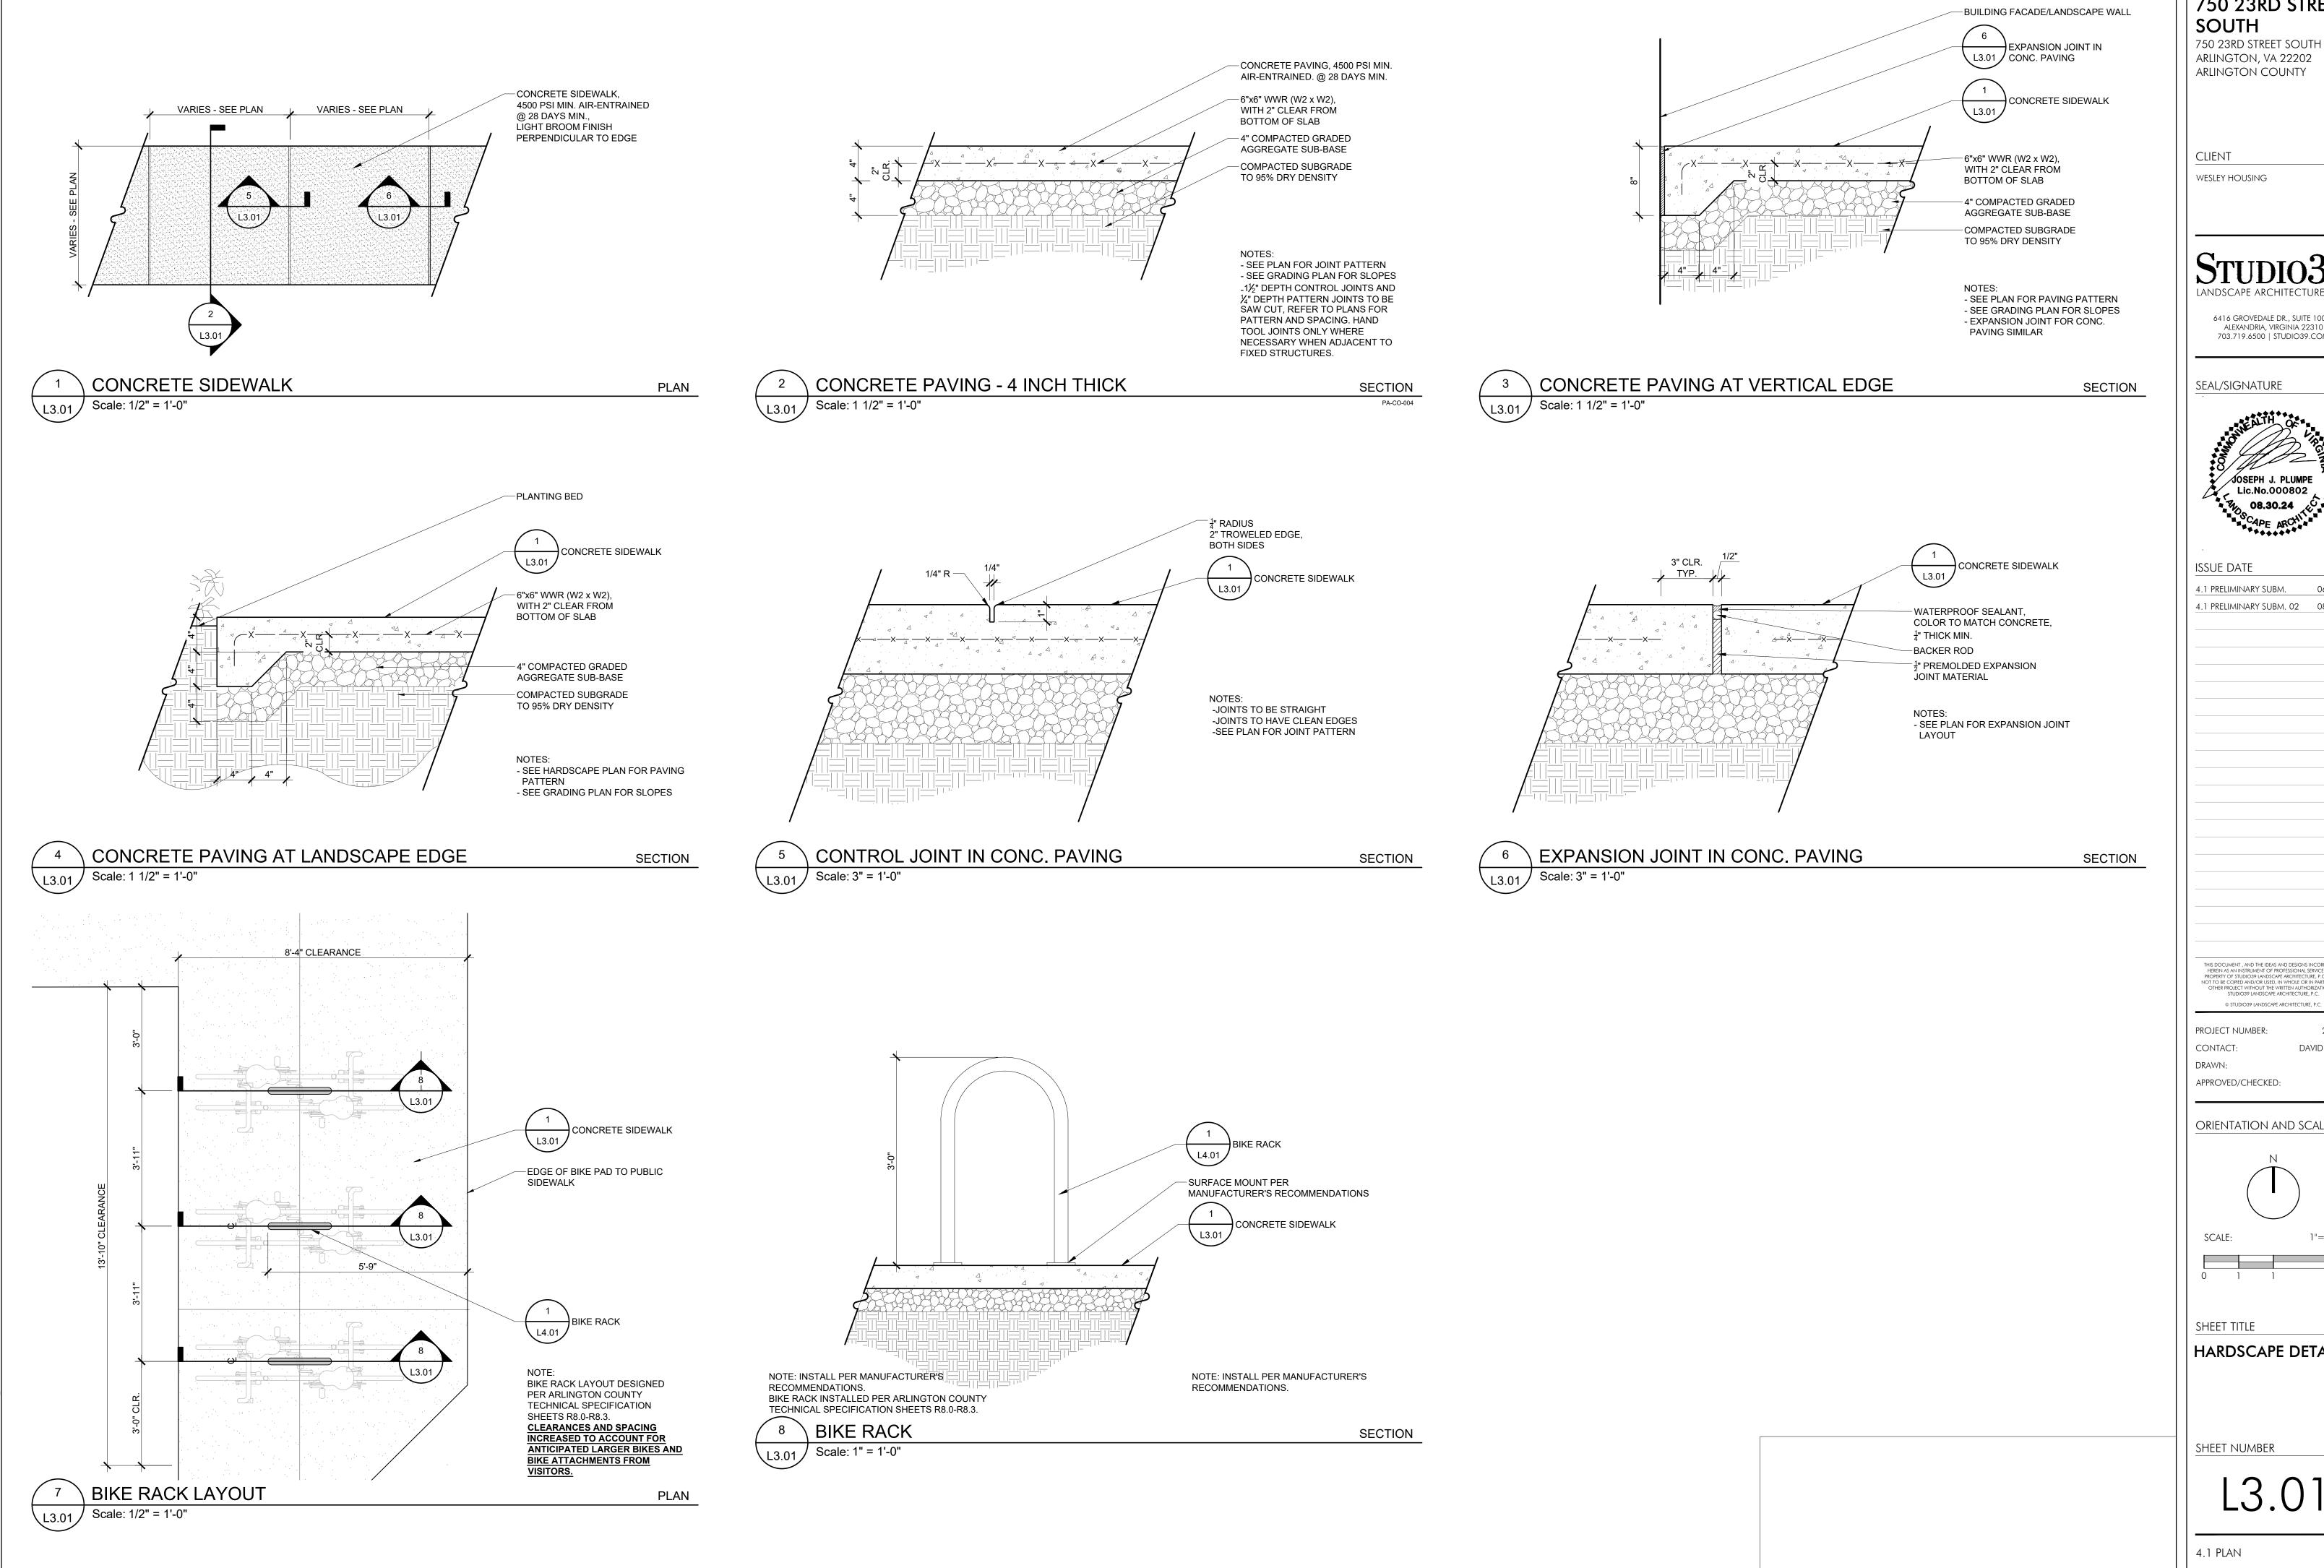

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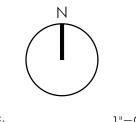
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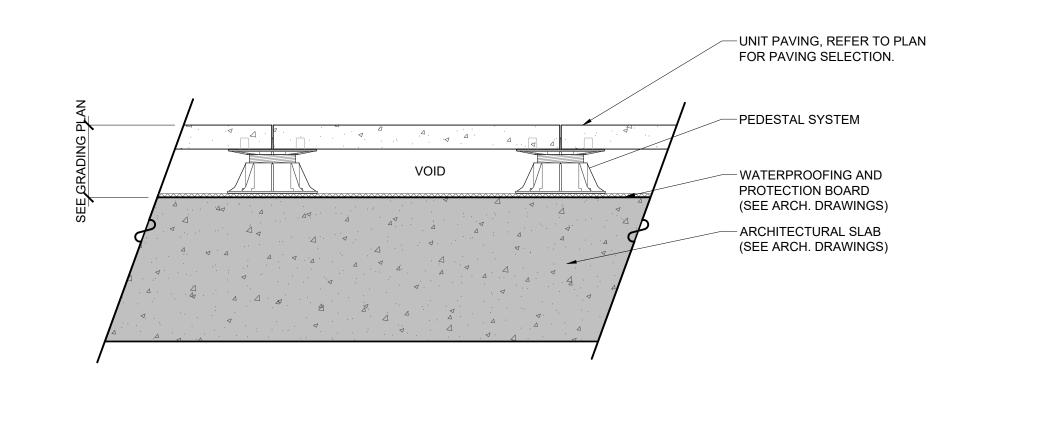
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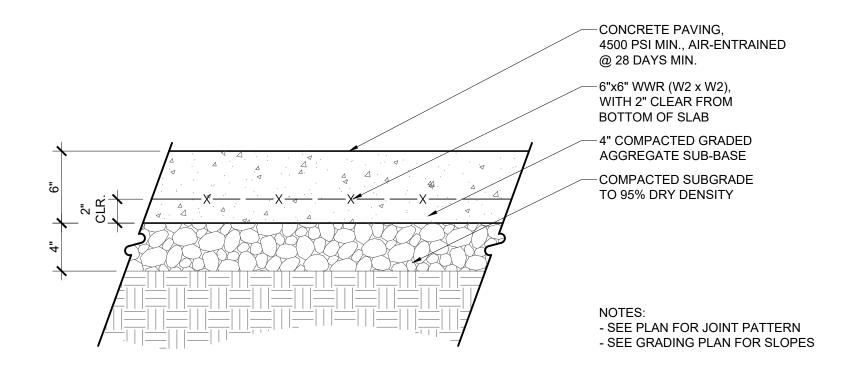


1"=0'-0"

HARDSCAPE DETAILS

SHEET NUMBER





1 PEDESTAL PAVER

3.02 Scale: 1 1/2" = 1'-0"

2 CONCRETE PAVING - VEHICULAR

Scale: 1 1/2" = 1'-0"

SECTION
PA-CO-005

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24008

DAVID JUDD


PROJECT NUMBER:

CONTACT:

DRAWN:

APPROVED/CHECKED:

ORIENTATION AND SCALE

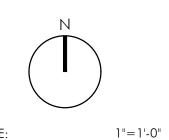

SCALE:

1/2 1

SHEET TITLE

HARDSCAPE DETAILS

SHEET NUMBER

L3.02

4.1 PLAN

iley-Melwood 750 23rd Street South_DCS\6.0 CAD Files\CURRENT PHASE\L3.02 HARDSCAPE DETAILS.dwg



MODEL: BRWS-101 - SURFACE MOUNT

DESCRIPTION: U-SHAPED BIKE RACK

COLOR: STAINLESS STEEL

QUANTITY: PER PLAN COMPANY: VICTOR STANLEY

DUNKIRK, MD 20754 www.victorstanley.com CONTACT: GEORGE BLEVINS

(P) 301.855.8300 georgeb@victorstanley.com

NOTES:

CONTRACTOR TO VERIFY QUANTITIES. INSTALL PER MANUFACTURER'S RECOMMENDATION AND GOVERNING MUNICIPAL REQUIREMENTS. OR APPROVED EQUAL



PROD. INFO.

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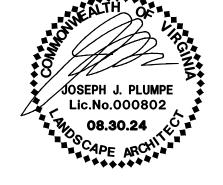
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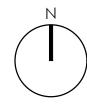
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24008

PROJECT NUMBER: CONTACT: DAVID JUDD DRAWN: APPROVED/CHECKED:

ORIENTATION AND SCALE



SHEET TITLE

PRODUCT INFORMATION

SHEET NUMBER

	EXISTING TREE IDENTIFICATION													
	DIA. AT 4.5 FEET COMMON NAME BOTANICAL NAME CONDITION INVASIVE APPROX. CANOPY RADIUS PRESERVED CANOPY BONUS													
1815.84	2x	907.92	17	Native	60	Quercus palustris	oak, pin	26	139					
56.54	2x	28.27	3	Native	75	Quercus phellos	oak, willow	3	140					
2035.74	2x	1017.87	18	Native	55	Quercus phellos	oak, willow	27	141					
1815.84	2x	907.92	17	Native	50	Quercus palustris	oak, pin	29	142					
56.54	2x	28.27	3	Native	75	Quercus phellos	oak, willow	2	143					
100.52	2x	50.26	4	Native	65	Cercis canadensis	redbud, eastern	4	169					
226	2x	113	6	Native	65	Quercus phellos	oak, willow	11	170					
100.52	2x	50.26	4	Native	40	Pinus virginiana	pine, Virginia	14	171					
6207.54			•					1						

TREE REPLACEMEN	NT TABULATION

TREE REPLACEMENT COUNT REQUIRED:	47
ONE-FOR-ONE TREE COUNT*	50
THREE-FOR-ONE TREE COUNT**	(20/3=) 6
TREE REPLACEMENT COUNT PROVIDED:	56

*ONE-FOR-ONE TREE COUNT BASED ON TREES SIZED LARGE, MEDIUM-LARGE, AND MEDIUM PER ARLINGTON COUNTY RECOMMENDED PLANT LISTS. **THREE-FOR-ONE TREE COUNT BASED ON TREES SIZED SMALL-MEDIUM AND SMALL PER ARLINGTON COUNTY RECOMMENDED PLANT LISTS.

CANOPY COVERAGE TABULATIONS

20 YEAR CANOPY COVERAGE REQUIREMENTS									
SITE AREA (PARCEL A & B):	82,302 S.F.								
MINIMUM TREE CANOPY REQUIREMENT	10%								
MINIMUM TREE CANOPY REQUIRED:	8,230 S.F.								
TREE CANOPY TARGET PER STUDY DOC.:	25% / 20,575.50 S.F.								
EXISTING TREE CANOPY TO REMAIN:	6,207.52 S.F. (7.5%)								
MINIMUM TREE CANOPY PROVIDED:	14,493.75 S.F. (17.6%)								
-									

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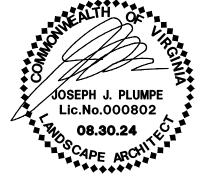
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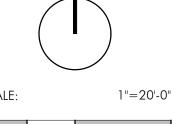
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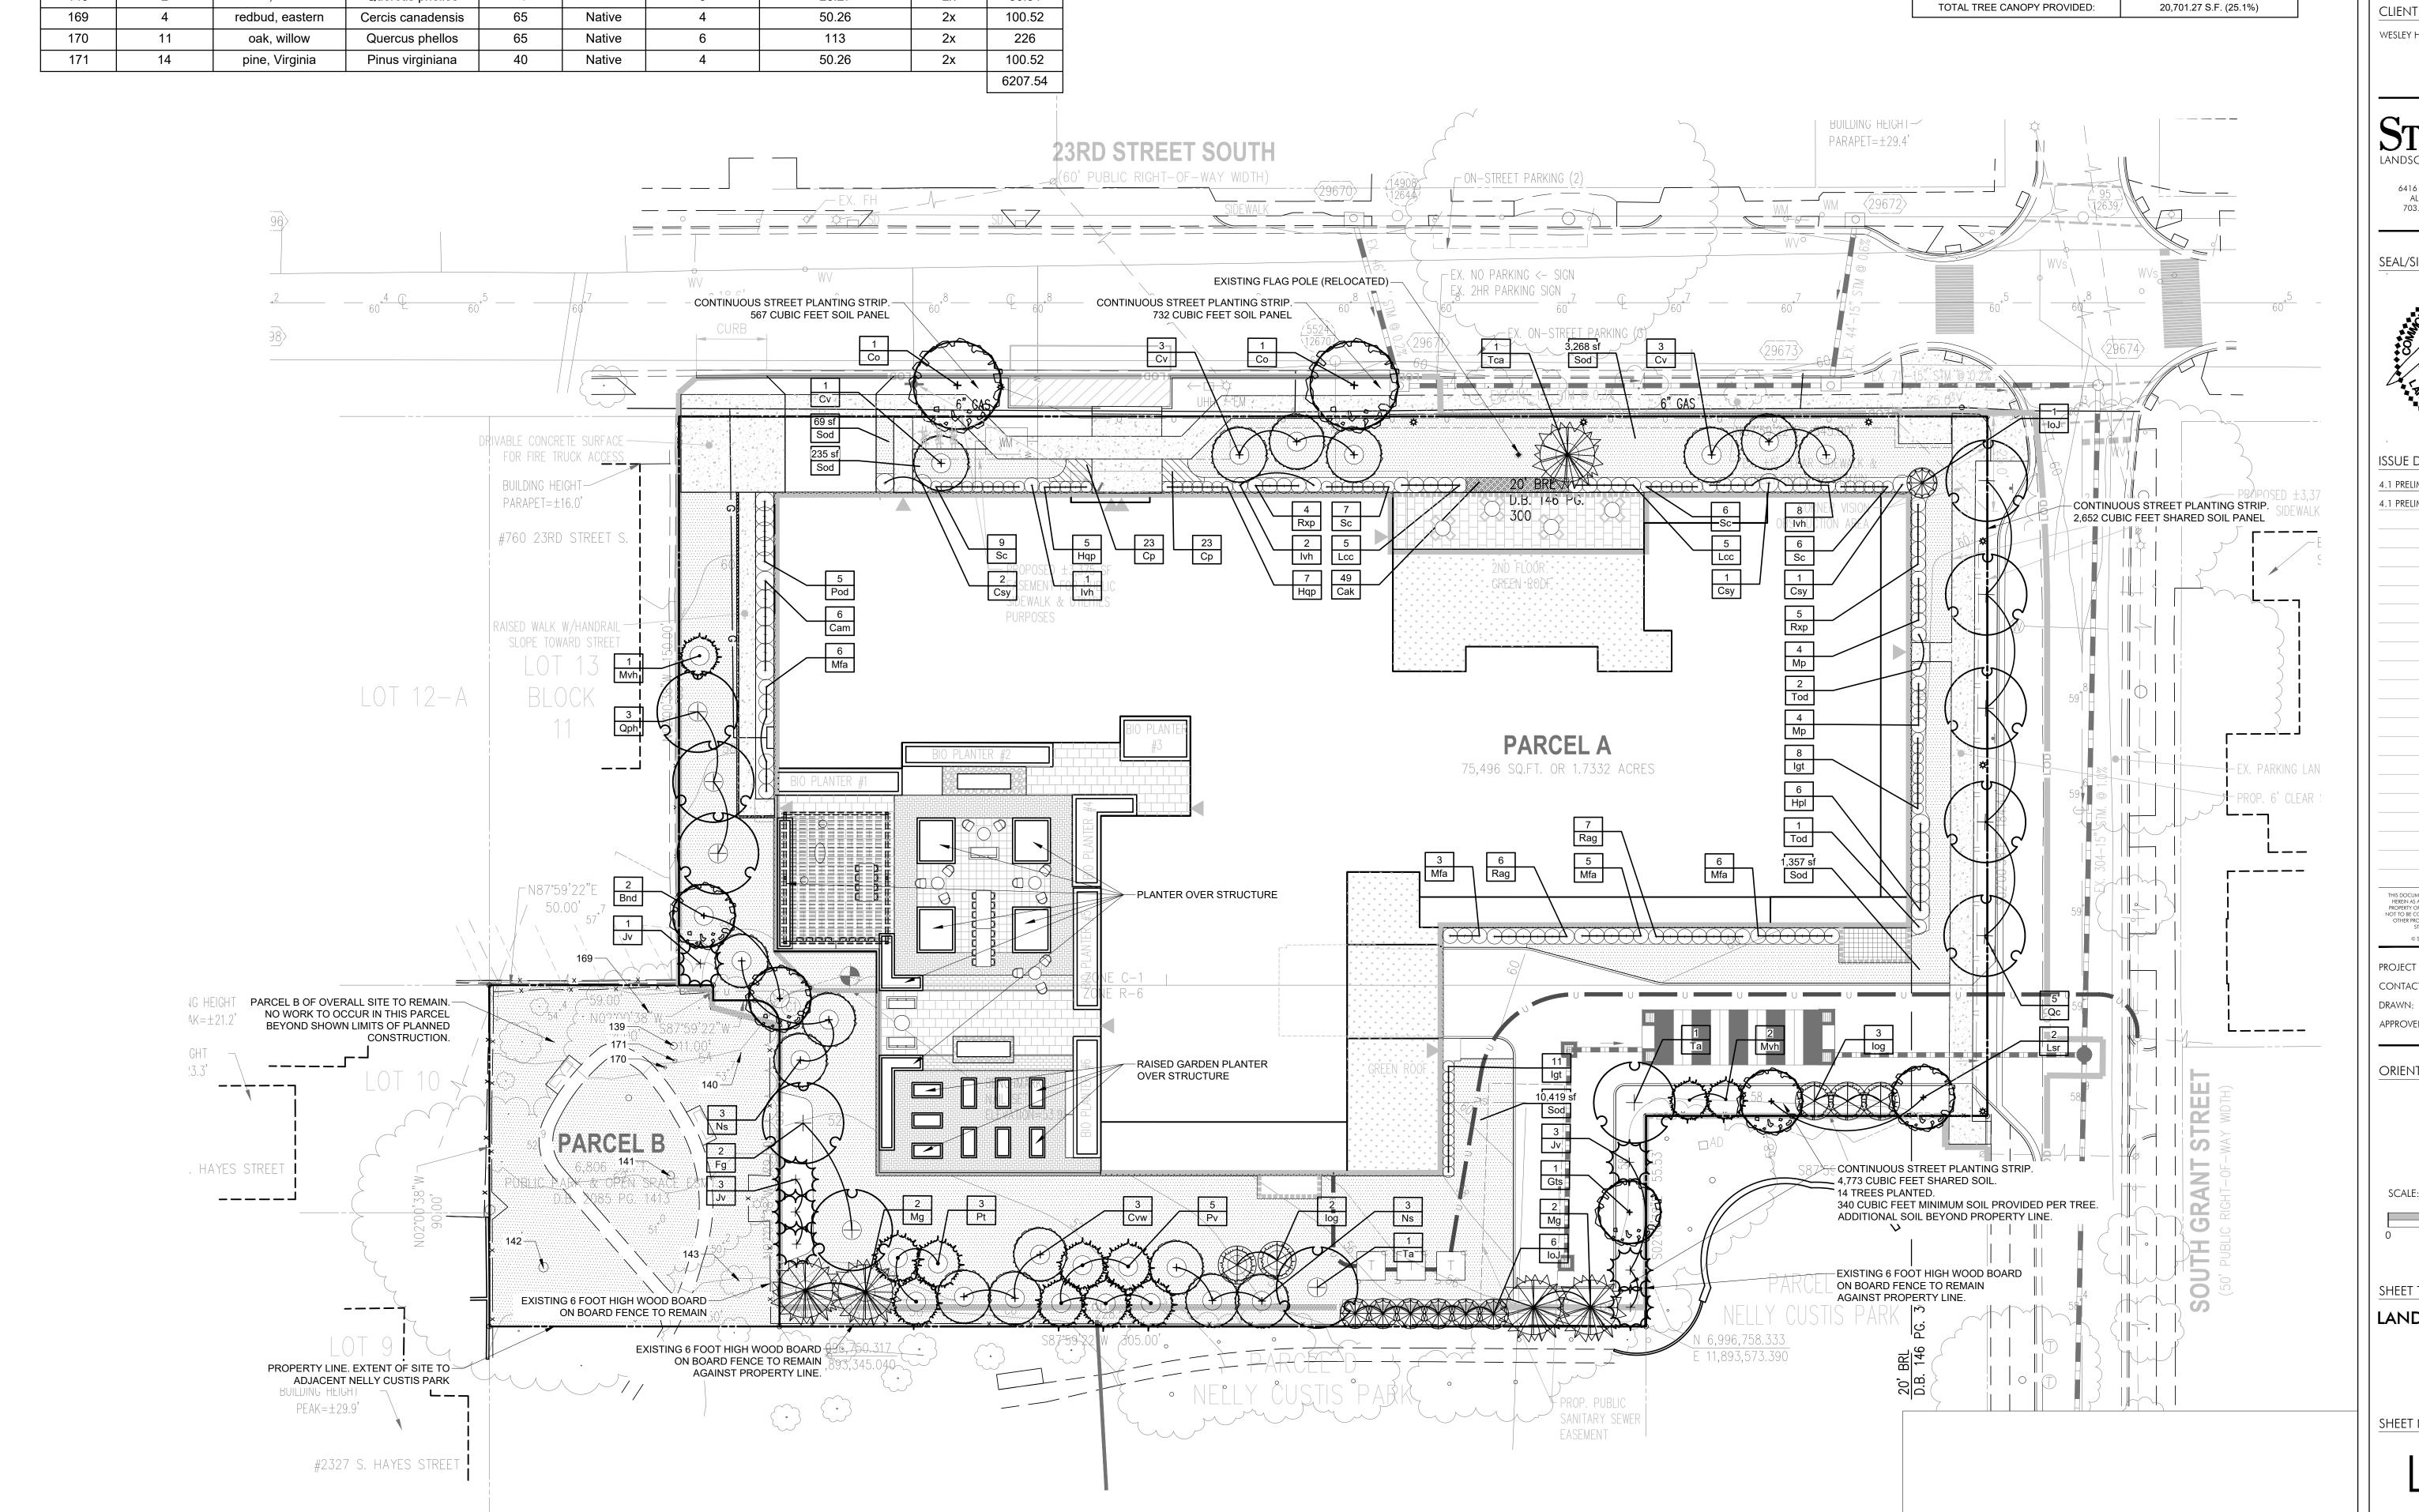


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SHEET TITLE

LANDSCAPE PLAN

SHEET NUMBER



DI AA	IT SCUE									
PLAN	IT SCHE									
CODE	QTY	BOTANICAL NAME	COMMON NAME	HEIGHT	CALIPER	SPREAD	REMARKS	CREDIT QTY	CANOPY CREDIT (SF)	CANOPY CREDIT TOTAL
EVERGE	REEN TREE	S								
loJ	7	llex opaca 'Jersey Knight'	Jersey Knight American Holly	6`-8`		3 1/2 - 5`	B&B, full to ground with good seasonal flush	7	218.75	1,531.25
log	5	Ilex opaca `Greenleaf`	Greenleaf Holly	6`-8`		3 1/2 - 5`	B&B, full to ground with good seasonal flush	5	218.75	1,093.75
Jv	7	Juniperus virginiana	Eastern Red Cedar	6`-8`		3 1/2 - 5`	B&B, full to ground with good seasonal flush	7	137.50	962.50
Mg	4	Magnolia grandiflora	Southern Magnolia	6`-8`		3 1/2 - 5`	B&B, full to ground with good seasonal flush	4	393.75	1,575.00
Mvh	3	Magnolia virginiana 'Henry Hicks'	Henry Hicks Sweetbay Magnolia	8`-10`	2" min.		B&B, single trunk, full symmetrical branching	3	137.50	412.50
Pt	3	Pinus taeda	Loblolly Pine	6`-8`		3 1/2 - 5`	B&B, full to ground with good seasonal flush	3	218.75	656.25
Pv	5	Pinus virginiana	Virginia Pine	6`-8`		3 1/2 - 5`	B&B, full to ground with good seasonal flush	5	218.75	1,093.75
Tca	1	Tsuga canadensis	Canadian Hemlock	12' MIN		6-8`	B&B, full to ground with good seasonal flush	1	218.75	218.75
ORNAMI	ENTAL TRE	FS						35	TOTAL	7,543.75
Cv	7	Chionanthus virginicus	White Fringetree	8`-10`	2 1/2" min.		B&B, uniform branching, full specimen	7	137.50	962.50
Cvw	3	Crataegus viridis `Winter King`	`Winter King` Hawthorn	8`-10`	2 1/2" min.		B&B, uniform branching, full specimen	3	137.50	412.50
Ns	6	Nyssa sylvatica	Sour Gum	14`-16`	3" - 3 1/2"		B&B, full uniform crown, symmetrical	6	312.50	1,875.00
		, ,	Jour Juni	1	0 0 1/2		branching, full specimen			
SHADE	TREES							16	TOTAL	3,250.00
Bnd	2	Betula nigra `Duraheat`	Duraheat River Birch	10`-12`	2" min.		B&B, multi-trunk, 3 cane minimum, full symmetrical branching	2	218.75	437.50
Со	2	Celtis occidentalis	Common Hackberry	14`-16`	3" - 3 1/2"		B&B, full uniform crown, symmetrical	0*	393.75	0
			,				branching, full specimen B&B, full uniform crown, symmetrical			
Fg	2	Fagus grandifolia	American Beech	14`-16`	3" - 3 1/2"		branching, full specimen B&B, full uniform crown, symmetrical	2	393.75	787.50
Gts	1	Gleditsia triacanthos inermis `Shademaster`	Shademaster Locust	14`-16`	3" - 3 1/2"		branching, full specimen	1	312.50	312.50
Lsr	2	Liquidambar styraciflua `Rotundiloba`	Round-Lobed Sweet Gum	14`-16`	3" - 3 1/2"		B&B, full uniform crown, symmetrical branching, full specimen	2	218.75	437.50
Qc	5	Quercus coccinea	Scarlet Oak	14`-16`	3" - 3 1/2"		B&B, full uniform crown, symmetrical branching, full specimen	0*	393.75	0
Qph	3	Quercus phellos 'Hightower'	Willow Oak	14`-16`	3" - 3 1/2"		B&B, full uniform crown, symmetrical branching, full specimen	3	312.50	937.50
Та	2	Tilia americana	American Linden	14`-16`	3" - 3 1/2"		B&B, full uniform crown, symmetrical	2	393.75	787.50
							branching, full specimen	12	 TOTAL	3,700.00
CODE	QTY	BOTANICAL NAME	COMMON NAME	HEIGHT	SPREAD	SIZE	REMARKS	12 TOTAL TREE C	OVERAGE PROVIDED BY	· ·
DECIDU	OUS SHRUI	BS							PLANTING PLANTING	14,493.75
Cam	6	Callicarpa americana	American Beautyberry	24"-30"	24"-30"	#5 cont.	healthy vigorous, well-rooted & established in container		*Ql	JANTITY NOT INCLUDED AS IN R.O.W.
Hpl	6	Hydrangea paniculata `Limelight`	Limelight Panicle Hydrangea	24" min.	24" min.	#3 cont.	healthy, vigorous, well-rooted & established in container			
Нզр	12	Hydrangea quercifolia `Pee Wee`	Oakleaf Hydrangea	18"-24"	18"-24"	#3 cont.	healthy, vigorous, well-rooted & established in container			
lvh	11	Itea virginica `Henry`s Garnet`	Henry's Garnet Sweetspire	18"-24"	18"-24"	#3 cont.	healthy vigorous, well-rooted & established in container			
Pod	5	Physocarpus opulifolius `Diablo`	Diablo Ninebark	24"-36"	18"-24"	#3 cont.	healthy vigorous, well-rooted & established in container			
Rag	13	Rhus aromatica `Gro-Low`	Gro-Low Fragrant Sumac	12"-15"	15"-18"	#3 cont.	4` o.c., full specimen, healthy, vigorous, well-rooted and established	_		
EVEDGE	REEN SHRU	IDC		1	1					
Csy	4	Camellia sasanqua `Yuletide`	Yuletide Camellia	24"-30"	24"-30"	#5 cont.	healthy, vigorous, well-rooted & established in	†		
lgt	19	Ilex glabra `Strongbox`	Strongbox Inkberry	18"-24"	18"-24"	#3 cont.	container healthy, vigorous, well-rooted & established in	-		
			·				container	1		
Lcc	10	Loropetalum chinense rubrum `Crimson Fire`	Purple Leaf Fringe Flower	24"-36"	24"-36"	#5 cont.	healthy, vigorous, well-rooted & established	+		
Mfa Mp	20	Morella cerifera `Fairfax` Myrica pensylvanica	Fairfax Wax Myrtle Northern Bayberry	30"-36" 30"-36"	30"-36" 30"-36"	#7 cont. #7 cont.	healthy vigorous, well-rooted & established healthy vigorous, well-rooted & established	+		
Rxp	0	Rhododendron x `P.J.M.`	P.J.M. Rhododendron	24"-30"	18"-24"		healthy, vigorous, well-rooted & established in	-		
	20					#3 cont.	container healthy, vigorous, well-rooted & established in	-		
Sc	28	Sarcococca confusa	Sweetbox Degreet's Spire Arbervites	18"-24"	18"-24"	#3 cont.	container	_		
Tod	3	Thuja occidentalis `Degroot's Spire`	Degroot's Spire Arborvitae	3`-5`		3 1/2 - 5`	B&B, full to ground with good seasonal flush	-		
CODE	QTY	BOTANICAL NAME	COMMON NAME	CONT.	COLOR	SPACING	REMARKS	_		
SOD	45 040 -f	Turout	Drought Tolorent Facers Direct	De"			I Described to the second seco	1		
Sod	15,348 sf	Turf Sod	Drought Tolerant Fescue Blend	Roll			Durablend tall fescue blend or similar	+		
PERENN	NIALS, ORN	AMENTAL GRASSES AND FERNS								
Cak	49	Calamagrostis x acutiflora `Karl Foerster`	Feather Reed Grass	#1 cont. @		18" o.c.	full specimen, healthy, vigorous, well-rooted and established			
Ср	46	Carex pensylvanica	Pennsylvania Sedge	#1 cont. @		18" o.c.	full specimen, healthy, vigorous, well-rooted and established			
	•	•		•	•		•	_		

STORM WATER MANAGEMENT PLANT POOL

\mathbf{Z}	<u> </u>	<u> </u>	NAGEMEN	<u> </u>	SHKL	185	
KEY	GENUS	SPECIES	VARIETY	COMMON NAME	SIZE	COLOR	REMARKS
CAA	Callicarpa	americana		American beautyberry	30 - 36"	18 - 24"	#3 cont., healthy vigorous, well-rooted & established in container
САН	Clethra	alnifolia	'Hummingbird'	Hummingbird Clethra	18 - 24"	18 - 24"	#3 cont., healthy, vigorous, well-rooted & established
cos	Cornus	sericea		Red Twig Dogwood	24 - 36"	24 - 36"	#5 cont., healthy, vigorous, well-rooted & established
НДД	Hydrangea	arborescens	'Anabelle'	Anabelle Hydrangea	18 - 24"	18 - 24"	#3 cont., healthy, vigorous, well-rooted & established in container
ILG	llex	glabra		Inkberry	24 - 30"	18 - 24"	#3 cont., healthy, vigorous, well-rooted & established in container
I√J	llex	verticillata	'Jim Dandy'	Jim Dandy Winterberry	18 - 24"	18 - 24"	#3 cont., healthy vigorous, well-rooted & established in container
IVR	llex	verticillata	'Red Sprite'	Red Sprite Winterberry	18 - 24"	18 - 24"	#3 cont., healthy vigorous, well-rooted & established in container
I∨H	Itea	virginica	'Henry's Garnet'	Henry's Garnet Sweetspire	18 - 24"	18 - 24"	#3 cont., healthy vigorous, well-rooted & established in container
MYP	Myrica	penslyvanica		Northern Bayberry	30 - 36"	30 - 36"	#7 cont., healthy vigorous, well-rooted & established
VIΑ	Viburnum	acerifolium		Mapleleaf Viburnum	24 - 36"	18 - 24"	B&B, healthy, vigorous, well-rooted & established
VID	Viburnum	dentatum		Arrowwood Viburnum	24 - 36"	18 -24"	B&B, healthy, vigorous, well-rooted & established
	KEY CAA CAH COS HAA ILG IVJ IVR IVH MYP VIA	KEY GENUS CAA Callicarpa CAH Clethra COS Cornus HAA Hydrangea ILG Ilex IVJ Ilex IVR Ilex IVH Itea MYP Myrica VIA Viburnum	KEY GENUS SPECIES CAA Callicarpa americana CAH Clethra alnifolia COS Cornus sericea HAA Hydrangea arborescens ILG Ilex glabra IVJ Ilex verticillata IVR Ilex verticillata IVH Itea virginica MYP Myrica penslyvanica VIA Viburnum acerifolium	KEY GENUS SPECIES VARIETY CAA Callicarpa americana CAH Clethra alnifolia 'Hummingbird' COS Cornus sericea HAA Hydrangea arborescens 'Anabelle' ILG Ilex glabra IVJ Ilex verticillata 'Jim Dandy' IVR Ilex verticillata 'Red Sprite' IVH Itea virginica 'Henry's Garnet' MYP Myrica penslyvanica VIA Viburnum acerifolium	KEY GENUS SPECIES VARIETY COMMON NAME CAA Callicarpa americana American beautyberry CAH Clethra ainifolia 'Hummingbird' Hummingbird Clethra COS Cornus sericea Red Twig Dogwood HAA Hydrangea arborescens 'Anabelle' Anabelle Hydrangea ILG Ilex glabra Inkberry IVJ Ilex verticillata 'Jim Dandy' Jim Dandy Winterberry IVR Ilex verticillata 'Red Sprite' Red Sprite Winterberry IVH Itea virginica 'Henry's Garnet' Henry's Garnet Sweetspire MYP Myrica penslyvanica Northern Bayberry VIA Viburnum acerifolium Mapleleaf Viburnum	KEY GENUSSPECIESVARIETYCOMMON NAMESIZECAA CallicarpaamericanaAmerican beautyberry30 - 36"CAH Clethraalnifolia'Hummingbird'Hummingbird Clethra18 - 24"COS CornussericeaRed Twig Dogwood24 - 36"HAA Hydrangeaarborescens'Anabelle'Anabelle Hydrangea18 - 24"ILG IlexglabraInkberry24 - 30"IVJ Ilexverticillata'Jim Dandy'Jim Dandy Winterberry18 - 24"IVR Ilexverticillata'Red Sprite'Red Sprite Winterberry18 - 24"IVH Iteavirginica'Henry's Garnet'Henry's Garnet Sweetspire18 - 24"MYP MyricapenslyvanicaNorthern Bayberry30 - 36"VIA ViburnumacerifoliumMapleleaf Viburnum24 - 36"	KEY GENUS SPECIES VARIETY COMMON NAME SIZE COLOR CAA Callicarpa americana American beautyberry 30 - 36" 18 - 24" CAH Clethra alnifolia 'Hummingbird' Hummingbird Clethra 18 - 24" 18 - 24" COS Cornus sericea Red Twig Dogwood 24 - 36" 24 - 36" HAA Hydrangea arborescens 'Anabelle Hydrangea 18 - 24" 18 - 24" ILG Ilex glabra Inkberry 24 - 30" 18 - 24" IVJ Ilex verticillata 'Jim Dandy Winterberry 18 - 24" 18 - 24" IVR Ilex verticillata 'Red Sprite' Red Sprite Winterberry 18 - 24" 18 - 24" IVH Itea virginica 'Henry's Garnet Sweetspire 18 - 24" 18 - 24" MYP Myrica pensiyvanica Northern Bayberry 30 - 36" 30 - 36" VIA Viburnum acerifolium Mapleleaf Viburnum 24 - 36" 18 - 24"

STO	RI	T WATE	ER MA	NAGEMEN	T PLANTS -	PER	ENNIAL	S/GROUNDCOVERS
QTY	KEY	GENUS	SPECIES	VARIETY	COMMON NAME	SIZE	COLOR	REMARKS
QTY	Δt	Asclepias	tuberosa		Butterfly Milkweed	#1 cont.	Orange	24" o.c., full specimen, healthy, vigorous, well-rooted and established
QTY	CST	Carex	stricta		Tussock Sedge	#1 cont.		18" o.c., full specimen, healthy, vigorous, well-rooted and established
QTY	CHL	Chasmanthium	latifolium		Northern Sea Oats	#1 cont.		18" o.c., full specimen, healthy, vigorous, well-rooted and established
QTY	CGL	Chelone	glabra		White Turtle-head	#1 cont.	White	24" o.c., full specimen, healthy, vigorous, well-rooted and established
QTY	CSM	Coreopsis	verticillata	'Moonbeam'	Moonbeam Coreopsis	#1 cont.	Pale yellow	18" o.c., full specimen, healthy, vigorous, well-rooted and established
QTY	IRY	iris	versicolor		Blue Flag Iris	#1 cont.		18" o.c., full specimen, healthy, vigorous, well-rooted and established
QTY	JUF	Juncus	effusus		Soft rush	#1 cont.		24" o.c., full specimen, healthy, vigorous, well-rooted and established
QTY	LOC	Lobelia	cardinalis		Cardinal Flower	#1 cont.	Red	12" o.c., full specimen, healthy, vigorous, well-rooted and established
QTY	PVH	Panicum	virgatum	'Heavy Metai'	Heavy Metal Switch Grass	#3 cont.		24" o.c., full specimen, healthy, vigorous, well-rooted and established
QTY	PVS	Panicum	virgatum	'Shenandoah'	Shenandoah Switch Grass	#3 cont.		24" o.c., full specimen, healthy, vigorous, well-rooted and established

| 750 23RD STREET SOUTH

750 23RD STREET SOUTH ARLINGTON, VA 22202 ARLINGTON COUNTY


CLIENT

WESLEY HOUSING

LANDSCAPE ARCHITECTURE, P.C.

6416 GROVEDALE DR., SUITE 100-A ALEXANDRIA, VIRGINIA 22310 703.719.6500 | STUDIO39.COM

SEAL/SIGNATURE

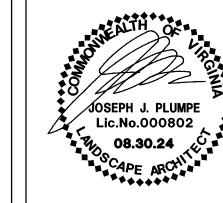

ISSUE DATE


4.1 PRELIMINARY SUBM. 06.20.24 4.1 PRELIMINARY SUBM. 02 08.30.24

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PROJECT NUMBER: CONTACT: DAVID JUDD DRAWN:

ORIENTATION AND SCALE


APPROVED/CHECKED:

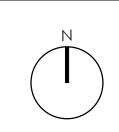

SHEET TITLE

PLANT SCHEDULE

SHEET NUMBER

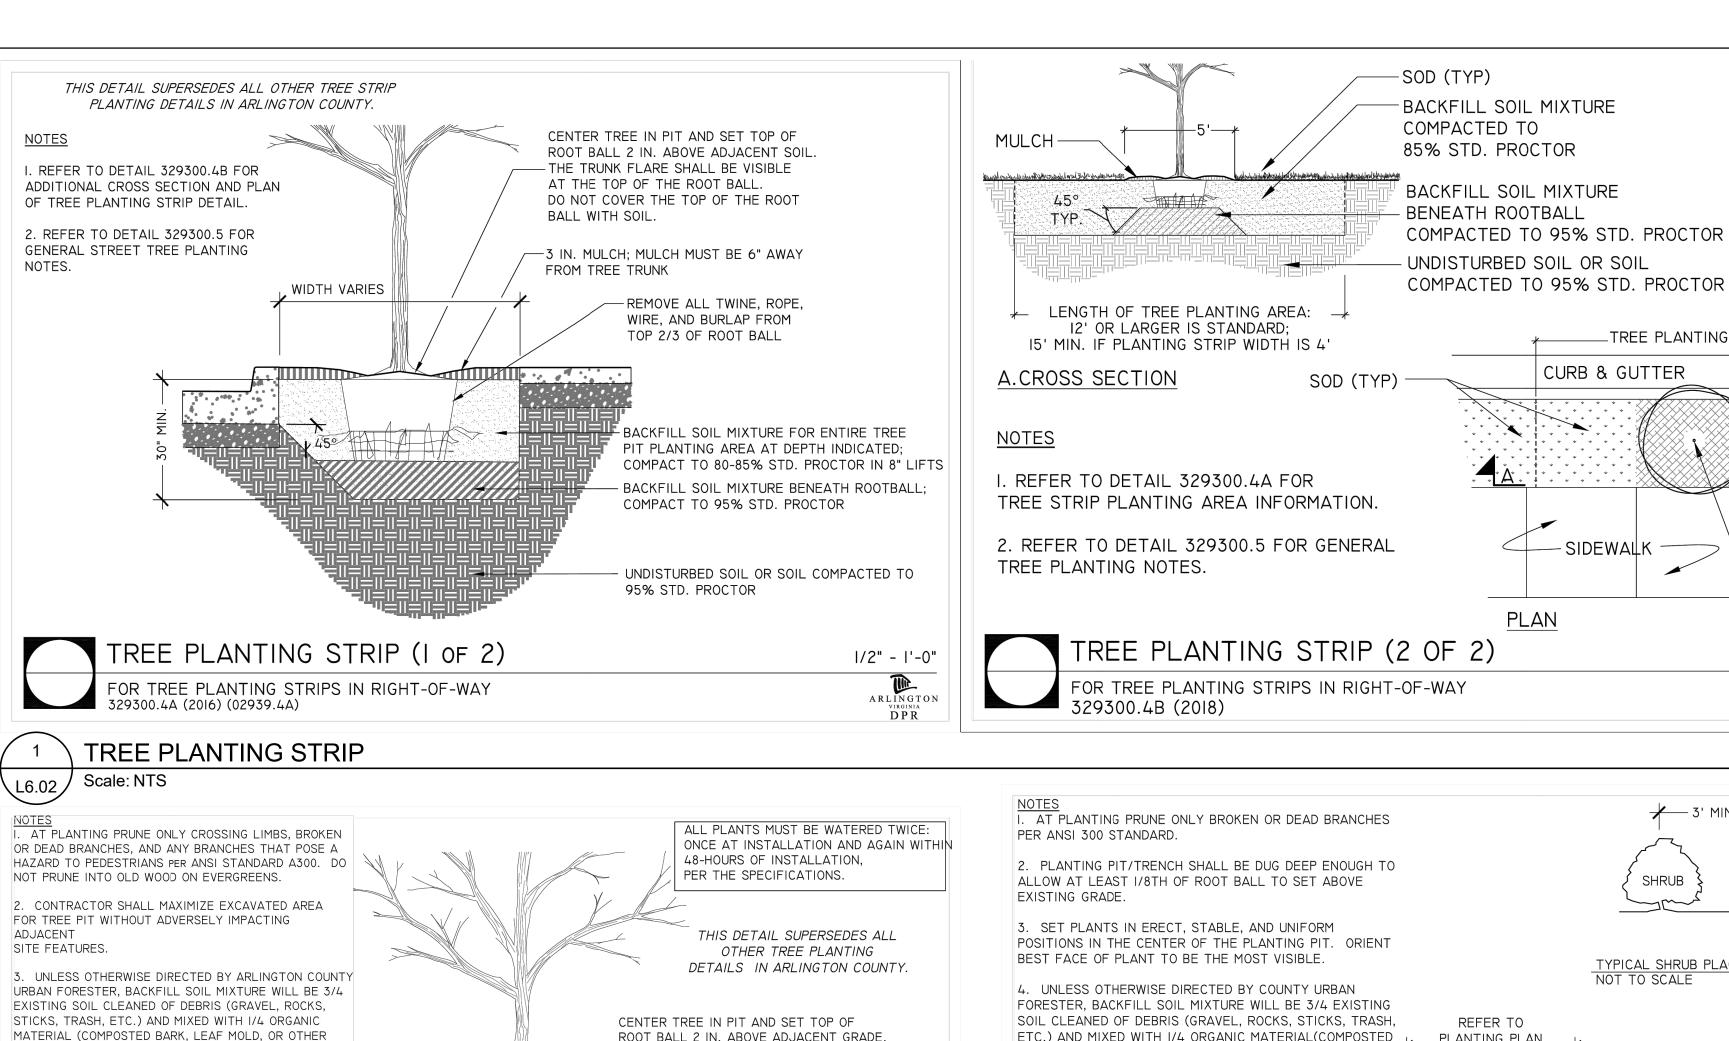

ROOT BALL 2 IN. ABOVE ADJACENT GRADE. THE TRUNK FLARE SHALL BE VISIBLE AT THE TOP OF THE ROOT BALL. DO NOT COVER THE TOP OF THE ROOT BALL WITH SOIL. MULCH RING (6 FT.) DIAM. MIN. 4. CONTRACTOR SHALL LEGALLY REMOVE EXCESS SOIL - 4 IN. HIGH EARTH SAUCER BEYOND EDGE OF ROOT BALL REMOVE ALL TWINE, ROPE, WIRE, MA A A AND BURLAP FROM TOP 2/3 OF TAMP SOIL AROUND ROOT BALL BASE FIRMLY WITH FOOT PRESSURE SO THAT ROOT BALL DOES NOT SHIFT - UNDISTURBED SUBGRADE MIN WIDTH OF TREE PIT 2 TIMES ROOTBALL DIAMETER OR 5'-0", WHICHEVER IS GREATER TREE PLANTING DETAIL NOT TO SCALE FOR OPEN PLANTING AREAS FREE OF PAVING OR GRATES ARLINGTON DPR SECTION

PLANT DEBRIS PROCESSED TO A POINT OF DECAY AND

5. TREES PLANTED WITHOUT THE TRUNK FLARE

6. TREES MAY ONLY BE STAKED IF REQUIRED BY

THE COUNTY URBAN FORESTER. REFER TO STAKING

3 IN. SHREDDED HARDWOOD MULCH:

ROUGHEN SIDES OF PLANTING HOLE -

SOIL SHALL BE FIRMED IN 8" LIFTS -

ENTIRE TREE PIT AREA X ROOTBALL DEPTH

TREE PLANTING

329300.1 (2019)

Scale: NTS

BACKFILL SOIL MIXTURE FOR

MULCH MUST BE 6 IN.

AWAY FROM TREE TRUNK -

NOT BE USED).


DETAILS.

L6.02 /

& DEBRIS FROM SITE.

VISIBLE WILL BE REJECTED.

APPROVED BY THE URBAN FORESTER; PEAT MOSS SHALL

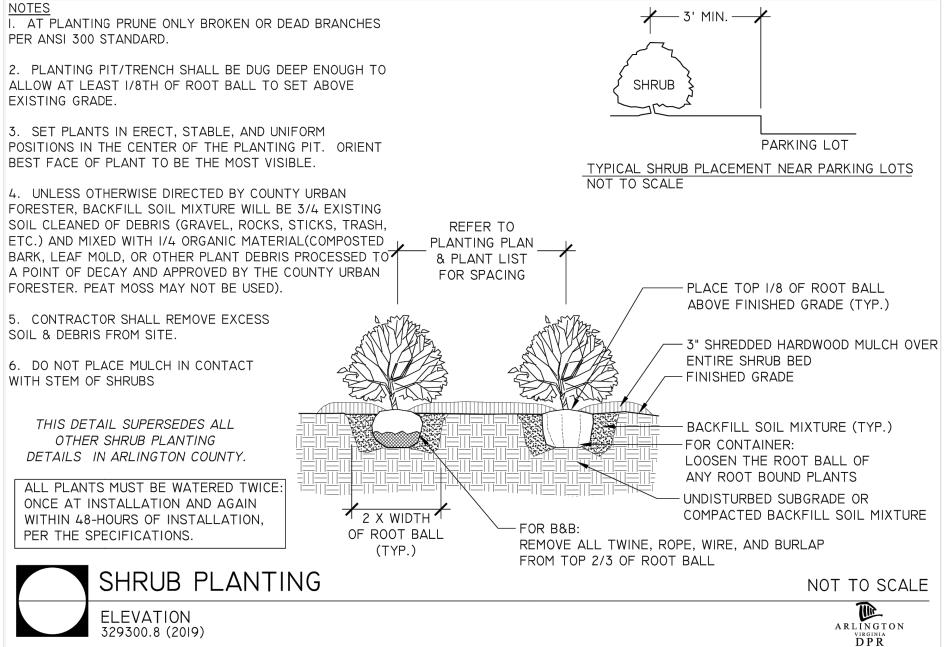

 $_{ extsf{-}}\mathsf{TREE}$ PLANTING AREA $_{ extsf{-}}$

⋆ STREET

-MULCH

-STREET TREE

NOT TO SCALE

DPR

SECTION

TREE PLANTING

L6.02

- PLANTS SHALL BE FURNISHED AND INSTALLED AS INDICATED ON THE LANDSCAPE PLAN.
- 2. PLANTS SHALL BE TYPICAL OF THEIR SPECIES AND VARIETY, AND COMPLY WITH MOST RECENT ANSI Z60.1 STANDARDS.
- 3. PLANTS SHALL BE PLANTED ON THE DAY OF DELIVERY. IF THIS IS NOT POSSIBLE, THE CONTRACTOR SHALL PROTECT STOCK NOT PLANTED. PLANTS SHALL NOT REMAIN UNPLANTED FOR LONGER THAN A THREE-DAY PERIOD AFTER DELIVERY. ANY PLANTS NOT INSTALLED DURING THIS PERIOD SHALL BE REJECTED. ALL PLANTS KEPT ON SITE FOR ANY PERIOD SHOULD BE WATERED AND CARED FOR USING ANSI A300 STANDARDS.
- NO STAKES SHALL BE USED TO STABILIZE TREES, UNLESS DIRECTED BY THE ARLINGTON COUNTY URBAN FORESTER.
- 5. TREES PLANTED SHALL RECEIVE A 3 INCH THICK LAYER OF SHREDDED HARDWOOD MULCH, IN A 6 FOOT RING SURROUNDING THE TREE, WITH A 6 INCH CLEAR AREA NEAR THE TRUNK.
- 6. PLANTS SHALL NOT BE BOUND WITH WIRE OR ROPE AT ANY TIME TO DAMAGE THE BARK OR BREAK BRANCHES. PLANTS SHALL BE HANDLED FROM THE BOTTOM OF THE ROOT BALL ONLY.
- 7. PLANTING OPERATIONS SHALL BE PERFORMED DURING PERIODS WITHIN THE PLANTING SEASON WHEN WEATHER AND SOIL CONDITIONS ARE SUITABLE AND IN ACCORDANCE WITH ACCEPTED LOCAL PRACTICE. PLANTS SHALL NOT BE INSTALLED IN TOP SOIL THAT IS IN MUDDY OR FROZEN CONDITION. TREES AND SHRUBS SHALL BE INSTALLED BETWEEN 09/15 AND 12/15 OR BETWEEN 03/15 AND 06/15. CONTACT THE ARLINGTON COUNTY URBAN FORESTER TO OBTAIN A DEFERRAL OR APPROVAL FOR PLANTING OUT OF SEASON.
- 8. NO PLANT, EXCEPT GROUNDCOVERS, SHALL BE PLANTED WITHIN TWO FEET OF A SIDEWALK, 5 FEET FROM A FENCE, 10 FEET FROM A BUILDING, OR 15 FEET FROM OVERHEAD UTILITY LINES.
- 9. TREES AND SHRUBS SHALL BE PLANTED IN HOLES TWO TO THREE TIMES AS WIDE AND TO THE DEPTH OF THE ROOT BALL.
- 10. PLANTS SHALL BE PLANTED IN HEALTHY, UNCOMPACTED SOIL. SEE THE PLANTING DETAIL FOR SOIL SPECIFICATIONS.
- 11. SET ALL PLANTS PLUMB AND STRAIGHT AT SUCH LEVEL THAT NORMAL OR NATURAL RELATIONSHIP BETWEEN THE PLANT AND THE GROUND SURFACE WILL BE ESTABLISHED. LOCATE THE PLANT IN THE CENTER OF THE PIT.
- 12. INJURED ROOTS SHALL BE PRUNED TO CLEAN ENDS BEFORE PLANTING WITH CLEAN, SHARP TOOLS. THE LEADER OF TREES SHALL NOT BE CUT BACK.
- 13. AT THE END OF THE PROJECT, PRESERVED AND PLANTED TREES MUST BE INSPECTED AND APPROVED BY AN ARLINGTON COUNTY URBAN FORESTER.

I. NOTIFY THE DPR URBAN FORESTER AT LEAST 72 HOURS IN ADVANCE OF THE SCHEDULED INSTALLATION OF TREE PITS AND PLANTING OF ANY STREET TREES FOR INSPECTION.

2. A PERMIT IS REQUIRED WHEN TREES ARE PLANTED IN PUBLIC RIGHT-OF-WAY OR IN A PUBLIC EASEMENT. THE DEPARTMENT OF ENVIRONMENTAL SERVICES SHALL ISSUE THE PERMIT ACCORDING TO THE PROVISIONS OF THE CURRENT ARLINGTON COUNTY ADMINISTRATIVE REGULATION 4.3.

3. TREE SPECIES SHALL BE SELECTED FROM THE "ARLINGTON COUNTY STREET TREE LIST" OR PER SECTOR PLAN REQUIREMENTS.

4. TREES SHALL BE NURSERY GROWN SPECIMENS THAT MEET THE LATEST EDITION OF THE AMERICAN STANDARDS FOR NURSERY STOCK (ANSI Z60). BALLED AND BURLAPPED TREES SHALL BE SECURELY HELD IN PLACE BY UNTREATED BURLAP AND STOUT ROPE (NYLON ROPE IS NOT ACCEPTABLE). LOOSE, BROKEN OR MANUFACTURED BALLS ARE UNACCEPTABLE.

5. CALL MISS UTILITY AT (800) 552-7001 FOR UTILITY LOCATIONS PRIOR TO EXCAVATION.

6. AT TIME OF PLANTING PRUNE ONLY CROSSING LIMBS, BROKEN OR DEAD BRANCHES, AND ANY BRANCHES THAT POSE A HAZARD TO PEDESTRIANS. DO NOT PRUNE INTO OLD WOOD ON EVERGREENS

7. TREE PIT AND TREE STRIP PLANTING AREA DIMENSIONS: SEE PLAN 8. SPACE TREES 25'-30' APART OR PER SECTOR PLAN REQUIREMENTS OR SITE

9. SITE CHARACTERISTICS, SUCH AS OVERHEAD POWER LINES, EXISTING VEGETATION, AND INFRASTRUCTURE ITEMS SUCH AS CURBS, SIDEWALKS AND UTILITIES SHALL BE CONSIDERED. TREES THAT GROW TALLER THAN 25 FEET SHOULD NOT BE PLANTED DIRECTLY UNDER POWER LINES. WHEN POSSIBLE THE TREE LEADER SHALL BE OFFSET FROM POWER LINES.

10. BACKFILL SOIL MIXTURE SHALL BE 3/4 EXISTING SOIL CLEANED OF DEBRIS (GRAVEL, ROCKS, STICKS, TRASH, ETC.) AND MIXED WITH 1/4 ORGANIC MATERIAL (COMPOSTED BARK, LEAF MOLD, OR OTHER PLANT DEBRIS PROCESSED TO A POINT OF DECAY AND APPROVED BY THE COUNTY URBAN FORESTER. PEAT MOSS MAY NOT BE USED.

II. IF THE QUANTITY OF ACCEPTABLE EXISTING SOIL IS INSUFFICIENT FOR THE PLANTING REQUIREMENTS, THE CONTRACTOR MAY USE TOPSOIL. SOIL TEST REPORT RESULTS FOR THE TOPSOIL WILL BE MADE AVAILABLE TO THE COUNTY URBAN FORESTER UPON REQUEST. CONTRACTOR SHALL SUBMIT TOPSOIL FOR APPROVAL TO COUNTY URBAN FORESTER THAT MEETS THE FOLLOWING SPECIFICATIONS:

(A.) TOPSOIL CONSISTS OF A SANDY LOAM WITH UNIFORM COMPOSITION AND IS FREE OF STONES, LUMPS, PLANTS, ROOTS, AND OTHER DEBRIS OVER 1/2" IN LENGTH. (B.) TOPSOIL HAS A PH RANGE OF 5.5 TO 6.5 AND A MINIMUM CONTENT OF I.0% ORGANIC MATTER (C.) TOPSOIL DOES NOT CONTAIN TOXIC SUBSTANCES HARMFUL TO PLANT GROWTH. SOLUBLE SALT LEVEL SHALL NOT EXCEED 3

12. TREES PLANTED WITHOUT THE TRUNK FLARE VISIBLE WILL BE REJECTED.


13. TREES MAY ONLY BE STAKED IF REQUIRED BY THE COUNTY URBAN FORESTER. REFER TO ARLINGTON COUNTY STANDARD STAKING DETAILS.

MILLIOHMS PER CENTIMETER.

14. MULCH SHALL BE CLEAN, SCREENED, DOUBLE-HAMMERED HARDWOOD BARK MULCH, UNIFORM IN SIZE AND FREE OF STONES, CLODS, NON-ORGANIC DEBRIS AND OTHER FOREIGN MATERIAL.

15. ALL PLANTS SHALL BE WATERED TWICE: ONCE AT INSTALLATION AND AGAIN WITHIN 48-HOURS OF INSTALLATION. EACH WATERING WILL CONSIST OF 20 GALLONS PER TREE.

16. CONTRACTOR SHALL LEGALLY REMOVE EXCESS SOIL & DEBRIS FROM SITE.

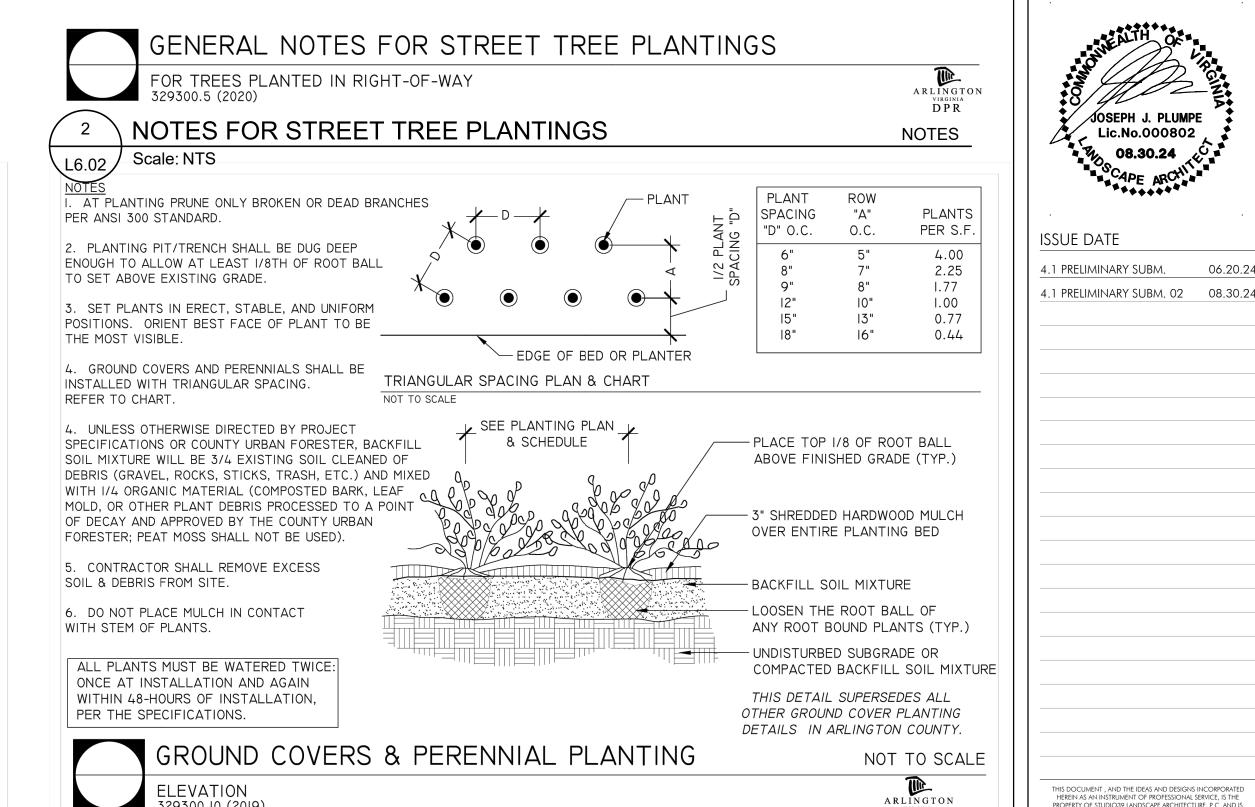

GROUND COVERS & PERENNIAL PLANTING Scale: NTS L6.02

ELEVATION

329300.10 (2019)

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DPR

PROJECT NUMBER: CONTACT: DAVID JUDD DRAWN:

750 23RD STREET

6416 GROVEDALE DR., SUITE 100-A

ALEXANDRIA, VIRGINIA 22310

703.719.6500 | STUDIO39.COM

√JOSEPH J. PLUMPE

Lic.No.000802 08.30.24

750 23RD STREET SOUTH

ARLINGTON, VA 22202

ARLINGTON COUNTY

SOUTH


CLIENT

WESLEY HOUSING

SEAL/SIGNATURE

ORIENTATION AND SCALE

APPROVED/CHECKED:

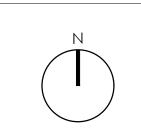

SHEET TITLE

LANDSCAPE DETAILS

SHEET NUMBER

4.1 PLAN


TREE PLANTING NOTES Scale: NTS L6.02

SHRUB PLANTING


Scale: NTS

SECTION

NOTES

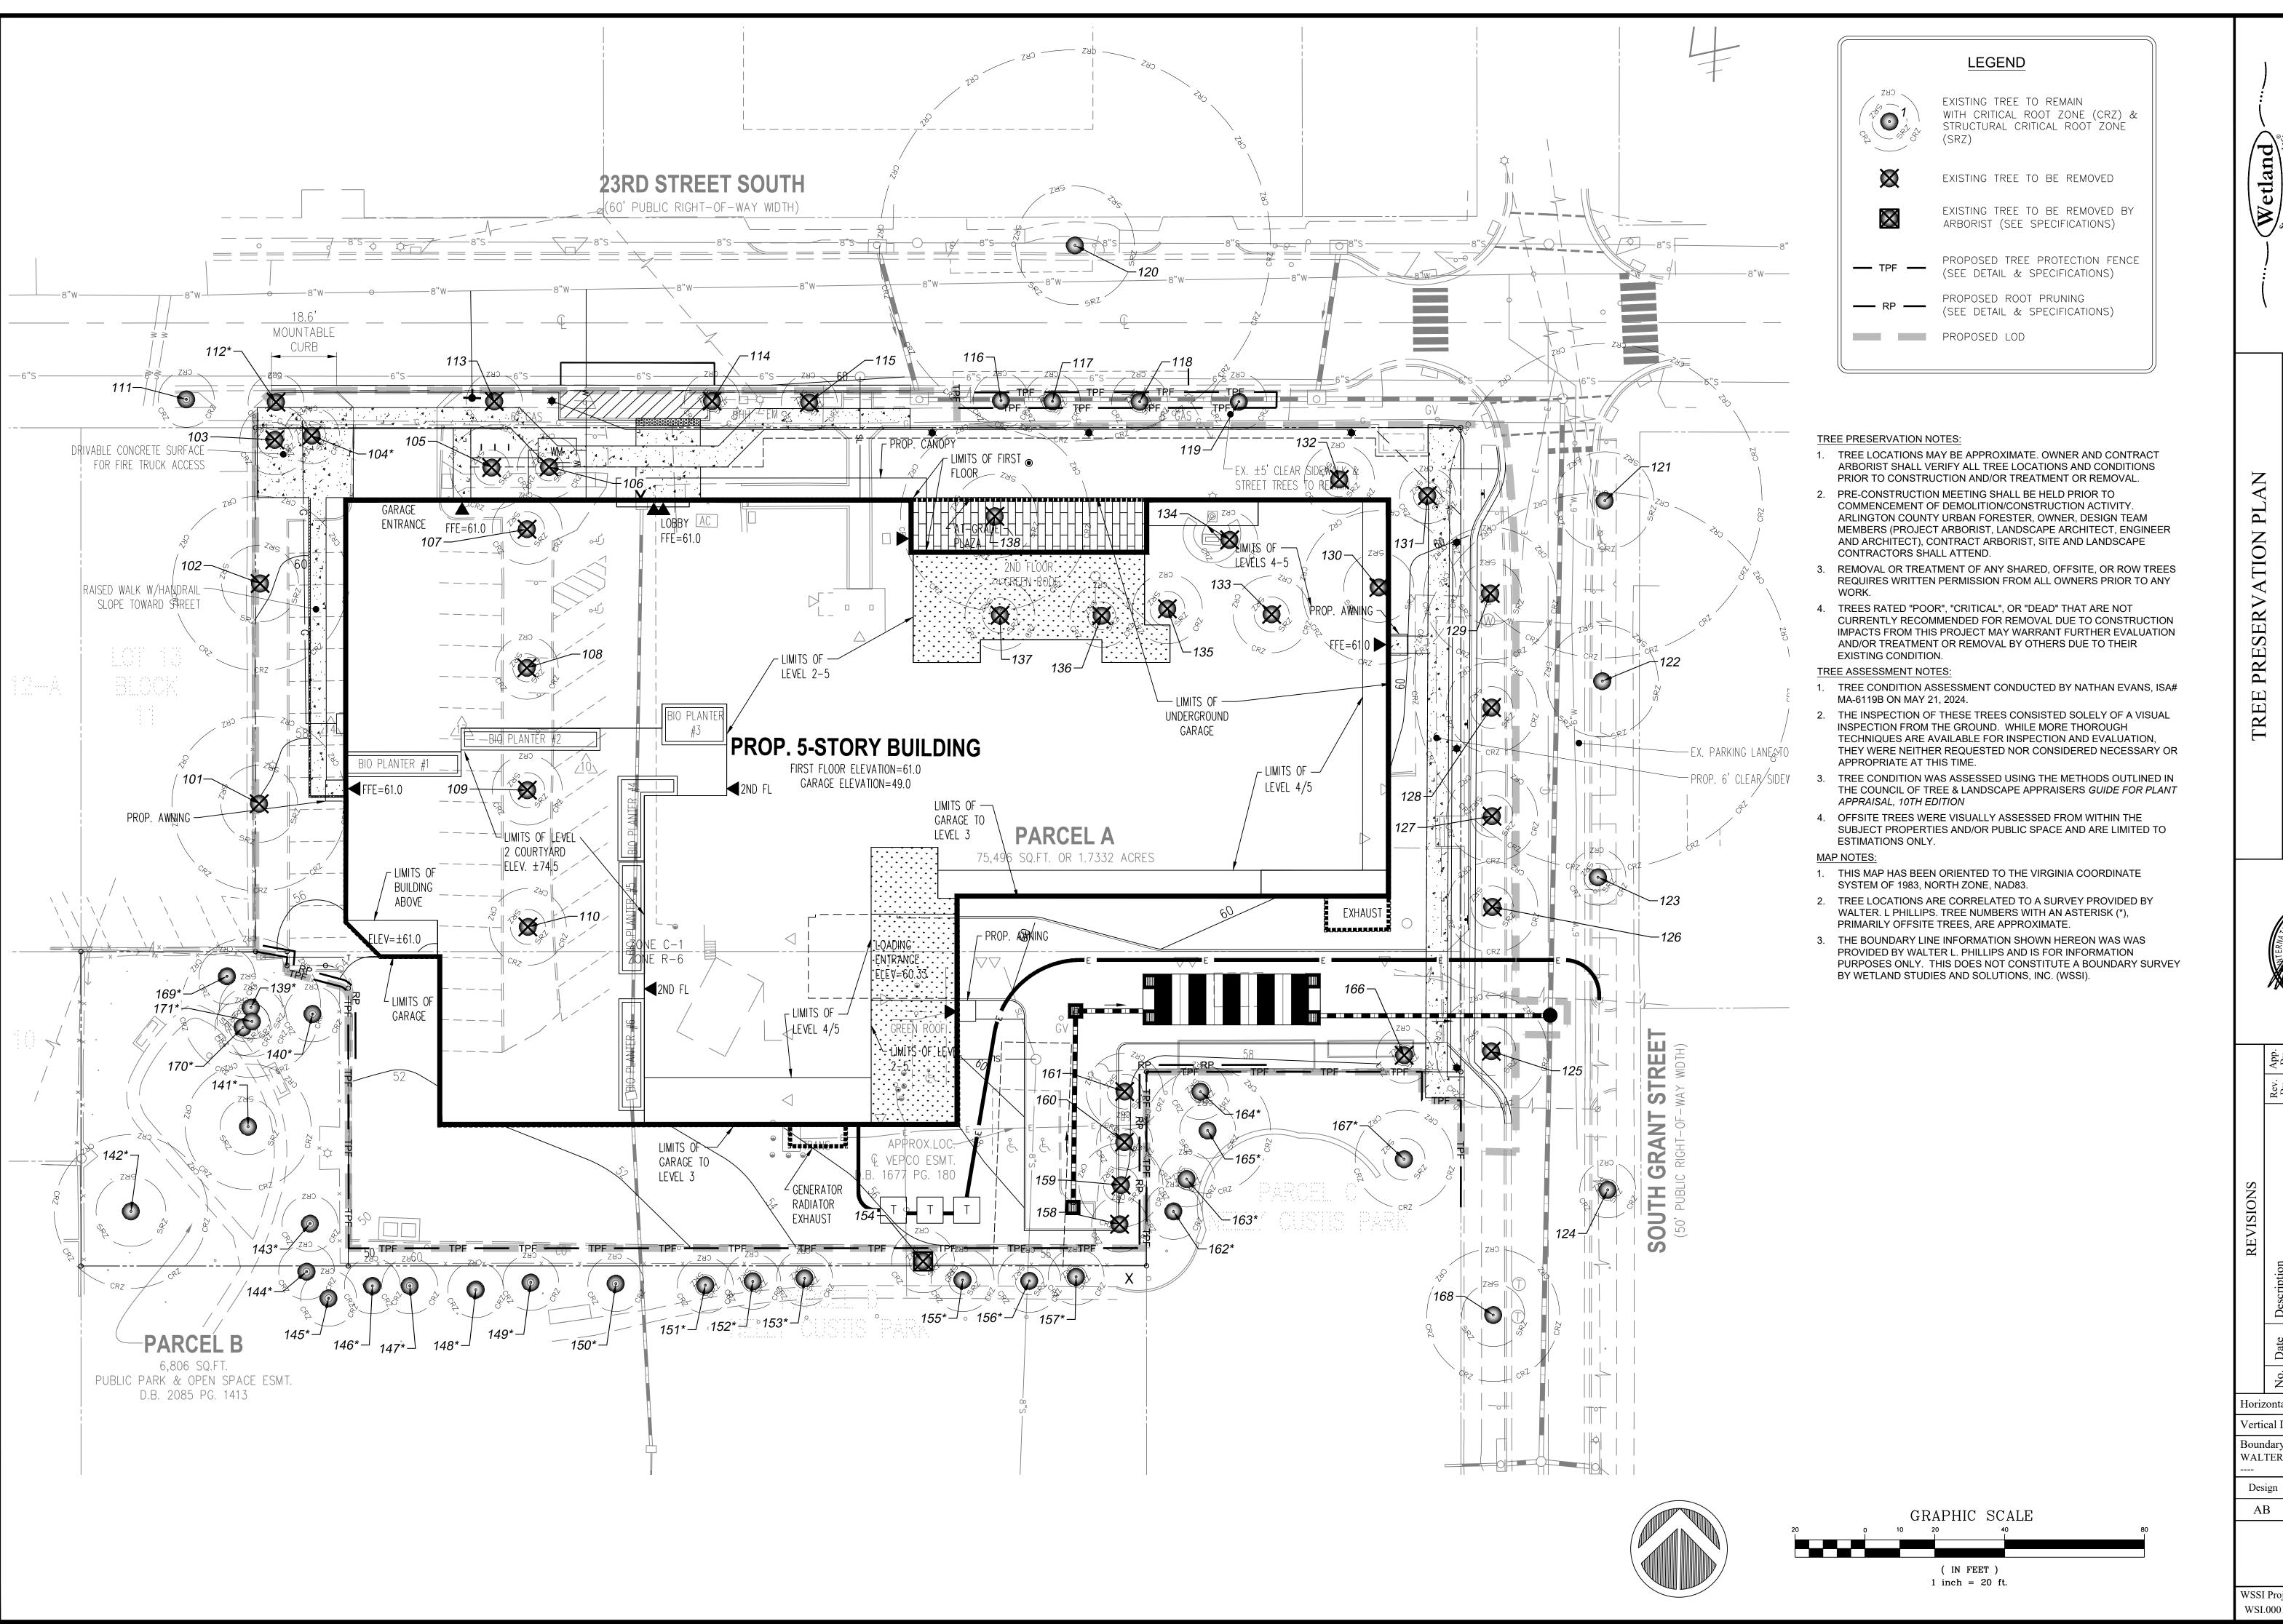



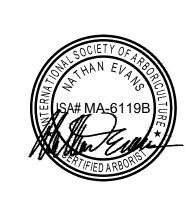

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	App. By						
	Rev. App. By By	JN	НЭ				:2,
							C.I.:2'
REVISIONS		NOISSIN	MISSION 02				SCALE:1" = 20'
REV	Description	06/18/24 4.1 PRELIMINARY SUBMISSION	08/28/24 4.1 PRELIMINARY SUBMISSION 02				DATE: AUG 28, 2024
	No. Date	06/18/24	08/28/24				E: AUC
	No.	-	2				DAT
Horiz	zontal l	Datı	ım:	VC	S NA	AD 8	33
Verti	cal Da	tum	:				

Vertical Datum:

Boundary and Topo Source: WALTER L. PHILLIPS

Draft Design Approved ABNE NE Sheet #

LJ-101


WSSI Project Number:

WSI.0001017

	Da	te: <u>AUG 28, 2024</u>								Tr	ee Pr	otectio	n A	ction	ı Ke	∍y							Project: <u>WSI.0001017</u>
Tree #	(Diameter at 4.5 feet above grade)	Common Name	Botanical Name	Condition Rating %	Condition Rating	Dead Tree (Y/N)	INVASIVE STATUS	Approx Canopy Radius (FT)	Approx Tree Height (FT)	Structural Critical Root Zone S (radius) in Feet	Arlington County Critical Root Zone Radius in Ft	CRZ % Impact	Removal	Removal By Arborist		Tree Protection Fence Mulch	/Aeration	Condition Inspections	tion Matt	latting	Γ	Additional Notes	Condition Notes
101	25	oak, pin	Quercus palustris	45%	Fair	NO	Native	18	55	11	25	100%	x									dead limbs over neighbors lot	Large DW (3"+), Small DW (1-2"), Serious Decline
102		oak, pin	Quercus palustris				Native	22				100%	X						_			vertical seam from base to18' response growth present	Large DW (3"+), Small DW (1-2")
103 104	8	pine, Japanese black pine, Japanese black	Pinus thunbergii Pinus thunbergii	60%	Fair	NO	Unknown Unknown	4	12 20	4	. 8	100%	X				\pm						Small DW (1-2")
105 106		pine, Japanese black pine, Japanese black	Pinus thunbergii Pinus thunbergii				Unknown Unknown	5	16 16			100%	X			_			+				
107	10	maple, red	Acer rubrum	70%	Good	NO	Native	15	25	5	10	100%	х									pruning wounds. response growth present. 2GR 1"x10"	Girdling Roots
108	9	maple, red	Acer rubrum	70%	Good	NO	Native	12	25	4	. 9	100%	х									pruning wounds. response growth present.	
109	10	maple, red	Acer rubrum	70%	Good	NO	Native	12	30	5	10	100%	x									pruning wounds. response growth present.	
110		maple, red	Acer rubrum				Native	14		5		100%	x									pruning wounds. response growth present.	
111 112		maple, Freeman hackberry, common	Acer × freemanii Celtis occidentalis	50%	Fair	NO	Unknown Native	1	12 10	0	8	none 100%	X			X							Small DW (1-2")
113 114		hackberry, common linden, American	Celtis occidentalis Tilia americana				Native Native	5	14 20	3		100%	X	++			+		+	\vdash			
115 116		linden, American oak, pin	Tilia americana Quercus palustris				Native Native	5	14	3		100%	X	\vdash		X	Ŧ					small birds nest	
117 118	7	linden, American	Tilia americana Tilia americana	65%	Good	NO	Native Native	6	20	3		2.2%	,			X	#						
119		linden, American	Tilia americana				Native	4	25		8	3.5%				X						effether a team and aidemalle	
120	37	ash, green	Fraxinus pennsylvanica	50%	Fair	NO	Native	25	40	17	56	0.9%	,			х						offsite no tag. paved sidewalk near trunk, flexipave?	Large DW (3"+), Small DW (1-2")
121	30	oak, pin	Quercus palustris	50%	Fair	NO	Native	15	25	14	45	13.2%	,			х						offsite, no tag. limited rooting area.	Overhead Utilities
122		oak, pin	Quercus palustris				Native	18					<u>, </u>			X	_		_			offsite, no tag. limited rooting area.	Overhead Utilities
123 124		lilac, Japanese tree lilac, Japanese tree	Syringa reticulata Syringa reticulata				Unknown Unknown	4	16 12		+	none none				X X						offsite, no tag.	
125	16	elm, Chinese	Ulmus parvifolia	65%	Good	NO	Invasive	18	45	7	16	100%	х									many girdling roots avg size 1.5"x24"	Girdling Roots
126		sycamore, American	Platanus occidentalis				Native	4	50	6		100%	х										Large DW (3"+), Small DW (1-2"), Stressed, Serious Decline, Branch Decay
127		elm, Chinese	Ulmus parvifolia				Invasive	18		6		100%	X	+								2GR 1"x6" many small girdling roots. minor	Girdling Roots
128 129	19	elm, Chinese elm, Chinese	Ulmus parvifolia Ulmus parvifolia	60%	Fair	NO	Invasive Invasive	14 20	50		19	100%	X				\pm					lean near water man hole	Girdling Roots Co-Dominant Stems
130 131		maple, red linden, American	Acer rubrum Tilia americana				Native Native	24 10				100%	X						+				Surface Roots
132 133		linden, American hemlock, eastern	Tilia americana Tsuga canadensis				Native Unknown	12 12				100% 100%	X				+						Co-Dominant Stems
134 135		pear, Callery hemlock, eastern	Pyrus calleryana Tsuga canadensis				Invasive Unknown	4 12	25 35			100% 100%	X				Ŧ						Co-Dominant Stems
136		hemlock, eastern	Tsuga canadensis				Unknown	12				100%	X									formerly codominant, second stem removed, stump remains	
																						dog vomit slime mold on tree, unlikely to harm tree, but potential	
137	10	hemlock, eastern	Tsuga canadensis	65%	Good	NO	Unknown	12	35	5	10	100%	X									overwatering multiple electrical outlets on post	
138		spruce, blue	Picea pungens				Unknown	17				100%	x		<u> </u>	<u> </u>	,				\ \ \ \ \ \ \ \ \ \ \ \ \ \ \ \ \ \ \	at base of trunk. some xmas lights tangled and cut in tree at ~18'	Hardware One Sided, Small DW (1-2"), Overhead
139 140	3	oak, pin oak, willow	Quercus palustris Quercus phellos	75%	Good	NO	Native Native	17	14	1	8	none)			X X		X			Х		Utilities Buried Root Collar
141		oak, willow	Quercus phellos				Native	18				none	\vdash			X	+		+				Small DW (1-2") Large DW (3"+), Small DW (1-2"), Broken
142 143	2	oak, pin oak, willow	Quercus palustris Quercus phellos	75%	Good	NO	Native Native	17 3	55 14	1		none none				X							Limbs, Branch Decay Buried Root Collar
144 145		birch, river baldcypress, common	Betula nigra Taxodium distichum				Native Unknown	3	16 16			none none				X						offsite, no tag estimated offsite, no tag estimated	Buried Root Collar
146 147	5	birch, river baldcypress, common	Betula nigra Taxodium distichum				Native Unknown	8	25 16	2	+	none				X X						offsite, no tag estimated offsite, no tag estimated	Surface Roots
148 149	5	birch, river	Betula nigra Quercus alba	70%	Good	NO	Native Native	10		2	8	none				X	‡	+	#			offsite, no tag estimated offsite, no tag estimated	
150		oak, swamp white	Quercus bicolor				Native	4	18	2		none				X						offsite, no tag estimated	Trunk Doogy Included Bork/Week Union Co.
151	6,5,6,4	crapemyrtle, common	Lagerstroemia indica	55%	Fair	NO	Unknown	10	25	5	11	none	_			х	_	_	_	_		offsite, no tag estimated	Trunk Decay, Included Bark/Weak Union, Co- Dominant Stems, Small DW (1-2") Included Bark/Weak Union, Co-Dominant
152	6,5,4	crapemyrtle, common	Lagerstroemia indica	65%	Good	NO	Unknown	8	25	4	9	none	_	\prod		x	+	_	_	_		offsite, no tag estimated	Stems, Small DW (1-2")
153 154		crapemyrtle, common pear, Callery	Lagerstroemia indica Pyrus calleryana				Unknown Invasive	8	20	5 4	11	none 26.7%)	X		х						offsite, no tag estimated	Small DW (1-2") Co-Dominant Stems, Small DW (1-2") Included Bark/Weak Union, Co-Dominant
155	6,6,5 5,4,4,4	crapemyrtle, common	Lagerstroemia indica	60%	Fair	NO	Unknown	10	25	4	10	none				x L			_		-	offsite, no tag estimated	Stems, Small DW (1-2") Surface Roots, Included Bark/Weak Union, Co-
156		crapemyrtle, common	Lagerstroemia indica	65%	Good	NO	Unknown	8	25	4	9	none				х	+		_			offsite, no tag estimated	Dominant Stems, Small DW (1-2") Included Bark/Weak Union, Co-Dominant
157 158		crapemyrtle, common pine, Japanese black	Lagerstroemia indica Pinus thunbergii		Good Fair		Unknown Unknown	10	25 20	5		none 100%	X	H		х	+	+	_		_	offsite, no tag estimated	Stems, Small DW (1-2")
159	12	crabapple, flowering	Malus spp.	60%	Fair	NO	Unknown	9	25		12	100%	X				+						Small DW (1-2")
160 161		pine, Japanese black crabapple, flowering	Pinus thunbergii Malus spp.		Fair Fair		Unknown Unknown	6	20 16			100%	X			\perp	\pm		+			affaita and the first state of t	Small DW (1-2")
162			Juniperus virginiana				Native	2				none			_	x x	_	X			X	playground	Basal Decay, Trunk Decay, Large DW (3"+), Small DW (1-2"), Serious Decline
163		redbud, eastern fringetree, Chinese	Cercis canadensis Chionanthus retusus				Native Unknown	10	<u> </u>		10	none 9.0%	-	\Box	X			X			X	offsite, no tag estimated offsite, no tag estimated	Basal Decay, Trunk Decay, Small DW (1-2") Included Bark/Weak Union, Co-Dominant Stems
165	18	sycamore, American	Platanus occidentalis	70%	Good	NO	Native	16	50	8	18	1.1%				X		X			X	offsite, no tag estimated	
166 167	15	pear, Callery sycamore, American	Pyrus calleryana Platanus occidentalis	60%	Fair	NO	Invasive Native	15		7	15	100% none	\ \ \ \ \ \ \ \ \ \ \ \ \ \ \ \ \ \ \			хх		X	_		Х	in planter on edge offsite, no tag, estimated	Trunk Decay, Small DW (1-2")
168 169	4	elm, Chinese redbud, eastern	Ulmus parvifolia Cercis canadensis	65%	Good	NO	Invasive Native	20 4	20	2	8	none none				X	\pm					offsite, no tag, estimated	Small DW (1-2") Small DW (1-2")
170		oak, willow	Quercus phellos				Native	6	35			none			\top	X	+		+				Small DW (1-2") Large DW (3"+), Small DW (1-2"), Serious
171	14	pine, Virginia	Pinus virginiana	40%	Poor	ΙΝΟ	Native	<u> </u>	35	6	14	none				X							Decline

ARLINGTON COUNTY REPLACEMENT CALCULATIONS

Tree #	DBH (inches)	Species	To Be Removed (Y/N)	Condition	Species Rating	Total Score	Replacements Required
101		Quercus palustris	Yes	45%	80%	9.00	2
102		Quercus palustris	Yes	55%	80%	11.00	3
103		Pinus thunbergii	Yes	65%	65%	4.23	1
104		Pinus thunbergii	Yes	60%	65%	3.12	1
105 106		Pinus thunbergii Pinus thunbergii	Yes	65% 55%	65% 65%	5.07	2
106		Acer rubrum	Yes	70%	85%	3.22 5.95	
107		Acer rubrum Acer rubrum	Yes Yes	70%	85%	5.36	1 1
109		Acer rubrum	Yes	70%	85%	5.95	1 1
110		Acer rubrum	Yes	70%	85%	6.55	2
111		Acer × freemanii	No	50%	70%	1.05	0
112	1	Celtis occidentalis	Yes	50%	70%	0.35	1
113	2	Celtis occidentalis	Yes	65%	70%	0.91	1
114	7	Tilia americana	Yes	70%	80%	3.92	1
115	6	Tilia americana	Yes	70%	80%	3.36	1
116	5	Quercus palustris	No	65%	80%	2.60	0
117	7	Tilia americana	No	65%	80%	3.64	0
118	7	Tilia americana	No	65%	80%	3.64	0
119		Tilia americana	No	60%	80%	2.40	0
120		Fraxinus pennsylvanica	No	50%	25%	4.63	0
121		Quercus palustris	No	50%	80%	12.00	0
122		Quercus palustris	No	50%	80%	14.40	0
123		Syringa reticulata	No	70%	75%	4.20	0
124		Syringa reticulata	No	65%	75%	2.93	0
125 126		Ulmus parvifolia Platanus occidentalis	Yes Yes	65% 40%	70% 70%	7.28 3.64	2
127		Ulmus parvifolia	Yes	40% 65%	70%	5.92	2
128		Ulmus parvifolia	Yes	60%	70%	5.46	2
129		Ulmus parvifolia	Yes	60%	70%	7.98	2
130		Acer rubrum	Yes	70%	85%	13.09	3
131		Tilia americana	Yes	75%	80%	4.80	1
132		Tilia americana	Yes	75%	80%	6.00	1 1
133		Tsuga canadensis	Yes	65%	60%	4.29	1
134		Pyrus calleryana	Yes	70%	20%	0.70	1
135		Tsuga canadensis	Yes	65%	60%	3.90	1
136	9	Tsuga canadensis	Yes	60%	60%	3.24	1
137	10	Tsuga canadensis	Yes	65%	60%	3.90	1
138	27	Picea pungens	Yes	75%	50%	10.13	3
139		Quercus palustris	No	60%	80%	12.48	0
140		Quercus phellos	No	75%	90%	2.03	0
141		Quercus phellos	No	55%	90%	13.37	0
142		Quercus palustris	No	50%	80%	11.60	0
143		Quercus phellos	No	75%	90%	1.35	0
144		Betula nigra	No	75%	70%	1.58	0
145		Taxodium distichum	No	75%	70%	2.63	0
146 147		Betula nigra Taxodium distichum	No No	75% 75%	70% 70%	2.63 2.10	0
147		Betula nigra	No	75%	70%	2.10	0
149		Quercus alba	No	70% 75%	95%	3.56	0
150		Quercus bicolor	No	75%	95%	2.85	0
151		Lagerstroemia indica	No	55%	80%	4.84	0
152		Lagerstroemia indica	No	65%	80%	4.68	0
153		Lagerstroemia indica	No	60%	80%	5.28	0
154		Pyrus calleryana	Yes	65%	20%	1.17	1
155		Lagerstroemia indica	No	60%	80%	4.80	0
156		Lagerstroemia indica	No	65%	80%	4.68	0
157		Lagerstroemia indica	No	65%	80%	6.24	0
158		Pinus thunbergii	Yes	55%	65%	1.79	1
159		Malus spp.	Yes	60%	65%	4.68	1
160		Pinus thunbergii	Yes	60%	65%	3.12	1
161		Malus spp.	Yes	50%	65%	3.58	1
162		Juniperus virginiana	No	30%	80%	1.68	0
163		Cercis canadensis	No	45%	80%	3.60	0
164		Chionanthus retusus	No	60%	60%	2.88	0
165		Platanus occidentalis	No	70%	70%	8.82	0
166		Pyrus calleryana	Yes	70%	20%	0.98	1
167		Platanus occidentalis	No	60%	70%	6.30	0
168		Ulmus parvifolia	No	75%	70%	9.98	0
169		Cercis canadensis	No	65%	80%	2.08	0
170 171		Quercus phellos	No	65%	90%	6.44	0
1/11	14	Pinus virginiana	No	40%	65%	3.64	l O

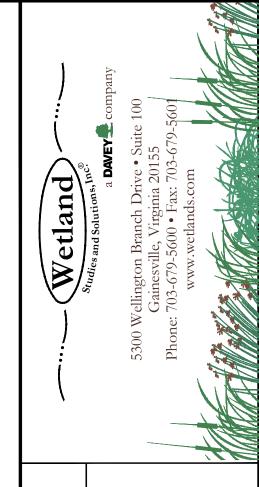

750 73RD ST COLLTH

/ 50 25KD 4.1



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Horizontal Datum: VCS NAD 83

Vertical Datum:

Boundary and Topo Source: WALTER L. PHILLIPS

AB NE NE

Sheet #

LJ-102

WSSI Project Number: WSI.0001017

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Page 1 of 1

- 1.1. REFER TO THE TREE PROTECTION ACTION KEY (TPAK) FOR SPECIFIC RECOMMENDATIONS FOR
- 1.2. PRIOR TO ANY DEMOLITION OR CONSTRUCTION WORK WITHIN OR ADJACENT TO TREE PROTECTION AREAS (TPA), A PRE-CONSTRUCTION SITE WALK SHALL BE HELD TO INCLUDE THE CONTRACT ARBORIST AND PROJECT ARBORIST WITH THE CONTRACTOR, ARCHITECT, ARLINGTON COUNTY URBAN FORESTER, AND OWNER.
- 1.3. SUBSTITUTIONS OR ALTERNATIVE METHODS OR MATERIALS SHALL BE REVIEWED AND APPROVED 6.3BY ARLINGTON COUNTY URBAN FORESTER.
- 1.4. ALL TREE PROTECTION MEASURES MUST BE IN PLACE PRIOR TO COMMENCEMENT OF DEMOLITION, SITE CLEARING OR CONSTRUCTION AND MAINTAINED THROUGHOUT CONSTRUCTION. TREE PROTECTION MEASURES MAY ONLY BE REMOVED WITH ARLINGTON COUNTY URBAN
- 1.5. ALL MEASURES WILL BE REVIEWED AFTER INSTALLATION AND APPROVED BY OWNER AND ARLINGTON COUNTY URBAN FORESTER.

2. <u>REMOVAL BY ARBORIST</u>

FORESTER APPROVAL

- 2.1. TREES DESIGNATED AS "REMOVAL BY ARBORIST" SHALL BE REMOVED BY A QUALIFIED ARBORIST "BY HAND", TO MINIMIZE POTENTIAL FOR DAMAGE TO REMAINING TREES AND ROOTS.
- 2.2. CREWS SHALL BE DIRECTLY SUPERVISED BY A CERTIFIED ARBORIST.
- 2.3. TRUCKS AND MECHANIZED EQUIPMENT SHALL NOT ENTER THE FENCED TREE PROTECTION AREAS, EXCEPT WHERE EXPLICITLY APPROVED BY THE PROJECT ARBORIST AND UTILIZING
- APPROVED ROOT PROTECTION DEVICE. 2.4. STUMPS SHALL BE LEFT IN PLACE OR GROUND OUT AT THE OWNERS DISCRETION. STUMPS IN TURF/LANDSCAPE AREAS OR WITHIN ROOT AERATION MATTING AREAS SHALL BE GROUND.
- 2.5. STUMP GRINDING SHALL BE DONE WITH SMALL MACHINES SPECIFICALLY DESIGNED FOR THAT PURPOSE. NO STUMPS SHALL BE EXCAVATED EXCEPT AS DESCRIBED HEREIN. STUMPS SHALL BE GROUND NOT MORE THAN 8" BELOW GRADE AND CARE MUST BE TAKEN TO MINIMIZE DAMAGE TO ROOTS OF RETAINED TREES.

3. TREE PROTECTION FENCE

- 3.1. INSTALL AND MAINTAIN TEMPORARY TREE PROTECTION FENCE FOR EACH TREE PROTECTION AREA AS SHOWN ON THE PLAN. INSTALLATION IS TYPICALLY AFTER ROOT PRUNING AND PRIOR TO CLEARING & GRADING.
- 3.2. FENCE SHALL BE ONE OF THE FOLLOWING: (SEE DETAIL)
- 3.2.1. 4' HIGH, 14 GAUGE WELDED WIRE FENCE MOUNTED ON 6' STEEL "T" POSTS SPACED NOT MORE THAN 10' APART. FENCE SHALL BE ATTACHED TO POSTS USING GALVANIZED STEEL 8.1. ANSI A300 STANDARD PRACTICES FOR TREES, SHRUBS, AND OTHER WOODY PLANT MAINTENANCE CLIPS OR ALUMINUM TIES. PLASTIC "ZIP" TIES SHALL NOT BE USED.
- 3.2.2. 6' HIGH CHAIN LINK FENCE FABRIC MOUNTED ON 8', 1.5"Ø GALVANIZED STEEL PIPE LINE POSTS. CORNER POSTS SHALL BE 2"Ø. FENCE SHALL BE ATTACHED TO POSTS USING ALUMINUM TIES. PLASTIC "ZIP" TIES SHALL NOT BE USED.
- 3.2.3. "SUPER SILT FENCE" (SILT FENCE WITH AN INCORPORATED CHAIN LINK FENCE FABRIC) INSTALLED AS SPECIFIED BY APPROPRIATE STATE OR LOCAL EROSION AND SEDIMENT CONTROL REQUIREMENTS.
- 3.3. SILT FENCE SHALL BE COORDINATED FOR INSTALLATION TO ENHANCE PROTECTION AND AVOID UNNECESSARY ROOT CUTS BY SILT FENCE INSTALLATION.
- 3.4. FENCE SHALL REMAIN FOR THE DURATION OF CONSTRUCTION. FENCE MAY BE REMOVED ONLY AFTER ALL CONSTRUCTION AND FINAL LANDSCAPING IS COMPLETE AND WITH ARLINGTON COUNTY URBAN FORESTER APPROVAL.

4. TREE PROTECTION AREA SIGNS

2" CHAIN -

LINK FABRIC

SALVANIZED STEEL

SIGN ENLARGEMENT

PIPE 2" O.D.-

- 4.1. TREE PROTECTION AREA SIGNS SHALL BE AFFIXED TO ALL TREE PROTECTION FENCE AT 30' SPACING AVERAGE.
- 4.2. SIGNS SHALL BE BILINGUAL (ENGLISH AND SPANISH).
- 4.3. SIGNS SHALL NOT BE AFFIXED DIRECTLY TO TREES. SEE DETAIL.
- 4.4. SIGN MATERIAL SHALL BE WATERPROOF, HEAVY VINYL OR SIMILAR. 4.5. SIGNS SHALL BE MAINTAINED THROUGHOUT CONSTRUCTION.
- 5. <u>ROOT PRUNE</u>

FREE PRESERVATION

CALL: 703-228-6557

TO REPORT VIOLATIONS

PROHIBIDO ENTRAR

ZONA DE PROTECTION DEL ARBO

PARA REPORTAR INFRACCIONES

APPROVE LAYOUT.

I. TREE PROTECTION FENCE (TPF) SHALL BE INSTALLED

ARLINGTON COUNTY URBAN FORESTER SHALL BE NOTIFIED

72 HOURS PRIOR TO INSTALLATION OF ANY OTHER TREE

PRESERVATION MEASURE SPECIFIED IN PLANS AND SHALL

2. NO PERSONNEL, VEHICLES, EQUIPMENT, CONSTRUCTION

AREAS WITHOUT WRITTEN CONSENT OF ARLINGTON COUNTY

MATERIALS OR DEBRIS ALLOWED IN TREE PROTECTION

PRIOR TO ANY SITE WORK, CLEARING OR DEMOLITION.

- 5.1. THE EXACT LOCATION AND DEPTH WILL BE DETERMINED DURING THE PRE-CONSTRUCTION MEETING. SPECIFIC EQUIPMENT & METHODS WILL BE DETERMINED BY PROJECT ARBORIST AND ARLINGTON COUNTY URBAN FORESTER BASED UPON DEPTH & TREE IMPACT. (SEE DETAIL)
- 5.2. HAND PRUNE ROOTS OVER 1" DIAMETER WITHIN CRZS OF SIGNIFICANT TREES. STEEP SLOPES, DEEP EXCAVATIONS AND PAVEMENT/CURB REMOVAL WILL BE REVIEWED WHEN OPEN FOR HAND ROOT PRUNING DURING CONSTRUCTION.
- 5.3. COORDINATE WITH SILT FENCE INSTALLATION TO MINIMIZE UNNECESSARY ROOT DAMAGE
- 5.4. ROOT PRUNING SHALL BE PERFORMED BY A CERTIFIED ARBORIST.

6. WOOD CHIP MULCH

- 6.1. INSTALL MULCH FOR DESIGNATED SIGNIFICANT TREES. MULCH AREA SHALL BE ONE OF THE FOLLOWING, AT THE DISCRETION OF THE CONTRACT ARBORIST AND OWNER:
- 6.1.1. INSTALL MULCH BED RINGS. MULCH SHOULD COVER AT LEAST THE ENTIRE STRUCTURAL ROOT ZONE. LARGER MULCH BEDS ARE PREFERRED.
- 6.1.2. PROVIDE CONTINUOUS MULCH STRIP 10' TO 15' WIDE ALONG LOD WITHIN PRESERVED CRZ

MULCH SHALL BE INSTALLED TO A DEPTH OF 4". TOTAL MULCH DEPTH SHALL NOT EXCEED 4"

- SHOULD EXISTING MULCH BE PRESENT. MULCH SHALL BE DOUBLE GROUND SHREDDED HARDWOOD, AGED FOR AT LEAST 6 MONTHS FROM AN APPROVED SOURCE. INSUFFICIENTLY OR IMPROPERLY AGED MULCH CONTAINING HIGH BACTERIAL COUNTS OR HIGH LEVELS OF BARK, WALNUT, INVASIVE SPECIES, OR OTHER
- MATERIALS RESISTANT TO DECOMPOSITION SHALL NOT BE USED. 6.4. MULCH SHALL NOT CONTACT TRUNK OF TREES.
- 6.5. EDGING SHALL NOT BE USED.
- 7. <u>CONSTRUCTION MONITORING/INSPECTIONS</u>
- 7.1. A CERTIFIED ARBORIST SHALL ACTIVELY MONITOR THE SITE TO ENSURE ADHERENCE TO ALL TREE PROTECTION REQUIREMENTS.
- 7.2. THIS WORK IS TYPICALLY PREFORMED BY THE CONTRACT ARBORIST, TO BE HIRED BY THE GENERAL CONTRACTOR OR OWNER.

7.3. SCHEDULE:

- 7.3.1. PHASE 1 (DURING INITIAL CLEARING AND INSTALLATION OF TREE PROTECTION AND PERIMETER E&S CONTROLS) INSPECTIONS SHALL BE AT LEAST WEEKLY.
- 7.3.2. PHASE 2 (DURING ALL REMAINING SITE WORK AND UNTIL PROJECT COMPLETION) INSPECTIONS SHALL BE AT LEAST MONTHLY.
- 7.3.3. TRANSITION FROM WEEKLY TO MONTHLY SCHEDULE SHALL REQUIRE OWNER AND ARLINGTON
- *County urban forester* approval. 7.4. REPORTS SHALL BE PROVIDED TO THE OWNER AND ARLINGTON COUNTY URBAN FORESTER. REPORTS SHALL DOCUMENT CONDITION OF TREE PROTECTION DEVICES AND PROVIDE
- 7.5. ADDITIONAL ARBORIST INSPECTIONS AND/OR DIRECT ARBORIST OVERSIGHT OF CRITICAL TREE PRESERVATION ACTIVITIES, TREE PRUNING, TREE REMOVAL, OR OTHER SENSITIVE ACTIVITIES MAY BE REQUIRED. WEEKLY INSPECTIONS DO NOT SATISFY THE NEED FOR DIRECT ARBORIST OVERSIGHT THAT MAY BE REQUIRED FOR SPECIFIC ACTIVITIES.

8. PUBLICATIONS INCLUDED BY REFERENCE PUBLICATIONS LISTED HEREIN ARE PART OF THIS WORK TO EXTENT REFERENCED:


- 8.1.1. PART 1 -- 2017, TREE PRUNING
- 8.1.2. PART 2 -- 2018, SOIL MANAGEMENT

RECOMMENDATIONS FOR MAINTENANCE AND/OR ADDITIONAL CARE

- 8.1.3. PART 3 -- 2013, SUPPLEMENTAL SUPPORT SYSTEMS
- 8.1.4. PART 4 -- 2014, LIGHTNING PROTECTION SYSTEMS
- 8.1.5. PART 5 -- 2019, MANAGEMENT OF TREES AND SHRUBS DURING SITE PLANNING, SITE DEVELOPMENT, AND CONSTRUCTION
- 8.1.6. PART 6 -- 2018, PLANTING AND TRANSPLANTING
- 8.1.7. PART 8 -- 2020, ROOT MANAGEMENT
- 8.1.8. PART 9 -- 2017, TREE RISK ASSESSMENT
- 8.1.9. PART 10 -- 2016, IPM
- 8.2. ANSI Z133.1 -- 2017 AND MOST RECENT UPDATES, ARBORICULTURAL OPERATIONS -- SAFETY REQUIREMENTS

ARLINGTON COUNTY STANDARD TREE PROTECTION NOTES

- 1. BEFORE ANY GRADING, DEMOLITION, OR OTHER DISTURBANCE, TREE PROTECTION NEEDS TO BE INSTALLED PER PLAN, AND INSPECTED BY AN ARLINGTON COUNTY PARKS AND RECREATION URBAN FORESTER. EROSION AND SEDIMENT CONTROLS ARE INSPECTED BY THE DEPARTMENT OF ENVIRONMENTAL SERVICES.
- 2. PLANTS SHALL BE FURNISHED AND INSTALLED AS INDICATED, INCLUDING ALL PLANTS, MATERIALS, AND EQUIPMENT.
- 3. PLANTS SHALL BE TYPICAL OF THEIR SPECIES AND VARIETY; HAVE NORMAL GROWTH HABITS, WELL-DEVELOPED DENSELY FOLIATED BRANCHES, AND VIGOROUS ROOT SYSTEMS; AND BE FREE FROM DEFECTS AND INJURIES.
- 4. PLANTS SHALL BE PLANTED ON THE DAY OF DELIVERY IF/WHEN PRACTICAL. IN THE EVENT THAT THIS IS NOT POSSIBLE, THE CONTRACTOR SHALL PROTECT STOCK NOT PLANTED. PLANTS SHALL NOT REMAIN UNPLANTED FOR LONGER THAN A THREE-DAY PERIOD AFTER DELIVERY. ANY PLANTS NOT INSTALLED DURING THIS PERIOD SHALL BE REJECTED, UNLESS OWNER AND CONTRACTOR PROVIDE OTHERWISE BY WRITTEN AGREEMENT. ALL PLANTS KEPT ON SITE FOR ANY PERIOD OF TIME SHOULD BE WATERED AND CARED FOR USING ANSI A300 STANDARDS.
- 5. PLANTS SHALL NOT BE BOUND WITH WIRE OR ROPE AT ANY TIME SO AS TO DAMAGE THE BARK OR BREAK BRANCHES. PLANTS SHALL BE HANDLED FROM THE BOTTOM OF
- 6. PLANTING OPERATIONS SHALL BE PERFORMED DURING PERIODS WITHIN THE PLANTING SEASON WHEN WEATHER AND SOIL CONDITIONS ARE SUITABLE AND IN ACCORDANCE WITH ACCEPTED LOCAL PRACTICE. PLANTS SHALL NOT BE INSTALLED IN TOP SOIL THAT IS IN MUDDY OR FROZEN CONDITION. LAWNS, TREES AND SHRUBS SHALL BE INSTALLED BETWEEN 03/15 AND 06/15 OR BETWEEN 09/15 AND 12/01. IF A PROJECT COMPLETION IS OUTSIDE OF THIS PLANTING PERIOD, CONTACT THE ARLINGTON COUNTY URBAN FORESTER TO OBTAIN A DEFERRAL OR APPROVAL FOR PLANTING OUT OF SEASON.
- 7. NO PLANT, EXCEPT GROUND COVERS, SHALL BE PLANTED WITHIN TWO FEET OF A
- 8. TREES AND SHRUBS SHALL BE PLANTED IN HOLES TWO TO THREE TIMES AS WIDE AND TO THE DEPTH OF THE ROOT BALL.
- 9. PLANTS SHALL BE PLANTED IN IN SITU SOIL THAT IS THOROUGHLY WATERED.
- 10. SET ALL PLANTS PLUMB AND STRAIGHT SET AT SUCH LEVEL THAT NORMAL OR NATURAL RELATIONSHIP BETWEEN THE PLANT AND THE GROUND SURFACE WILL BE ESTABLISHED. LOCATE THE PLANT IN THE CENTER OF THE PIT.
- 11. INJURED ROOTS SHALL BE PRUNED TO CLEAN ENDS BEFORE PLANTING WITH CLEAN, SHARP TOOLS. THE LEADER OF TREES SHALL NOT BE CUT BACK.
- 12. PRESERVED AND PLANTED TREES MUST BE INSPECTED AND APPROVED BY A DEPARTMENT OF PARKS AND RECREATION URBAN FORESTER.
- 13. ALL DISTURBED AREAS SHALL BE TREATED WITH 4" TOP SOIL OR COMPOST AND SEEDED IN ACCORDANCE WTH PERMANENT STABILIZATION METHODS INDICATED ON SOIL EROSION AND SEDIMENT CONTROL SHEET AND/OR LANDSCAPE PLAN.

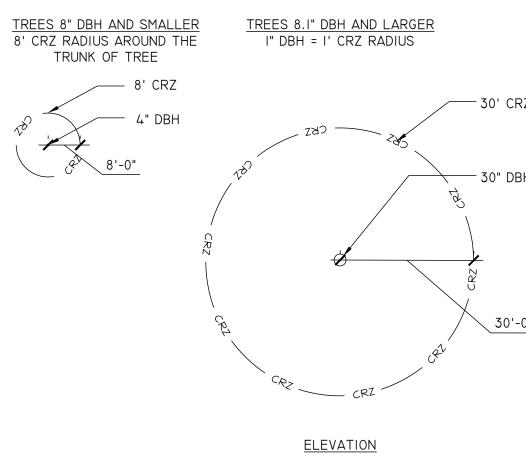

NOTES:


I. GRAPHICALLY, THE CRITICAL ROOT ZONE (CRZ) IS REPRESENTED AS A CIRCULAR REGION MEASURED OUTWARD FROM A TREE TRUNK REPRESENTING THE AREA OF ROOTS THAT MUST BE MAINTAINED OR PROTECTED FOR THE TREE'S SURVIVAL.

. THE CRZ OF A TREE IS THE ZONE IN WHICH MOST OF THE MAJORITY OF THE ROOTS LAY. 95% OF THE ROOTS OF MOST TREES WILL BE FOUND IN THE UPPER 12-18" OF THE SOIL. MOST OF THE ROOTS THAT SUPPLY THE NUTRIENTS AND WATER TO THE TREE ARE FOUND JUST BELOW THE SOIL SURFACE. THE TOTAL AMOUNT OF A TREE'S ROOTS ARE GENERALLY PROPORTIONAL TO THE VOLUME OF THE TREE'S CANOPY. THEREFORE IF THE ROOTS ONLY PENETRATE A THIN LAYER OF SOIL, THEN THE ROOTS MUST SPREAD FAR FROM THE TREE, BEYOND THE EXTENSION OF THE CANOPY.

GREATER THAN 3" DIAMETER AT BREAST HEIGHT (DBH) AND/OR TREE STANDS WITHIN DEVELOPMENT AREAS ON ALL PLANS FOR THE PROJECT AND DELINEATE THEIR ESTIMATED CRITICAL ROOT ZONE.

4. PLOT ACCURATE TRUNK LOCATIONS OF OFFSITE TREES WHICH WILL HAVE THEIR CRZ AFFECTED BY DEVELOPMENT AND DELINEATE THEIR ESTIMATED CRITICAL ROOT ZONE.

TREE PROTECTION DETAIL FOR DETERMINING CRITICAL ROOT ZONE 311300.3 (2019)

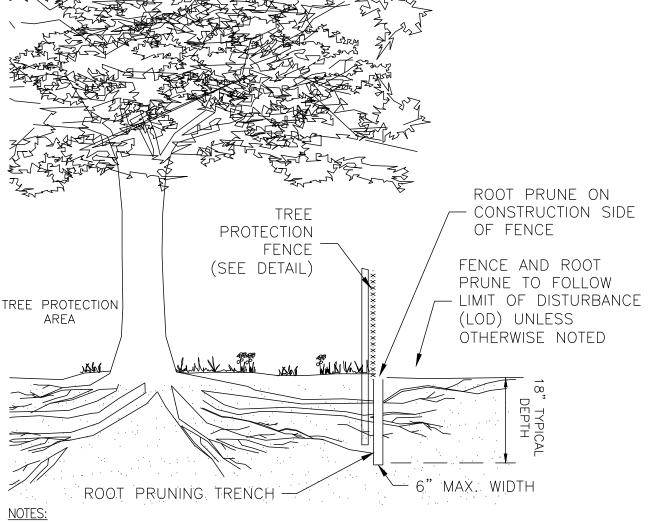

- 1. TREE PROTECTION AREA WILL BE DETERMINED AS PART OF THE PLAN REVIEW PROCESS. EXACT LOCATION, DEPTH AND METHODS OF ROOT PRUNING TO BE DETERMINED IN THE FIELD BY PROJECT
- 2. EXACT LOCATION OF TREE PROTECTION AREAS SHALL BE STAKED OR FLAGGED PRIOR TO TRENCHING. 3. TRENCH SHOULD BE BACKFILLED IMMEDIATELY OR INCORPORATED WITH SILT FENCE INSTALLATION. 4. ROOTS SHOULD BE SEVERED BY ROCK SAW, TRENCHER, VIBRATORY PLOW OR APPROVED EQUIVALENT.
- SPECIMEN TREES MAY REQUIRE SOIL REMOVAL BY SUPERSONIC AIR TOOL TO MINIMIZE TREE AND ROOT 6. COORDINATE WITH SILT FENCE INSTALLATION (IF REQUIRED) TO MINIMIZE ROOT IMPACTS FROM

5. ROOTS OVER 1.5" DIAMETER SHOULD BE CLEANLY CUT BY HAND. ROOT PRUNING ADJACENT TO

ADDITIONAL TRENCHING. ROOT PRUNING (TYPICAL



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Horizontal Datum: VCS NAD 83

Vertical Datum: Boundary and Topo Source: WALTER L. PHILLIPS

Design Approved ABNE Sheet #

WSSI Project Number: WSI.0001017



30' O.C.

(SEE ENLARGEMENT)

TENSION BAR

AT ENDS

1/2" = 1'-0"

ARLINGTON

30'-0" 3. PLOT ACCURATE TRUNK LOCATIONS OF ALL TREES

3. REMOVE TPF ONLY WITH APPROVAL FROM ARLINGTON COUNTY URBAN FORESTER AFTER ALL SITE WORK HAS BEEN **ELEVATION** 4. SIGN MATERIAL TO BE WEATHER RESISTANT. CHAIN LINK TREE PROTECTION FENCE 311300.1 (2016) (02231.1]