PLANTING NOTES:

- ALL QUANTITIES LISTED IN THE DRAWINGS ARE FOR INFORMATION ONLY. IT IS THE CONTRACTOR'S RESPONSIBILITY TO VERIFY ALL QUANTITIES AND TO PROVIDE ALL MATERIALS NECESSARY FOR FULL COVERAGE IN ALL PLANTING AREAS AS SPECIFIED ON THE DRAWINGS. ANY DISCREPANCY SHOULD BE
- 2. ALL PLANTS SHOULD BE IN ACCORDANCE WITH ANSI Z60.1 -2014, AMERICAN STANDARD FOR NURSERY STOCK PUBLICATION, APPROVED APRIL 14, 2014.
- 4. ALL PLANT MATERIAL SHALL CONFORM TO THE SIZE SPECIFICATIONS (CALIPER, HEIGHT AND SPREAD) GIVEN IN THE PLANT SCHEDULE AND SHALL BE
- NURSERY GROWN UNLESS SPECIFIED OTHERWISE. 5. ANY PLANT SUBSTITUTION SHALL BE APPROVED BY LANDDESIGN PRIOR TO PURCHASE.

3. CALIPER SIZE OF CANOPY TREES ARE TO BE MEASURED PER LOCAL CITY LANDSCAPE ORDINANCE.

- 6. SIZES LISTED ARE MIN. AND REFER TO HEIGHT, UNLESS OTHERWISE SPECIFIED.
- 7. LANDSCAPE CONTRACTOR SHALL STAKE OUT LOCATIONS OF ALL TREES TO BE PLANTED FOR REVIEW BY LANDDESIGN PRIOR TO INSTALLING. LANDDESIGN RESERVES THE RIGHT TO ADJUST TREE LOCATIONS IN THE FIELD AS NECESSARY.
- 8. SHRUB/GROUNDCOVER BEDS SHALL BE STAKED FOR REVIEW BY LANDDESIGN/OWNER'S REPRESENTATIVE PRIOR TO EXCAVATION AND OR BED PREPARATION.
- 9. LANDSCAPE CONTRACTOR SHALL INSTALL STEEL EDGING BETWEEN PLANTING BEDS AND LAWNS, OR AS SHOWN IN DETAILS.
- 10. LANDSCAPE CONTRACTOR SHALL BE RESPONSIBLE FOR VERIFYING THE LOCATION OF ALL UNDERGROUND UTILITIES. PIPES, STRUCTURES, AND LINE RUNS IN THE FIELD PRIOR TO THE INSTALLATION OF ANY PLANT MATERIAL.
- 11. IT IS THE RESPONSIBILITY OF THE CONTRACTOR TO ADVISE LANDDESIGN OF ANY CONDITION FOUND ON THE SITE WHICH PROHIBITS INSTALLATION AS
- SHOWN ON THE DRAWINGS.
- OPERATIONS. 13. ALL PLANT MATERIAL SHALL BE MAINTAINED IN A HEALTHY GROWING CONDITION AND MUST BE REPLACED WITH PLANT OF SAME VARIETY AND SIZE IF

12. LANDSCAPE CONTRACTOR IS RESPONSIBLE FOR ALL COORDINATION WITH OTHER CONTRACTORS ON SITE AS REQUIRED TO ACCOMPLISH ALL PLANTING

- DAMAGED, DESTROYED, DEAD AND /OR REMOVED.
- 14. LANDSCAPE CONTRACTOR SHALL BE RESPONSIBLE FOR FINE GRADING AND REMOVAL OF DEBRIS PRIOR TO PLANTING IN ALL AREAS
- 15. FINAL FINISHED GRADING SHALL BE REVIEWED BY LANDDESIGN. CONTRACTOR IS RESPONSIBLE FOR ANY ADDITIONAL TOPSOIL REQUIRED TO CREATE A SMOOTH CONDITION SUITABLE FOR PLANTING.
- 16. TREES OVERHANGING INTO THE PUBLIC R.O.W. SHALL HAVE A MINIMUM CLEAR TRUNK HEIGHT OF FOURTEEN(14) FEET OVER STREETS, DRIVE AISLES, ALLEYS AND FIRE LANES. TREES OVERHANGING PRIVATE STREETS, WALKS, AND /OR PARKING LOTS SHALL HAVE A MINIMUM CLEAR TRUNK HEIGHT OF SEVEN (7) FEET.
- 17. LANDSCAPE CONTRACTOR IS REQUIRED TO PERFORM A TREE PIT PERCOLATION TEST FOR EACH TREE PIT PRIOR TO INSTALLATION. IF TREE PIT DOES NOT DRAIN WITHIN A 24-HOUR PERIOD, THE CONTRACTOR WILL BE REQUIRED TO PROVIDE A GRAVEL SUMP, FILTER FABRIC AND STAND PIPE. ALL TREE PIT SUMPS SHALL BE INCLUDED IN IN THE CONTRACTOR'S BASE BID AS A UNIT PRICE AND PROVIDE AS A DEDUCT ALTERNATE PER TREE PIT SUMPS NOT
- 18. LANDSCAPE CONTRACTOR IS RESPONSIBLE TO REVIEW SITE ENVIRONMENTAL CONDITIONS PRIOR TO AND DURING INSTALLATION OF PLANT MATERIAL. ANY DISCREPANCIES OR CONCERNS BETWEEN THE ENVIRONMENTAL SITE CONDITIONS (I.E., SOIL TYPE, WATER, CLIMATE, WIND, SUN EXPOSURE ETC.) AND THE PLANT MATERIAL SPECIFIED WITHIN THE DRAWING SHALL BE BROUGHT TO THE ATTENTION OF LANDDESIGN AND/OR OWNER, AND SHALL BE DONE SO IN WRITING. CONTRACTOR SHALL PROVIDE SUGGESTED SOLUTIONS FOR ALTERNATIVE PLANT MATERIAL PROPOSED FOR SUBSTITUTION. LANDDESIGN TO REVIEW CONDITIONS AND INFORMATION SUBMITTED BY CONTRACTOR AND WILL ISSUE DIRECTIVE. SHOULD PLANT MATERIAL DIE BECAUSE OF ENVIRONMENTAL CONDITIONS DESCRIBED ABOVE, THE LANDSCAPE CONTRACTOR ASSUMES ALL WARRANTY AND GUARANTEE OF THE PLANT MATERIAL
- 19. ALL NEW PLANTING AREAS SHALL BE BACKFILLED WITH PLANTING SOIL THAT IS A MIXTURE OF 40-50% IMPORTED UNSCREENED TOPSOIL, 40-45% COARSE SAND, AND 10% COMPOST. FINAL TESTED ORGANIC MATTER SHALL BE BETWEEN 2.75 AND 4% (BY DRY WEIGHT). BACKFILL SHALL BE TO A DEPTH OF 18" FOR SHRUB AND GROUNDCOVER ZONES AND 36" FOR TREE PITS.
- 20. AFTER PLANTING SOIL MIXES ARE INSTALLED IN PLANTING BED AREAS AND JUST PRIOR TO THE INSTALLATION OF SHRUB OR GROUNDCOVER PLANTINGS, SPREAD 3-4 INCHES OF COMPOST OVER THE BEDS AND ROTO TILL INTO THE TOP 8 INCHES OF THE PLANTING SOIL. THIS WILL RAISE GRADES SLIGHTLY ABOVE THE FINISHED GRADES, IN ANTICIPATION GRADES WILL SETTLE WITHIN A FEW MONTHS AFTER INSTALLATION AS COMPOST BREAKS DOWN.
- 21. IN ALL EXISTING PLANTING AREAS DESIGNATED TO RECEIVE NEW PLANTINGS, SPREAD 3-4 INCHES OF COMPOST OVER THE BEDS AND ROTO TILL INTO THE TOP 8 INCHES OF THE PLANTING SOIL. THIS WILL RAISE THE GRADES SLIGHTLY ABOVE THE FINISHED GRADES, IN ANTICIPATION GRADES WILL SETTLE WITHIN A FEW MONTHS AFTER INSTALLATION AS COMPOST BREAKS DOWN. IN NO CASE WILL THIS BE PERFORMED WHERE IT MAY NEGATIVELY IMPACT THE HEALTH OF ADJACENT, EXISTING PLANT MATERIALS WHICH ARE DESIGNATED TO REMAIN.
- 22. LANDSCAPE CONTRACTOR TO WARRANTY ALL PLANT MATERIALS FOR A PERIOD OF ONE YEAR. THE CONTRACTOR AGREES TO REPLACE DEFECTIVE WORK AND DEFECTIVE PLANTS, AND THAT THE OWNER'S REPRESENTATIVE SHALL MAKE THE FINAL DETERMINATION IF PLANTS MEET THE REQUIRED SPECIFICATIONS OR THAT PLANTS ARE DEFECTIVE. PLANTS DETERMINED TO BE DEFECTIVE SHALL BE REMOVED IMMEDIATELY UPON NOTIFICATION BY THE OWNER'S REPRESENTATIVE AND REPLACED WITHOUT COST TO THE OWNER, AS SOON AS WEATHER CONDITIONS PERMIT AND WITHIN THE SPECIFIED PLANTING PERIOD. THE REPLACED MATERIALS SHALL ALSO RECEIVE A WARRANTY PERIOD OF ONE YEAR WHICH STARTS AT THE DATE OF INSTALLATION. BULBS, ANNUAL FLOWERS, AND SEASONAL COLOR PLANTS SHALL ONLY BE WARRANTED FOR THE PERIOD OF THE EXPECTED BLOOM OR PRIMARY DISPLAY.

PLANTERS/POTS/SEASONAL PLANTING NOTES:

- 1. SOIL SHOULD BE NUTRIENT-RICH, MOISTURE CONTAINING PLANTING MEDIUM AND BE A MINIMUM 18" DEPTH FOR SEASONALS, PERENNIALS AND SMALL SHRUBS; MINIMUM 36" DEPTH FOR ALL TREES.
- A LAYER OF RIVER ROCK SHALL BE PLACED IN THE BASE OF EACH PLANTER POT TO A MINIMUM 6" DEPTH OR AS ALLOWABLE BY REQUIRED SOIL DEPTH. PLACE FILTER FABRIC BETWEEN SOIL MEDIUM AND RIVER ROCK AND SOIL MEDIUM AND PLANTER EDGES, OVERLAP FABRIC 6" MINIMUM TO MINIMIZE SOIL
- PLANTERS POTS WHICH DO NOT RECEIVE IRRIGATION SHALL BE HAND-WATERED. HAND WATERING SHOULD OCCUR MINIMUM 2 TIMES PER WEEK DURING COOLER AND RAINY SEASONS AND INCREASED TO EVERY 2-3 DAYS DURING HOT/DRY WEATHER. ALWAYS CHECK SOIL 6" BELOW SURFACE FOR SATURATION PRIOR TO WATERING TO PREVENT OVERWATERING/DROWNING OF PLANT MATERIAL.
- 4. WHEN APPLICABLE, PLANTS TO REMAIN IN CONTAINERS FOR DURATION OF SEASON ARE SHOWN IN THE "PERMANENT" LAYOUT, EACH SEASON WILL HAVE ITS OWN PLANT MATERIAL, SOME OF WHICH MAY LAST ALL YEAR, ROTATE IN THE PLANTS NOTED FOR EACH SEASON.
- 5. IF PLANT MATERIAL DIES DURING A SEASON AND IS EXPECTED TO REMAIN FOR AN ADDITIONAL SEASON, CONTRACTOR IS TO REPLACE AT TIME OF NEXT SEASONAL ROTATION.
- 6. CONTACT LANDDESIGN FOR ANY REQUIRED SUBSTITUTIONS.
- 7. ALL PLANTS SHOULD BE FULL AT TIME OF INSTALLATION AND COVER 75% OF POT SURFACE AREA.
- 8. AVOID PLANTING IN THE ROOT ZONE OF ANY PERMANENT TREES, SHRUBS, OR PERENNIALS.
- 9. SEASONAL PLANTS SHOULD BE REMOVED FOLLOWING THE FIRST MAJOR FROST DIEBACK AND REPLACED WITH EVERGREEN BOUGHS OR OTHER OWNER APPROVED WINTER DECOR. TREES, SHRUBS AND PERENNIALS SHOULD REMAIN IN THE CONTAINERS YEAR ROUND AND REPLACED ONLY AS NECESSARY.

IRRIGATION NOTES:

- 1. A FULLY AUTOMATED IRRIGATION SYSTEM PROVIDING 100% COVERAGE SHALL BE PROVIDED FOR ALL PLANTING AREAS, UNLESS NOTED OTHERWISE. SYSTEM SHALL BE IN OPERATION PRIOR TO INSTALLATION OF ANY PLANT MATERIAL OTHER THAN CANOPY TREES.
- 2. ALL PLANTING BEDS/ SHRUB AND GROUNDCOVER AREAS TO BE IRRIGATED WITH EITHER 12" SPRAY POP-UPS AND/OR A LANDSCAPE DRIP-LINE SYSTEM, UNLESS NOTED OTHERWISE.
- 3. ALL PLANTER POTS AND RAISED PLANTERS TO BE IRRIGATED WITH MICRO SPRAY SPRINKLER HEADS.
- 4. IRRIGATION SYSTEM IS DESIGN/BUILD. CONTRACTOR TO PROVIDE DRAWINGS AND CUT SHEETS OF ALL COMPONENTS
- 5. PROVIDE AS-BUILT DRAWINGS OF IRRIGATION AFTER INSTALLATION

MATERIALS + PAVING NOTES:

- 1. ALL MATERIALS, CONSTRUCTION METHODS, WORKMANSHIP, EQUIPMENT SERVICES AND TESTING FOR ALL IMPROVEMENTS SHALL BE IN ACCORDANCE WITH THE PROJECT DOCUMENTS AND THE GOVERNING AUTHORITIES' REQUIREMENTS. IN THE EVENT OF A CONFLICT BETWEEN THE PROJECT DOCUMENTS AND THE GOVERNING AUTHORITIES' REQUIREMENTS, THE MORE STRINGENT SHALL APPLY.
- 2. SUBGRADE PREPARATION, PAVEMENT STRENGTH AND THICKNESS SHALL BE IN ACCORDANCE WITH THE GEOTECHNICAL REPORT PREPARED FOR THIS
- 2.1. PROOF-ROLL SUBGRADE: PRIOR TO PREPARATION OF THE SUBBASE, THE SUBGRADE SHALL BE PROOF-ROLLED WITH HEAVY PNEUMATIC EQUIPMENT. ANY SOFT OR PUMPING AREAS SHALL BE EXCAVATED TO FIRM SUBGRADE AND BACKFILLED AND COMPACTED IN ACCORDANCE WITH THE GEOTECHNICAL REPORT
- 2.2. PAVEMENT SUBGRADE SHALL BE GRADED TO PREVENT PONDING AND INFILTRATION OF EXCESSIVE MOISTURE ON OR ADJACENT TO THE PAVEMENT SUBGRADE.
- THE USE OF "LEVEL UP" SAND UNDER PAVEMENT WILL NOT BE ACCEPTED, UNLESS NOTED OTHERWISE.
- 4. CONCRETE SHALL NOT BE PLACED WHEN THE TEMPERATURE IS BELOW 40 DEGREES FAHRENHEIT AND FALLING, BUT MAY BE PLACED WHEN THE TEMPERATURE IS ABOVE 35 DEGREES FAHRENHEIT AND RISING. THE TEMPERATURE READING SHALL BE TAKEN IN THE SHADE AWAY FROM ARTIFICIAL
- 4.1. DO NOT PLACE CONCRETE WHILE IT IS RAINING OR WHEN RAIN IS IMMINENT.
- 5. CAST IN PLACE CONCRETE SHALL MEET THE FOLLOWING REQUIREMENTS:
- 5.1. MINIMUM 3,000 PSI COMPRESSIVE STRENGTH AT 28 DAYS, UNLESS NOTED OTHERWISE
- 5.2. AGGREGATES: ASTM C33 MAX 3/4" IN SIZE, UNLESS NOTED OTHERWISE
- 5.3. SLUMP: 3 TO 5 INCHES
- 5.4. AIR CONTENT: 4 TO 6 PERCENT BY VOLUME
- 6.1. PEDESTRIAN AREA: 4" THICK, UNLESS NOTED OTHERWISE.
- 6.2. ALL OTHER CONCRETE COMPONENTS INSTALL PER SIZE SPECIFIED IN DRAWINGS
- 7. CONCRETE REINFORCING:

CONCRETE THICKNESS:

- 7.1. 4" THICK PAVING: #3's AT 24" SPACING UNLESS NOTED OTHERWISE IN DRAWINGS
- 7.2. 6" THICK PAVING: #4s AT 24" SPACING UNLESS NOTED OTHERWISE IN DRAWINGS 7.3. 8" THICK PAVING: #5's AT 24" SPACING UNLESS NOTED OTHERWISE IN DRAWINGS
- 7.4. ALL PAVEMENT REINFORCING BARS SHALL BE GRADE 60 KSI DEFORMED BILLET STEEL BARS, UNCOATED FINISH. SIZE AND SPACING SHALL BE IN ACCORDANCE WITH THE PAVING PLAN AND DETAILS.
- 7.5. ALL REINFORCING STEEL AND DOWEL BARS IN PAVEMENT SHALL BE SUPPORTED AND MAINTAINED AT THE CORRECT CLEARANCES BY THE USE OF
- 8. CONTROL JOINTS (TROWEL OR SAW CUT)
- 8.1. TO BE PLACED AS INDICATED ON PLANS AND DETAILS TO A MINIMUM DEPTH OF 1/8 OF CONCRETE THICKNESS.
- 8.2. SAW CUT JOINTS TO BE EXECUTED WITHIN 12 HOURS OF CONCRETE PLACEMENT.
- 8.3. SAWN JOINTS ARE TO BE TRUE IN ALIGNMENT AND SHALL CONTINUE THROUGH ADJACENT CURBS. RADIAL JOINTS SHALL BE NO SHORTER THAN 18". 8.4. SAWN JOINTS TO BE CLEANED OF DEBRIS, DIRT, DUST, SCALE, CURING COMPOUND AND CONCRETE, BLOWN DRY AND IMMEDIATELY SEALED. SEALANT MATERIAL SHALL BE SONNEBORN SONOLASTIC SL2 MULTI-COMPONENT, SELF-LEVELING, ELASTOMERIC POLYURETHANE OR EQUIVALENT.
- 9. EXPANSION JOINTS
- 9.1. PLACE AT A MAXIMUM SPACING OF 30' O.C. AND COORDINATE WITH OVERALL PAVING PATTERN AND COLOR.
- 9.2. PROVIDE DOWELS AS SPECIFIED IN DRAWING DETAILS.

SEALANT COLOR SHALL MATCH PAVEMENT.

- 9.3. CONTRACTOR SHALL PREPARE A JOINT LAYOUT AND PROVIDE IT TO THE ENGINEER FOR REVIEW. THE JOINT LAYOUT SHALL BE PROVIDED A MINIMUM OF ONE WEEK PRIOR TO PLACING CONCRETE. PATTERN SHALL BE CAREFULLY DESIGNED BY THE CONTRACTOR TO AVOID IRREGULAR SHAPES. EXPANSION JOINTS SHALL NOT BE LOCATED ALONG VALLEYS IN PAVEMENT.
- 10. ALL CONSTRUCTION JOINTS SHALL BE SAWN, CONCRETE FINISHES TO BE PER DRAWING DETAILS AND SPECIFICATIONS.
- 11. CONCRETE SHALL BE BROOM FINISHED AND CURED FOR A MINIMUM OF 72 HOURS UNLESS NOTED OTHERWISE
- 12. BREAKOUTS FOR REMOVAL OF EXISTING PAVEMENT AND CURBS SHALL BE MADE BY FULL DEPTH SAW CUT WHEN ADJACENT TO PROPOSED PAVEMENT
- AND/OR CURBS.
- 13. PROPOSED PAVEMENT AND/OR CURBS INTENDED TO TIE INTO EXISTING SHALL MATCH SHALL MATCH THE ELEVATION OF EXISTING PAVEMENT AND/OR

14. PAVEMENT MARKINGS

- 14.1. PAVEMENT MARKINGS SHALL BE PROVIDED IN ACCORDANCE WITH THE ARLINGTON COUNTY "UNIFORM TRAFFIC MANUAL FOR PAVEMENT MARKINGS.'
- 14.2. FIRE LANES SHALL BE STRIPED AND/OR SIGNED IN ACCORDANCE WITH THE GOVERNING AUTHORITIES' REGULATIONS.
- 14.3. ALL ACCESSIBLE PAVEMENT MARKINGS SHALL COMPLY WITH ADAAG STANDARDS AND STATE AND LOCAL CODES. 14.4. PARKING SPACE STRIPES, ACCESSIBLE SPACES, PEDESTRIAN STRIPING, DIRECTIONAL ARROWS AND LETTERING SHALL BE SOLID WHITE, UNLESS A SPECIFIC COLOR IS REQUIRED BY LOCAL CODE. TWO (2) COATS OF VOC COMPLIANT, LOCAL DOT APPROVED, UNDILUTED, SOLVENT BASED OR LATEX TRAFFIC PAINT SHALL BE APPLIED. USE MANUFACTURER'S RECOMMENDED APPLICATION RATE, WITHOUT ADDITION OF A THINNER, WITH A

THICKNESS PER COAT WITH A MINIMUM OF 30 DAYS BETWEEN APPLICATIONS. PAINT SHALL BE CRISP, STRAIGHT AND APPLIED UNIFORMLY ACROSS

- THE WIDTH OF THE LINE FOR A MINIMUM TOTAL DRY FILM THICKNESS OF 15 MILS. 15. CONTRACTOR SHALL REFER TO THE SITE CIVIL, MEP AND IRRIGATION PLANS FOR CONDUIT TO BE INSTALLED UNDER PAVEMENT PRIOR TO
- COMMENCING PAVEMENT SUBGRADE PREPARATION. 16. ALL TESTING SHALL BE PERFORMED BY A QUALIFIED TESTING LABORATORY, EMPLOYED AND PAID DIRECTLY BY THE OWNER. TESTING SHALL BE PERFORMED. AT A MINIMUM. IN ACCORDANCE WITH THE RECOMMENDATIONS IN THE GEOTECHNICAL REPORT. IN THE EVENT THE RESULTS OF THE INITIAL TESTING DO NOT COMPLY WITH THE PLANS AND THE SPECIFICATIONS, SUBSEQUENT TEST NECESSARY TO DETERMINE THE ACCEPTABILITY OF CONSTRUCTION SHALL BE AT THE CONTRACTOR'S EXPENSE. PAVEMENT FOUND TO BE DEFICIENT IN STRENGTH OR THICKNESS SHALL BE REMOVED

ACCESSIBILITY NOTES:

- 1. MAX CROSS SLOPE ON PAVED SURFACES SHALL BE 2% MAXIMUM, UNLESS NOTED OTHERWISE
- 2. MAX RUNNING SLOPE ON PAVED SURFACES SHALL BE 5% MAXIMUM, UNLESS NOTED OTHERWISE.
- 3. ACCESSIBLE PATH OF TRAVEL SHALL BE MAINTAINED FREE OF OVERHANGING OBSTRUCTIONS TO 80" MINIMUM, AND PROTRUDING OBJECTS GREATER THAN 4" PROJECTION FROM WALL AND ABOVE 27" AND LESS THAN 80". CONTRACTOR SHALL VERIFY THAT THERE ARE NO BARRIERS IN THE PATH OF
- 4. ALL CURB RAMPS SHALL BE BROOM FINISHED PERPENDICULAR TO SLOPE.

AND REPLACED SOLELY AT THE EXPENSE OF THE CONTRACTOR.

- 5. ALL CURB RAMPS SHALL HAVE A 1:12 MAX SLOPE IN THE DIRECTION OF TRAVEL, 2% MAX CROSS SLOPE.
- 6. IT IS THE INTENT OF THE CONTRACT DOCUMENTS TO COMPLY WITH ALL APPROPRIATE FAIR HOUSING ACCESSIBILITY GUIDELINES AND GENERAL NOTES FOR PUBLIC AND COMMON USE FACILITIES. REPORT ANY DISCREPANCIES TO LANDDESIGN.

GENERAL NOTES:

- BASE INFORMATION, INCLUDING EXISTING CONDITIONS, TOPOGRAPHY, EXISTING UTILITIES, AND BOUNDARY INFORMATION IS FROM PLANS BY: WALTER
- ARCHITECTURAL INFORMATION IS FROM PLANS BY: RUST ORLING ARCHITECTURE.
- 3. WRITTEN DIMENSIONS PREVAIL OVER SCALED DIMENSIONS. NOTIFY LANDDESIGN OF ANY DISCREPANCIES.
- 4. DIMENSIONS ARE TO FACE OF OBJECT, UNLESS NOTED OTHERWISE.
- 5. THE CONTRACTOR IS RESPONSIBLE FOR VERIFYING ALL UNDERGROUND UTILITIES, PIPES, STRUCTURES, AND LINE RUNS IN THE FIELD PRIOR TO CONSTRUCTION. ANY DAMAGE TO NEW AND EXISTING UTILITIES ARE TO BE REPAIRED IMMEDIATELY AT NO ADDITIONAL EXPENSE TO THE OWNER. LANDDESIGN ASSUMES NO RESPONSIBILITY FOR ANY UTILITIES NOT SHOWN ON PLANS.
- 6. ALL PROPOSED FINISHED GRADES ARE BASED ON INFORMATION PROVIDED BY THE OWNER'S SURVEY AND OR CIVIL ENGINEER. ANY DISCREPANCIES IN ACTUAL FIELD MEASUREMENTS ARE TO BE REPORTED TO LANDDESIGN IMMEDIATELY.
- PRIOR TO COMMENCEMENT OF HARDSCAPE CONSTRUCTION, ALL PIERS, FOOTINGS, AND WALLS ARE TO BE SURVEYED, LAID OUT, AND STAKED IN THE FIELD FOR REVIEW BY LANDDESIGN. CONTRACTOR SHALL ASSUME ALL RESPONSIBILITY FOR ANY DEMOLITION, ADJUSTMENTS, OR RECONSTRUCTION OF HARDSCAPE CONSTRUCTION RESULTING FROM UNAUTHORIZED CONSTRUCTION.
- 8. CONTRACTOR IS RESPONSIBLE TO PROVIDE AND INSTALL ALL ITEMS PER DRAWINGS AND SPECIFICATION. NOTIFY LANDDESIGN OF ANY MAJOR DISCREPANCIES BETWEEN CONTRACTOR'S VERIFIED QUANTITIES, BID BOOK, AND INTENT OF DRAWING.
- 9. CONTRACTOR IS RESPONSIBLE FOR ALL FINAL QUANTITIES PER DRAWINGS AND SPECIFICATIONS ANY QUANTITIES PROVIDE BY LANDDESIGN ARE PROVIDED FOR CONVENIENCE ONLY AND SHALL NOT BE CONSIDERED ABSOLUTE. LANDDESIGN SHOULD BE NOTIFIED OF ANY GRADING DISCREPANCIES.
- 10. THE CONTRACTOR SHALL EXAMINE AND BECOME FAMILIAR WITH ALL CONTRACT DOCUMENTS IN THEIR ENTIRETY. SURVEY THE PROJECT AND BECOME FAMILIAR WITH THE EXISTING CONDITIONS AND SCOPE OF WORK. ALL COSTS SUBMITTED SHALL BE BASED ON THOROUGH KNOWLEDGE OF ALL WORK AND MATERIALS REQUIRED ANY DISCREPANCY AND/ OR UNCERTAINTY AS TO WHAT MATERIAL OR PRODUCT IS TO BE USED, SHALL BE VERIFIED WITH THE
- 11. THE CONTRACTOR SHALL BE SOLELY RESPONSIBLE FOR CONSTRUCTION MEANS, METHODS, TECHNIQUES, SEQUENCES AND PROCEDURES REQUIRED FOR SAFE EXECUTION AND COMPLETION OF WORK, AND FOR INITIATING, MAINTAINING AND SUPERVISING ALL SAFETY PRECAUTIONS AND PROGRAMS IN CONNECTION WITH THE WORK.
- 12. IN THE EVENT A DISCREPANCY IS FOUND IN THE CONTRACT DOCUMENTS, THE OWNER & LANDDESIGN SHALL BE NOTIFIED IMMEDIATELY.

14. CONTRACTOR SHALL VERIFY ALL MEASUREMENTS AT THIS SITE AND AND BE RESPONSIBLE FOR ACCURACY AND CORRECTNESS OF SAME.

- 13. CONTRACTOR SHALL VERIFY ALL DIMENSIONS IN THE FIELD AND NOTIFY LANDDESIGN OF ANY DISCREPANCIES PRIOR TO CONSTRUCTION.
- 15. CONTRACTOR SHALL COORDINATE WORK WITH ALL OTHER TRADES AND NOTIFY OWNER & LANDDESIGN OF ANY DISCREPANCIES PRIOR TO CONSTRUCTION. 16. THE CONTRACTOR SHALL EMPLOY, AS REQUIRED BY GOVERNING AUTHORITIES, AN APPROVED TESTING LABORATORY TO MAKE ALL TESTS FROM
- 17. ALL EXISTING WORK OR LANDSCAPING NOT SHOWN TO BE ALTERED OR REMOVED SHALL BE PROTECTED FROM DAMAGE DURING CONSTRUCTION. THE CONTRACTOR(S) SHALL BEAR THE TOTAL EXPENSE FOR, AND SHALL REPAIR ANY DAMAGE TO EXISTING CONDITIONS, OR IMPROVEMENTS NOT INDICATED IN THE DRAWINGS OR SPECIFICATIONS TO RECEIVE ALTERATION, ADDITIONS OR REMOVAL.

CONCRETE, SOIL COMPACTION AND WELDING TO INSURE COMPLIANCE WITH PLANS, STANDARDS AND CODES. COST SHALL BE INCLUDED AS INCIDENTAL TO

LAYOUT NOTES:

- I. ALL MATERIALS AND CONSTRUCTION WITHIN RIGHT OF WAYS SHALL BE IN ACCORDANCE WITH THE ARLINGTON COUNTY STANDARD SPECIFICATIONS AND CONSTRUCTION STANDARDS, AND STANDARD SPECIFICATIONS FOR PUBLIC WORKS CONSTRUCTION PREPARED BY THE ARLINGTON COUNTY (LATEST
- EXISTING UTILITIES ARE SHOWN SCHEMATICALLY AND ARE FOR THE CONTRACTOR'S GUIDANCE ONLY. THE LOCATION AND/OR ELEVATION OF EXISTING UTILITIES AS SHOWN ON THESE PLANS ARE BASED ON RECORDS OF THE VARIOUS UTILITY COMPANIES, AND, WHERE POSSIBLE, MEASUREMENTS TAKEN IN THE FIELD. THE CONTRACTOR MUST CALL THE APPROPRIATE UTILITY COMPANY AT LEAST 48 HOURS PRIOR TO ANY EXCAVATION TO REQUEST EXACT FIELD LOCATION OF UTILITIES.
- 3. CONTRACTOR SHALL BE RESPONSIBLE FOR PROTECTING ALL EXISTING IMPROVEMENTS IN THE CONSTRUCTION OF THIS PROJECT. THE CONTRACTOR IS RESPONSIBLE FOR REPAIRS OF DAMAGE TO ANY EXISTING IMPROVEMENTS DURING CONSTRUCTION. REPAIRS SHALL BE EQUAL TO OR BETTER THAN CONDITION PRIOR TO CONSTRUCTION.
- 4. ALL ONSITE PAVING DIMENSIONS ARE TO THE FACE OF CURB, WHERE APPLICABLE, UNLESS NOTED OTHERWISE.
- 5. ALL CURB RADII AND SIDEWALK RETURNS ARE 2' UNLESS NOTED OTHERWISE
- 6. ALL PAVING AND EARTHWORK OPERATIONS SHALL CONFORM TO THE PROJECT GEOTECHNICAL REPORT.
- 7. BOUNDARY SURVEY: BOUNDARY SURVEY INFORMATION IS BASED ON THE BOUNDARY SURVEY PREPARED BY WALTER L PHILLIPS. REFER TO THE BOUNDARY SURVEY AND PLAT TO VERIFY PROPERTY LINES AND EASEMENT LOCATIONS.
- 8. BUILDING DIMENSIONS: THE CONTRACTOR SHALL REFER TO THE ARCHITECTURAL PLANS TO VERIFY THE EXACT BUILDING DIMENSIONS.
- PLACEMENT OF LAID PAVERS WITH RUBBER HAMMERS AS REQUIRED. 10. PROVIDE JOINTS BETWEEN PAVERS BETWEEN 1/16 IN. AND 3/16 IN. (2 AND 5 MM) WIDE. NO MORE THAN 5% OF THE JOINTS SHALL EXCEED 1/4" WIDE TO

9. LAY PAVERS IN PATTERN(S) SHOWN ON DRAWINGS. PLACE UNITS HAND TIGHT WITHOUT USING HAMMERS. MAKE HORIZONTAL ADJUSTMENTS TO

- ACHIEVE STRAIGHT BOND LINES. 11. JOINT (BOND) LINES SHALL NOT DEVIATE MORE THAN ±1/2 IN. (±15 MM) OVER 50 FT. (15 M) FROM STRING LINES.
- 12. FILL GAPS AT THE EDGES OF THE PAVED AREA WITH CUT PAVERS OR EDGE UNITS.
- 13. CUT PAVERS TO BE PLACED ALONG THE EDGE WITH A MASONRY SAW. 14. ADJUST BOND PATTERN AT PAVEMENT EDGES SUCH THAT CUTTING OF EDGE PAVERS IS MINIMIZED.
- 15. IN NO CASE SHALL A CUT PAVER BE LESS THAN 1/3 FULL PAVER SIZE. 16. PAVER DIMENSIONS ARE NOMINAL. PRIOR TO POURING SLABS, BANDING, OR OTHERWISE SETTING PAVER FIELDS, VERIFY ACTUAL PAVER SIZES AND LAYOUT OF THE PAVER FIELDS. MAKE MINOR ADJUSTMENTS TO EDGE CONSTRAINTS AS REQUIRED TO ACCOMMODATE ACTUAL PAVER SIZES. NOTIFY LANDDESIGN IMMEDIATELY OF DISCREPANCIES AND/OR ADJUSTMENTS

GRADING NOTES:

- 1. STAKE PER SPOT ELEVATIONS AND NOTED SLOPES. CONTOURS ARE PROVIDED FOR MASS GRADING/INTENT ONLY.
- 2. WRITTEN DIMENSIONS AND GRADES PREVAIL OVER SCALED DIMENSIONS. NOTIFY LANDDESIGN OF ANY DISCREPANCIES.
- 3. ALL SPOT ELEVATIONS SHOWN ON GRADING PLAN ARE TO BOTTOM OF CURB/TOP OF PAVEMENT UNLESS OTHERWISE NOTED. ALL RIM ELEVATIONS ARE TO 4. REFER TO GEOTECHNICAL ENGINEER AND GEOTECH REPORT FOR INFORMATION ON SUBSURFACE MATERIALS, TOPSOIL, STRUCTURAL MATERIAL, DEEP
- FILLS, EXCAVATION, AND FOUNDATIONS.
- 5. APPROVAL OF THIS PLAN IS NOT AN AUTHORIZATION TO GRADE ADJACENT PROPERTIES. WHEN FIELD CONDITIONS WARRANT OFF-SITE GRADING, PERMISSION MUST BE OBTAINED FROM THE AFFECTED PROPERTY OWNERS.
- 6. IN ORDER TO ASSURE PROPER DRAINAGE, KEEP A MINIMUM OF .5% SLOPE ON THE CURB.
- 7. ALL PLANTING ISLANDS SHALL BE GRADED TO MOUND TO PROVIDE POSITIVE DRAINAGE. 8. CONTRACTOR TO VERIFY 2% MAX. CROSS-SLOPE ON ALL SIDEWALKS.
- 9. CONTRACTOR TO VERIFY THAT ALL SIDEWALK SLOPES, HANDICAP RAMPS, AND HANDICAP PARKING SPACES MEET ADA REQUIREMENTS.
- 10. CONCRETE SIDEWALKS ADJACENT TO TREE SAVE LOCATIONS SHOULD BE POURED ON TOP OF EXISTING GRADE.
- 11. REFER TO LANDSCAPE PLAN FOR ALL TREE PROTECTION FENCE LOCATIONS AND INSTALLATION PROCEDURES. BEFORE GRADING/CONSTRUCTION BEGINS, CALL FOR INSPECTION OF TREE PROTECTION BARRICADES. NO SOIL DISTURBANCE OR COMPACTION, CONSTRUCTION MATERIALS, TRAFFIC, BURIAL PITS, TRENCHING, OR OTHER LAND DISTURBING ACTIVITY ALLOWED IN THE TREE PROTECTION ZONE.
- 12. DIMENSIONS ON BUILDINGS ARE FOR GRADING PURPOSES ONLY AND ARE NOT TO BE USED TO LAYOUT FOOTINGS.
- 13. GRADING CONTRACTORS SHALL NOTIFY AND COOPERATE WITH ALL UTILITY COMPANIES OR FIRMS HAVING FACILITIES ON OR ADJACENT TO THE SITE BEFORE DISTURBING, ALTERING, REMOVING, RELOCATING, ADJUSTING OR CONNECTING TO SAID FACILITIES. CONTRACTORS SHALL PAY ALL COSTS IN CONNECTION WITH THE ALTERATION OF OR RELOCATION OF THE FACILITIES. CONTRACTORS SHALL RAISE OR LOWER TOPS OF EXISTING MANHOLES AS REQUIRED TO MATCH FINISHED GRADES.
- 14. GRADING CONTRACTOR SHALL COOPERATE AND WORK WITH ALL OTHER CONTRACTORS PERFORMING WORK ON THIS PROJECT TO INSURE PROPER AND TIMELY COMPLETION OF THIS PROJECT.

703.549.7784 WWW.LANDDESIGN.COM

09/12/2023

SUNRISE LIVING

SUNRISE SENIOR LIVING

716 SOUTH GLEBE ROAD

ARLINGTON, VA 22204

2022139


REVISION / ISSUANCE DESCRIPTION 4.1 SITE PLAN 1ST 09/09/2022 PRELIMINARY SUBMISSION 4.1 SITE PLAN 2ND 12/02/2022 PRELIMINARY SUBMISSION 4.1 SITE PLAN 3RD 04/10/2023 PRELIMINARY SUBMISSION 4.1 SITE PLAN 4TH

06/01/2023 PRELIMINARY SUBMISSION 4.1 SITE PLAN PUBLIC 08/11/2023 HEARING SUBMISSION REVISED PUBLIC HEARING 09/12/2023 SUBMISSION

> DESIGNED BY: JM DRAWN BY: JM CHECKED BY: AC

VERT: N/A HORZ: N/A

ORIGINAL SHEET SIZE: 24" X 36" 9/11/2023 12:31:20 PM DAPHNE BRICE Z:\TEMPLATES\SHEETS\CD SHEETS\NOTES-24X36.DW

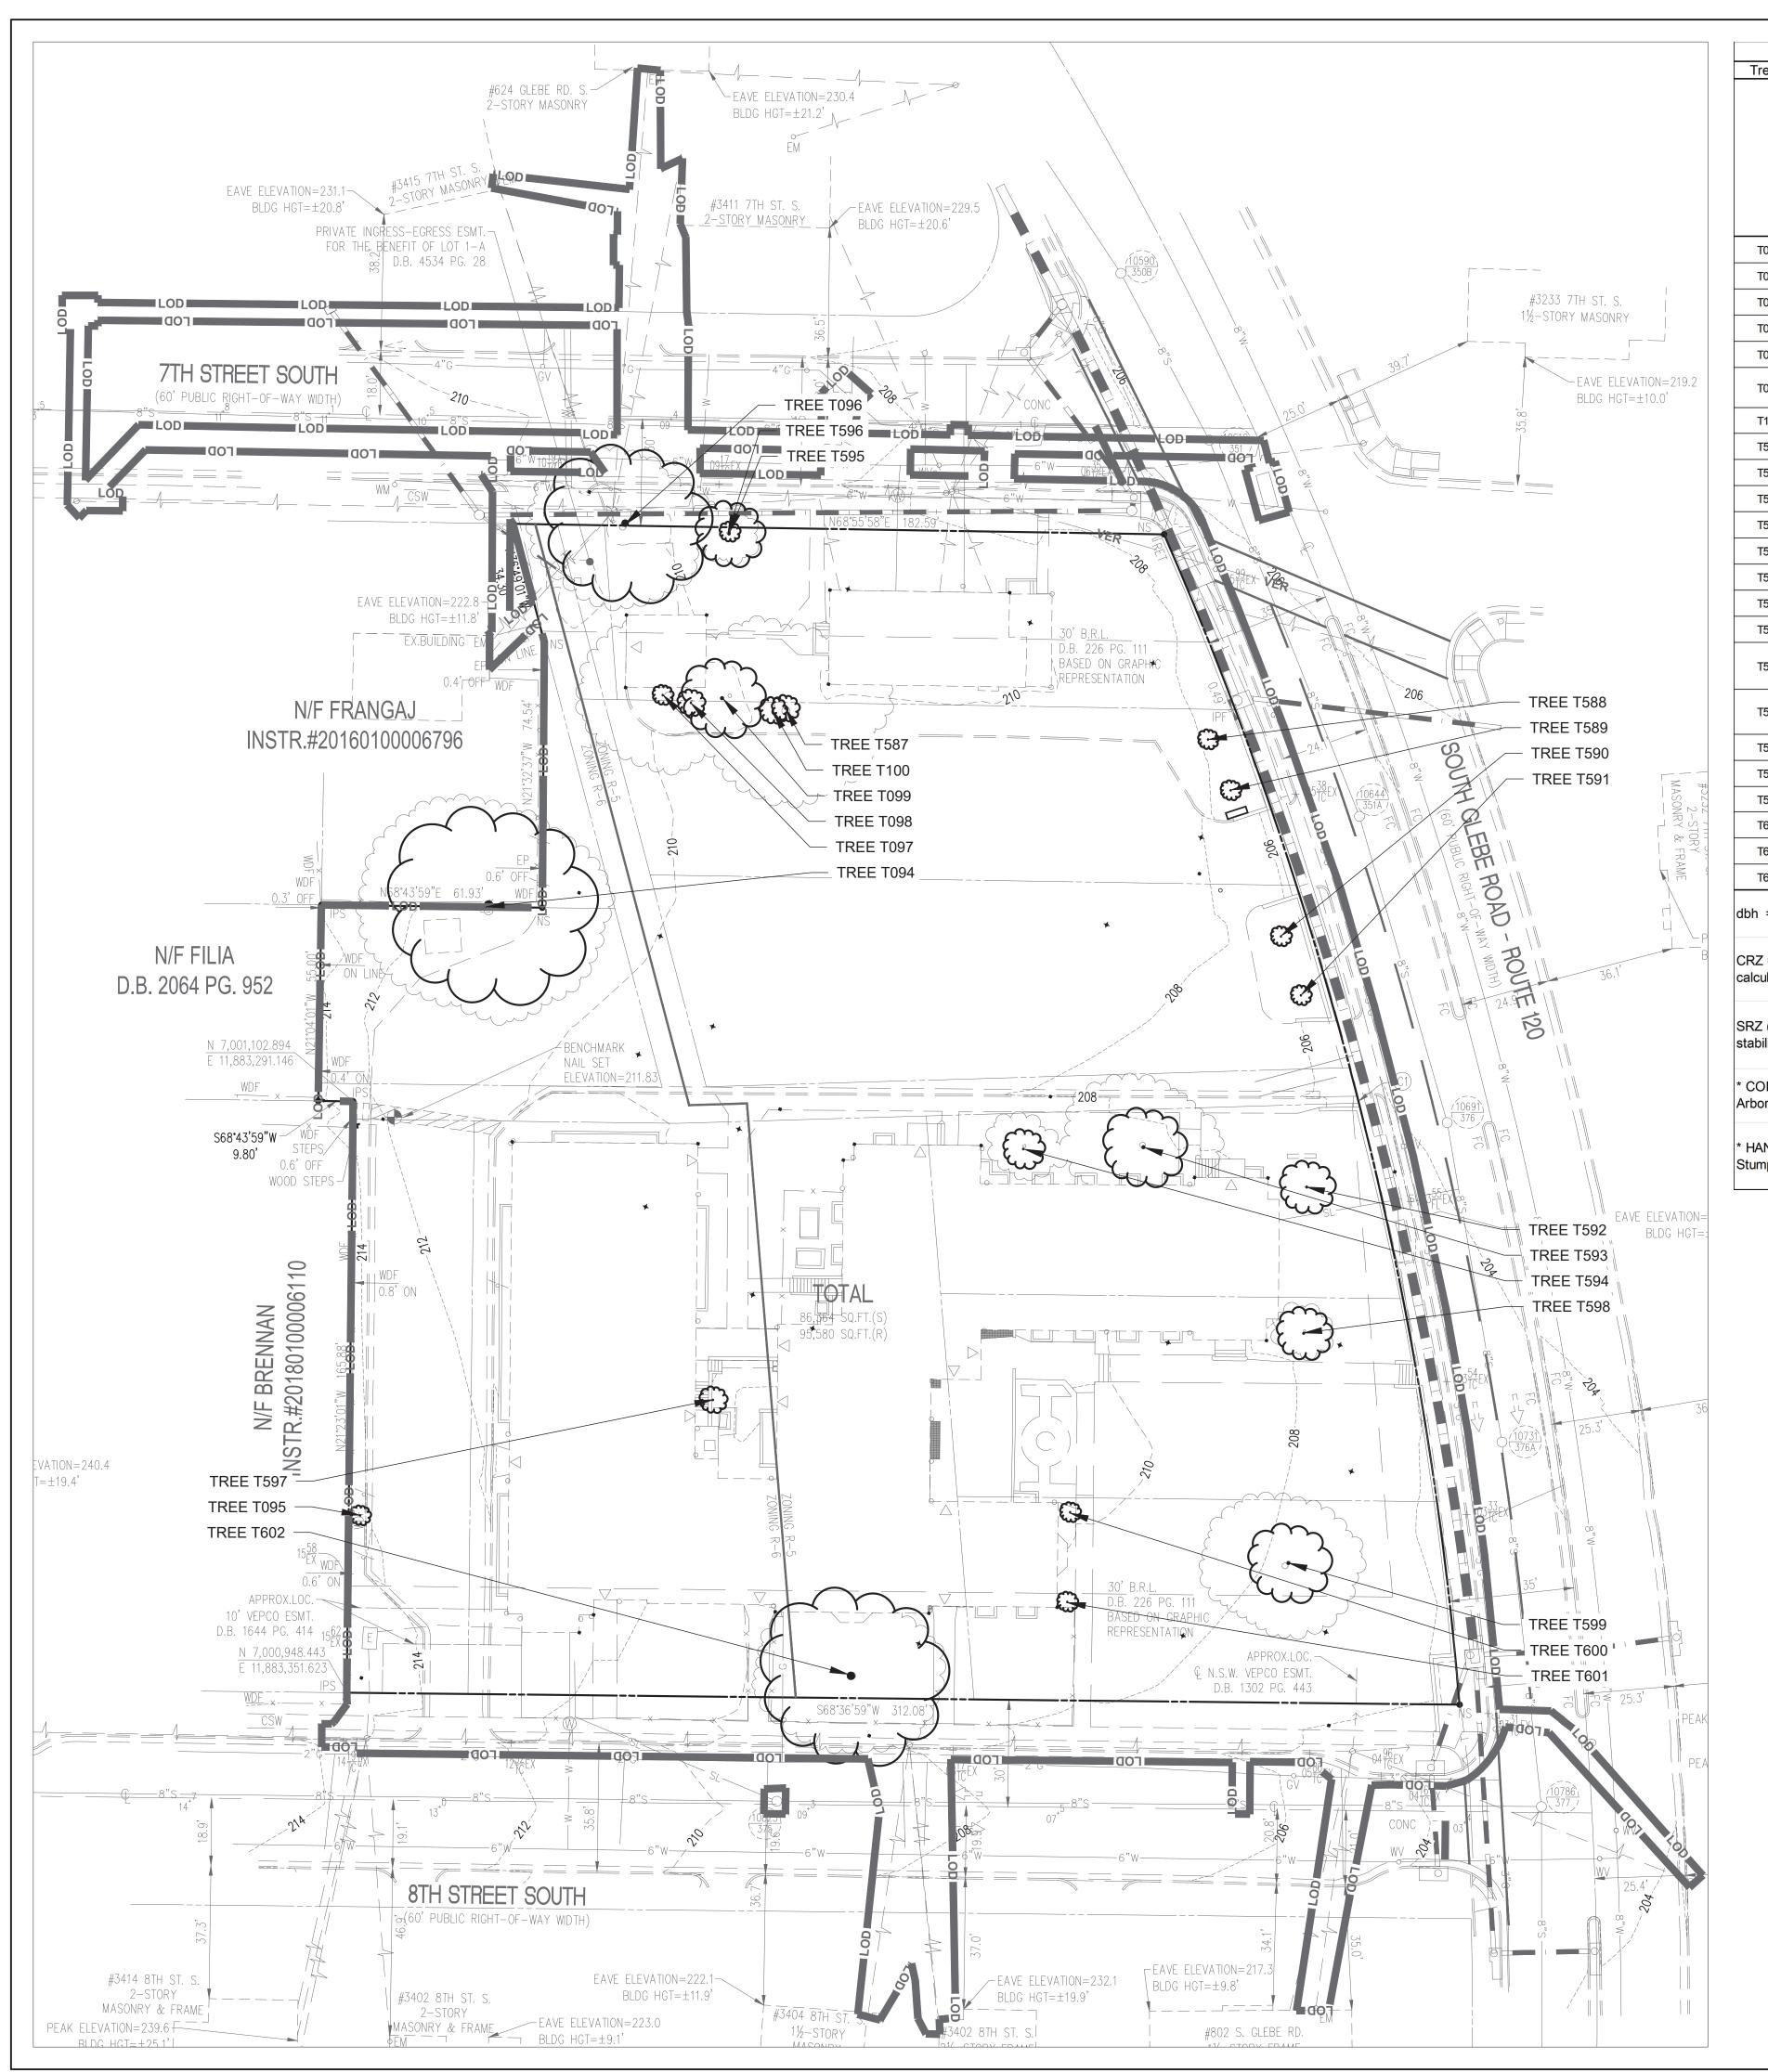

roo #						or Living of South		Donloosmants		Notos
ree #	Species	Size	CRZ	SRZ o	Condition	Canopy Position	Status	Replacements		Notes
		dbh	Critical Root Zone (radius ft)	Structural Rooting Zone (radius ft)	%				*Hand Removal	
T094	WHITE OAK	30"	30	9.9	30	CODOMINANT	*REMOVE	6	*X	Major dieback, poor condition
T095	WHITE OAK	3"	3	0.99	70	CENTRAL LEADER	*REMOVE	1	*X	Fair condition, constricted growth area
T096	EASTERN WHITE PINE	24"	24	7.92	40	CODOMINANT	*REMOVE	5	*X	Conflict with utility wires, bare canopy, dieback
T097	CHINESE PRIVET	3"	3	0.99	20	CODOMINANT	*REMOVE	1	*X	Poor condition, dieback, invasives, vines
T098	HONEY LOCUST	4"	4	1.32	30	CODOMINANT	*REMOVE	1	*X	Covered with invasives and vines, constricted growth area
T099	OBSCURED - VINES	12"	12	3.96	10	CODOMINANT	*REMOVE	3	*X	Dying, fully covered in invasives and vines, assesment obscured
T100	JAPANESE PHOTINIA	4"	4	1.32	30	CODOMINANT	*REMOVE	1	*X	Poor condition, covered in invasives and vines
T587	JAPANESE PHOTINIA	4"	4	1.32	30	CODOMINANT	*REMOVE	1	*X	Poor condition, covered in invasives and vines
T588	CREPE MYRTLE	3"	3	0.99	60	CODOMINANT	*REMOVE	1	*X	Fair condition, some dieback
T589	CREPE MYRTLE	3"	3	0.99	60	CODOMINANT	*REMOVE	1	*X	Fair condition, some dieback
T590	CREPE MYRTLE	3"	3	0.99	60	CODOMINANT	*REMOVE	1	*X	Fair condition, some dieback
T591	CREPE MYRTLE	3"	3	0.99	60	CODOMINANT	*REMOVE	1	*X	Fair condition, some dieback
T592	EASTERN HORNBEAM	8"	8	2.64	80	CODOMINANT	*REMOVE	2	*X	Good condition, full canopy
T593	BLACK CHERRY	12"	12	3.96	70	CODOMINANT	*REMOVE	3	*X	Fair condition, cankers, included bark
T594	FLOWERING DOGWOOD	6"	6	1.98	30	CODOMINANT	*REMOVE	2	*X	Poor condition, dying
T595	CREPE MYRTLE	3"	3	0.99	60	CODOMINANT	*REMOVE	1	*X	Fair condition, growing in competition with T596, close to utility wires
T596	BRADFORD PEAR	10"	10	3.3	60	CODOMINANT	*REMOVE	3	*X	Fair condition, growing in competition with T596, close to utility wires
T597	HONEY LOCUST	4"	4	1.32	50	CODOMINANT	*REMOVE	1	*X	Fair condition, dieback
T598	EASTERN HORNBEAM	8"	8	2.64	80	CODOMINANT	*REMOVE	2	*X	Good condition, some root plate exposed
T599	RED SPRUCE	12"	12	3.96	30	CODOMINANT	*REMOVE	3	*X	Poor condition, dieback, vines, included bark
T600	AMERICAN HOLLY	3"	3	0.99	70	CODOMINANT	*REMOVE	1	*X	Fair condition, limited growth room
T601	AMERICAN HOLLY	3"	3	0.99	60	CODOMINANT	*REMOVE	1	*X	Fair condition, limited growth room
T602	WHITE OAK	27"	27	8.91	80	CENTRAL LEADER	*REMOVE	6	*X	Good condition, full canopy, bordered by utility wires

dbh = Diameter at Breast Height (measured 4.5 feet above ground).

CRZ = Critical Root Zone = 1.0 foot radius per inch of tree diameter. Estimated radius of area containing majority of tree roots. TRZ values for trees with multiple stems were calculated using the diameter of a tree with the basal area equivalent to the sum of the basal areas for all stems.

SRZ (Structural Rooting Zone). Calculation - dbh x 0.33 = radius feet. Estimated radius of area containing tree roots that must be protected to ensure tree health and structural stability. Impact/root loss within SRZ may result in compromised structure, whole tree failure or decline in health.

* CONDITION RATING - provided as percentages based on methods outlined in the 10th edition of the Guide for Plant Appraisal, published by the International Society of Arboriculture.

* HAND REMOVAL - Trees to be removed within tree save areas or directly adjacent to but within the limits of clearing and grading shall be felled by hand with a chain saw. Stumps shall remain in place or shall be ground out. See tree preservation notes.

LandDesign.

200 S. PEYTON STREET ALEXANDRIA, VA 22314 703.549.7784 WWW.LANDDESIGN.COM

MATTHEW V. CLARK Lic. No. 952
09/12/2023
CAPE ARCHITICATE

OF THE STATE OF THE STAT

NOT FOR CONSTRUCTION

SUNRISE LIVING


OF SOUTH ARLINGTON

SUNRISE SENIOR LIVING
716 SOUTH GLEBE ROAD
ARLINGTON, VA 22204

2022139 REVISION / ISSUANCE DESCRIPTION PRELIMINARY SUBMISSION 4.1 SITE PLAN 2ND 2 PRELIMINARY SUBMISSION 4.1 SITE PLAN 3RD PRELIMINARY SUBMISSION 4.1 SITE PLAN 4TH 4 PRELIMINARY SUBMISSION HEARING SUBMISSION REVISED PUBLIC HEARING SUBMISSION DESIGNED BY: JM DRAWN BY: JM CHECKED BY: AC

>) 12.5' 25' T TITLE

TREE INVENTORY

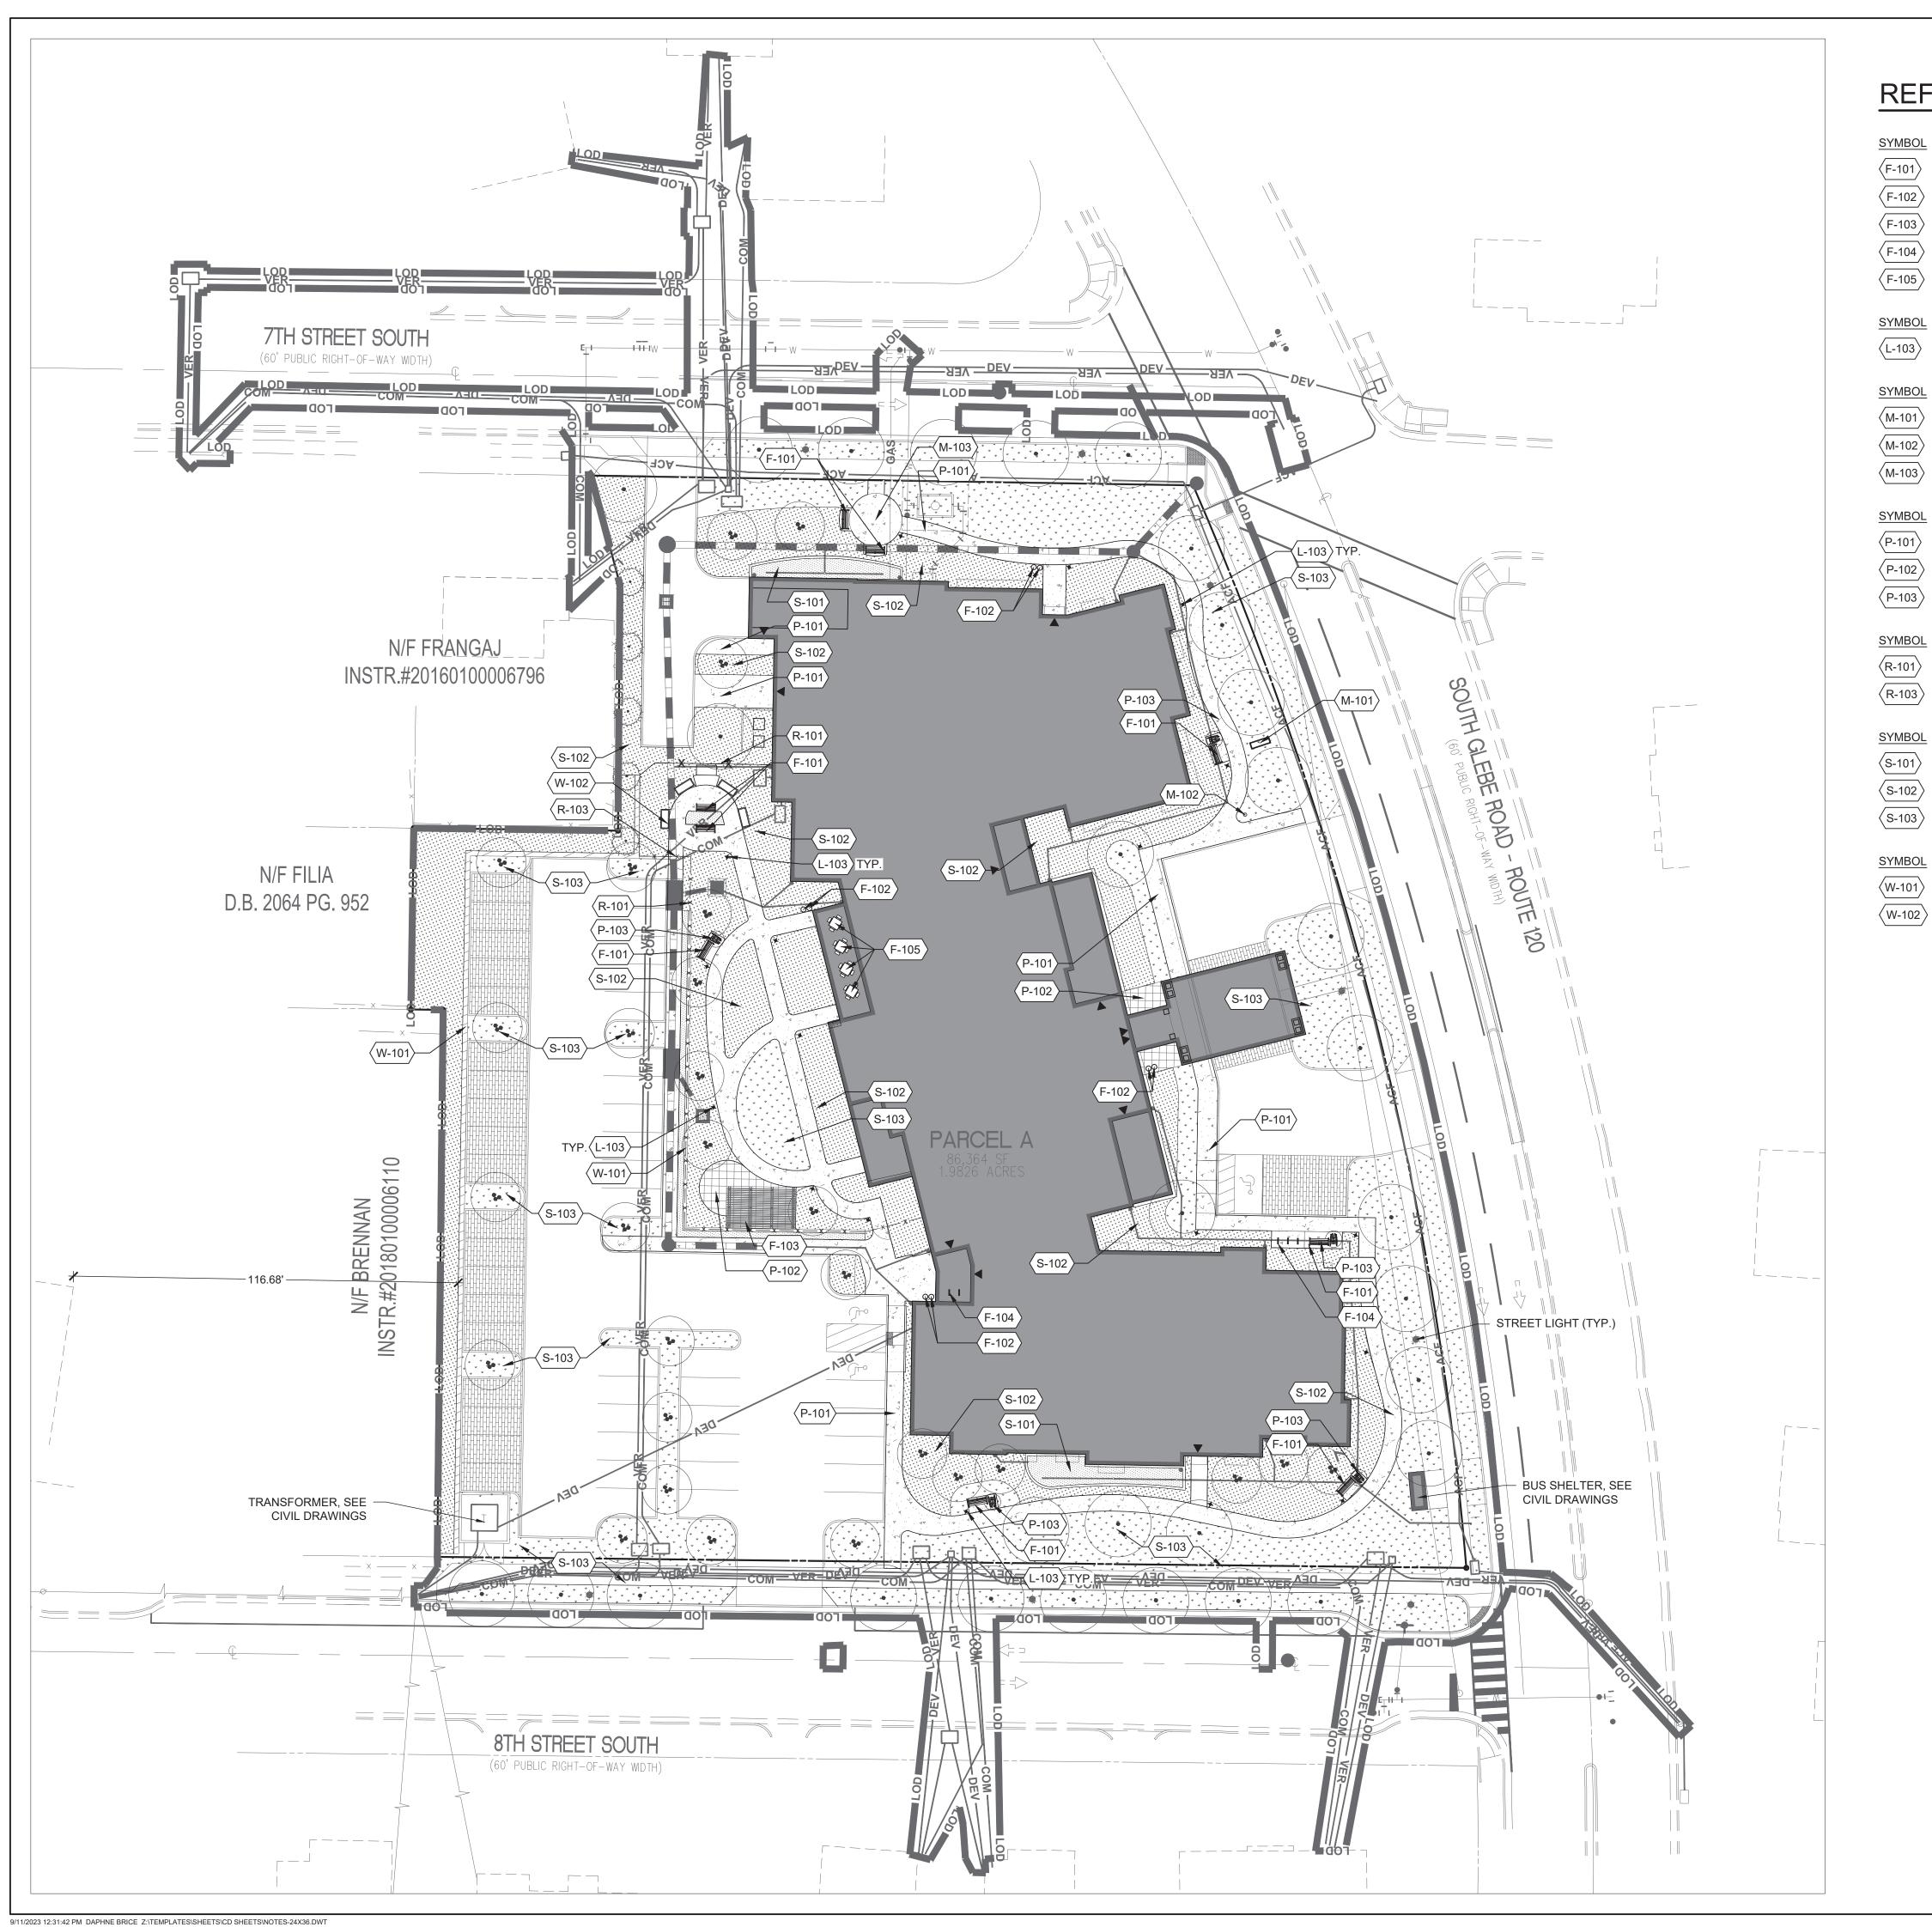

ULE

REFE	RENCE NOTES S	CHEDU
SYMBOL	FURNISHINGS DESCRIPTION	DETAIL
⟨F-101⟩	BENCH	1/L-502
(F-102)	TRASH & RECYCLING RECEPTACLES	2/L-502
(F-103)	PERGOLA	3/L-502
⟨F-104⟩	BIKE RACK	6/L-502
(F-105)	4 SEAT TABLE	7/L-502
SYMBOL	LIGHTING & ELECTRICAL DESCRIPTION	<u>DETAIL</u>
(L-103)	PATHWAY LIGHT BOLLARD	3/L-504
SYMBOL	MISCELLANEOUS DESCRIPTION	<u>DETAIL</u>
(M-101)	MONUMENT SIGN	
(M-102)	FLAG POLE	
(M-103)	POTENTIAL SCULPTURE	
SYMBOL	PAVING & CURBS DESCRIPTION	<u>DETAIL</u>
(P-101)	CONCRETE PAVING	1/L-501
(P-102)	ENHANCED PAVING	2/L-501
(P-103)	BENCH COMPANION SPACE	5/L-501
SYMBOL	RAILINGS & FENCES DESCRIPTION	<u>DETAIL</u>
(R-101)	FENCE - TYPE 1	5/L-502
(R-103)	GATE	1/L-503
SYMBOL	SOILS DESCRIPTION	<u>DETAIL</u>
(0.404)		

BIORETENTION PLANTER

PLANT BED

WALLS & STAIRS DESCRIPTION

RAISED PLANTER

FREE-STANDING WALL

4/L-501

<u>DETAIL</u>

3/L-501

4/L-502



200 S. PEYTON STREET ALEXANDRIA, VA 22314 703.549.7784 WWW.LANDDESIGN.COM




NOT FOR CONSTRUCTION

SUNRISE LIVING OF SOUTH **ARLINGTON**

SUNRISE SENIOR LIVING 716 SOUTH GLEBE ROAD ARLINGTON, VA 22204

ANDDL	SIGN PROJ.# 2022139	
ſ	REVISION / ISSUA	NCE
NO.	DESCRIPTION	DATE
1	4.1 SITE PLAN 1ST PRELIMINARY SUBMISSION	09/09/202
2	4.1 SITE PLAN 2ND PRELIMINARY SUBMISSION	12/02/202
3	4.1 SITE PLAN 3RD PRELIMINARY SUBMISSION	04/10/202
4	4.1 SITE PLAN 4TH PRELIMINARY SUBMISSION	06/01/202
5	4.1 SITE PLAN PUBLIC HEARING SUBMISSION	08/11/202
6	REVISED PUBLIC HEARING SUBMISSION	09/12/202
DE	SIGNED BY: JM	
	RAWN BY: JM HECKED BY: AC	

MATERIALS PLAN

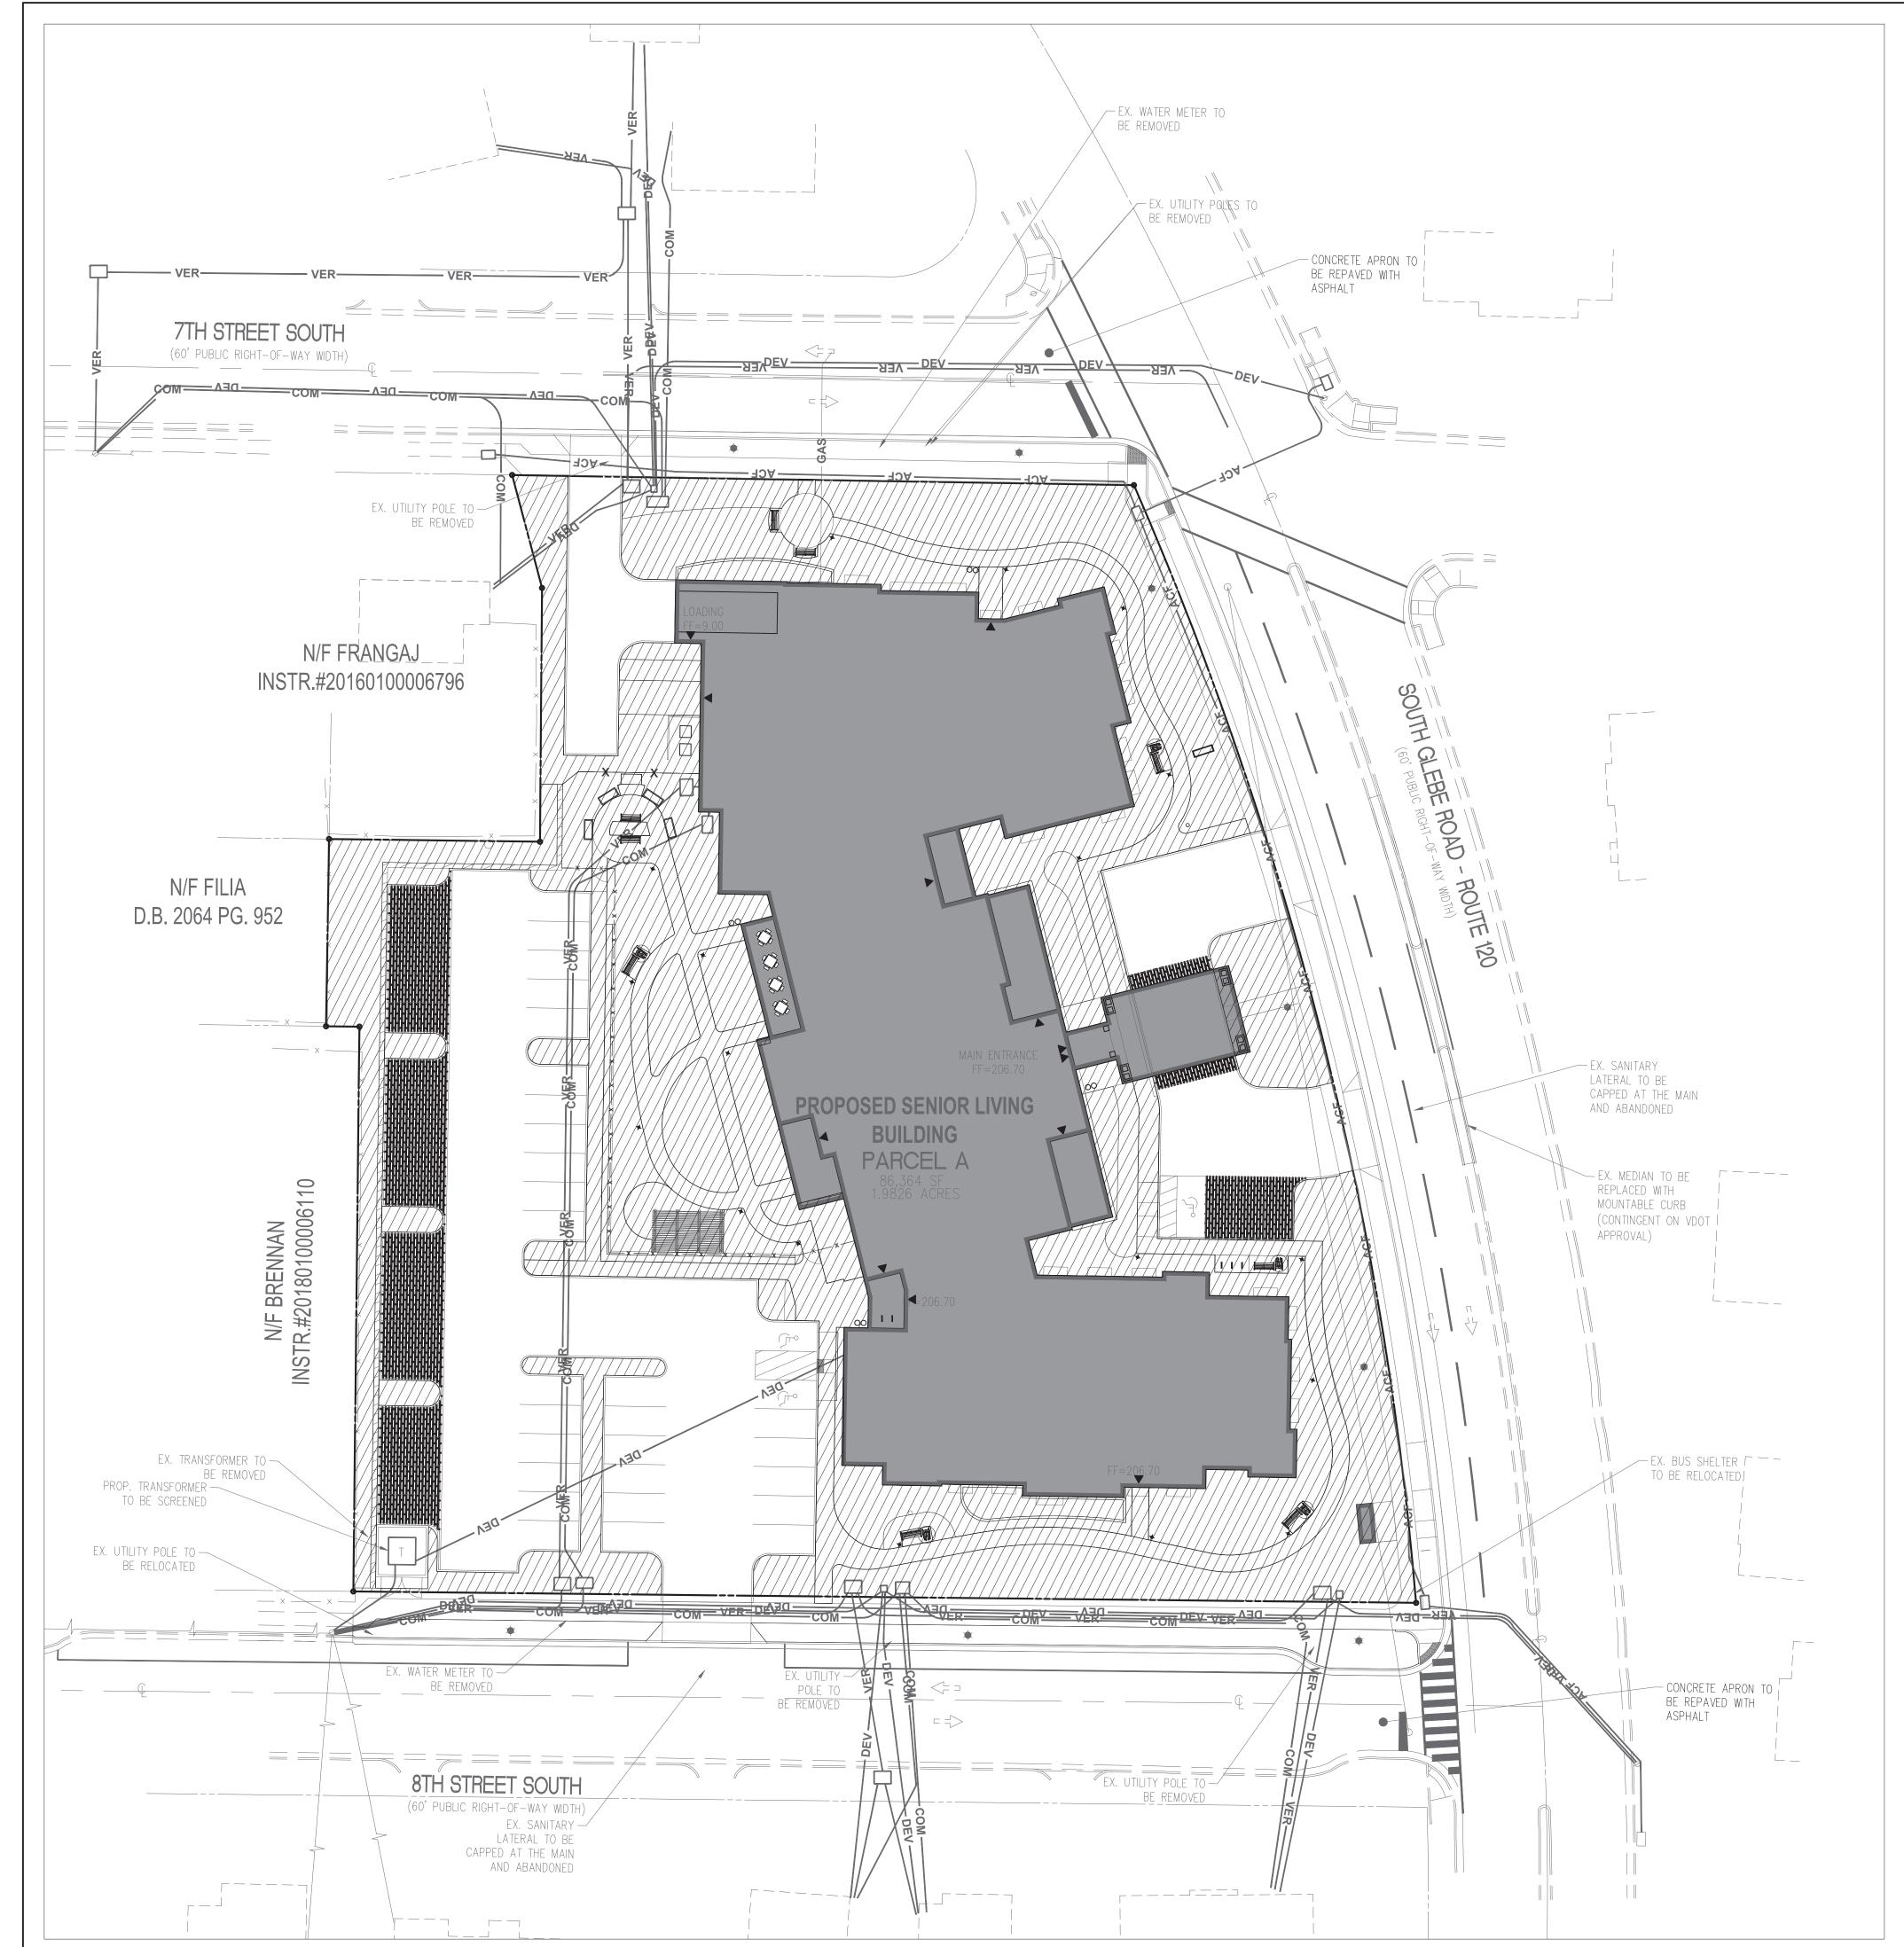

OPEN SPACE CALCULATIONS

TOTAL OPEN SPACE AREA:

36,033 SF

OPEN SPACE PROVIDED - ON SITE						
STREET LEVEL	36,033 SF					
TOTAL OPEN SPACE	36,033 SF					
TOTAL SITE AREA	86,364 SF					
PERCENTAGE OF TOTAL OPEN SPACE	41.7%					

NOTE: ARLINGTON COUNTY, VA ZONING ORDINANCE PER CHAPTER 7.3.4 D - MINIMUM OF 10% OF THE TOTAL SITE AREA IS REQUIRED TO BE LANDSCAPED OPEN SPACE.



200 S. PEYTON STREET ALEXANDRIA, VA 22314 703.549.7784 WWW.LANDDESIGN.COM

NOT FOR CONSTRUCTION


SUNRISE LIVING OF SOUTH **ARLINGTON**

SUNRISE SENIOR LIVING 716 SOUTH GLEBE ROAD ARLINGTON, VA 22204

	2022139	
F	REVISION / ISSUA	NCE
NO.	DESCRIPTION	DATE
1	4.1 SITE PLAN 1ST PRELIMINARY SUBMISSION	09/09/202
2	4.1 SITE PLAN 2ND PRELIMINARY SUBMISSION	12/02/2022
3	4.1 SITE PLAN 3RD PRELIMINARY SUBMISSION	04/10/2023
4	4.1 SITE PLAN 4TH PRELIMINARY SUBMISSION	06/01/2023
5	4.1 SITE PLAN PUBLIC HEARING SUBMISSION	08/11/2023
6	REVISED PUBLIC HEARING SUBMISSION	09/12/2023
DE	SIGNED BY: JM	
DF	RAWN BY: JM	
CH	HECKED BY: AC	

OPEN SPACE PLAN

ORIGINAL SHEET SIZE: 24" X 36"

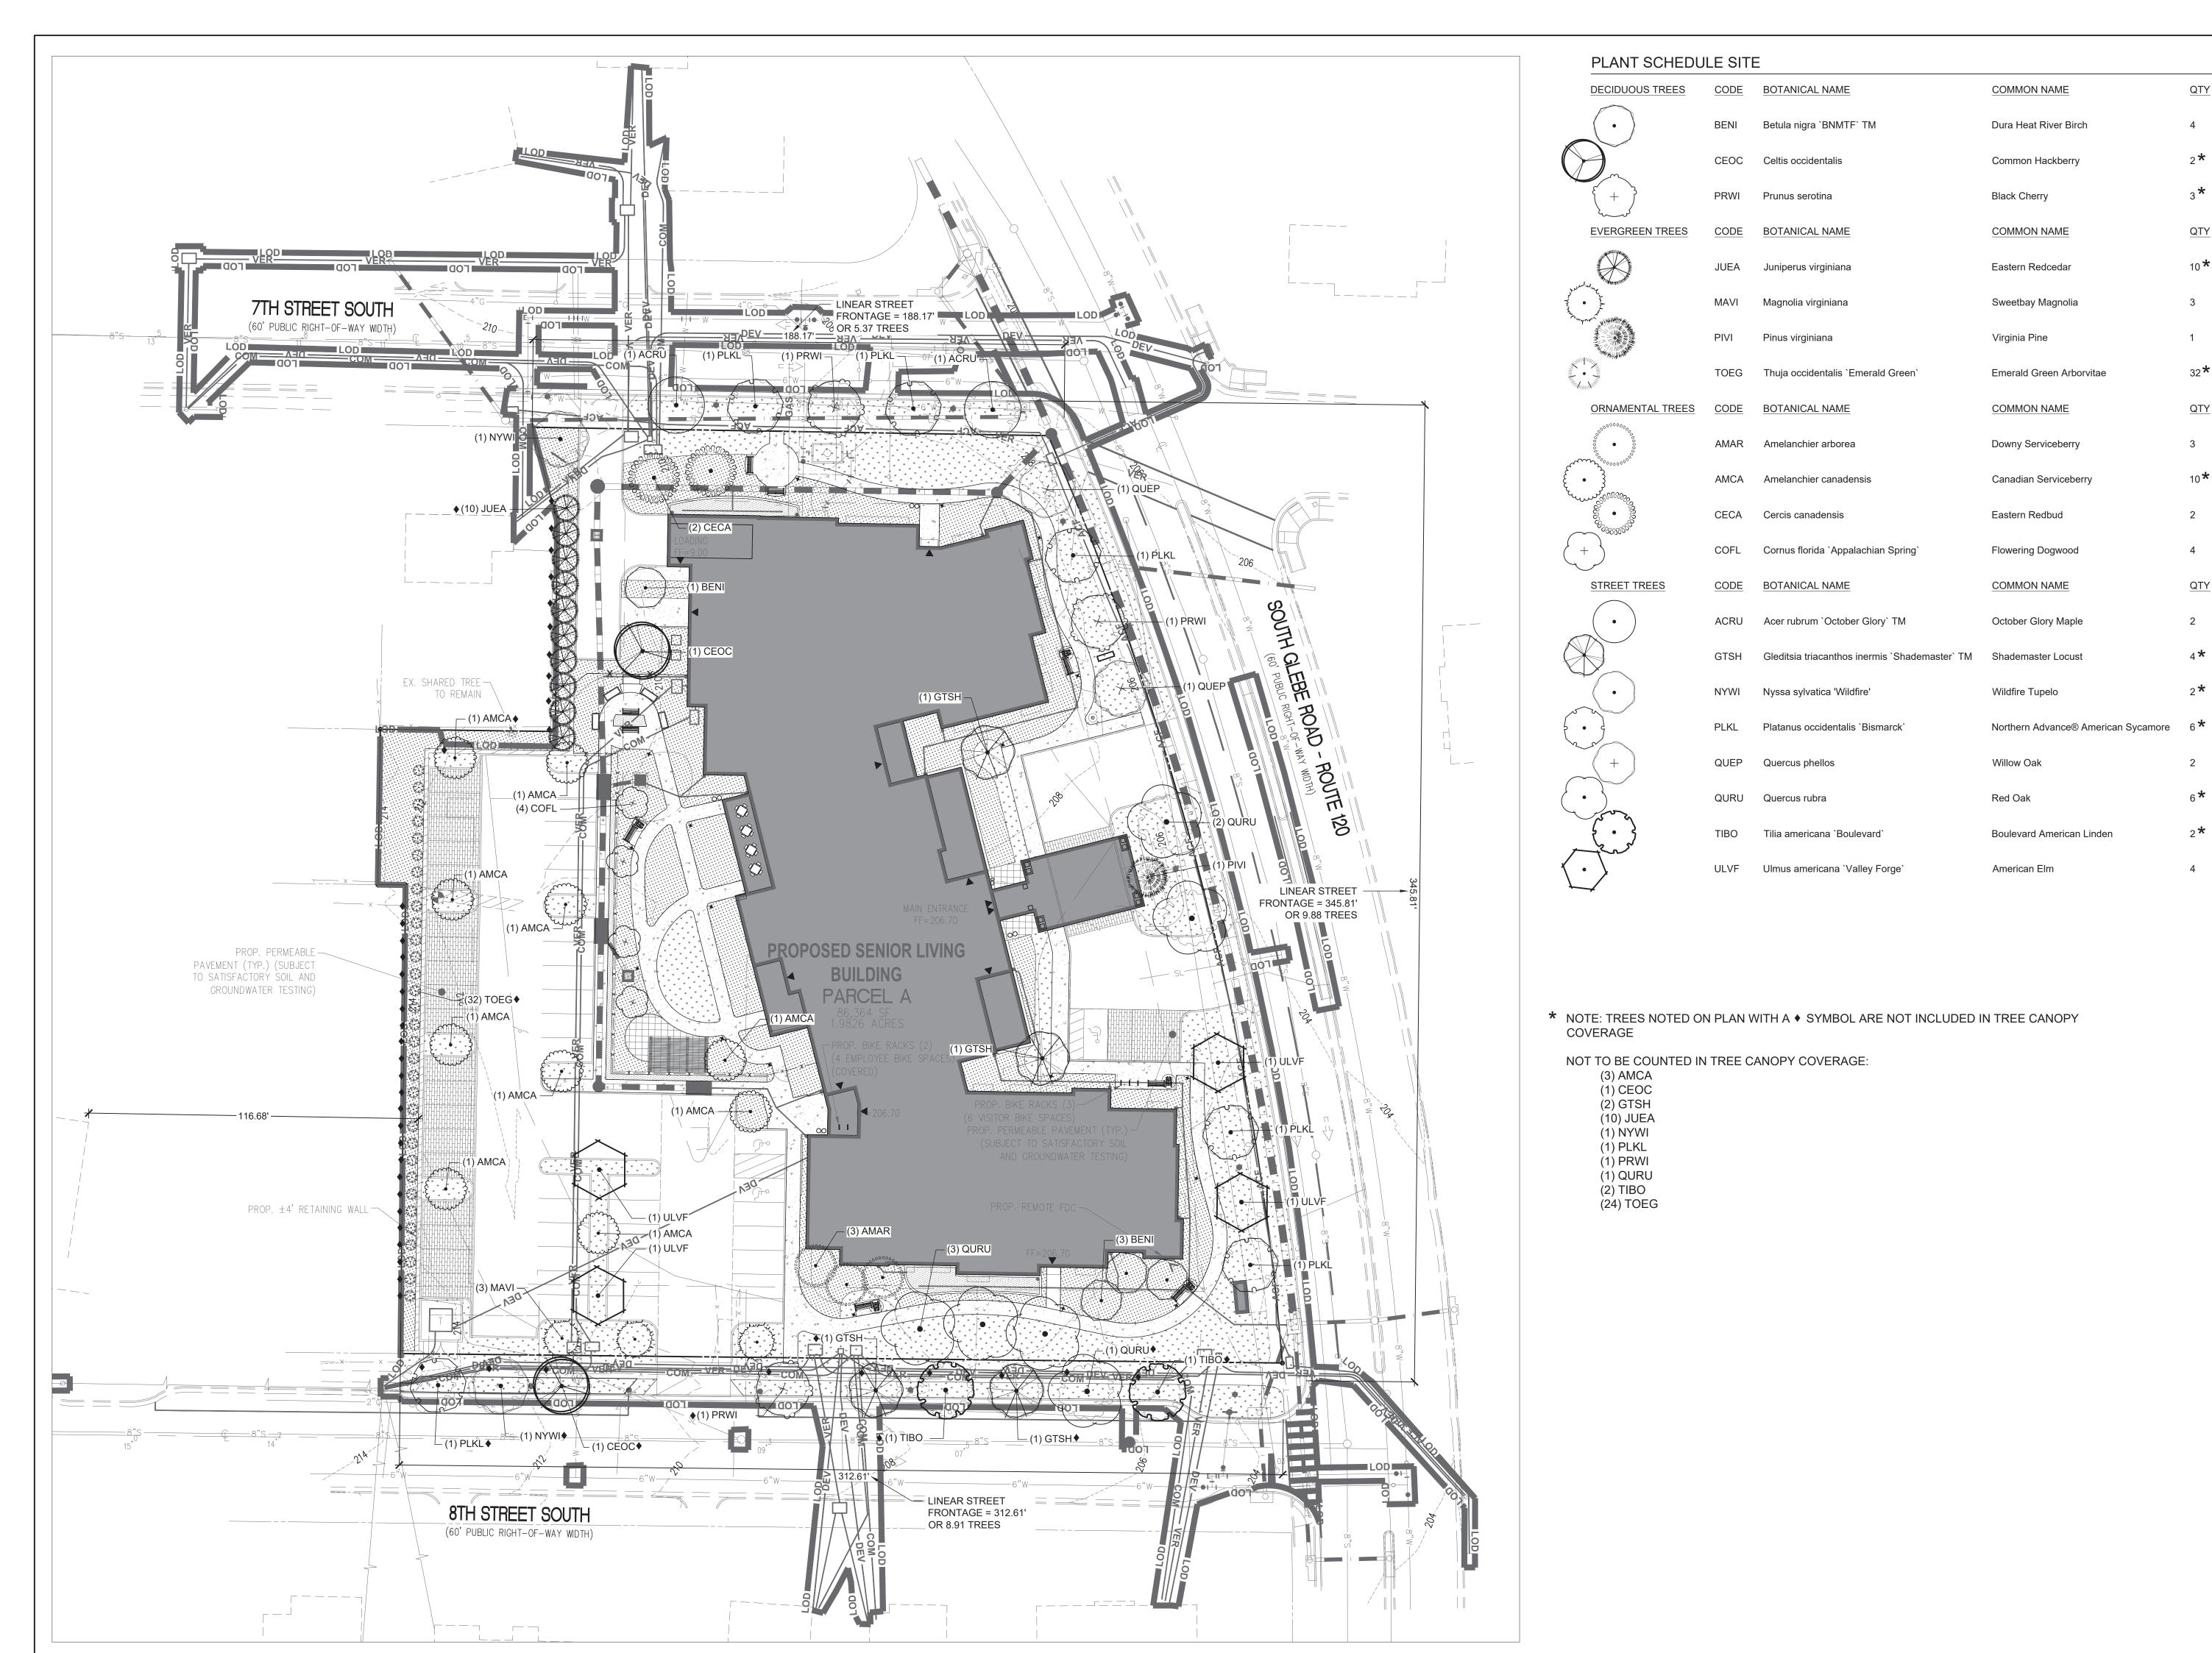

200 S. PEYTON STREET ALEXANDRIA, VA 22314 703.549.7784 WWW.LANDDESIGN.COM

QTY

2 *****

QTY

10 *****

32*****

QTY

10*****


QTY

4 *****

2 *****

6 *****

2*****

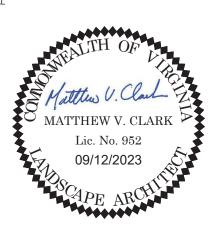

NOT FOR CONSTRUCTION

SUNRISE LIVING OF SOUTH ARLINGTON

SUNRISE SENIOR LIVING 716 SOUTH GLEBE ROAD ARLINGTON, VA 22204

_ANDDES	SIGN PROJ.# 2022139	
F	REVISION / ISSUA	NCE
NO.	DESCRIPTION	DATE
1	4.1 SITE PLAN 1ST PRELIMINARY SUBMISSION	09/09/2022
2	4.1 SITE PLAN 2ND PRELIMINARY SUBMISSION	12/02/2022
3	4.1 SITE PLAN 3RD PRELIMINARY SUBMISSION	04/10/2023
4	4.1 SITE PLAN 4TH PRELIMINARY SUBMISSION	06/01/2023
5	4.1 SITE PLAN PUBLIC HEARING SUBMISSION	08/11/2023
6	REVISED PUBLIC HEARING SUBMISSION	09/12/2023
DR	SIGNED BY: JM AWN BY: JM ECKED BY: AC	

PLANTING PLAN


20-YEAR	TREE CA	ANOPY COVERA	GE WORKSHE	ET PER C	HESAPEA	KE BAY	PRESERVATIC	N ORDIN	ANCE
QUANTITY	KEY	TREE SPECIES	COMMON NAME	PLANTING SIZE HEIGHT (ft.)	CALIPER SIZE AT PLANTING (in.)	SPREAD AT PLANTING (ft.)	CANOPY SIZE	20 YEAR COVERAGE (sq. ft.)	SUBTOTAL COVERAGE (sq. ft.)
2	ACRU	ACER RUBRUM	RED MAPLE		2 - 2 ½	5-7	LARGE	393.75	787.50
3	AMAR	AMALANCHIER ARBOREA	DOWNY SERVICEBERRY	6-7 FT		4-6	SMALL- MEDIUM	137.50	412.50
10	AMCA	AMALANCHIER CANADENSIS	SHADBLOW SERVICEBERRY	6-7 FT		4-6	SMALL- MEDIUM	137.50	1375.00
4	BENI	BETULA NIGRA	DURAHEAT RIVER BIRCH	8-10 FT		5-7	MEDIUM	218.75	875.00
4	COFL	CORNUS FLORIDA	FLOWERING DOGWOOD		>1	2-3	MEDIUM	218.75	875.00
2	CECA	CERCIS CANADENSIS	EASTERN REDBUD		1	2-3	SMALL-MEDIUM	218.75	437.50
1	CEOC	CELTIS OCCIDENTALIS	COMMON HACKBERRY		2-2 ½	3-5	MEDIUM-LARGE	393.75	393.75
2	GTSH	GLEDITSIA TRIACANTHOS INERMIS	SHADEMASTER LOCUST		2 - 2 ½	3-5	MEDIUM-LARGE	250	500.00
3	MAVI	MAGNOLIA VIRGINIANA	SWEETBAY MAGNOLIA	6-7 FT		3-4	SMALL- MEDIUM	137.50	412.50
1	NYWI	NYSSA SYLVATICA	BLACK GUM		2 - 2 ½	3-5	MEDIUM - LARGE	312.5	625.00
1	PIVI	PINUS VIRGINIANA	VIRGINIA PINE	6-7 FT		2-4	SMALL-MEDIUM	110.00	110
5	PLKL	PLATANUS OCCIDENTALIS	AMERICAN SYCAMORE		2-2 ½	5-7	LARGE	393.75	1968.75
2	PRWI	PRUNUS SEROTINA	BLACK CHERRY		1 ³ / ₄ - 2	3-4	MEDIUM - LARGE	312.5	937.50
2	QUEP	QUERCUS PHELLOS	WILLOW OAK		$2-2\frac{1}{2}$	3-5	MEDIUM-LARGE	312.5	625.00
5	QURU	QUERCUS RUBRA	NORTHERN RED OAK		$2-2\frac{1}{2}$	4-5	LARGE	393.75	1968.75
8	TOEG	THUJA OCCIDENTALIS	EMERALD GREEN ARBORVITAE	6-7 FT		3-4	SMALL	50	400
4	ULVF	ULMUS AMERICANA	AMERICAN ELM 'VALLEY FORGE'		2-2 ½	3-5	LARGE	393.75	1575.00
TOTAL: 57	-	-	-	-	-	-	-	-	14278.75

NOTE: ARLINGTON COUNTY CODE PER CHAPTER 61 CHESAPEAKE BAY PRESERVATION ORDINANCE MINIMUM TREE CANOPY REQUIREMENTS: TEN PERCENT (10%).

86,364 SQ FT SITE AREA X 10% = 8,636 SQ FT MINIMUM TREE CANOPY COVERAGE

TOTAL TREE CANOPY COVERAGE PROVIDED: 14,278.75 SF TOTAL SITE AREA: 86,363.55 SF PERCENT OF TREE CANOPY COVERAGE PROVIDED: 16.5%

PLANT SCHEDULE SITE

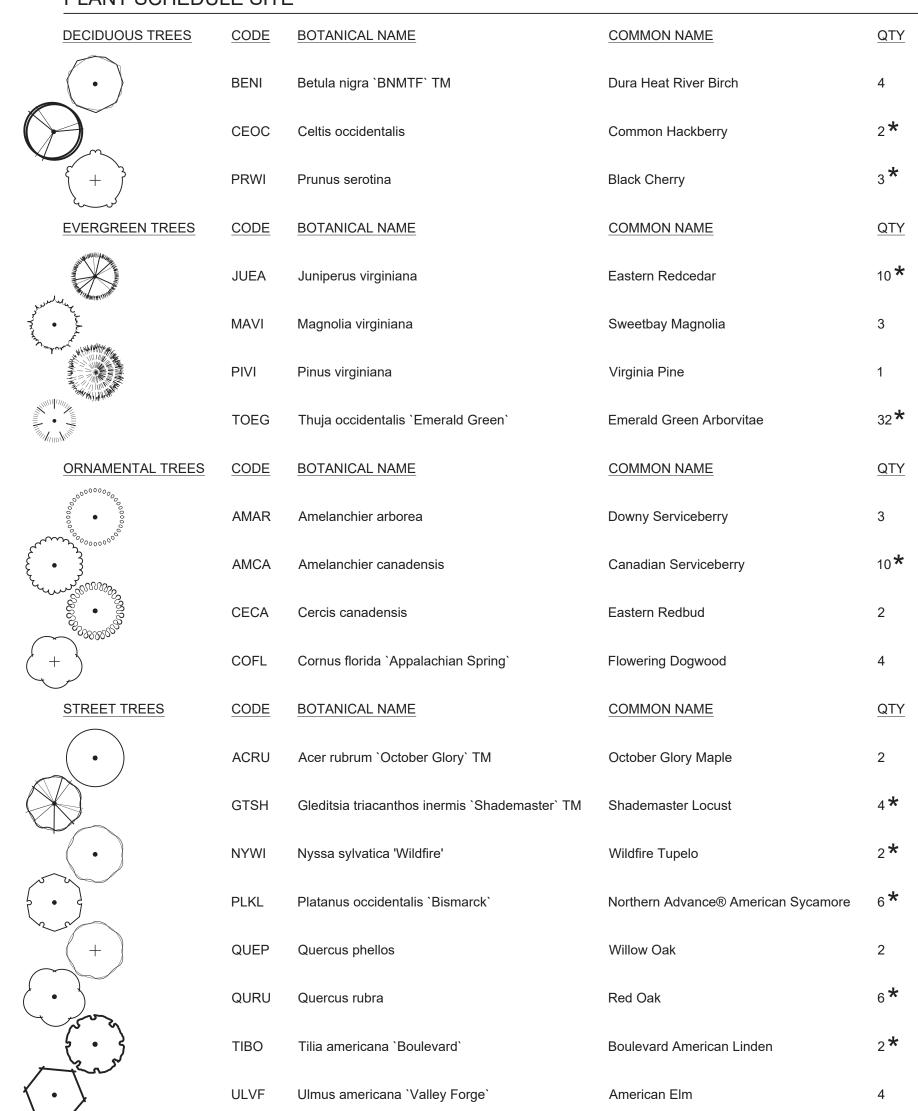

* NOTE: TREES NOTED ON PLAN WITH A ◆ SYMBOL ARE NOT INCLUDED IN TREE CANOPY COVERAGE

NOT TO BE COUNTED IN TREE CANOPY COVERAGE:

(1) AMCA (1) CEOC

(2) GTSH (10) JUEA

(1) NYWI (1) PLKL (1) PRWI


(1) QURU (2) TIBO (24) TOEG

SHRUB COVERAGE CALULCATION

NOTE: ARLINGTON COUNTY ZONING PER CHAPTER 14.2.2 LANDSCAPING REQUIRES MINIMUM TWENTY-FIVE PERCENT (25%) SHRUB COVERAGE AT MATURITY. 29,708 SQ FT LANDSCAPE AREA X 25% = 7,427 SQ FT MINIMUM SHRUB COVERAGE

TOTAL SHRUB COVERAGE PROVIDED: 13,174 SF TOTAL LANDSCAPE AREA: 29,708 SF PERCENT OF SHRUB COVERAGE PROVIDED: 44.3% LandDesign.

200 S. PEYTON STREET ALEXANDRIA, VA 22314 703.549.7784 WWW.LANDDESIGN.COM

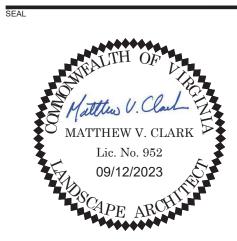

NOT FOR CONSTRUCTION

SUNRISE LIVING OF SOUTH ARLINGTON

SUNRISE SENIOR LIVING
716 SOUTH GLEBE ROAD
ARLINGTON, VA 22204

2022139 REVISION / ISSUANCE NO. DESCRIPTION 4.1 SITE PLAN 1ST 09/09/2022 PRELIMINARY SUBMISSION 4.1 SITE PLAN 2ND 2 PRELIMINARY SUBMISSION 4.1 SITE PLAN 3RD PRELIMINARY SUBMISSION 4.1 SITE PLAN 4TH 4 PRELIMINARY SUBMISSION 4.1 SITE PLAN PUBLIC 08/11/2023 HEARING SUBMISSION REVISED PUBLIC HEARING SUBMISSION

DESIGNED BY: JM
DRAWN BY: JM
CHECKED BY: AC

VERT: N/A HORZ:

5. ...

PLANTING SCHEDULE

1-402

Landscape Plan Notes and Details

LANDSCAPE AND PLANTING NOTES

- MATERIAL SHALL BE FURNISHED AND INSTALLED AS INDICATED ON PLANS, INCLUDING ALL LABOR, MATERIALS, PLANTS, EQUIPMENT, INCIDENTALS, AND CLEAN-UP.
- 2. GRADING AND PLANTING OPERATIONS SHALL BE PERFORMED DURING PERIODS WHEN WEATHER AND SOIL CONDITIONS ARE SUITABLE, AND IN ACCORDANCE WITH ACCEPTED LOCAL PRACTICE AND STANDARDS. THE ACCEPTABLE PLANTING RANGE IS FROM MARCH-JUNE 15 AND SEPTEMBER-DECEMBER, FOR NON-TREE MATERIAL, AND OCTOBER – JUNE 15 FOR TREES. PLANTS SHALL NOT BE INSTALLED IN TOPSOIL THAT IS MUDDY OR FROZEN. CARE SHALL BE TAKEN TO PROVIDE PLANTS WITH ENOUGH WATER TO COMBAT HEAT STRESS DURING HOT/DRY WEATHER.
- 3. ALL LAWN AND PLANTING AREAS SHALL BE GRADED TO A SMOOTH, EVEN, AND UNIFORM PLANE WITH NO ABRUPT CHANGE OF SURFACE UNLESS OTHERWISE DIRECTED BY THE LANDSCAPE ARCHITECT OR REPRESENTATIVE. SOIL AREAS ADJACENT TO BUILDINGS SHALL SLOPE AWAY FROM BUILDING. ALL PLANTING AREAS SHALL BE GRADED AND MAINTAINED TO ALLOW FREE FLOW OF SURFACE WATER. CONTRACTOR SHALL REPORT ANY SOIL OR DRAINAGE CONDITIONS CONSIDERED DETRIMENTAL TO GROWTH OF PLANT MATERIAL.
- 4. THE CONTRACTOR SHALL BE RESPONSIBLE FOR PLANTING AT CORRECT GRADES AND ALIGNMENT PER APPROVED PLANS. NO TREES SHALL BE PLANTED LESS THAN TWO FEET FROM EXISTING STRUCTURES AND SIDEWALKS. LAYOUT OF PLANTS SHALL BE APPROVED BY LANDSCAPE ARCHITECT OR REPRESENTATIVE PRIOR TO INSTALLATION.
- 5. PLANTS SHALL BE TYPICAL OF THEIR SPECIES AND VARIETY, HAVE NORMAL GROWTH HABITS, WELL-DEVELOPED DENSELY FOLIATED BRANCHES, VIGOROUS ROOT SYSTEMS, AND BE FREE FROM DEFECTS AND INJURIES.

 QUALITY AND SIZE OF PLANTS, SPREAD OF ROOTS AND SIZE OF ROOTBALL SHALL BE IN ACCORDANCE WITH THE MOST RECENT VERSION OF ANSI "AMERICAN STANDARD FOR NURSERY STOCK" PUBLISHED BY THE AMERICAN ASSOCIATION OF NURSERYMEN, INC.
- 6. ALL PLANT MATERIAL SHALL BE GUARANTEED BY THE INSTALLER TO BE IN VIGOROUS GROWING CONDITION. PROVISION SHALL BE MADE FOR A GROWTH GUARANTEE OF AT LEAST ONE YEAR FROM THE DATE OF ACCEPTANCE FOR ALL PLANT MATERIAL. REPLACEMENTS SHALL BE MADE AT THE BEGINNING OF THE FIRST SUCCEEDING PLANTING SEASON. ALL REPLACEMENTS SHALL HAVE A GUARANTEE EQUAL TO THAT STATED ABOVE.
- 7. PLANT MATERIAL SHALL BE PLANTED ON THE DAY OF DELIVERY IF PRACTICAL. IF THIS IS NOT POSSIBLE, THE CONTRACTOR SHALL PROTECT STOCK NOT PLANTED. PLANTS SHALL NOT REMAIN UNPLANTED FOR LONGER THAN A THREE-DAY PERIOD AFTER DELIVERY. ANY PLANTS NOT INSTALLED DURING THIS PERIOD SHALL BE REJECTED, UNLESS OTHERWISE DIRECTED BY THE ARLINGTON COUNTY LANDSCAPE ARCHITECT OR REPRESENTATIVE.
- 8. ALL INJURED ROOTS SHALL BE PRUNED USING ANSI A300 STANDARDS.
- CONTRACTOR SHALL PROVIDE 4 IN. MINIMUM THICK TOPSOIL LAYER IN ALL PLANTING AREAS. TOPSOIL SHALL
 BE FREE OF WEEDS, DEBRIS, ROCKS LARGER THAN 2 IN., WOOD, ROOTS, VEGETABLE MATTER, AND CLAY CLODS.
 CLEAN, FERTILE TOPSOIL PRESENT AT THE SITE, IF ANY, MAY BE USED TO SUPPLEMENT TOTAL AMOUNT REQUIRED.

ARLINGTON COUNTY LANDSCAPE STANDARDS REFERENCE GUIDE | PG. 35

Landscape Plan Notes and Details

Zariascape i lari Notes aria Betali

County Standards Details

Certain Arlington County standard details must be shown on landscape and tree preservation plans, depending on the project. The standard details can be found on the webpages below:


Department of Parks and Recreation Design Standards

Department of Environmental Services Infrastructure Design Standards

Department of Environmental Servies Bicycle Parking Standards

What details are required will depend on the elements of each specific project, but typically, the most relevant details for tree preservation and landscape plans include:

- Tree Protection and Trimming Details
- Exterior Plants
- Horizontal Standards sidewalks, curb ramps, crosswalks, street lights
- Bicycle Parking

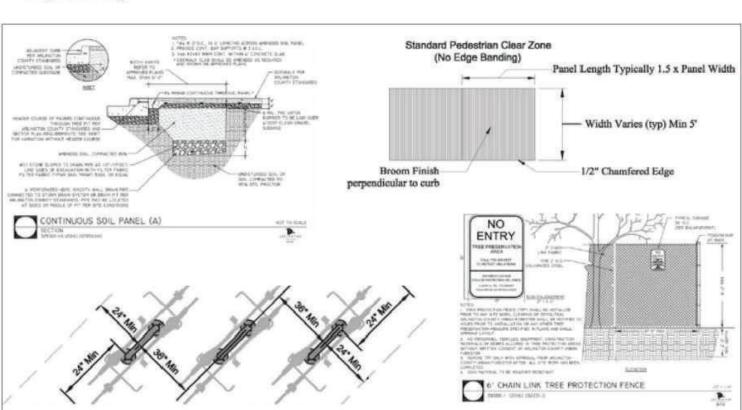

ARLINGTON COUNTY LANDSCAPE STANDARDS REFERENCE GUIDE | PG. 38

Examples of Arlington County Standard Details. See links above for actual details.

10. PLANTING PITS SHALL BE DUG PER COUNTY DETAILS. SET PLANTS PLUMB AND STRAIGHT, WITH ROOT FLARES SLIGHTLY ABOVE GRADE. DO NOT COVER THE ROOT FLARE WITH SOIL OR MULCH. BACKFILL PLANTING PITS WITH AMENDED TOPSOIL, AND THOROUGHLY WATER AND TAMP AS BACK-FILLING PROGRESSES. WATER AGAIN TO ACHIEVE SOIL SATURATION IMMEDIATELY FOLLOWING PLANTING.

Landscape Plan Notes and Details

- 11. PLANTS SHALL NOT BE BOUND WITH WIRE OR ROPE AT ANY TIME, SO AS NOT TO DAMAGE THE BARK OR BREAK BRANCHES. PLANTS SHALL BE HANDLED FROM THE BOTTOM OF THE ROOT BALL ONLY.
- 12. EACH TREE AND SHRUB SHALL BE PRUNED IN ACCORDANCE WITH ANSI A300: STANDARDS FOR TREE CARE PRACTICES, TO PRESERVE THE HEALTH AND APPEARANCE OF THE PLANT. PRUNING SHALL BE DONE WITH CLEAN, SHARP TOOLS.
- 13. TREES SHALL BE SUPPORTED AFTER PLANTING ONLY AS DIRECTED BY THE URBAN FORESTER. IF INSTALLED, THE LANDSCAPE CONTRACTOR SHALL REMOVE STAKING, GUYING AND TREE WRAP AT THE END OF THE ONE-YEAR MAINTENANCE AND WARRANTY PERIOD.
- 14. ALL PLANTING BEDS SHALL BE MULCHED WITH A 3 IN. LAYER OF WEED-FREE DOUBLE SHREDDED HARDWOOD BARK MULCH, OR OTHER EQUIVALENT AS APPROVED BY THE LANDSCAPE ARCHITECT OR REPRESENTATIVE. KEEP MULCH AWAY FROM TRUNKS OF TREES AND OTHER PLANT MATERIALS.
- 15. NEW PLANTINGS AND TURF SHALL BE ADEQUATELY IRRIGATED OR WATERED THROUGHOUT ESTABLISHMENT.
- 16. UPON COMPLETION OF ALL PLANTING AND BEFORE FINAL ACCEPTANCE, THE CONTRACTOR SHALL REMOVE ALL MATERIAL, EQUIPMENT AND DEBRIS. ALL PAVED AREAS SHALL BE BROOM-SWEPT AND LEFT IN A NEAT CONDITION.
- 17. URBAN FORESTER NOTIFICATION: THE DEVELOPER AGREES TO NOTIFY THE URBAN FORESTER AT LEAST 72 HOURS IN ADVANCE OF THE INSTALLATION OF DRAINAGE, SPECIAL SOIL EXPANSION EQUIPMENT, TREE PIT CREATION, AND SCHEDULED PLANTING OF ANY TREES IN THE PUBLIC RIGHT OF WAY, AND TO BE AVAILABLE AT THE TIME OF PLANTING TO MEET WITH DPR STAFF TO INSPECT THE PLANT MATERIAL, TREE PIT AND PLANTING TECHNIQUES. SOIL USED IN THE TREE PIT MUST MEET THE SPECIFICATIONS FOR STREET TREE PLANTING IN THE "STANDARDS FOR PLANTING AND PRESERVATION OF TREES ON SITE PLAN PROJECTS" AVAILABLE FROM THE URBAN FORESTER.

ARLINGTON COUNTY LANDSCAPE STANDARDS REFERENCE GUIDE | PG, 36

LANDSCAPE MAINTENANCE MANAGEMENT PROGRAM

GENERAL:

A. ALL PLANTING AREAS, INCLUDING LAWNS, BUFFERS, AND PARKING LOTS, SHALL BE PERIODICALLY INSPECTED A MINIMUM OF ONCE PER MONTH. A FALL CLEAN-UP SHALL BE PERFORMED EACH YEAR.
B. REMOVE ALL LITTER, DEBRIS AND WEEDS.
C. MAINTAIN A MINIMUM OF A 2 INCH DEPTH OF ORGANIC HARDWOOD MULCH OR EQUIVALENT IN ALL

PLANTING BEDS.

2. IRRIGATION:

A. KEEP NEW TURF MOIST UNTIL ALL SEED GERMINATES AND BECOMES AN ESTABLISHED STAND OF TURF. B. AUTOMATIC SPRINKLERS SHALL BE CLEANED OUT AND TURNED OFF IN THE FALL PRIOR TO THE FIRST FROST, AND TESTED WHEN TURNED ON IN THE SPRING.

C. EVALUATE SUCCESS OF IRRIGATION SYSTEM AND MODIFY AS NECESSARY.

- 3. PRUNING: ALL PRUNING SHALL BE DONE IN ACCORDANCE WITH ANSI PRUNING STANDARDS. REMOVAL OF DEAD, DISEASED, INSECT INFESTED OR WEAK WOOD SHALL TAKE PLACE WHEN APPROPRIATE FOR THE SPECIES. THE VIRGINIA TECH PRUNING CALENDAR SHALL BE USED FOR GUIDANCE ON APPROPRIATE TIMING. EXCESSIVE SHOOTS AND SUCKERS SHALL BE REMOVED.
- INSECT AND DISEASE CONTROL: THE CONTROL OF INSECTS AND DISEASE ASSOCIATED WITH ALL PLANTING AREAS SHALL BE A MAINTENANCE PRIORITY. ALL PLANTINGS, INCLUDING EXISTING MATURE TREES, SHALL BE PERIODICALLY INSPECTED FOR INSECT OR DISEASE INFESTATION. METHODS USED TO CONTROL INSECTS OR DISEASE MAY RANGE FROM SPRAYING AND PRUNING TO PLANT REMOVAL. SAFETY AND CONTROL SHALL BE OF PRIME CONCERN. TRAINED AND CERTIFIED PERSONNEL SHALL PERFORM THESE TASKS.

RENOVATION

A. RENOVATION INCLUDES THE RESEEDING OR REPLANTING OF LANDSCAPE AREAS DAMAGED, DESTROYED OR FAILING DUE TO INSECTS, DISEASE, WEATHER OR PHYSICAL DAMAGE.

B. ALL LAWN AREAS WHERE SOIL HAS BEEN EXPOSED SHALL BE RENOVATED DURING THE NEXT PLANTING SEASON. PROPER HORTICULTURAL AND SOIL EROSION PREVENTION METHODS SHALL BE USED. IF SOIL EROSION HAS OCCURRED, THE AREA SHALL BE REPAIRED WITH A SEED MIXTURE COMPATIBLE WITH EXISTING SOIL.

C. ALL PLANTINGS WHICH ARE DAMAGED OR DESTROYED SHALL BE REPLACED DURING OR BEFORE THE NEXT GROWING SEASON.

D. CARE SHALL BE TAKEN TO AVOID DAMAGE TO ESTABLISHED TREE ROOTS DURING RENOVATION OF LANDSCAPE

6. SITE AMENITIES: BENCHES, PATHS, BICYCLE RACKS, TRASH RECEPTACLES, AND SIGNS SHALL BE INSPECTED AT LEAST TWICE A YEAR, ONCE IN SPRING AND ONCE IN AUTUMN, TO DETERMINE THEIR CONDITION. ANY DAMAGED, WORN, OR UNSAFE CONDITIONS SHALL BE RECTIFIED IMMEDIATELY.

PAVED SURFACES:

A. ALL PAVED SURFACES SHALL BE INSPECTED ON A MONTHLY-BASIS FOR TRASH, STAINS, DAMAGE, CRACKS, POT HOLES, AND OBSTRUCTIONS, AND RETURNED TO THEIR ORIGINAL CONDITIONS. ANY UNSAFE CONDITIONS, SUCH AS UNEVEN SURFACES OR TRIPPING HAZZARDS, SHALL BE RECTIFIED IMMEDIATELY.

ARLINGTON COUNTY LANDSCAPE STANDARDS REFERENCE GUIDE | PG, 37

MATTHEW V. CLARK
Lic. No. 952
09/12/2023

703.549.7784 WWW.LANDDESIGN.COM

NOT FOR CONSTRUCTION

PROJEC

SUNRISE LIVING OF SOUTH ARLINGTON

SUNRISE SENIOR LIVING

716 SOUTH GLEBE ROAD

ARLINGTON, VA 22204

LANDDESIGN PROJ.#

REVISION / ISSUANCE NO. DESCRIPTION DATE 1 4.1 SITE PLAN 1ST PRELIMINARY SUBMISSION 09/09/

 2
 4.1 SITE PLAN 2ND PRELIMINARY SUBMISSION
 12/02/2022

 3
 4.1 SITE PLAN 3RD PRELIMINARY SUBMISSION
 04/10/2023

 4
 4.1 SITE PLAN 4TH PRELIMINARY SUBMISSION
 06/01/2023

 5
 4.1 SITE PLAN PUBLIC HEARING SUBMISSION
 08/11/2023

5 4.1 SITE PLAN PUBLIC
HEARING SUBMISSION 08/11/2023
6 REVISED PUBLIC HEARING
SUBMISSION 09/12/2023

DESIGNED BY: JM
DRAWN BY: JM
CHECKED BY: AC

VERT: N/A


T TITLE

PLANTING NOTES

JMBER 1 _ 1 ∩ 2

9/11/2023 12:32:10 PM DAPHNE BRICE Z:\TEMPLATES\SHEETS\CD SHEETS\NOTES-24X36.DWT

ORIGINAL SHEET SIZE: 24" X 36"

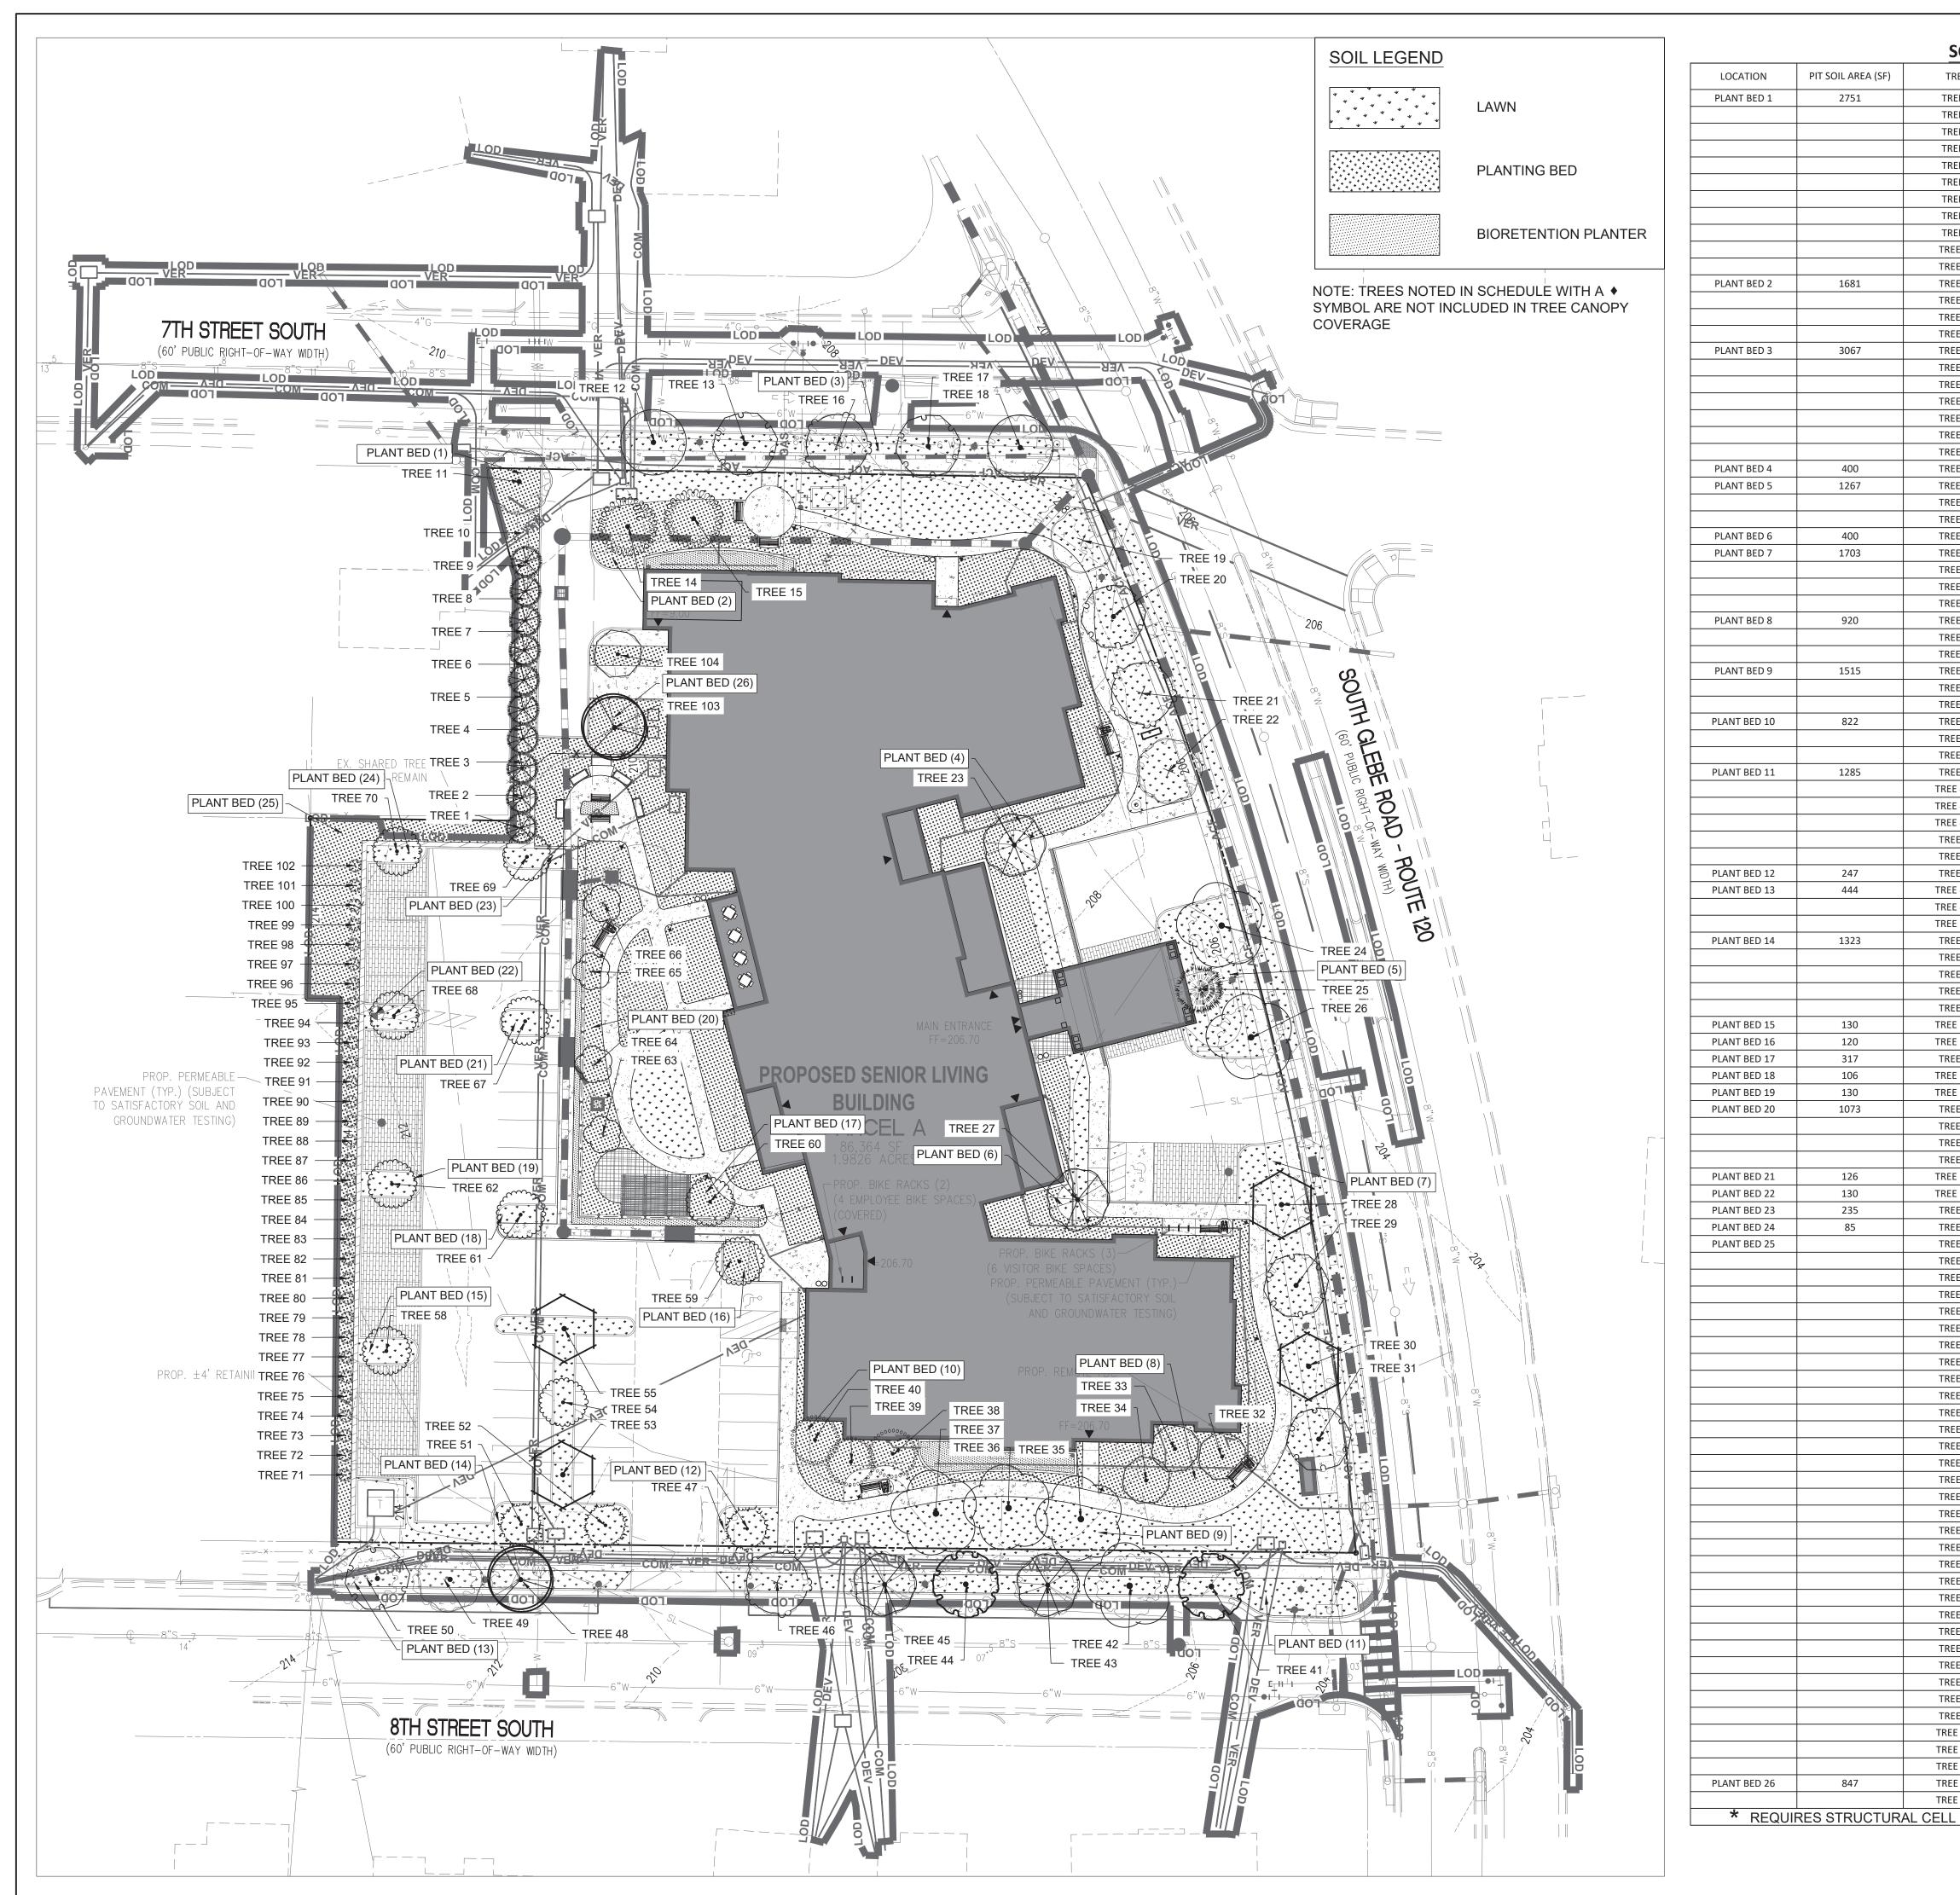

LOCATION	PIT SOIL AREA (SF)	TREE	TREE SOIL AREA (SF)	TREE SOIL VOLUME PROVIDED (3 FT DEPTH)	VOLUME REQUIREMENT (CU FT/TREE)	SIZE
PLANT BED 1	2751	TREE 1	143	429	900	MEDIUM
		TREE 2	111	333	900	MEDIUM
		TREE 3 TREE 4	144	432 372	900	MEDIUM
		TREE 5	124	372	900	MEDIUM
		TREE 6	124	372	900	MEDIUM
		TREE 7	124	372	900	MEDIUM
		TREE 8 TREE 9	124 154	372 462	900	MEDIUM MEDIUM
		TREE 10	273	819	900	MEDIUM
		TREE 11	348	1044	1000	LARGE
PLANT BED 2	1681	TREE 12	586	1758	1000	LARGE
		TREE 13 TREE 14	387 686	1161 2058	1000 700	LARGE MEDIUM
		TREE 15	653	1959	700	MEDIUM
PLANT BED 3	3067	TREE 16	821	2463	1000	LARGE
		TREE 17	842	2526	1000	LARGE
		TREE 18 TREE 19	765 553	2295 1659	1000	LARGE LARGE
		TREE 20	503	1509	1000	LARGE
		TREE 21	590	1770	1000	LARGE
PLANT BED 4	400	TREE 22 TREE 23	448	1344 1200	1000 1200	LARGE LARGE
PLANT BED 5	1267	TREE 24	400	1200	1000	LARGE
		TREE 25	463	1389	300	SMALL
		TREE 26	400	1200	1000	LARGE
PLANT BED 6	400	TREE 27	400	1200	1200	LARGE
PLANT BED 7	1703	TREE 28 TREE 29	405 584	1215 1752	1000	LARGE LARGE
		TREE 30	589	1767	1000	LARGE
		TREE 31	978	2934	1000	LARGE
PLANT BED 8	920	TREE 32	434	1302	700	MEDIUM
		TREE 33	613 471	1839 1413	700 700	MEDIUM MEDIUM
PLANT BED 9	1515	TREE 35	843	2529	1000	LARGE
		TREE 36	766	2298	1000	LARGE
DI ANT DED 40	022	TREE 37	672	2016	1000	LARGE
PLANT BED 10	822	TREE 38 TREE 39	378 440	1134 1320	700 700	MEDIUM MEDIUM
		TREE 40	372	1116	700	MEDIUM
PLANT BED 11	1285	TREE 41	564	1692	1000	LARGE
		TREE 42 * ◆	326	978	1000	LARGE
		TREE 43 * ◆ TREE 44 * ◆	326 321	978 963	1000	LARGE LARGE
		TREE 45	379	1137	1000	LARGE
		TREE 46	374	1122	1000	LARGE
PLANT BED 12	247	TREE 47	247	741	600	SMALL
PLANT BED 13	444	TREE 48 * ◆ TREE 49 * ◆	307 285	921 855	1000	LARGE LARGE
		TREE 50 * ◆	204	612	1000	LARGE
PLANT BED 14	1323	TREE 51	701	2103	700	MEDIUM
		TREE 52	470	1410	700	MEDIUM
		TREE 53 TREE 54	521 250	1563 750	1000 700	LARGE MEDIUM
		TREE 55	513	1539	1000	LARGE
PLANT BED 15	130	TREE 58 * ◆	130	390	700	MEDIUM
PLANT BED 16	120	TREE 59 * ◆	120	360	700	MEDIUM
PLANT BED 17 PLANT BED 18	317 106	TREE 60 TREE 61 *	317 106	951 318	700 700	MEDIUM MEDIUM
PLANT BED 19	130	TREE 62 *	130	390	700	MEDIUM
PLANT BED 20	1073	TREE 63	396	1188	700	MEDIUM
		TREE 64	356	1068	700	MEDIUM
		TREE 65 TREE 66	323 443	969 1329	700 700	MEDIUM MEDIUM
PLANT BED 21	126	TREE 67 *	126	378	700	MEDIUM
PLANT BED 22	130	TREE 68 *	130	390	700	MEDIUM
PLANT BED 23	235	TREE 69	235	705	700	MEDIUM
PLANT BED 24 PLANT BED 25	85	TREE 70 TREE 71	85 96	255 288	700 300	MEDIUM SMALL
. EARL DED Z3		TREE 72 ♦	96	288	300	SMALL
		TREE 73 ♦	96	288	300	SMALL
		TREE 74 ♦	96	288	300	SMALL
		TREE 75 ♦ TREE 76 ♦	96 96	288	300 300	SMALL
		TREE 76 ♦ TREE 77 ♦	96	288	300	SMALL SMALL
		TREE 78 ♦	96	288	300	SMALL
		TREE 79 ♦	96	288	300	SMALL
		TREE 80 ♦	96	288	300	SMALL
		TREE 81 ♦ TREE 82 ♦	96 96	288 288	300 300	SMALL SMALL
		TREE 83 ♦	96	288	300	SMALL
		TREE 84 ♦	96	288	300	SMALL
		TREE 85 ♦	96	288	300	SMALL
		TREE 86 ♦ TREE 87 ♦	96 96	288	300 300	SMALL SMALL
		TREE 88	96	288	300	SMALL
		TREE 89	96	288	300	SMALL

TREE 89 ♦

TREE 90 ♦

TREE 91 ♦

TREE 92 ♦

TREE 93 ♦

TREE 94 ♦

TREE 95 ♦

TREE 96 ♦

TREE 97

TREE 98

TREE 99

TREE 100

TREE 101

TREE 102

TREE 103

TREE 104

96

96

96

176

190

190

190

190

190


323

323

626

437

200 S. PEYTON STREET ALEXANDRIA, VA 22314 703.549.7784 WWW.LANDDESIGN.COM

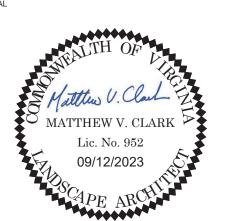

NOT FOR CONSTRUCTION

SUNRISE LIVING OF SOUTH ARLINGTON

SUNRISE SENIOR LIVING 716 SOUTH GLEBE ROAD ARLINGTON, VA 22204

	2022139	
F	REVISION / ISSUA	NCE
NO.	DESCRIPTION	DATE
1	4.1 SITE PLAN 1ST PRELIMINARY SUBMISSION	09/09/2022
2	4.1 SITE PLAN 2ND PRELIMINARY SUBMISSION	12/02/2022
3	4.1 SITE PLAN 3RD PRELIMINARY SUBMISSION	04/10/2023
4	4.1 SITE PLAN 4TH PRELIMINARY SUBMISSION	06/01/2023
5	4.1 SITE PLAN PUBLIC HEARING SUBMISSION	08/11/2023
6	REVISED PUBLIC HEARING SUBMISSION	09/12/2023
DR	SIGNED BY: JM AWN BY: JM IECKED BY: AC	

SOILS PLAN

L-404

300

300

1000

900

288

288

288

288

288

528

570

570

570

570

570

969

969

1878

1311

SMALL

SMALL

SMALL

SMALL

SMALL

SMALL

SMALL SMALL

SMALL

SMALL

SMALL

SMALL

SMALL

SMALL

LARGE

MEDIUM



NOTE: OR CLIENT/COUNTY APPROVED

1 CONCRETE PAVING
L-501 PICTORIAL


N/A



NOTE: OR CLIENT/COUNTY APPROVED EQUAL

1" = 1' - 0"

2 ENHANCED PAVING
L-501 PICTORIAL

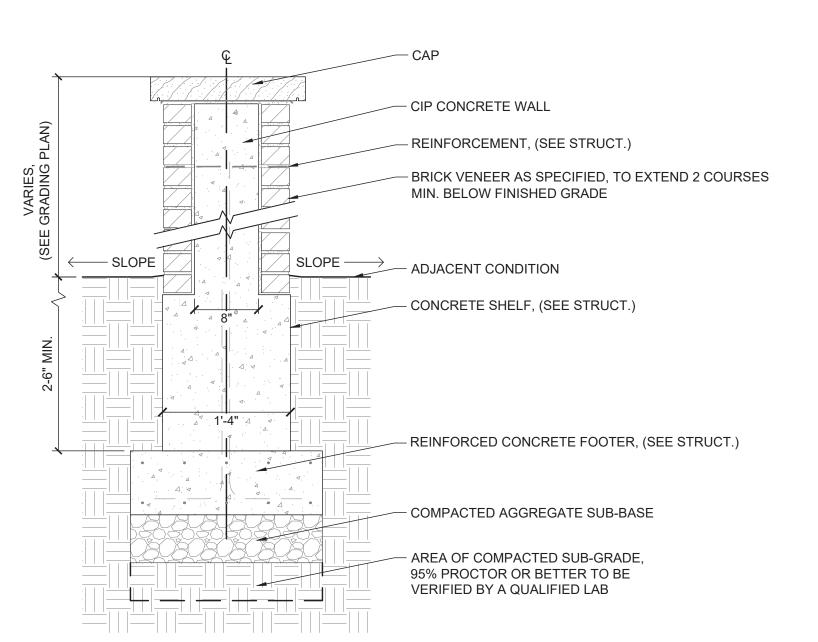


3 FREE-STANDING WALL
L-501 SECTION

— ROOF DOWNSPOUT (PER ARCHITECTURAL PLANS) STORM DRAINAGE, TOP — **ELEVATION SET AT 6"** PONDING DEPTH 6" PONDING - WATERPROOFING APPLIED ABOVE ___ STONE SPLASH BLOCK STRUCTURAL SLAB (SEE ARCHITECTURAL DRAWINGS) DEPTH — ADJACENT PAVEMENT CLEAN WASHED GRAVELE STRUCTURAL SLAB (SEE ARCHITECTURAL DRAWINGS) - TIE-IN TO PROPOSED STORM SEWER PERFORATED UNDERDRAIN PIPE TO COMPLY — WITH VIRGINIA DEQ STORMWATER DESIGN SPECIFICATION FOR BIORETENTION MATERIAL

4 BIORETENTION PLANTER

L-501 SECTION 3/4" = 1'

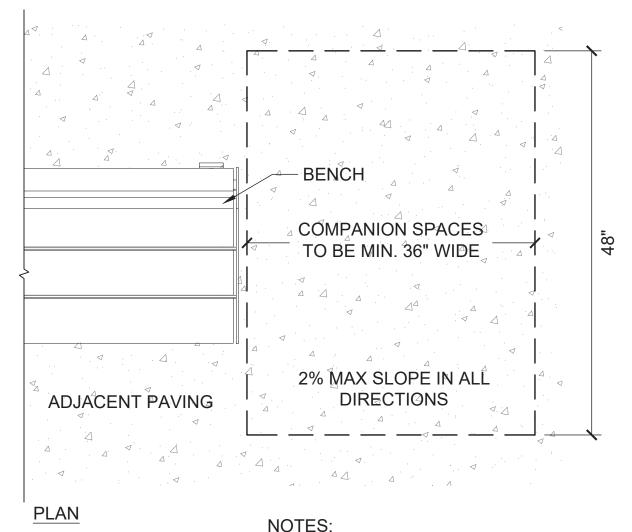

1. ANCHORING PROCEDURE IS THE RESPONSIBILITY OF THE INSTALLER.

2. INSTALL PER MANUFACTURER'S SPECIFICATIONS.


5 BENCH COMPANION SPACE
L-501 SECTION

1" = 1' - 0"

LandDesign.

200 S. PEYTON STREET ALEXANDRIA, VA 22314 703.549.7784 WWW.LANDDESIGN.COM

MAP

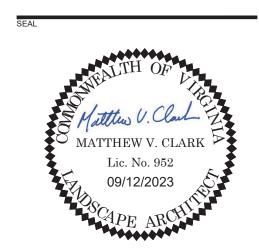

NOT FOR CONSTRUCTION

SUNRISE LIVING

OF SOUTH ARLINGTON

SUNRISE SENIOR LIVING
716 SOUTH GLEBE ROAD
ARLINGTON, VA 22204

2 4.1 SITE PLAN 2ND
PRELIMINARY SUBMISSION 12/02/2022
3 4.1 SITE PLAN 3RD
PRELIMINARY SUBMISSION 04/10/2023
4 4.1 SITE PLAN 4TH
PRELIMINARY SUBMISSION 06/01/2023
5 4.1 SITE PLAN PUBLIC
HEARING SUBMISSION 08/11/2023


5 4.1 SITE PLAN PUBLIC HEARING SUBMISSION 08/11/202
6 REVISED PUBLIC HEARING SUBMISSION 09/12/202

DESIGNED BY: JM
DRAWN BY: JM
CHECKED BY: AC

VERT: N/A HORZ: AS NOTED

HEETTIILE

DETAILS - HARDSCAPE

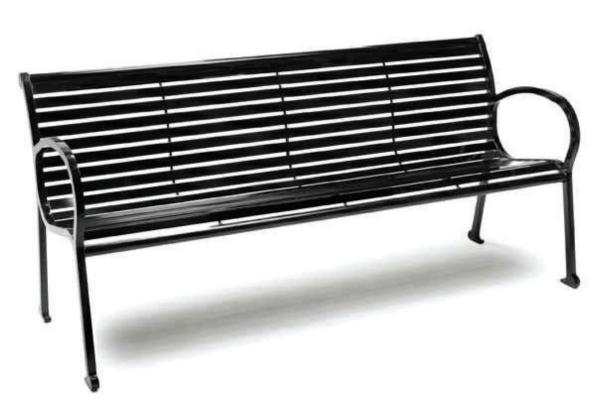

 LANDSCAPE FORMS 2. SCARBOROUGH 3. OR APPROVED EQUAL



VEG TRUG
 OR APPROVED EQUAL



KNOLL 1966 DINING SET
 OR APPROVED EQUAL

4 SEAT TABLE L-502 PICTORIAL

BENCH


L-502 PICTORIAL

 LANDSCAPE FORMS SCARBOROUGH

3. OR APPROVED EQUAL 2 TRASH AND RECYCLING RECEPTACLES

 JERITH 2. INDUSTRIAL STYLE 202 3. OR APPROVED EQUAL

NOTES:

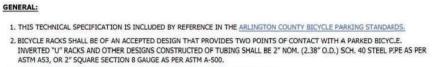

3. TOP OF INSTALLED BICYCLE RACKS SHALL BE MINIMUM 33" ABOVE FINISHED GRADE.

RAISED PLANTER

L-502 PICTORIAL

4. BICYCLE RACKS SHALL BE INSTALLED USING THE FOLLOWING OPTIONS ONLY: a. FLANGE-MOUNTED TO CURED CONCRETE

b. IN-GROUND (ANCHORED IN NEW CONCRETE) c. MOUNTED ON RAILS MOUNTED TO CURED CONCRETE OR ASPHALT

 IF MULTIPLE RACKS ARE INSTALLED, THEY SHALL BE UNIFORMLY ALIGNED, AND EVENLY SPACED. FOR LAYOUT PURPOSES, EACH BICYCLE RACK SHALL BE CENTERED IN A "DESIGN STALL" OF MINIMUM DIMENSION 36" X 72". 6. ACCEPTABLE MATERIALS AND COATINGS. PIPE (AND FLANGES, RAILS, ANCHOR PINS, SHIMS, AND FASTENERS, IF APPLICABLE) SHALL BE HOT-DIP GALVANIZED (HDG) AS PER ASTM A123 AND A304; OR STAINLESS STEEL AS PER ASTM A666 AND A240. BICYCLE RACKS MAY BE POWDER COATED OVER HDG AS PER ASTM D 7803, OR THERMOPLASTIC COATED AS APPROVED BY THE COUNTY. COATING MUST BE COMPLETE, I.E., DIPPED OR COMPLETELY POWDER COATED.

7. BICYCLE RACKS SHALL BE ANCHORED FIRMLY, AND INSTALLED VERTICAL (PLUMB) IN TWO PLANES. 8. NO COMPONENT OF THE INSTALLED BICYCLE RACK SHALL RESULT IN A TRIPPING HAZARD. 9. BICYCLE RACKS SHALL NOT BE MOUNTED DIRECTLY TO UNIT PAVERS ONLY.

10. FASTENERS WHEN USED SHALL: a. BE OF ACCEPTABLE MATERIAL AND COATING.

b. MEET ONE OF THE FOLLOWING REQUIREMENTS

TYPE	SPECIFICATION	MINIMUM SIZE	MINIMUM INSTALLATION DEPTH	ACCEPTABLE EMBEDMENT MATERIAL
THREADED	ASME B18.18:2017	3/8"	AS NECESSARY	METAL TO METAL. TAMPER RESISTANT NUTS REQUIRED.
FRICTION	A-A-1925a, ASTM E 488	3/8"	3"	CONCRETE
MECHANICALLY EXPANDED	A-A-55614, ASTM E 488	3/8"	3.5"	CONCRETE
ADHESIVE BONDED	ASTM C 881, ASTM E1512	3/8"	6"	CONCRETE, ASPHALT

c. BE ABLE TO PROVIDE FIRM, SECURE ANCHORING WITH A MAXIMUM OF ¼-INCH NON-TRIP HAZARD PROJECTION ABOVE FINISHED GRADE. d. BE THREADED OR DRIVEN ANCHORS. THREADED FASTENERS TO BE FIXED WITH TAMPER-RESISTANT NUTS AS APPROVED BY THE COUNTY.

GENERAL NOTES FOR BICYCLE RACK

NOTES:

FLANGE MOUNTED INSTALLATION:

N/A

1. FLANGE MOUNTED RACKS SHALL BE INSTALLED ON EXISTING CURED CONCRETE. USE FLANGE RACKS WITH FASTENERS AS SPECIFIED ABOVE. EXISTING CONCRETE SHALL CONFORM TO CONCRETE SIDEWALK STD., ARLINGTON COUNTY CONSTRUCTION SPECIFICATION SECTION 02611, AND STD. DWG. R-2.0 (MIN. 4" THICKNESS).

2. RACK LEGS SHALL BE WELDED TO FLANGES WITH COMPLETE SEANLESS CONTINUOUS FILLET WELDS CONFORMING TO ASTM A36, ASTM A312, AND AWS D1.1. SPOT, TACK, OR INTERMITHENT WELDING IS NOT ACCEPTABLE.

3. FLANGES SHALL BE MINIMUM 3/8" THICK, WITH MINIMUM TWO ½" DIA. HOLES (TWO FASTENERS) PER FLANGE.

4. FLANGE MOUNTED RACKS SHALL NOT BE BOLTED TO UNIT PAVERS.

5. WHERE CONCRETE PAVERS OR FIRED CLAY BRICK ARE INSTALLED OVER CONTINUOUS CONCRETE SUB-BASE, FLANGE-MOUNTED RACKS SHALL BE INSTALLED ON CONCRETE SUB-BASE. INSTALLATION MUST NOT COMPROMISE ANY WATERPROOFING OF CONCRETE. (FOR EXAMPLE, INSTALLATION ABOVE UNDERGROUND PARKING STRUCTURE.)

6. UNIT PAVERS SHALL BE INSTALLED IN ACCORDANCE WITH ARLINGTON COUNTY CONSTRUCTION SPECIFICATION SECTION 02612.

7. UNIT PAYERS SHALL BE NEATLY CUT AND FIT AROUND FLANGES, FASTENERS, AND LEGS OF RACK.

 LEGS OF FLANGE MOUNTED RACKS SHALL BE OF SUFFICIENT LENGTH TO PROVIDE MINIMUM ACCEPTABLE HEIGHT OF 33"
ABOVE FINISH GRADE. IN-GROUND RACK INSTALLATION:

1. LEGS OF IN-GROUND RACKS SHALL BE FITTED WITH ANCHOR PINS TO PREVENT LIFT-OUT. ANCHOR PINS SHALL BE:

a. OF ACCEPTABLE MATERIAL. b. MIN. 3/8" DIAMETER WITH MIN. 3" CONCRETE ENCASEMENT. IN-GROUND RACKS SHALL BE INSTALLED AND FIRMLY ANCHORED IN NEW CONCRETE OF MINIMUM DIMENSIONS SHOWN.
ANCHORED PORTIONS OF RACK SHALL HAVE MIN. 3" CONCRETE ENCASEMENT ON ALL SIDES.
 FOR RACK INSTALLATIONS ON SITES WITH CONCRETE PAVERS OR FIRED CLAY BRICK INSTALLED <u>OVER COMPACTED SCIL</u>
SUB-BASE AND SAND LEVELING COURSE AS PER ARLINGTON COUNTY STANDARD SPECIFICATIONS SECTION 02612, AND
STANDARD DWG. R-2.1, RACKS SHALL BE INSTALLED IN CONCRETE FOOTING OF DIMENSIONS SHOWN.

 WHERE IN-GROUND RACKS ARE INSTALLED IN UNPAYED SOIL, OR SOD/GRASS/TURF, PROVIDE A SINGLE CONCRETE FOOTING OF DIMENSIONS SHOWN. PROVIDE A TAMPED GRAVEL PAD MIN. 4" THICKNESS, AND MIN. 36" X 72" CENTERED ON EACH INSTALLED RACK. 5. LEGS OF IN-GROUND RACKS SHALL BE OF SUFFICIENT LENGTH TO PROVIDE ANCHORING BELOW GRADE A MINIMUM OF 9"
AND BE A MINIMUM HEIGHT OF 33" ABOVE FINISH GRADE.

RAILS SHALL BE TYPE AISI C3 X 4.1 STEEL CHANNEL AS PER ASTM A36, HDG, OR POWDER COATED OVER HDG TO MATCH RACKS. RACKS.

3. INDIVIDUAL RACKS CAN BE WELDED TO RAILS. WELDS SHALL BE COMPLETE SEAMLESS CONTINUOUS FILLET WELDS CONFORMING TO ASTM A36, ASTM A312 AND AWS D1.1. SPOT, TACK, OR INTERMITTENT WELDING IS NOT ACCEPTABLE.

4. INDIVIDUAL RACKS CAN BE BOLTED TO RAILS.

5. IF RACKS ARE BOLTED TO RAILS, FASTENERS SHALL BE:


a. OF ACCEPTABLE MATERIAL.

b. MIN. 3/8" DIAMETER. c. ABLE TO PROVIDE FIRM, SECURE ANCHORING WITH THREADED NUTS ON UNDERSIDE OF STEEL CHANNEL. d. FITTED WITH TAMPER- RESISTANT THREADED NUTS AS APPROVED BY THE COUNTY. RACKS ON RAILS MAY BE APPROVED FOR INSTALLATION ON FINISHED ASPHALT. IN SUCH CASES, A PERMANENTLY GROUTED INTERNALLY THREADED ASPHALT ANCHOR AS APPROVED BY THE COUNTY SHALL BE USED TO PROVIDE ATTACHMENT.

SITE APPLICATION NOTES FOR BICYCLE RACK INSTALLATION ARLINGTON COUNTY, VIRGINIA DRAWING NO. A R L I N G TO N

DEPARTMENT OF ENVIRONMENTAL SERVICES


OF THE PROPERTY OF THE R-8.1

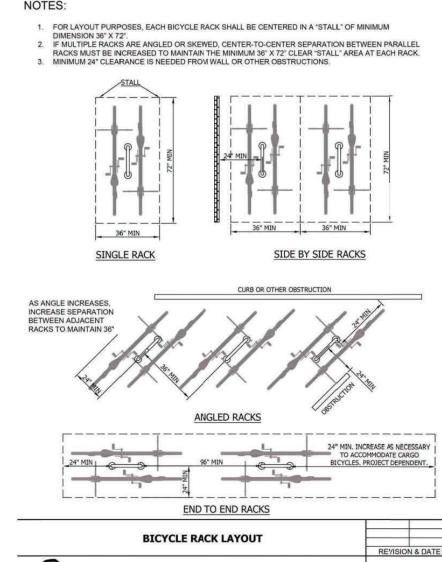

ARLINGTON COUNTY, VIRGINIA

R-8.2

A R L I N G T O N DEPARTMENT OF ENVIRONMENTAL SERVICES

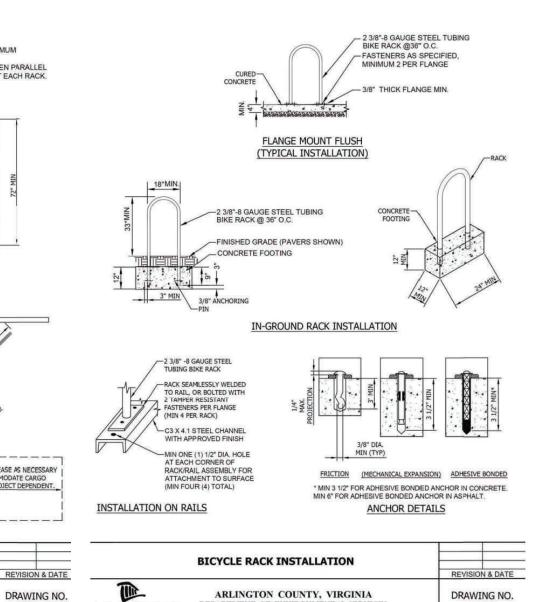

A R LING TO N DEPARTMENT OF ENVIRONMENTAL SERVICES

200 S. PEYTON STREET ALEXANDRIA, VA 22314 703.549.7784 WWW.LANDDESIGN.COM

NOT FOR CONSTRUCTION

SUNRISE LIVING OF SOUTH ARLINGTON

SUNRISE SENIOR LIVING 716 SOUTH GLEBE ROAD ARLINGTON, VA 22204

ANDDES	SIGN PROJ.# 2022139	
F	REVISION / ISSUA	NCE
NO.	DESCRIPTION	DA
1	4.1 SITE PLAN 1ST PRELIMINARY SUBMISSION	09/09/
2	4.1 SITE PLAN 2ND PRELIMINARY SUBMISSION	12/02/
3	4.1 SITE PLAN 3RD PRELIMINARY SUBMISSION	04/10/
4	4.1 SITE PLAN 4TH PRELIMINARY SUBMISSION	06/01/
5	4.1 SITE PLAN PUBLIC HEARING SUBMISSION	08/11/
6	REVISED PUBLIC HEARING SUBMISSION	09/12/

CHECKED BY: AC

VERT: N/A HORZ: AS NOTED

DETAILS - SITE FURNISHINGS

L-502

3 PERGOLA

 VIXEN HILL CUSTOM


3. OR APPROVED EQUAL

L-502 STANDARD DETAILS

9/11/2023 12:32:36 PM DAPHNE BRICE Z:\TEMPLATES\SHEETS\CD SHEETS\NOTES-24X36.DWT

NTS

R-8.3

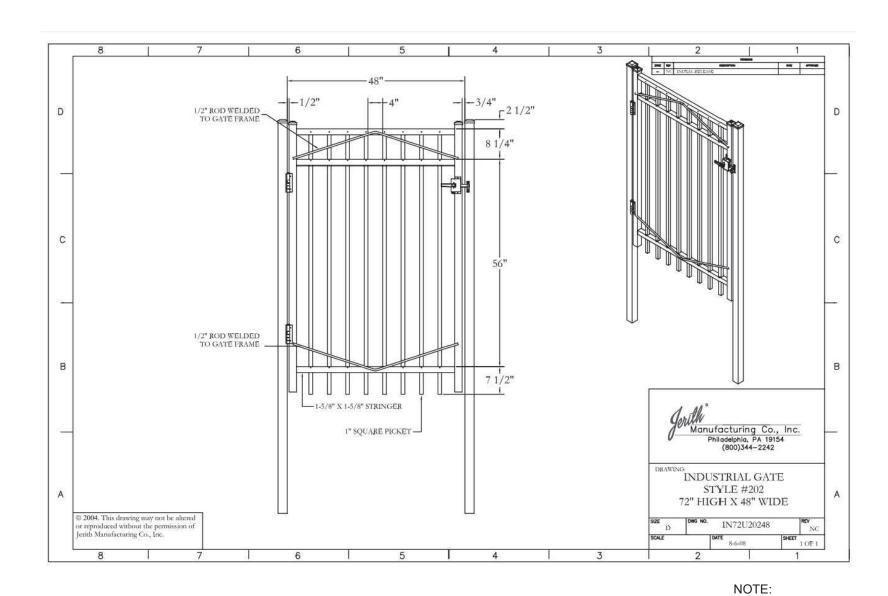

1 GATE
L-503 PICTORIAL

1. JERITH
2. INDUSTRIAL GATE
3. STYLE #202
4. OR APPROVED EQUAL

NAFFROVED EQUAL

NTS



200 S. PEYTON STREET ALEXANDRIA, VA 22314 703.549.7784 WWW.LANDDESIGN.COM

EY MAP

MATTHEW V. CLARK
Lic. No. 952
09/12/2023
CAPE ARCHITECTURE

CAPE ARCHITECTURE

DESCRIPTION OF THE PROPERTY OF

NOT FOR CONSTRUCTION

PROJECT

SUNRISE LIVING OF SOUTH ARLINGTON


SUNRISE SENIOR LIVING
716 SOUTH GLEBE ROAD
ARLINGTON, VA 22204

DESIGNED BY: JM
DRAWN BY: JM
CHECKED BY: AC

VERT: N/A

HORZ: AS NOTED


DETAILS - SITE FURNISHINGS

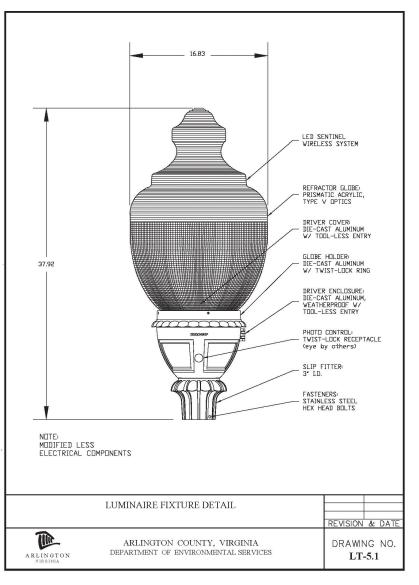

1 SINGLE LIGHT FIXTURE

L-504 PICTORIAL

N/A

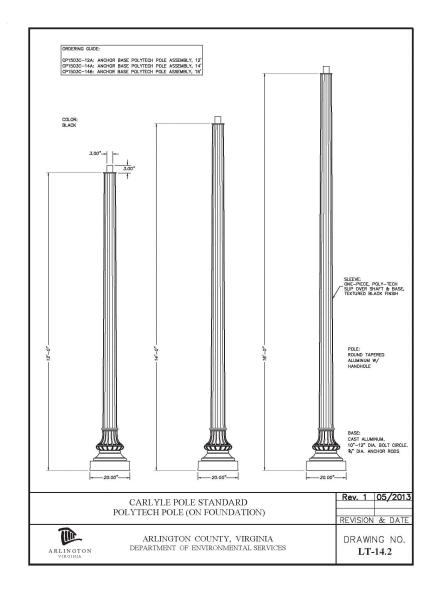

2 SINGLE LIGHT POST L-504 PICTORIAL

N/A



NOTE:
1. LANDSCAPE FORMS ASHBERY PATH LIGHT
2. OR APPROVED EQUAL



3 PATHWAY LIGHT BOLLARD
L-504 PICTORIAL

N/A

LandDesign.

200 S. PEYTON STREET ALEXANDRIA, VA 22314 703.549.7784 WWW.LANDDESIGN.COM

EV MAD

MATTHEW V. CLARK

Lic. No. 952

09/12/2023

CAPE ARCHITICAL

NOT FOR CONSTRUCTION

SUNRISE LIVING

OF SOUTH ARLINGTON


SUNRISE SENIOR LIVING
716 SOUTH GLEBE ROAD
ARLINGTON, VA 22204

DESIGNED BY: JM
DRAWN BY: JM
CHECKED BY: AC

VERT: N/A

HORZ: AS NOTED

DETAILS - LIGHTING

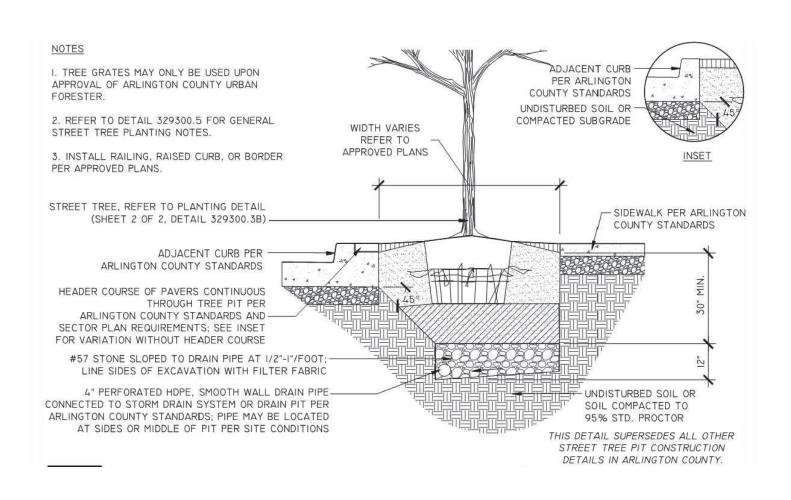

CENTER TREE IN PIT AND SET TOP OF ROOT BALL 2 IN. ABOVE ADJACENT SOIL. I. REFER TO STREET TREE PIT DETAIL THE TRUNK FLARE SHALL BE VISIBLE AT THE TOP OF THE ROOT BALL. DO NOT (329300.3A) FOR PIT CONSTRUCTION AND COVER THE TOP OF THE ROOT BALL INFORMATION ON ADJACENT PAVEMENTS, CURB, AND DRAINAGE. 2. REFER TO DETAIL 329300.5 FOR GENERAL TREE PLANTING NOTES. -SHREDDED HARDWOOD MULCH; MULCH MUST BE 6" AWAY FROM TREE TRUNK 3. MOUND SOIL ABOVE SIDEWALK GRADE TO ALLOW FOR SOIL TO SETTLE OVER TIME. REMOVE ALL TWINE, ROPE, WIRE, AND BURLAP FROM TOP 2/3 OF ROOT BALL BACKFILL SOIL MIXTURE FOR ENTIRE TREE PIT AREA; COMPACT TO 80-85% STD. PROCTOR IN 8" LIFTS; DO NOT THIS DETAIL SUPERSEDES ALL OTHER STREET TREE PLANTING DETAILS IN ARLINGTON COUNTY. COMPACT ROOTBALL - COMPACT BACKFILL SOIL MIXTURE TO 95% STD. PROCTOR BELOW ROOT BALL ONLY

STREET TREE PLANTING

L0601 SECTION

NOTES
I. AT PLANTING PRUNE ONLY CROSSING LIMBS, BROKEN ALL PLANTS MUST BE WATERED TWICE: ONCE AT INSTALLATION AND AGAIN WITHIN OR DEAD BRANCHES, AND ANY BRANCHES THAT POSE A 48-HOURS OF INSTALLATION, HAZARD TO PEDESTRIANS PER ANSI STANDARD A300. DO PER THE SPECIFICATIONS. NOT PRUNE INTO OLD WOOD ON EVERGREENS. 2. CONTRACTOR SHALL MAXIMIZE EXCAVATED AREA FOR TREE PIT WITHOUT ADVERSELY IMPACTING ADJACENT THIS DETAIL SUPERSEDES ALL SITE FEATURES. OTHER TREE PLANTING DETAILS IN ARLINGTON COUNTY. 3. UNLESS OTHERWISE DIRECTED BY ARLINGTON COUNTY URBAN FORESTER, BACKFILL SOIL MIXTURE WILL BE 3/4 EXISTING SOIL CLEANED OF DEBRIS (GRAVEL, ROCKS, STICKS, TRASH, ETC.) AND MIXED WITH 1/4 ORGANIC CENTER TREE IN PIT AND SET TOP OF MATERIAL (COMPOSTED BARK, LEAF MOLD, OR OTHER ROOT BALL 2 IN. ABOVE ADJACENT GRADE. PLANT DEBRIS PROCESSED TO A POINT OF DECAY AND THE TRUNK FLARE SHALL BE VISIBLE AT THE APPROVED BY THE URBAN FORESTER; PEAT MOSS SHALL TOP OF THE ROOT BALL. DO NOT COVER NOT BE USED). THE TOP OF THE ROOT BALL WITH SOIL. MULCH RING 4. CONTRACTOR SHALL LEGALLY REMOVE EXCESS SOIL (6 FT.) DIAM. MIN. & DEBRIS FROM SITE. 5. TREES PLANTED WITHOUT THE TRUNK FLARE 3"-0" VISIBLE WILL BE REJECTED. - 4 IN. HIGH EARTH SAUCER BEYOND EDGE OF ROOT BALL 6. TREES MAY ONLY BE STAKED IF REQUIRED BY THE COUNTY URBAN FORESTER. REFER TO STAKING - REMOVE ALL TWINE, ROPE, WIRE, MAHAMA AND BURLAP FROM TOP 2/3 OF 3 IN. SHREDDED HARDWOOD MULCH; - TAMP SOIL AROUND ROOT BALL BASE MULCH MUST BE 6 IN. FIRMLY WITH FOOT PRESSURE SO AWAY FROM TREE TRUNK -THAT ROOT BALL DOES NOT SHIFT ROUGHEN SIDES OF PLANTING HOLE -- UNDISTURBED SUBGRADE BACKFILL SOIL MIXTURE FOR MIN WIDTH OF TREE PIT 2 TIMES ROOTBALL DIAMETER OR ENTIRE TREE PIT AREA X ROOTBALL DEPTH

5'-0", WHICHEVER IS GREATER

TYPICAL SIGNAGE (SEE ENLARGEMENT) TREE PRESERVATION LINK FABRIC CALL: 703-228-6557 TO REPORT VIOLATIONS PIPE 2" O.D.-LVANIZED STEEL PROHIBIDO ENTRAR ONA DE PROTECTION DEL ARBO LLAMAR AL TEL. 703-228-6557 . TREE PROTECTION FENCE (TPF) SHALL BE INSTALLED PRIOR TO ANY SITE WORK, CLEARING OR DEMOLITION. ARLINGTON COUNTY URBAN FORESTER SHALL BE NOTIFIED 7 HOURS PRIOR TO INSTALLATION OR ANY OTHER TREE PRESERVATION MEASURE SPECIFIED IN PLANS AND SHALL APPROVE LAYOUT 2. NO PERSONNEL, VEHICLES, EQUIPMENT, CONSTRUCTION MATERIALS OR DEBRIS ALLOWED IN TREE PROTECTION AREAS WITHOUT WRITTEN CONSENT OF ARLINGTON COUNTY URBAN 3. REMOVE TPF ONLY WITH APPROVAL FROM ARLINGTON COUNTY URBAN FORESTER AFTER ALL SITE WORK HAS BEEN ELEVATION 4. SIGN MATERIAL TO BE WEATHER RESISTANT.

NTS

NTS

TREE PLANTING

L0601 SECTION

SOIL SHALL BE FIRMED IN 8" LIFTS -

NOTES

I. AT PLANTING PRUNE ONLY BROKEN OR DEAD BRANCHES ₹ 3' MIN. - ₹ PER ANSI 300 STANDARD. 2. PLANTING PIT/TRENCH SHALL BE DUG DEEP ENOUGH TO SHRUB ALLOW AT LEAST I/8TH OF ROOT BALL TO SET ABOVE EXISTING GRADE. 3. SET PLANTS IN ERECT, STABLE, AND UNIFORM PARKING LOT POSITIONS IN THE CENTER OF THE PLANTING PIT. ORIENT BEST FACE OF PLANT TO BE THE MOST VISIBLE. TYPICAL SHRUB PLACEMENT NEAR PARKING LOTS NOT TO SCALE 4. UNLESS OTHERWISE DIRECTED BY COUNTY URBAN FORESTER, BACKFILL SOIL MIXTURE WILL BE 3/4 EXISTING SOIL CLEANED OF DEBRIS (GRAVEL, ROCKS, STICKS, TRASH, ETC.) AND MIXED WITH I/4 ORGANIC MATERIAL (COMPOSTED PLANTING PLAN BARK, LEAF MOLD, OR OTHER PLANT DEBRIS PROCESSED TO & PLANT LIST A POINT OF DECAY AND APPROVED BY THE COUNTY URBAN FOR SPACING - PLACE TOP I/8 OF ROOT BALL FORESTER. PEAT MOSS MAY NOT BE USED). ABOVE FINISHED GRADE (TYP.) 5. CONTRACTOR SHALL REMOVE EXCESS SOIL & DEBRIS FROM SITE. - 3" SHREDDED HARDWOOD MULCH OVER ENTIRE SHRUB BED 6. DO NOT PLACE MULCH IN CONTACT - FINISHED GRADE WITH STEM OF SHRUBS THIS DETAIL SUPERSEDES ALL - BACKFILL SOIL MIXTURE (TYP.) OTHER SHRUB PLANTING -FOR CONTAINER: DETAILS IN ARLINGTON COUNTY. LOOSEN THE ROOT BALL OF ANY ROOT BOUND PLANTS ALL PLANTS MUST BE WATERED TWICE: UNDISTURBED SUBGRADE OR ONCE AT INSTALLATION AND AGAIN 1 2 X WIDTH COMPACTED BACKFILL SOIL MIXTURE WITHIN 48-HOURS OF INSTALLATION, PER THE SPECIFICATIONS. OF ROOT BALL REMOVE ALL TWINE, ROPE, WIRE, AND BURLAP (TYP.) FROM TOP 2/3 OF ROOT BALL

3 SHRUB PLANTING L0601 SECTION

NTS

NTS

PROTECTION FENCE

200 S. PEYTON STREET ALEXANDRIA, VA 22314 703.549.7784 WWW.LANDDESIGN.COM

MATTHEW V. CLARK 09/12/2023

NOT FOR CONSTRUCTION

SUNRISE LIVING

OF SOUTH ARLINGTON

SUNRISE SENIOR LIVING 716 SOUTH GLEBE ROAD ARLINGTON, VA 22204

2022139 REVISION / ISSUANCE DESCRIPTION 09/09/2022

PRELIMINARY SUBMISSION 4.1 SITE PLAN 2ND 2 PRELIMINARY SUBMISSION 4.1 SITE PLAN 3RD 3 PRELIMINARY SUBMISSION 4.1 SITE PLAN 4TH 4 PRELIMINARY SUBMISSION 4.1 SITE PLAN PUBLIC 08/11/2023 HEARING SUBMISSION REVISED PUBLIC HEARING SUBMISSION

DESIGNED BY: JM DRAWN BY: JM CHECKED BY: AC

VERT: N/A HORZ: AS NOTED

PLANTING DETAILS