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- L-602 DETAILS - PLANTING ON STRUCTURE
- L-701 DETAILS - SECTIONS

# 4.1 SITE PLAN SUBMISSION - OCTOBER 29, 2024



**RPC #15-012-041**

# 3130 LANGSTON BLVD.

ARLINGTON COUNTY, VIRGINIA

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SHEET A-00













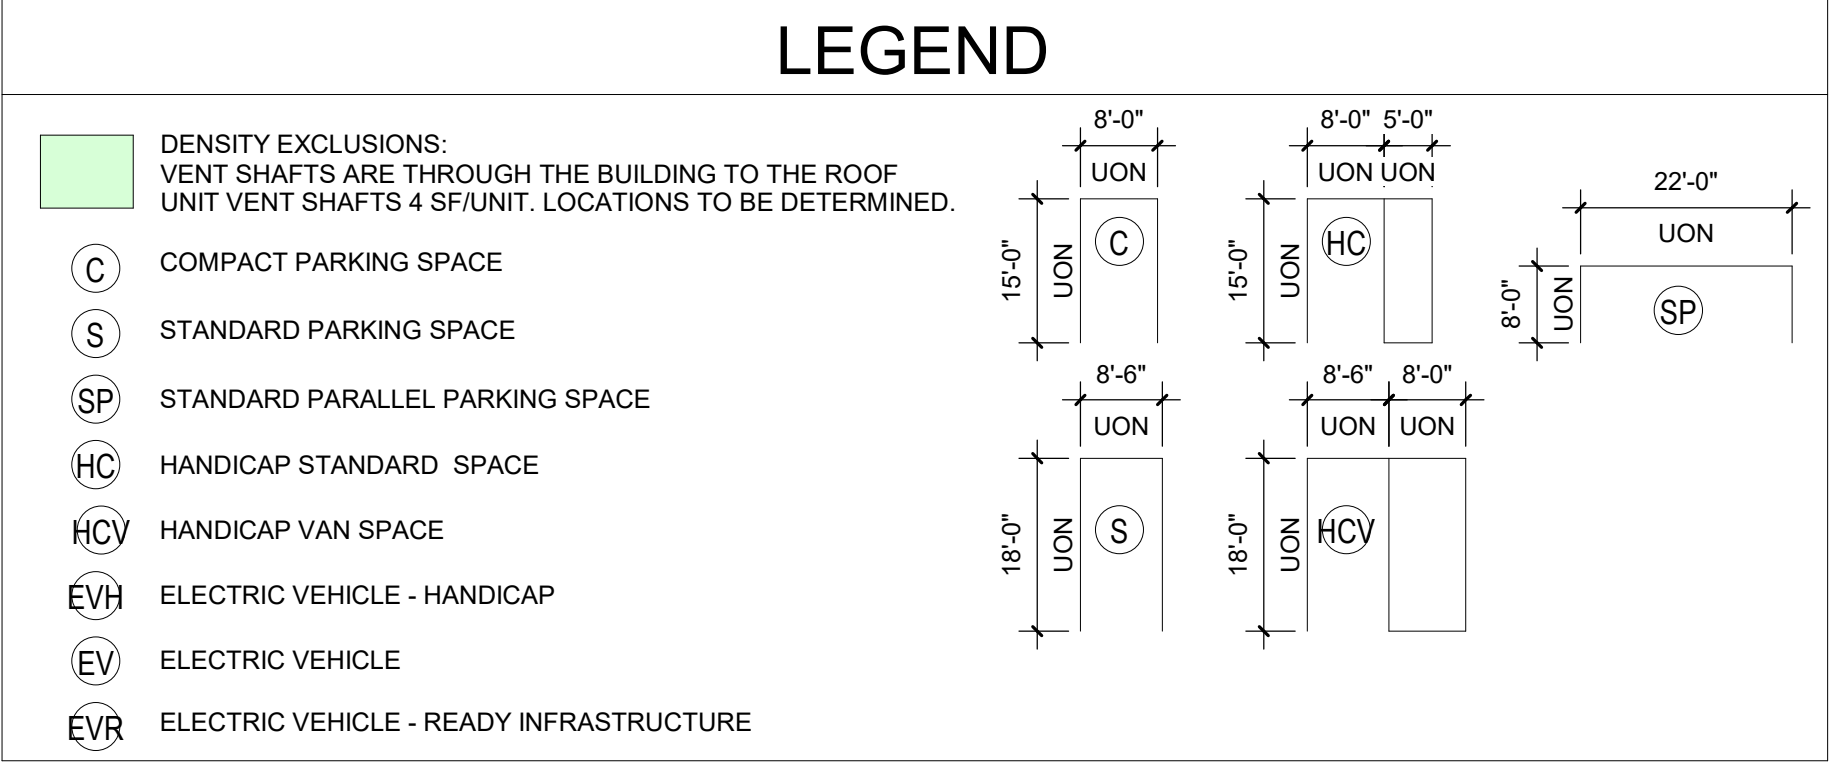
**PARKING TABULATION**

SPACE TYPE	COUNT
LEVEL LL	
C	14
EVR	23
HC	2
S	67
SP	1
LEVEL P1	107
C	4
EV	3
EVH	1
HC	2
HCV	2
S	39
SP	1
LEVEL P2	52
C	25
EV	7
EVR	6
HC	2
S	61
SP	2
LEVEL P3	103
C	25
EV	4
EVR	9
HC	2
S	49
SP	2
GRAND TOTAL	353


LEVEL	SPACE	GROSS PARKING AREA
LEVEL LL	BIKE STORAGE	2,040 SF
LEVEL LL	ELEVATOR 1	184 SF
LEVEL LL	ELEVATOR 2	112 SF
LEVEL LL	GARAGE EXHAUST	141 SF
LEVEL LL	GARAGE EXHAUST	105 SF
LEVEL LL	FIRE SERVICE ACCESS ELEVATOR LOBBY	185 SF
LEVEL LL	INTAKE GARAGE	82 SF
LEVEL LL	PARKING	44,015 SF
LEVEL LL	STAIR A	218 SF
LEVEL LL	STAIR D	285 SF
LEVEL LL	STAIR E	235 SF
LEVEL LL	UNOCCUPIED (LOW CLEARANCE AREA)	70 SF
TOTAL GROSS PARKING AREA (THIS LEVEL)		47,672 SF

LEVEL	SPACE	GROSS FLOOR AREA
LEVEL LL	BUILDING SERVICE 1	1,458 SF
LEVEL LL	BUILDING SERVICE 2	431 SF
LEVEL LL	BUILDING SERVICE 3	390 SF
LEVEL LL	EMERGENCY ELECTRICAL ROOM	205 SF
LEVEL LL	MAIN ELECTRICAL ROOM	653 SF
LEVEL LL	MDF ROOM	226 SF
LEVEL LL	STORAGE	132 SF
LEVEL LL	UNOCCUPIED (LOW CLEARANCE AREA)	38 SF
LEVEL LL	WATER / FIRE PUMP ROOM	999 SF
TOTAL GROSS FLOOR AREA (THIS LEVEL)		4,532 SF

LEVEL	SPACE	DENSITY EXCLUSIONS
LEVEL LL	MAIN ELECTRICAL ROOM	653 SF
LEVEL LL	EMERGENCY ELECTRICAL ROOM	205 SF
LEVEL LL	MDF ROOM	226 SF
LEVEL LL	STORAGE	132 SF
LEVEL LL	BUILDING SERVICE 1	1,458 SF
LEVEL LL	BUILDING SERVICE 2	431 SF
LEVEL LL	BUILDING SERVICE 3	390 SF
LEVEL LL	UNOCCUPIED (LOW CLEARANCE AREA)	38 SF
LEVEL LL	WATER / FIRE PUMP ROOM	999 SF
TOTAL DENSITY EXCLUSIONS (THIS LEVEL)		4,532 SF




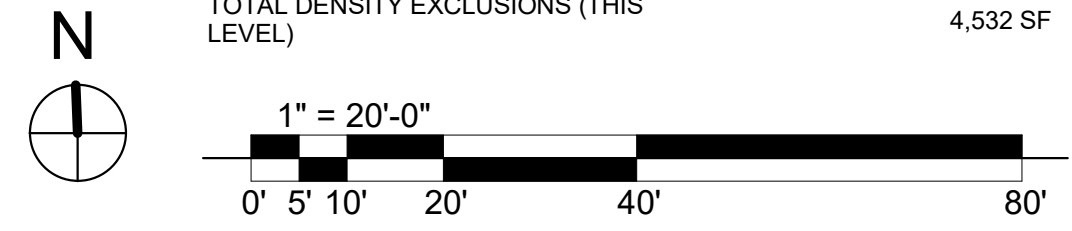**1 PARKING LOWER LEVEL (LL) FLOOR PLAN**  
1" = 20'-0"






LANGSTON BLVD - ROUTE 29/211

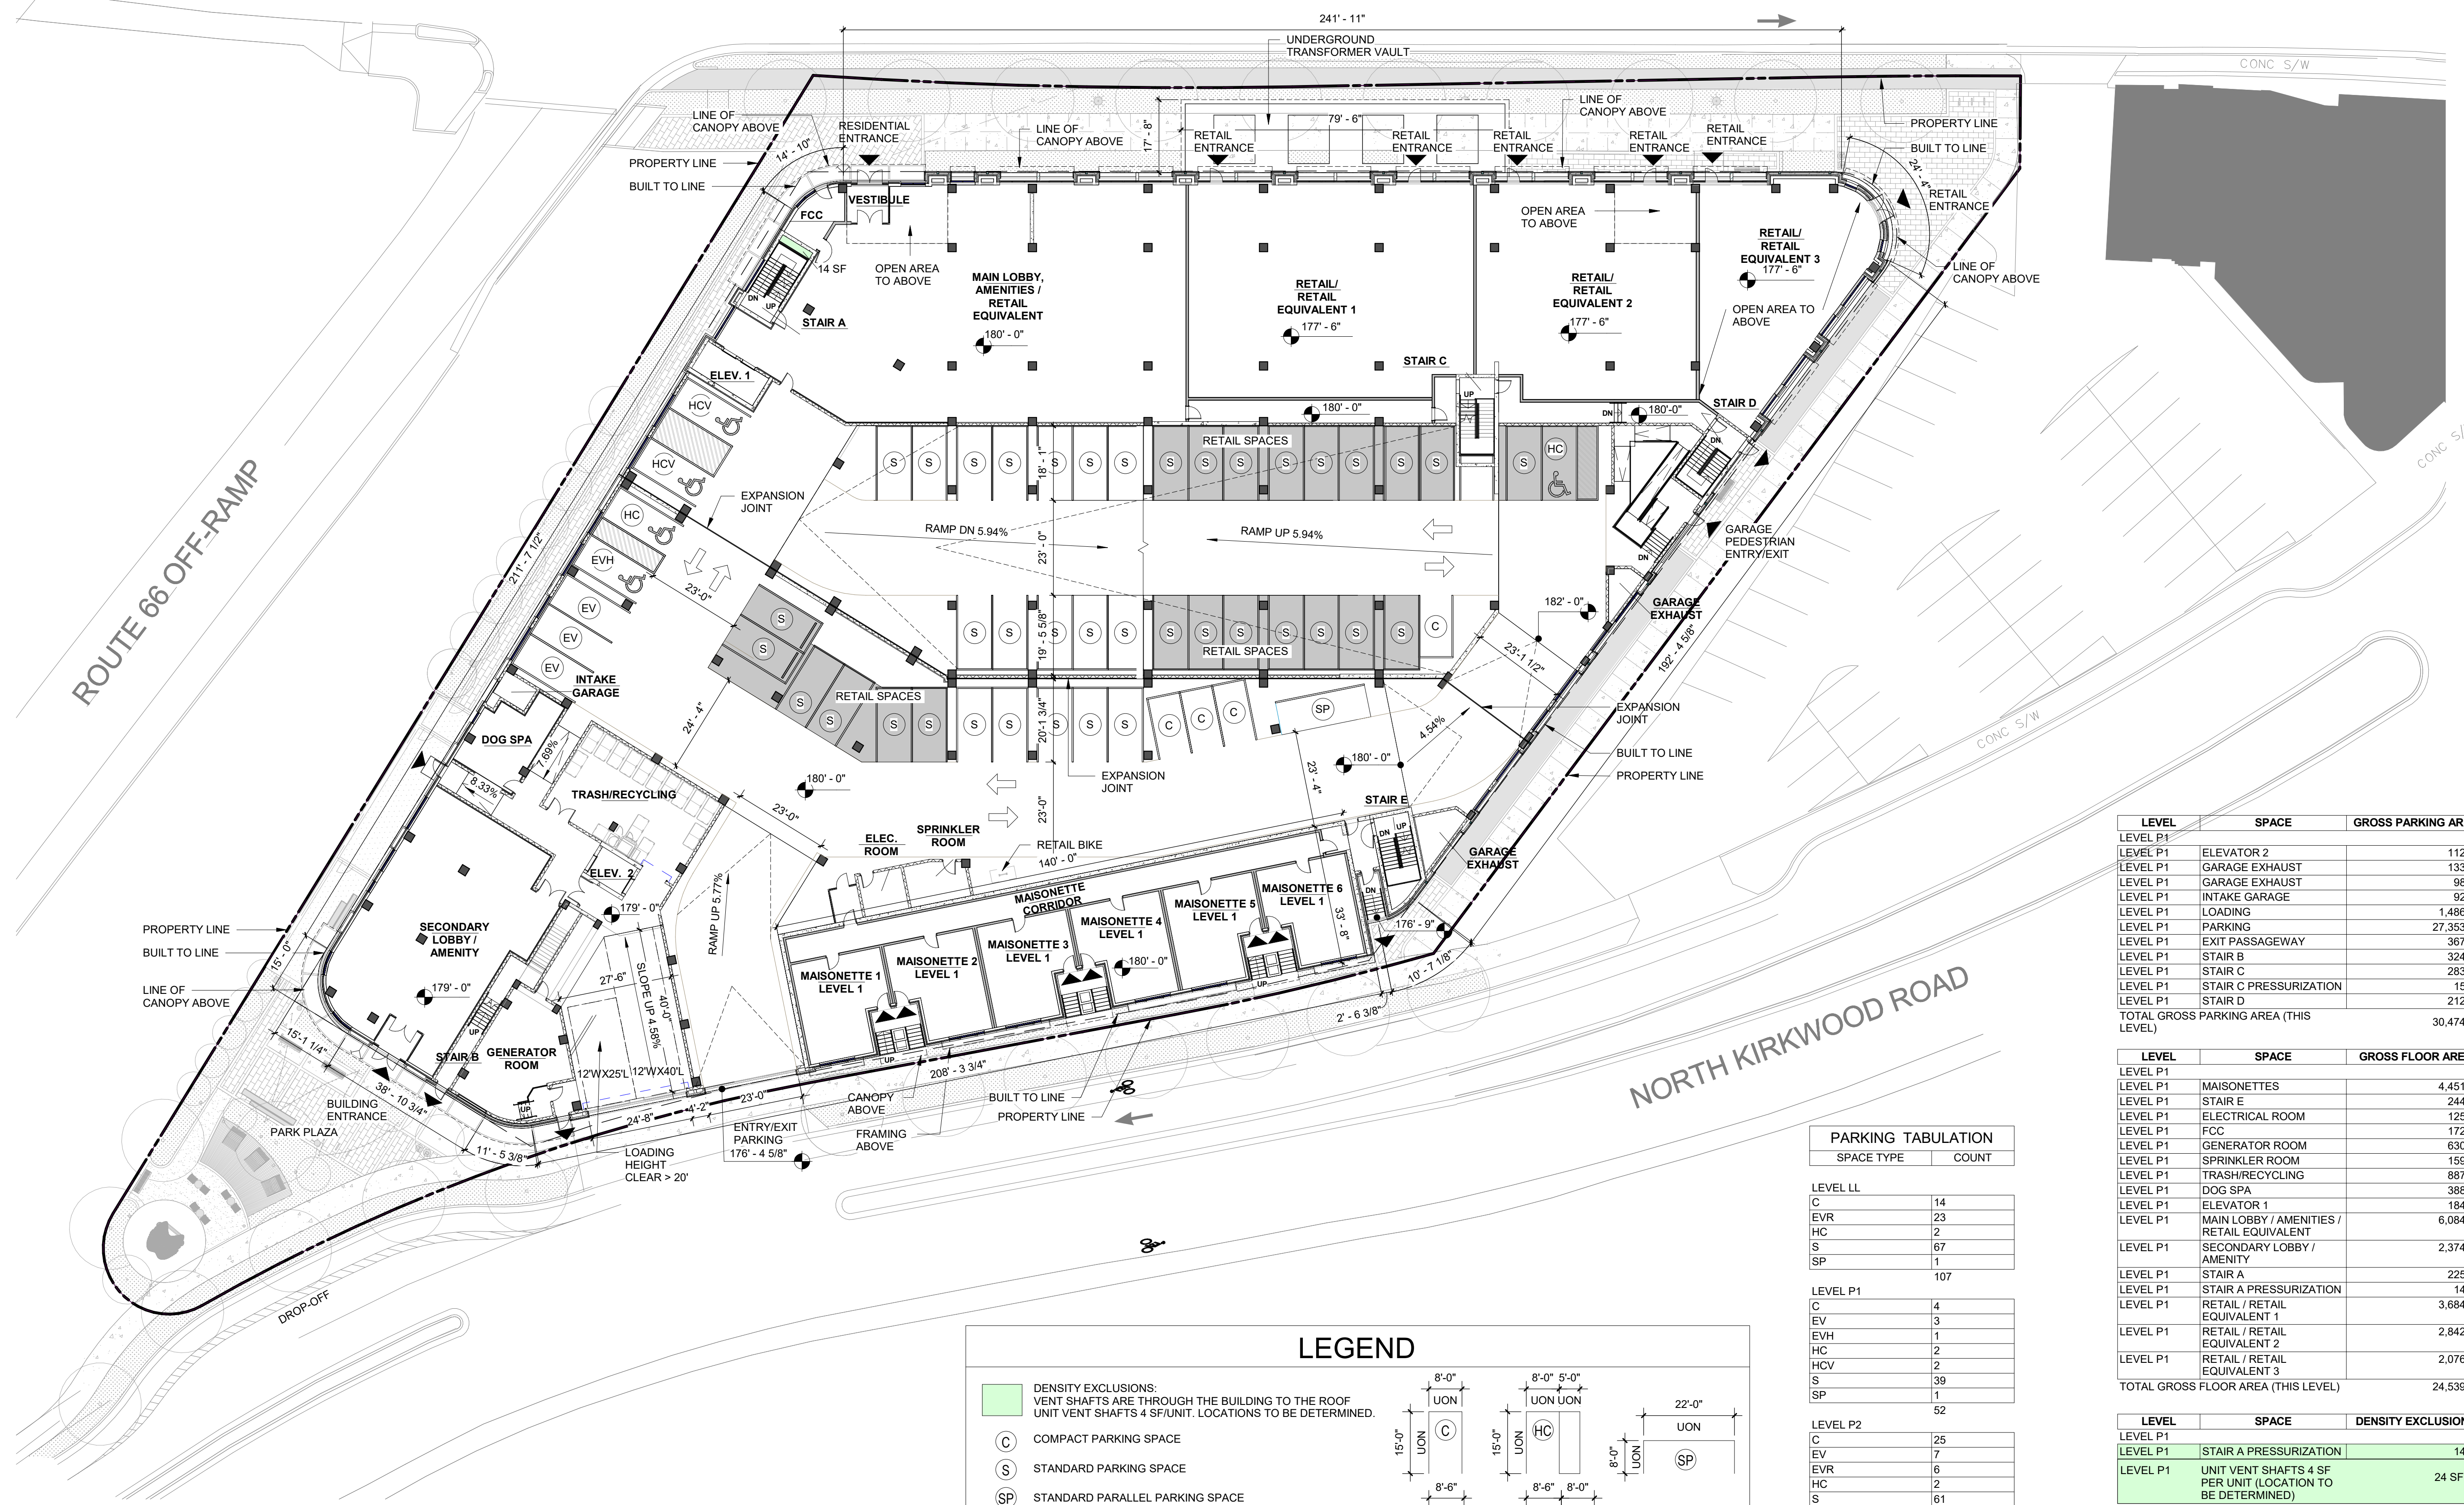

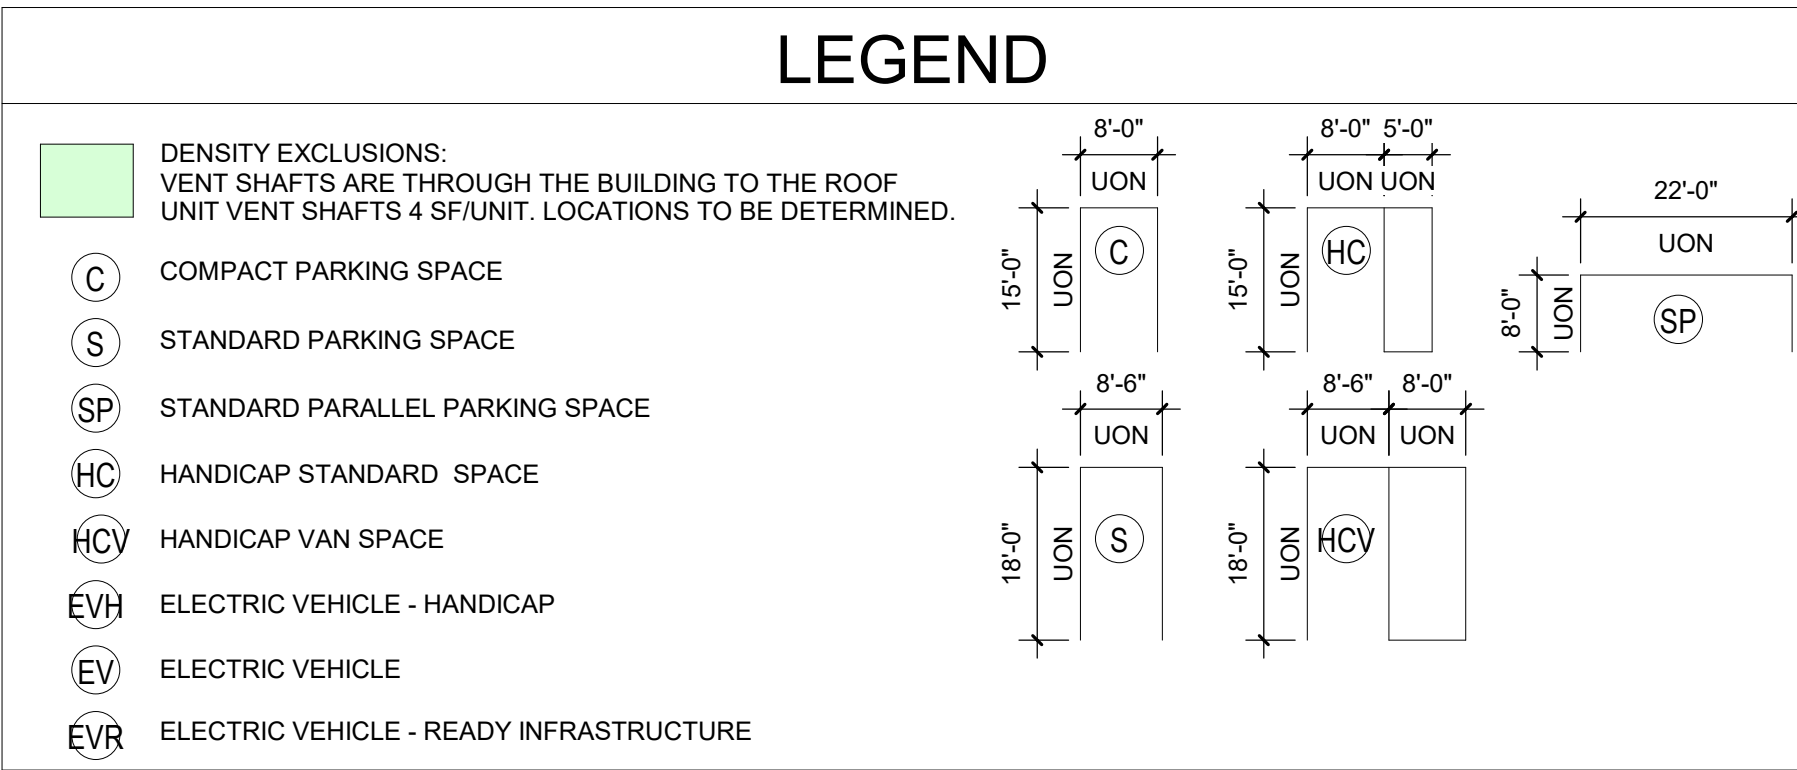**1 GROUND LEVEL P1 FLOOR PLAN**  
1" = 20'-0"



**PARKING TABULATION**

SPACE TYPE	COUNT
<b>LEVEL LL</b>	
C	14
EVR	23
HC	2
S	67
SP	1
<b>LEVEL P1</b>	<b>107</b>
C	4
EV	3
EVH	1
HC	2
HCV	2
S	39
SP	1
<b>LEVEL P2</b>	<b>52</b>
C	25
EV	7
EVR	6
HC	2
S	61
SP	2
<b>LEVEL P3</b>	<b>103</b>
C	25
EV	4
EVR	9
HC	2
S	49
SP	2
<b>GRAND TOTAL</b>	<b>353</b>

LEVEL	SPACE	GROSS PARKING AREA
LEVEL P1	ELEVATOR 2	112 SF
LEVEL P1	GARAGE EXHAUST	133 SF
LEVEL P1	GARAGE EXHAUST	98 SF
LEVEL P1	INTAKE GARAGE	92 SF
LEVEL P1	LOADING	1,486 SF
LEVEL P1	PARKING	27,353 SF
LEVEL P1	EXIT PASSAGEWAY	367 SF
LEVEL P1	STAIR B	324 SF
LEVEL P1	STAIR C	283 SF
LEVEL P1	STAIR C PRESSURIZATION	15 SF
LEVEL P1	STAIR D	212 SF
<b>TOTAL GROSS PARKING AREA (THIS LEVEL)</b>		<b>30,474 SF</b>

LEVEL	SPACE	GROSS FLOOR AREA
LEVEL P1	MAISONNETTES	4,451 SF
LEVEL P1	STAIR E	244 SF
LEVEL P1	ELECTRICAL ROOM	125 SF
LEVEL P1	FCC	172 SF
LEVEL P1	GENERATOR ROOM	630 SF
LEVEL P1	SPRINKLER ROOM	159 SF
LEVEL P1	TRASH/RECYCLING	887 SF
LEVEL P1	DOG SPA	388 SF
LEVEL P1	ELEVATOR 1	184 SF
LEVEL P1	MAIN LOBBY / AMENITIES / RETAIL EQUIVALENT	6,084 SF
LEVEL P1	SECONDARY LOBBY / AMENITY	2,374 SF
LEVEL P1	STAIR A	225 SF
LEVEL P1	STAIR A PRESSURIZATION	14 SF
LEVEL P1	RETAIL / RETAIL EQUIVALENT 1	3,684 SF
LEVEL P1	RETAIL / RETAIL EQUIVALENT 2	2,842 SF
LEVEL P1	RETAIL / RETAIL EQUIVALENT 3	2,076 SF
<b>TOTAL GROSS FLOOR AREA (THIS LEVEL)</b>		<b>24,539 SF</b>

LEVEL	SPACE	DENSITY EXCLUSIONS
LEVEL P1	STAIR A PRESSURIZATION	14 SF
LEVEL P1	UNIT VENT SHAFTS 4 SF PER UNIT (LOCATION TO BE DETERMINED)	24 SF (6)
<b>TOTAL DENSITY EXCLUSIONS (THIS LEVEL)</b>		<b>38 SF</b>

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PRINT DATE 11/11/2024 1:50:17 PM

ISSUE DATE  
4.1 SITE PLAN SUBMISSION 08-09-24  
4.1 SITE PLAN RESUBMISSION 10/29/2024

REVISION DATE

PROJECT TITLE  
**3130 LANGSTON BOULEVARD**  
ARLINGTON, VA 22201

4.1 SITE PLAN  
PROJECT NO. 322158.00

DRAWING TITLE  
**GROUND LEVEL P1 FLOOR PLAN**

DRAWN BY PFS.YL  
QC CHECKED BY RRV  
CA REVIEWED BY RRV

DRAWING NUMBER  
**A-03**

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**PARKING TABULATION**

SPACE TYPE	COUNT
LEVEL LL	
C	14
EVR	23
HC	2
S	67
SP	1
LEVEL P1	107
C	4
EV	3
EVH	1
HC	2
HCv	2
S	39
SP	1
LEVEL P2	52
C	25
EV	7
EVR	6
HC	2
HC	2
S	61
SP	2
LEVEL P3	103
C	25
EV	4
EVR	9
HC	2
S	49
SP	2
GRAND TOTAL	353

**LEVEL SPACE GROSS PARKING AREA**

LEVEL	SPACE	GROSS PARKING AREA
LEVEL P3		
LEVEL P3	ELEVATOR 1	184 SF
LEVEL P3	GARAGE EXHAUST	133 SF
LEVEL P3	GARAGE EXHAUST	98 SF
LEVEL P3	FIRE SERVICE ACCESS ELEVATOR LOBBY	184 SF
LEVEL P3	PARKING	38,738 SF
LEVEL P3	STAIR A	225 SF
LEVEL P3	STAIR PRESSURIZATION	14 SF
LEVEL P3	STAIR C	217 SF
LEVEL P3	STAIR PRESSURIZATION	15 SF
TOTAL GROSS PARKING AREA (THIS LEVEL)		39,807 SF

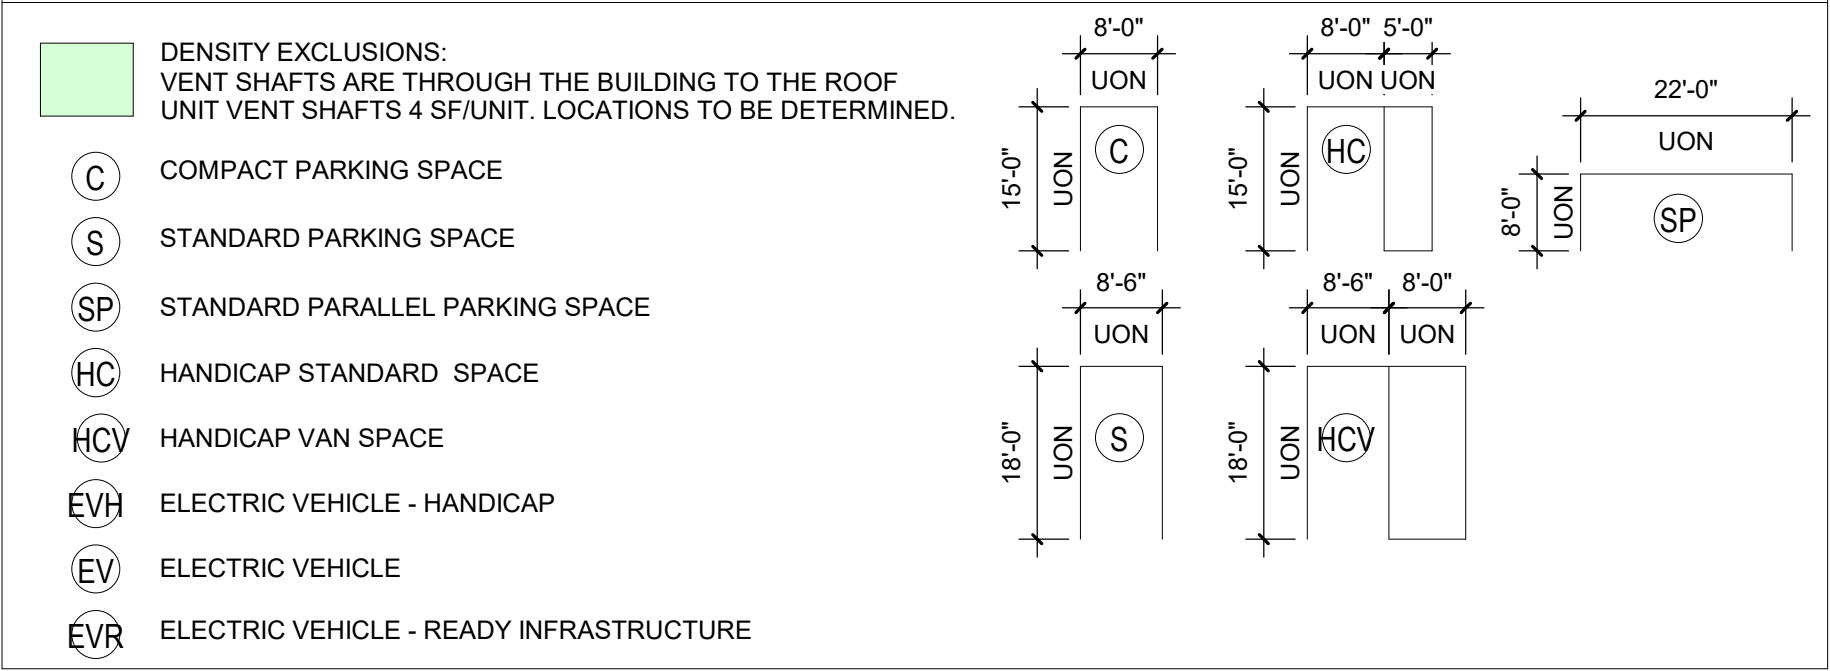
**LEVEL SPACE GROSS FLOOR AREA**

LEVEL	SPACE	GROSS FLOOR AREA
LEVEL P3		
LEVEL P3	MECHANICAL	72 SF
LEVEL P3	MAISONETTES	4,851 SF
LEVEL P3	STAIR E	235 SF
LEVEL P3	ELECTRICAL ROOM	225 SF
LEVEL P3	STORAGE / UTILITY	2,585 SF
LEVEL P3	TRASH EXHAUST	5 SF
LEVEL P3	TRASH ROOM	93 SF
LEVEL P3	ELEVATOR 2	112 SF
LEVEL P3	LOBBY	705 SF
LEVEL P3	RESIDENTIAL (2BR-B9)	971 SF
LEVEL P3	STAIR B	193 SF
LEVEL P3	STAIR B PRESSURIZATION	35 SF
LEVEL P3	AMENITY	694 SF
TOTAL GROSS FLOOR AREA (THIS LEVEL)		10,775 SF


**LEVEL SPACE DENSITY EXCLUSIONS**

LEVEL	SPACE	DENSITY EXCLUSIONS
LEVEL P3		
LEVEL P3	STAIR B PRESSURIZATION	35 SF
LEVEL P3	TRASH EXHAUST	5 SF
LEVEL P3	UNIT VENT SHAFTS 4 SF PER UNIT (LOCATION TO BE DETERMINED)	28 SF (7 UNITS)
TOTAL DENSITY EXCLUSIONS (THIS LEVEL)		68 SF

**LEGEND**



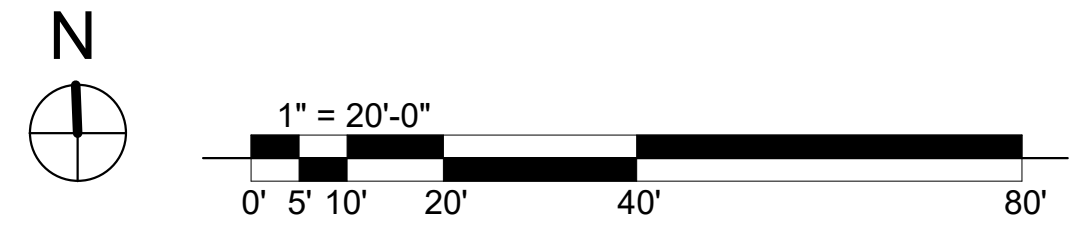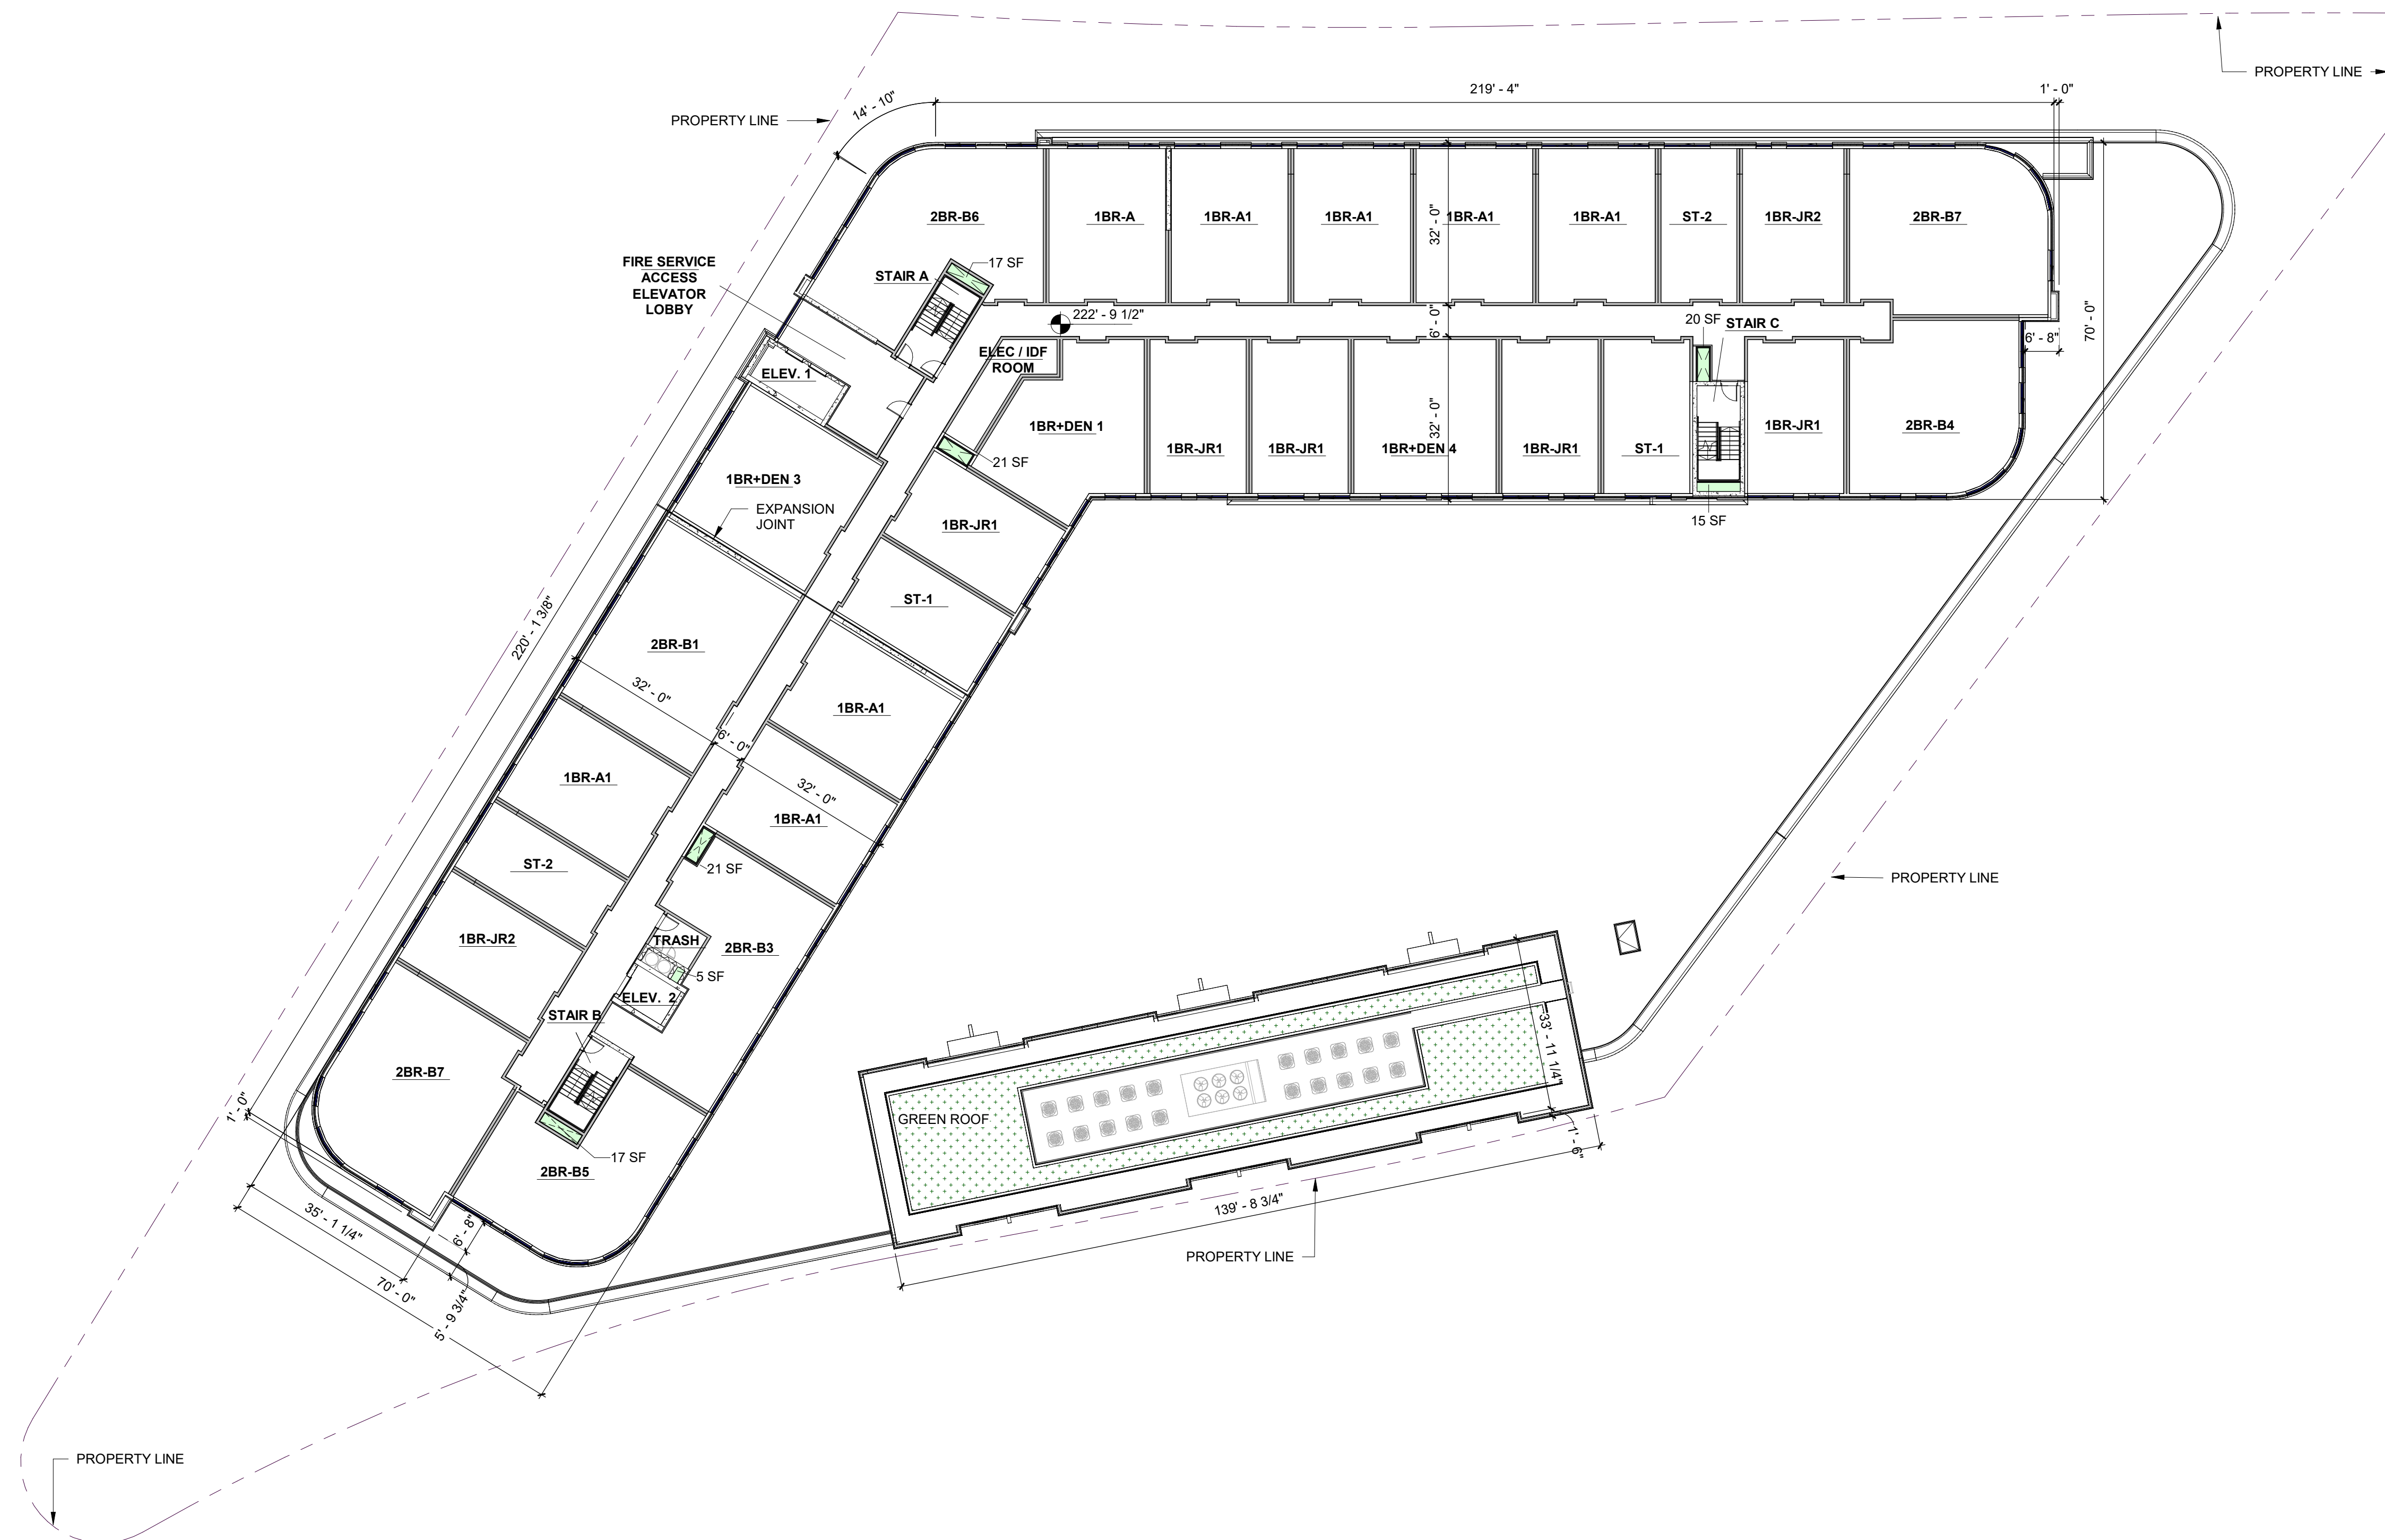
**1 2ND LEVEL P3 FLOOR PLAN**  
1" = 20'-0"













LEVEL	SPACE	GROSS FLOOR AREA
LEVEL 4	ELECTRICAL / IDF ROOM	221 SF
LEVEL 4	TRASH EXHAUST	5 SF
LEVEL 4	TRASH ROOM	102 SF
LEVEL 4	ELEVATOR 1	180 SF
LEVEL 4	ELEVATOR 2	112 SF
LEVEL 4	FIRE SERVICE ACCESS ELEVATOR LOBBY	405 SF
LEVEL 4	OUTSIDE AIR SHAFT	20 SF
LEVEL 4	OUTSIDE AIR SHAFT	21 SF
LEVEL 4	OUTSIDE AIR SHAFT	21 SF
LEVEL 4	RESIDENTIAL	26,885 SF
LEVEL 4	STAIR A	207 SF
LEVEL 4	PRESSURIZATION	17 SF
LEVEL 4	STAIR B	194 SF
LEVEL 4	PRESSURIZATION	17 SF
LEVEL 4	STAIR C	221 SF
LEVEL 4	PRESSURIZATION	15 SF
TOTAL GROSS FLOOR AREA (THIS LEVEL)		28,642 SF


LEVEL	SPACE	EXCLUDED AREA
LEVEL 4	OUTSIDE AIR SHAFT	20 SF
LEVEL 4	OUTSIDE AIR SHAFT	21 SF
LEVEL 4	OUTSIDE AIR SHAFT	21 SF
LEVEL 4	STAIR A	17 SF
LEVEL 4	PRESSURIZATION	17 SF
LEVEL 4	STAIR B	17 SF
LEVEL 4	PRESSURIZATION	15 SF
LEVEL 4	STAIR C	15 SF
LEVEL 4	PRESSURIZATION	5 SF
LEVEL 4	TRASH EXHAUST	5 SF
LEVEL 4	UNIT VENT SHAFTS 4 SF PER UNIT (LOCATION TO BE DETERMINED)	116 SF (29 UNITS)
TOTAL DENSITY EXCLUSIONS (THIS LEVEL)		232 SF

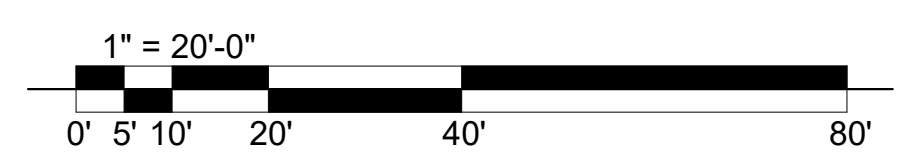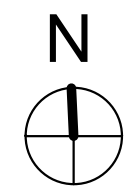DENSITY EXCLUSIONS:  
VENT SHAFTS ARE THROUGH THE BUILDING TO THE ROOF  
UNIT VENT SHAFTS 4 SF/UNIT. LOCATIONS TO BE DETERMINED.



**1 4TH FLOOR PLAN**  
1" = 20'-0"



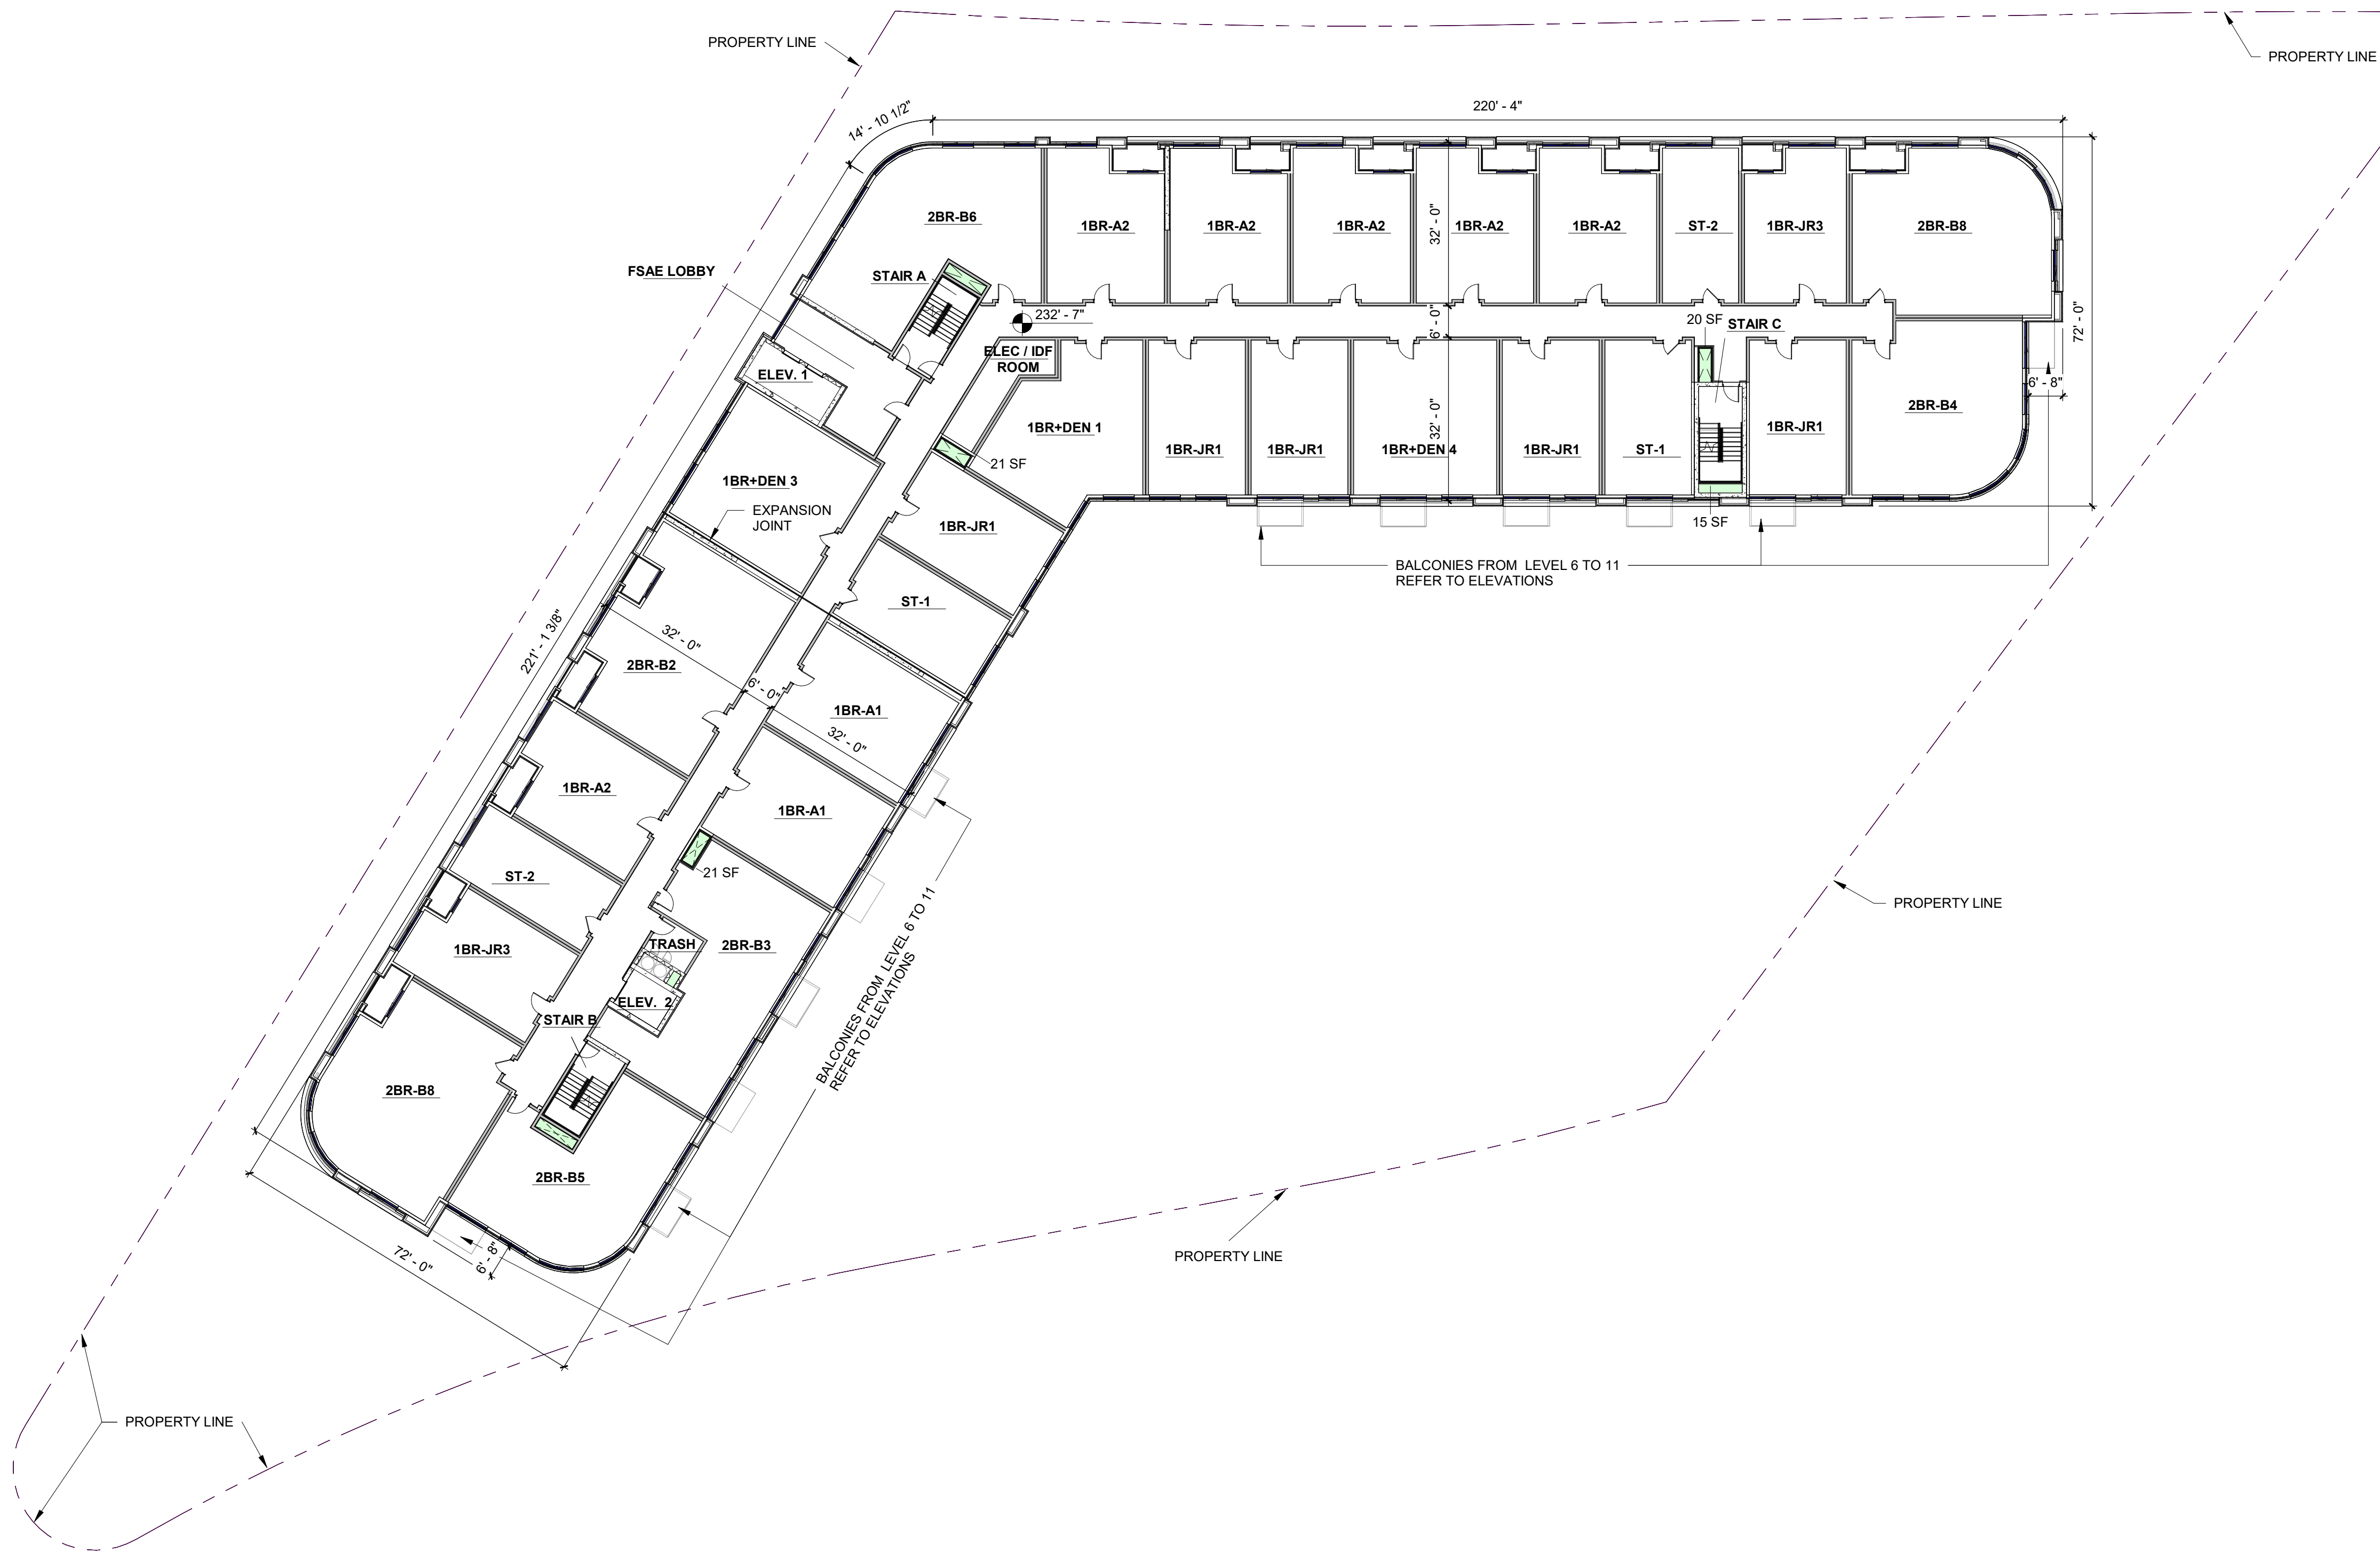

**GROSS FLOOR AREA PER LEVEL**

SPACE	GROSS FLOOR AREA
ELECTRICAL / IDF ROOM	221 SF
TRASH ROOM	102 SF
ELEVATOR 1	180 SF
ELEVATOR 2	112 SF
FIRE SERVICE ACCESS	405 SF
ELEVATOR LOBBY	
RESIDENTIAL	26,482 SF
STAIR A	207 SF
STAIR B	194 SF
STAIR C	226 SF
TRASH EXHAUST	5 SF
STAIR C PRESSURIZATION	15 SF
STAIR A PRESSURIZATION	17 SF
STAIR B PRESSURIZATION	17 SF
STAIR C PRESSURIZATION	15 SF
OUTSIDE AIR SHAFT	20 SF
OUTSIDE AIR SHAFT	21 SF
OUTSIDE AIR SHAFT	21 SF
TOTAL GROSS FLOOR AREA PER LEVEL	28,245 SF

**GROSS FLOOR AREA (LEVEL 5 THRU LEVEL 11)**

LEVEL	GROSS FLOOR AREA
LEVEL 5	28,245 SF
LEVEL 6	28,245 SF
LEVEL 7	28,245 SF
LEVEL 8	28,245 SF
LEVEL 9	28,245 SF
LEVEL 10	28,245 SF
LEVEL 11	28,245 SF
TOTAL GROSS FLOOR AREA (LEVEL 5 THRU 11)	197,715 SF

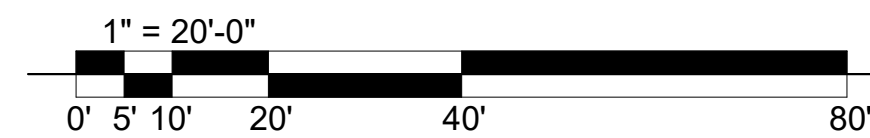
**DENSITY EXCLUSIONS PER LEVEL**

SPACE	DENSITY EXCLUSIONS
LEVEL 5	
OUTSIDE AIR SHAFT	20
OUTSIDE AIR SHAFT	21
OUTSIDE AIR SHAFT	21
STAIR A PRESSURIZATION	17
STAIR B PRESSURIZATION	17
STAIR C PRESSURIZATION	15
TRASH EXHAUST	5
UNIT VENT SHAFTS 4 SF PER UNIT (LOCATION TO BE DETERMINED)	116
TOTAL DENSITY EXCLUSIONS PER LEVEL	232 SF
TOTAL DENSITY EXCLUSIONS (LEVEL 5 THRU 11)	1,624 SF

(29 UNITS PER LEVEL)

**1 5TH THRU 11TH FLOOR PLANS**  
1" = 20'-0"

DENSITY EXCLUSIONS: VENT SHAFTS ARE THROUGH THE BUILDING TO THE ROOF UNIT VENT SHAFTS 4 SF/UNIT. LOCATIONS TO BE DETERMINED.



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PRINT DATE 11/11/2024 1:59:26 PM

**ISSUE DATE**

4.1 SITE PLAN SUBMISSION 08-09-24  
4.1 SITE PLAN RESUBMISSION 10/29/2024

**REVISION DATE**

**PROJECT TITLE**

**3130 LANGSTON BOULEVARD**  
ARLINGTON, VA 22201

**4.1 SITE PLAN**

PROJECT NO. 322158.00

**DRAWING TITLE**

**5TH THRU 11TH FLOOR PLANS**

**DRAWN BY** PFS.YL

**QC CHECKED BY** RRV

**CA REVIEWED BY** RRV

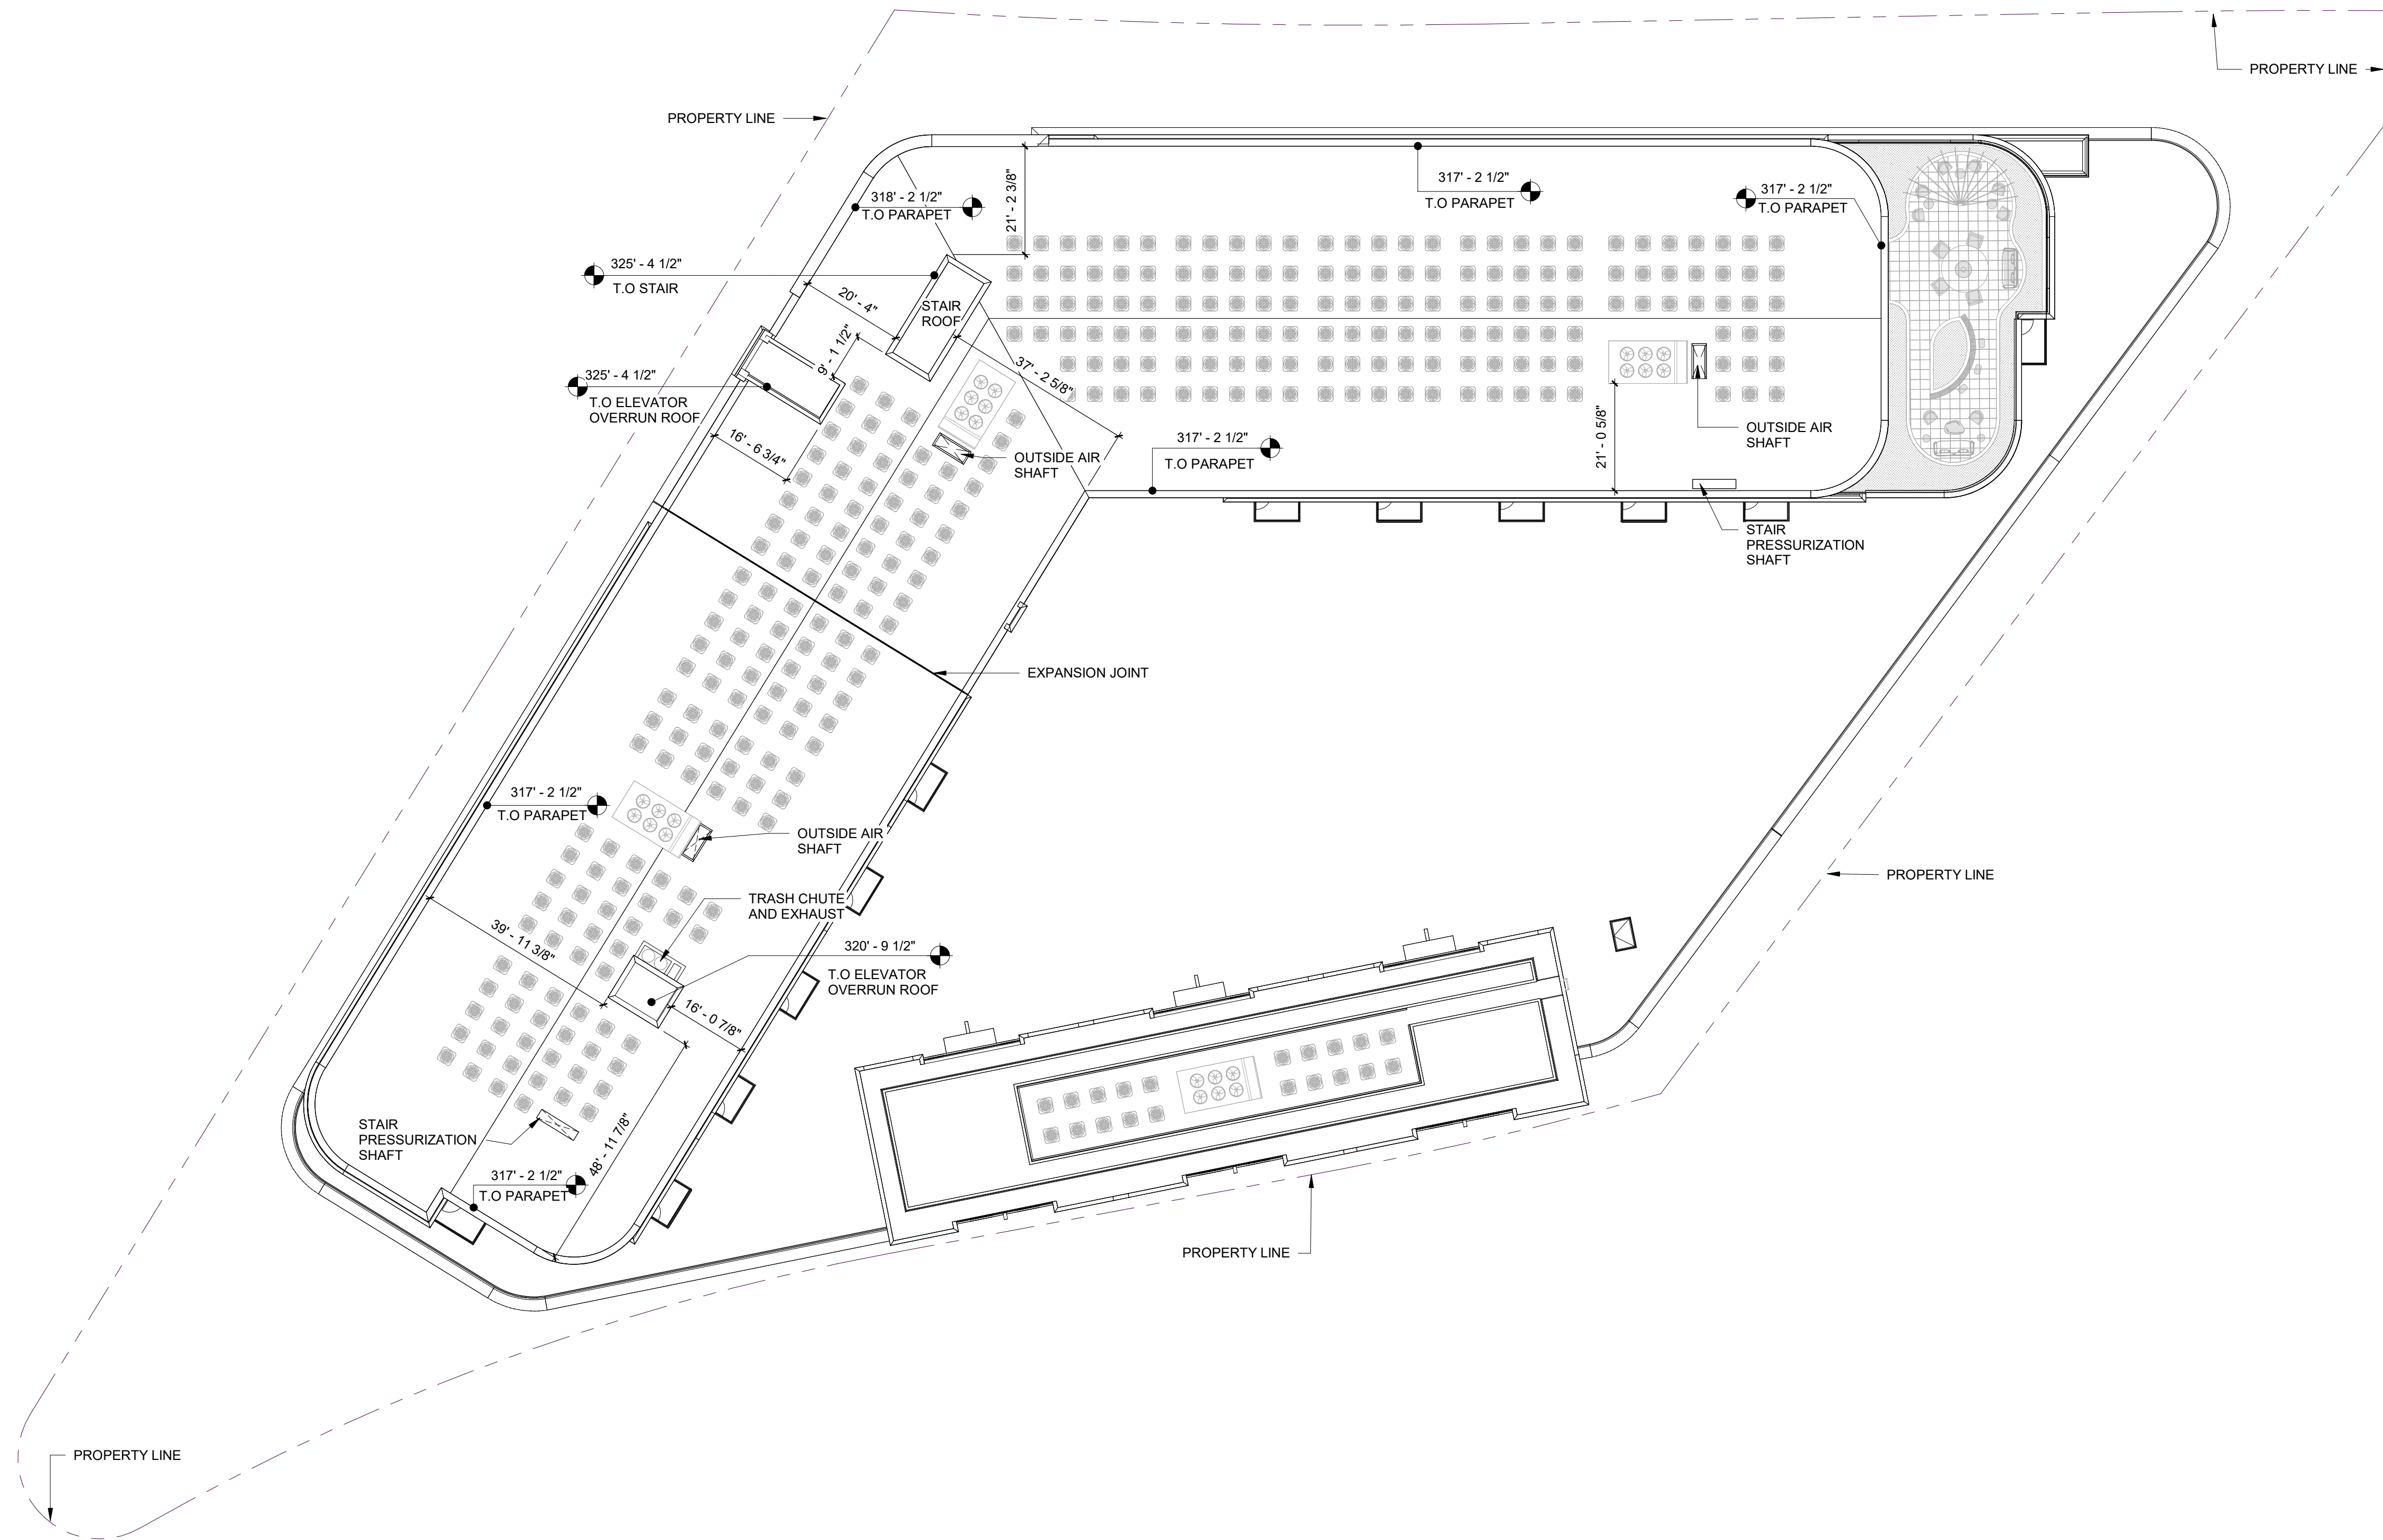
**DRAWING NUMBER**

**A-08**











**1 ROOF PLAN**  
1" = 20'-0"

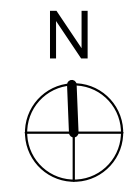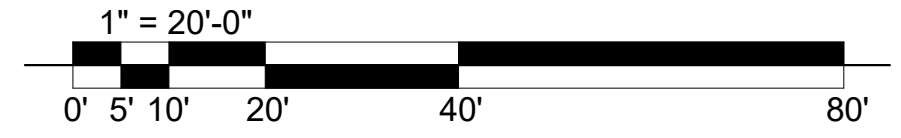
















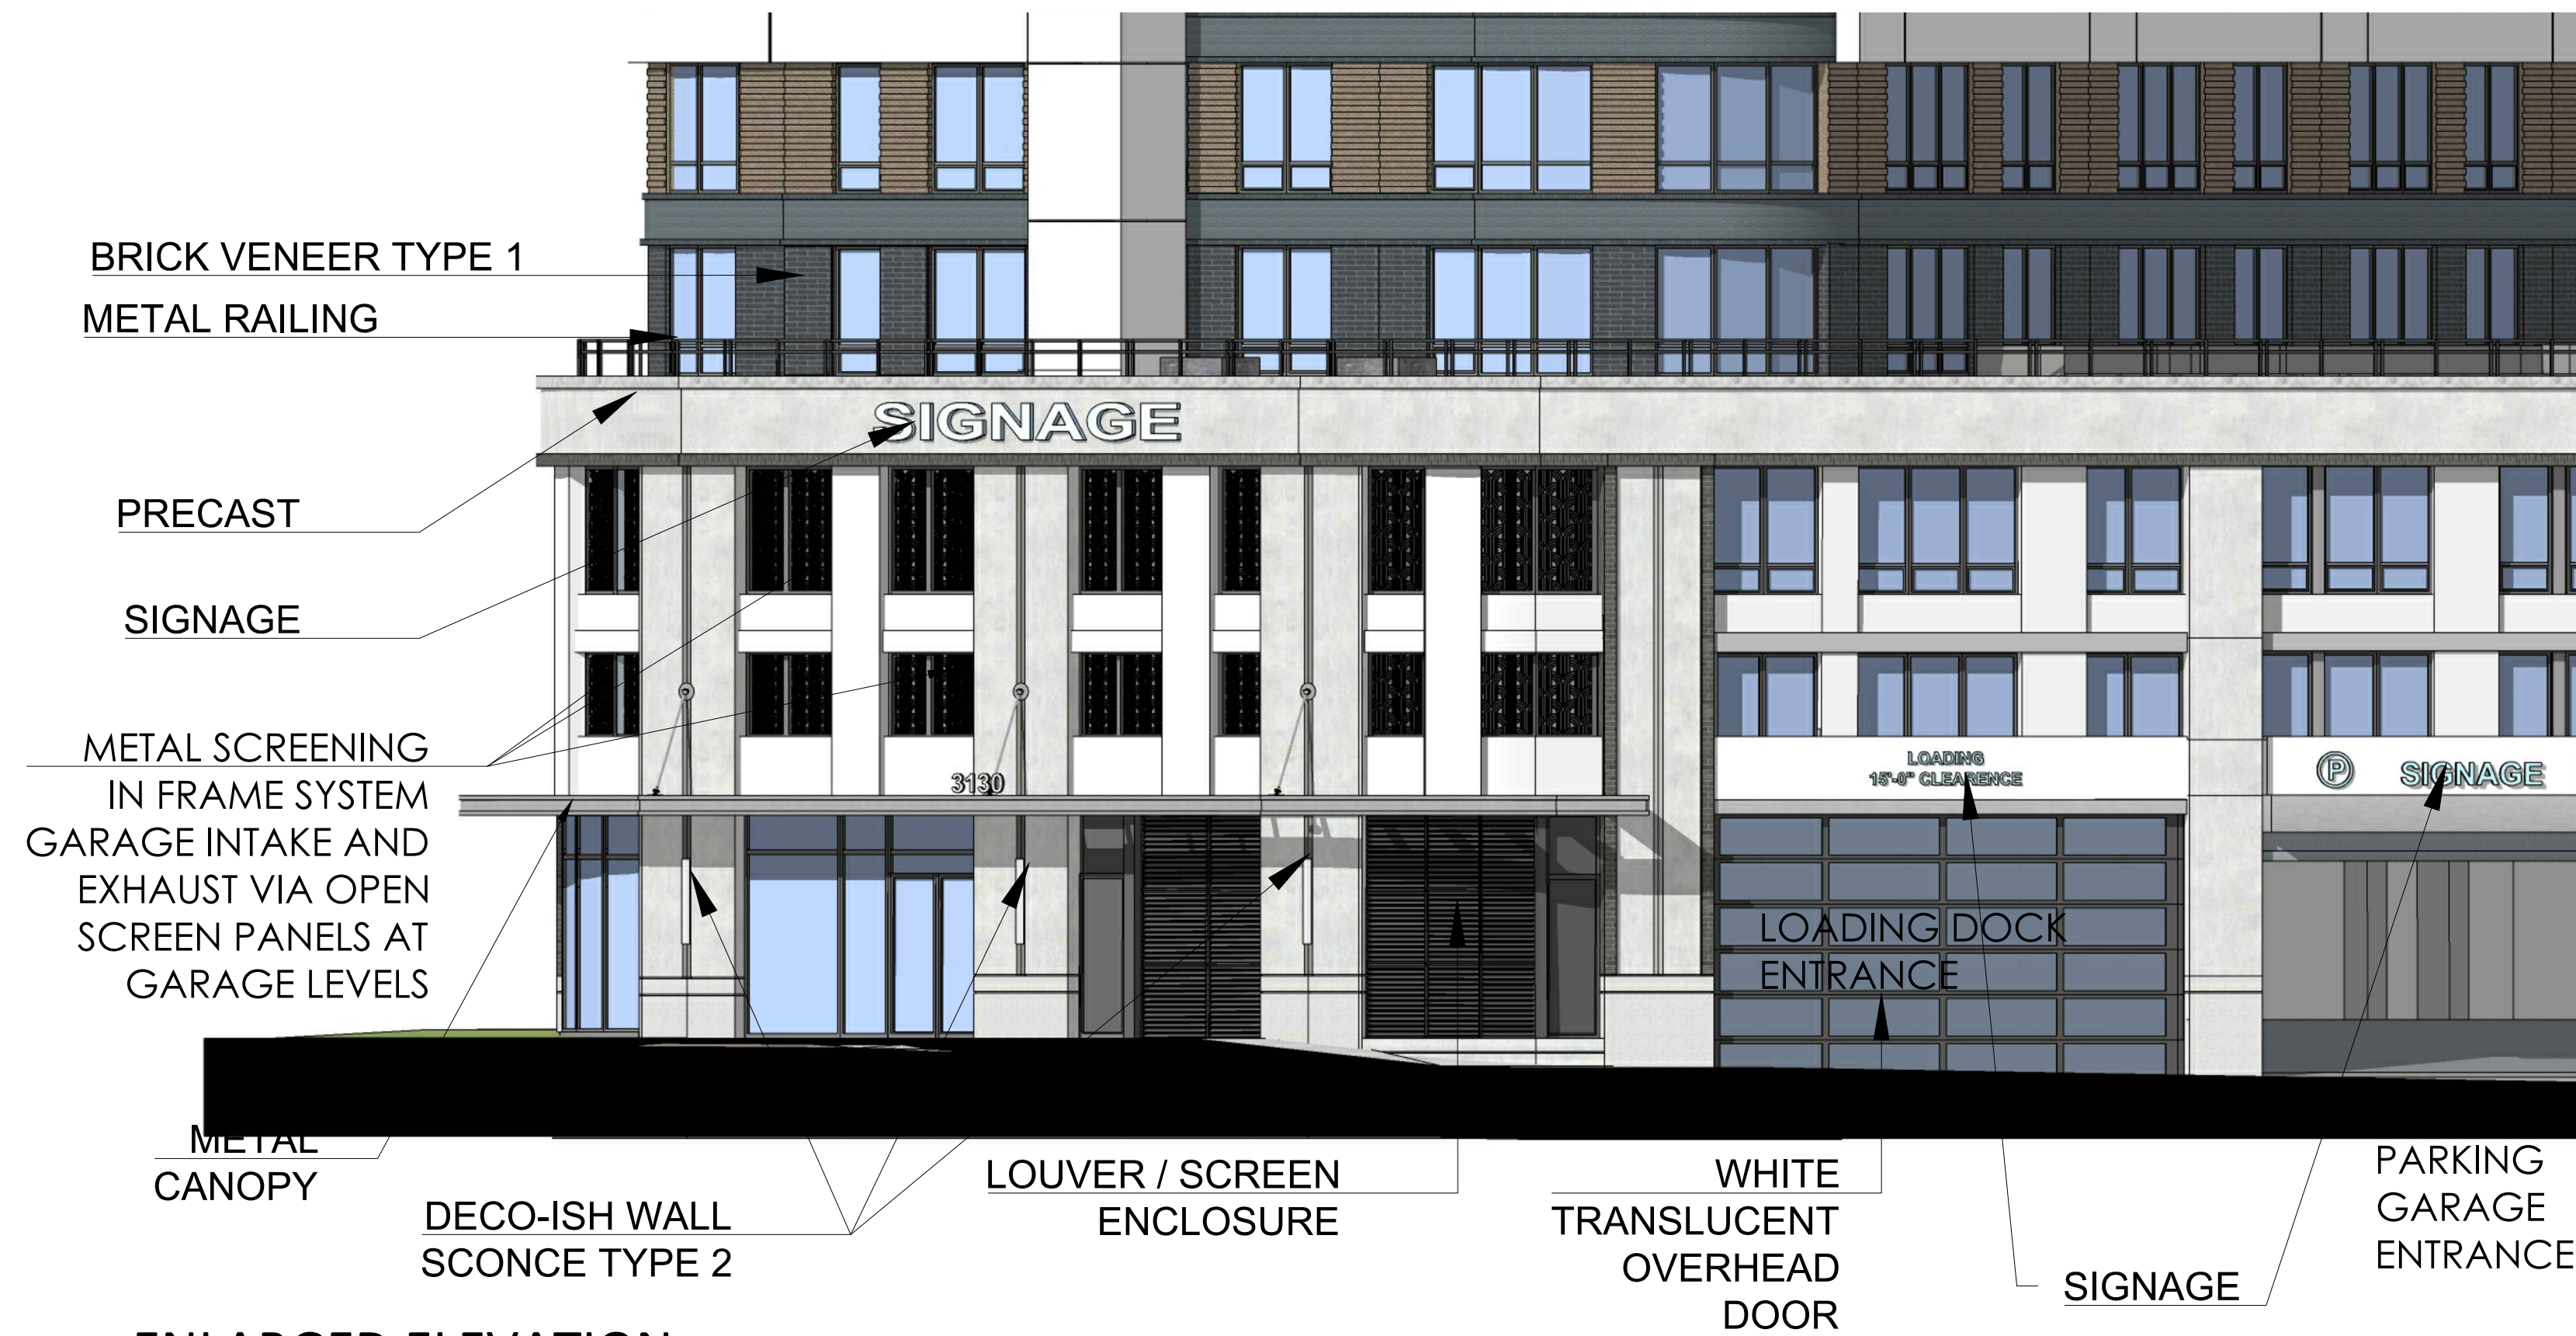Urban, Ltd. - \\DCS-FS\Drawings\05\_04\07\_2024\11\11\322158.00\01\_Drawings\05\_04\07\_2024\11\11\322158.00\01\_Sheets\A-14-REVISED\_322158.00 - A13-A15 - ENLARGED ELEVATIONS.dwg [A14-ELEVATIONS] October 29, 2024 - 4:27pm yllens






**1 ENLARGED ELEVATION**  
1/8"=1'-0"



**2 ENLARGED ELEVATION**  
1/8"=1'-0"

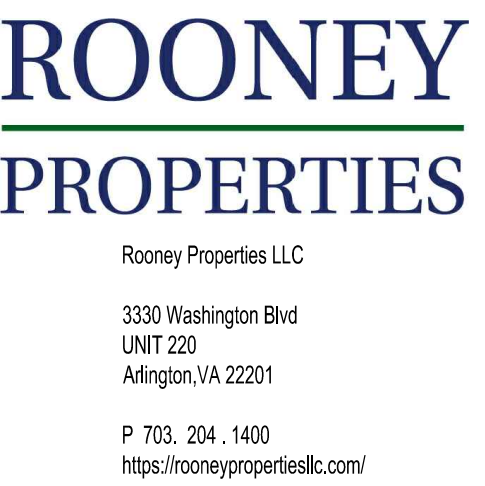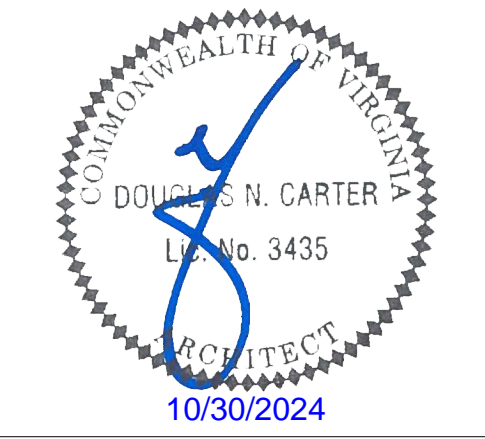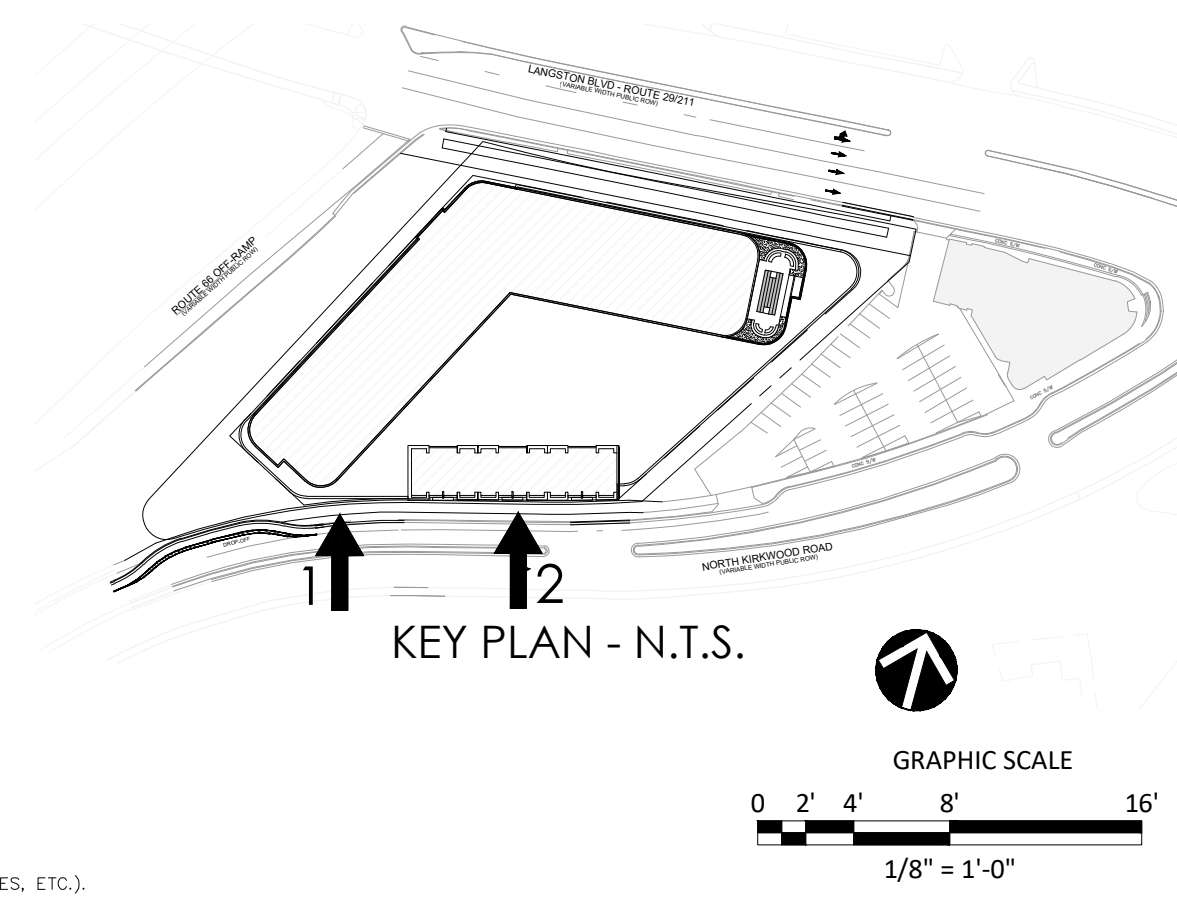NOTE:  
ARCHITECTURAL PLANS, INTERNAL PARKING LAYOUTS,  
PERSPECTIVES, ELEVATIONS AND SECTIONS ARE SUBJECT  
TO REVISION IN SITE PLAN APPLICATIONS. BUILDING  
DESIGN AND MATERIALS ARE SUBJECT TO CHANGE.



PRINT DATE	10/29/2024
ISSUE	DATE
4.1 SITE PLAN SUBMISSION	08-09-24
4.1 SITE PLAN RESUBMISSION	10-29-24
REVISION DATE	

PROJECT TITLE  
**3130 LANGSTON BOULEVARD**  
ARLINGTON, VA 22201

4.1 SITE PLAN  
PROJECT NO. 322158.00

DRAWING TITLE

**ENLARGED ELEVATIONS**

DRAWN BY RM  
QC CHECKED BY RV  
CA REVIEWED BY RRV

DRAWING NUMBER  
**A-14**





















VIEW 10



VIEW 11



VIEW 12




VIEW 13



VIEW 14



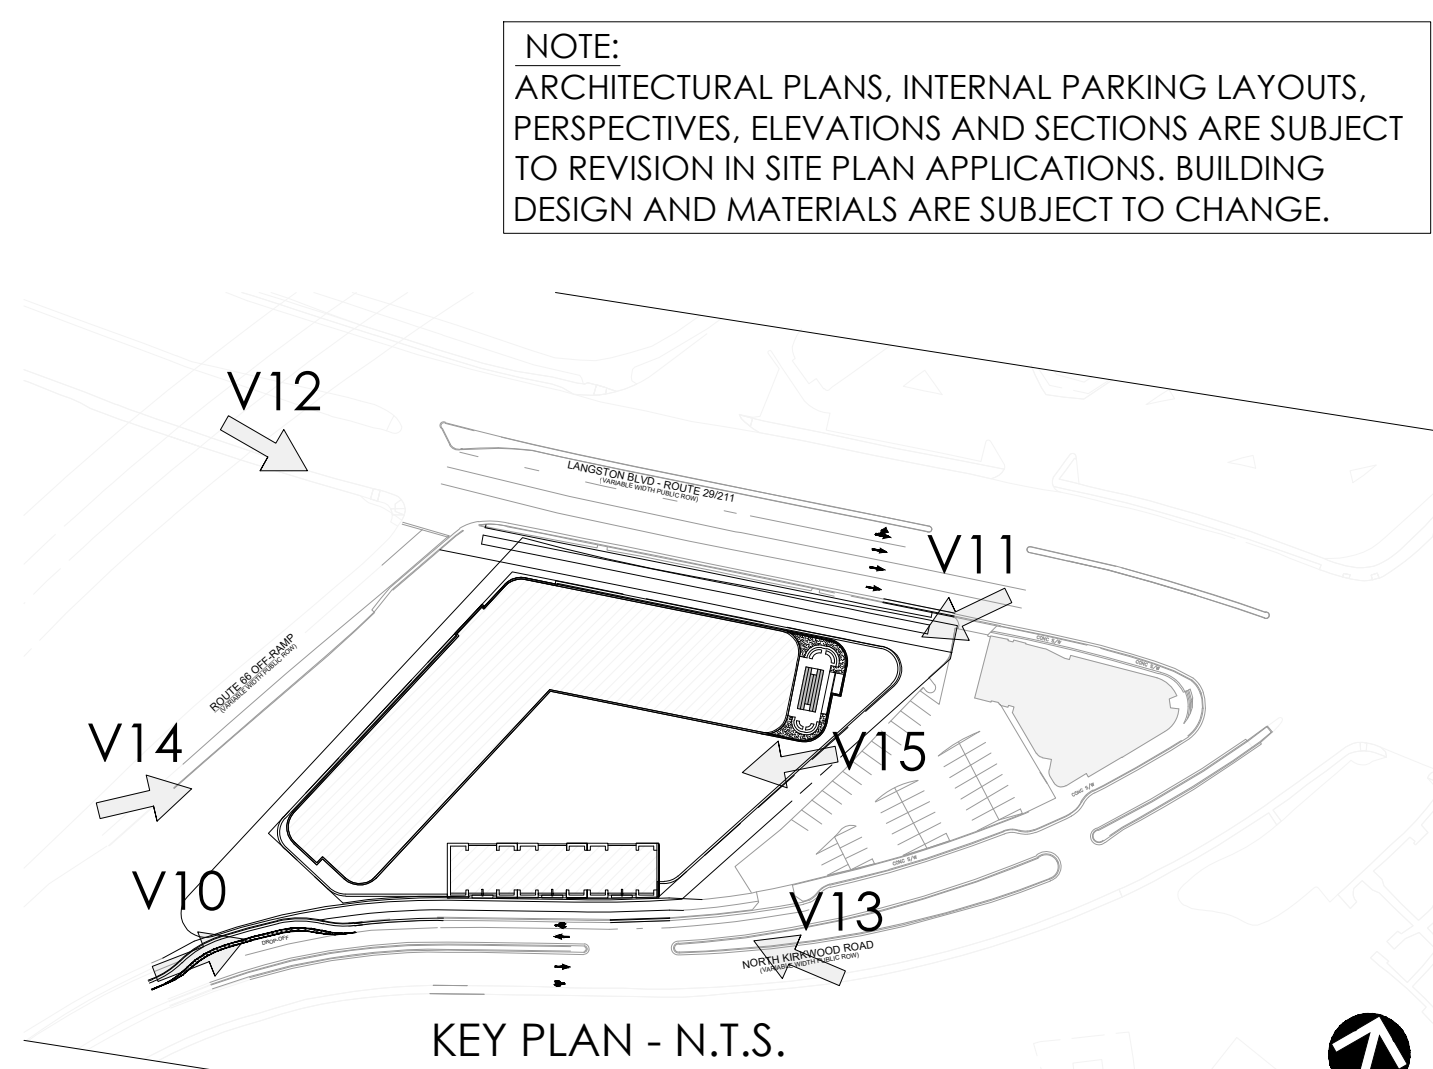VIEW 15




**dcs**  
DESIGN  
DAVIS  
CARTER  
SCOTT LLC

Architecture  
Interior Architecture  
Land Planning

3614 Westwood Center Dr.  
Suite 800  
Tysons, Virginia 22182

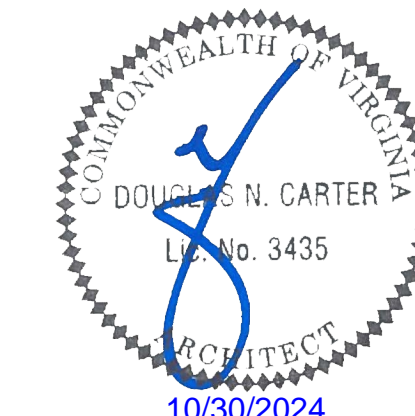P 703.556.9275  
F 703.821.6976  
www.dcsdesign.com



**ROONEY**  
PROPERTIES

Rooney Properties LLC  
3330 Washington Blvd  
UNIT 220  
Arlington, VA 22201

P 703.204.1400  
<https://rooneypropertiesllc.com/>

ISSUE	DATE
4.1 SITE PLAN SUBMISSION	08-09-24
4.1 SITE PLAN RESUBMISSION	10-29-24

PRINT DATE 10/29/2024

REVISION DATE

PROJECT TITLE  
**3130 LANGSTON  
BOULEVARD**  
ARLINGTON, VA 22201

4.1 SITE PLAN  
PROJECT NO. 322158.00

DRAWING TITLE  
**CONCEPT - VIEWS**

DRAWN BY RM  
QC CHECKED BY RV  
CA REVIEWED BY RRV

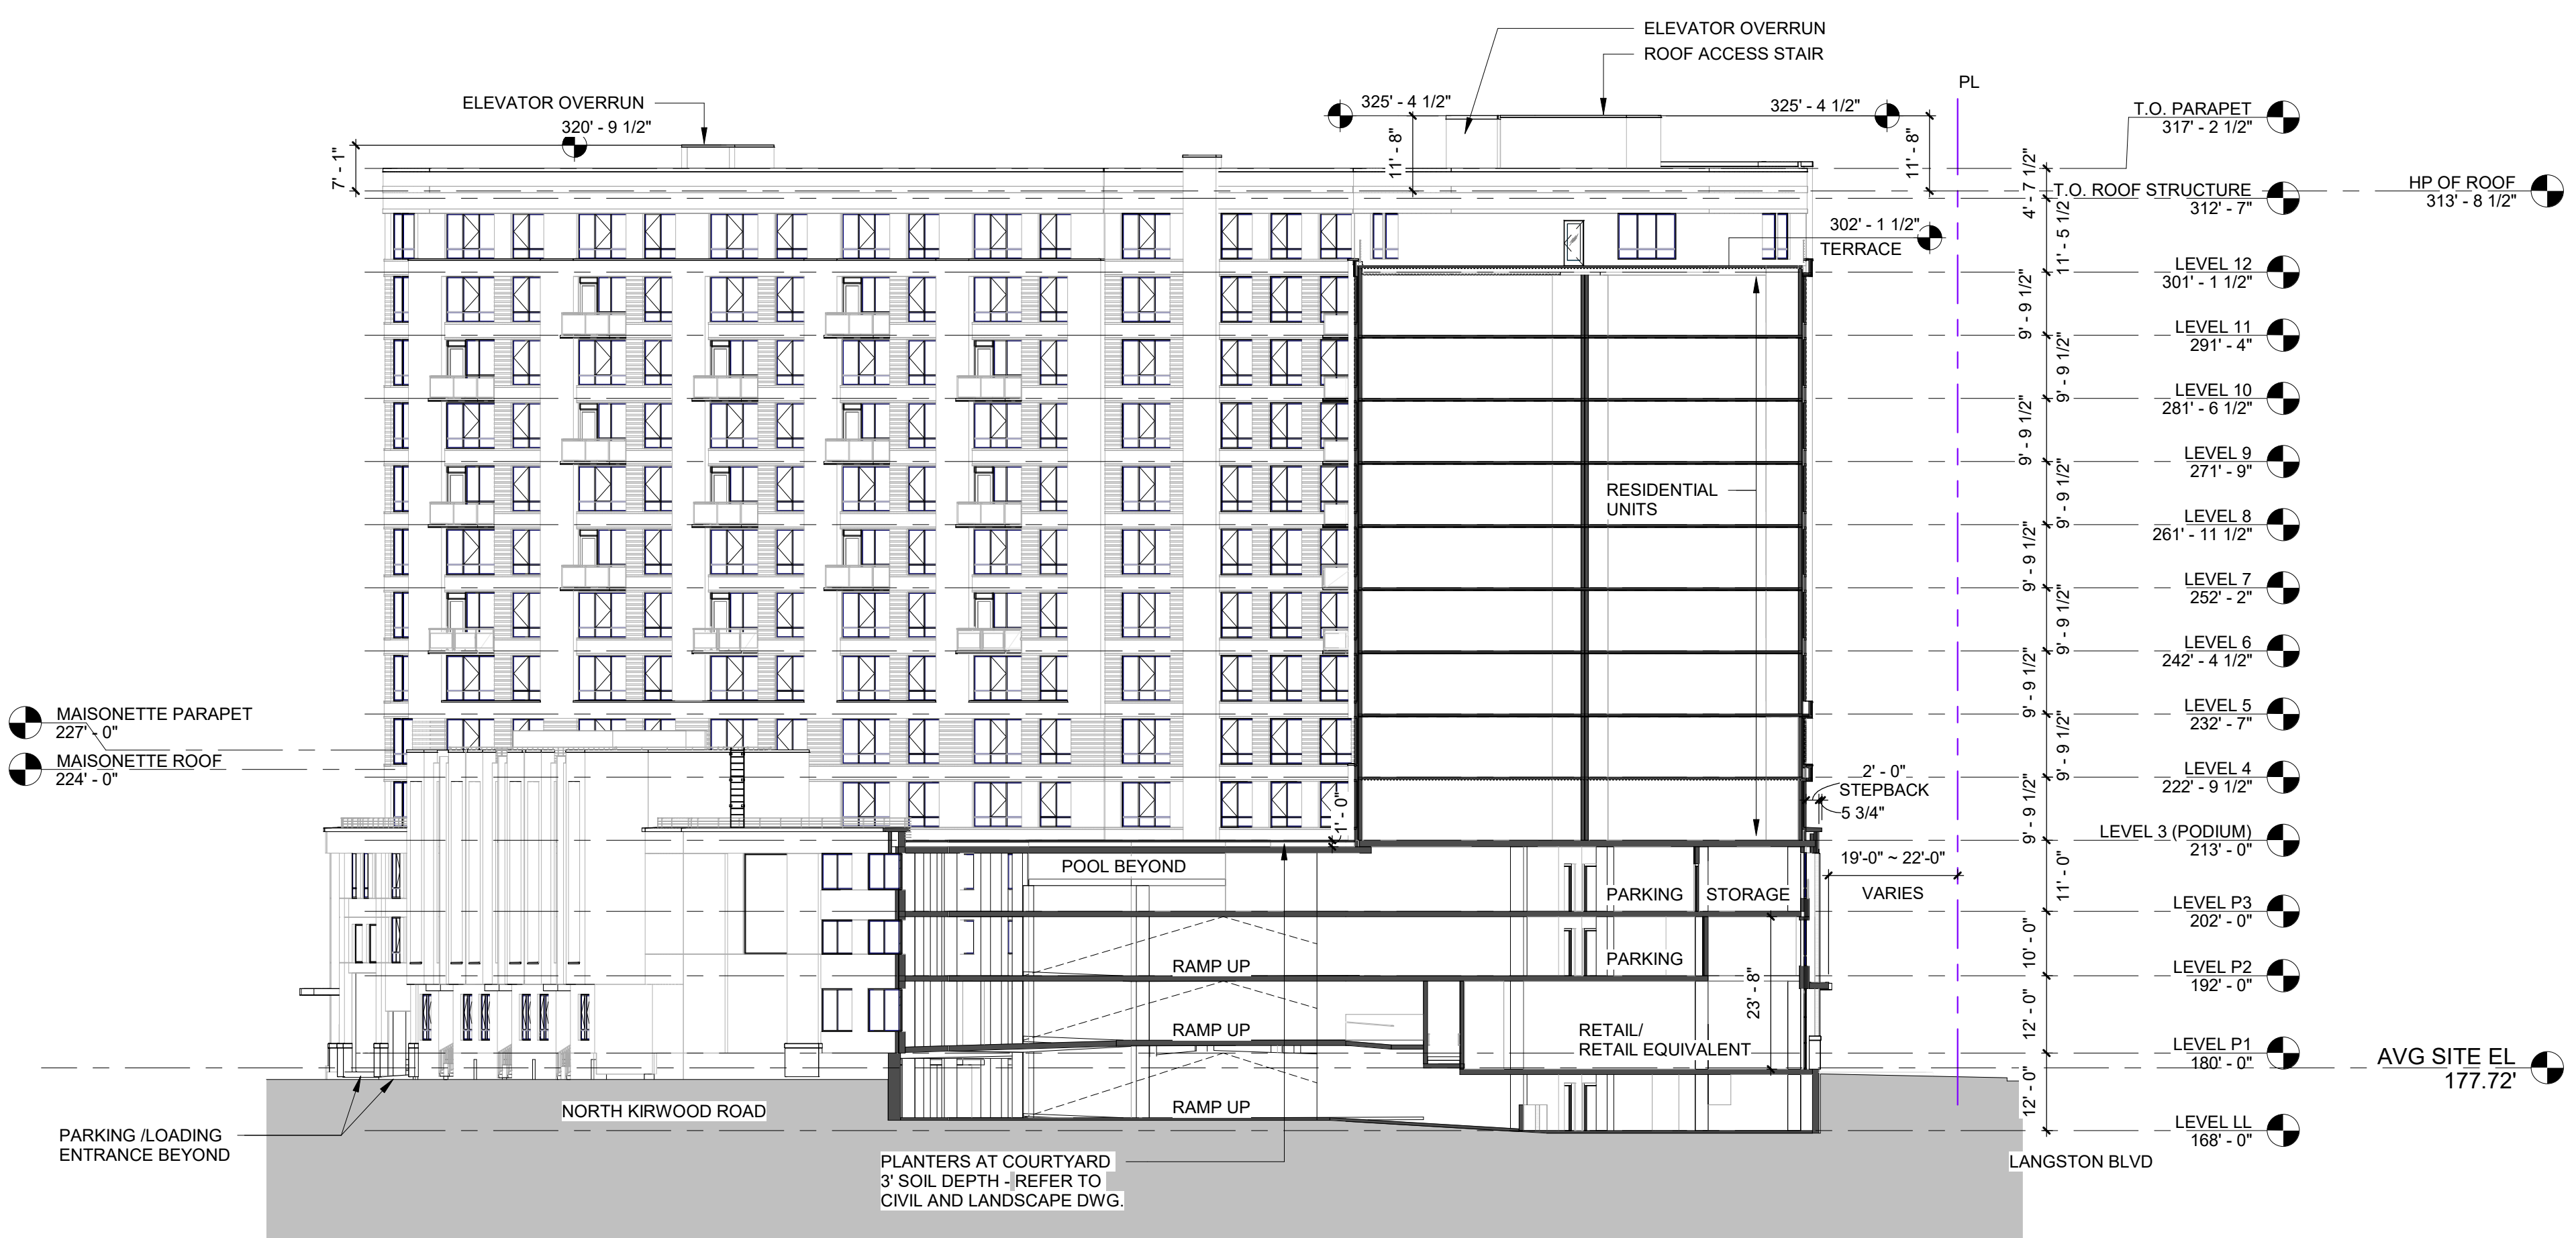
DRAWING NUMBER  
**A-19**

Urban, Ltd. - \DCS-FS\Drawings\05\_040\07\_Sheets\4.1\_REVISED\_322158.00\_16-A19\_VIEWS.dwg [A19] October 29, 2024 - 4:36pm ylfrens











**A BUILDING SECTION A-A**  
1" = 20'-0"

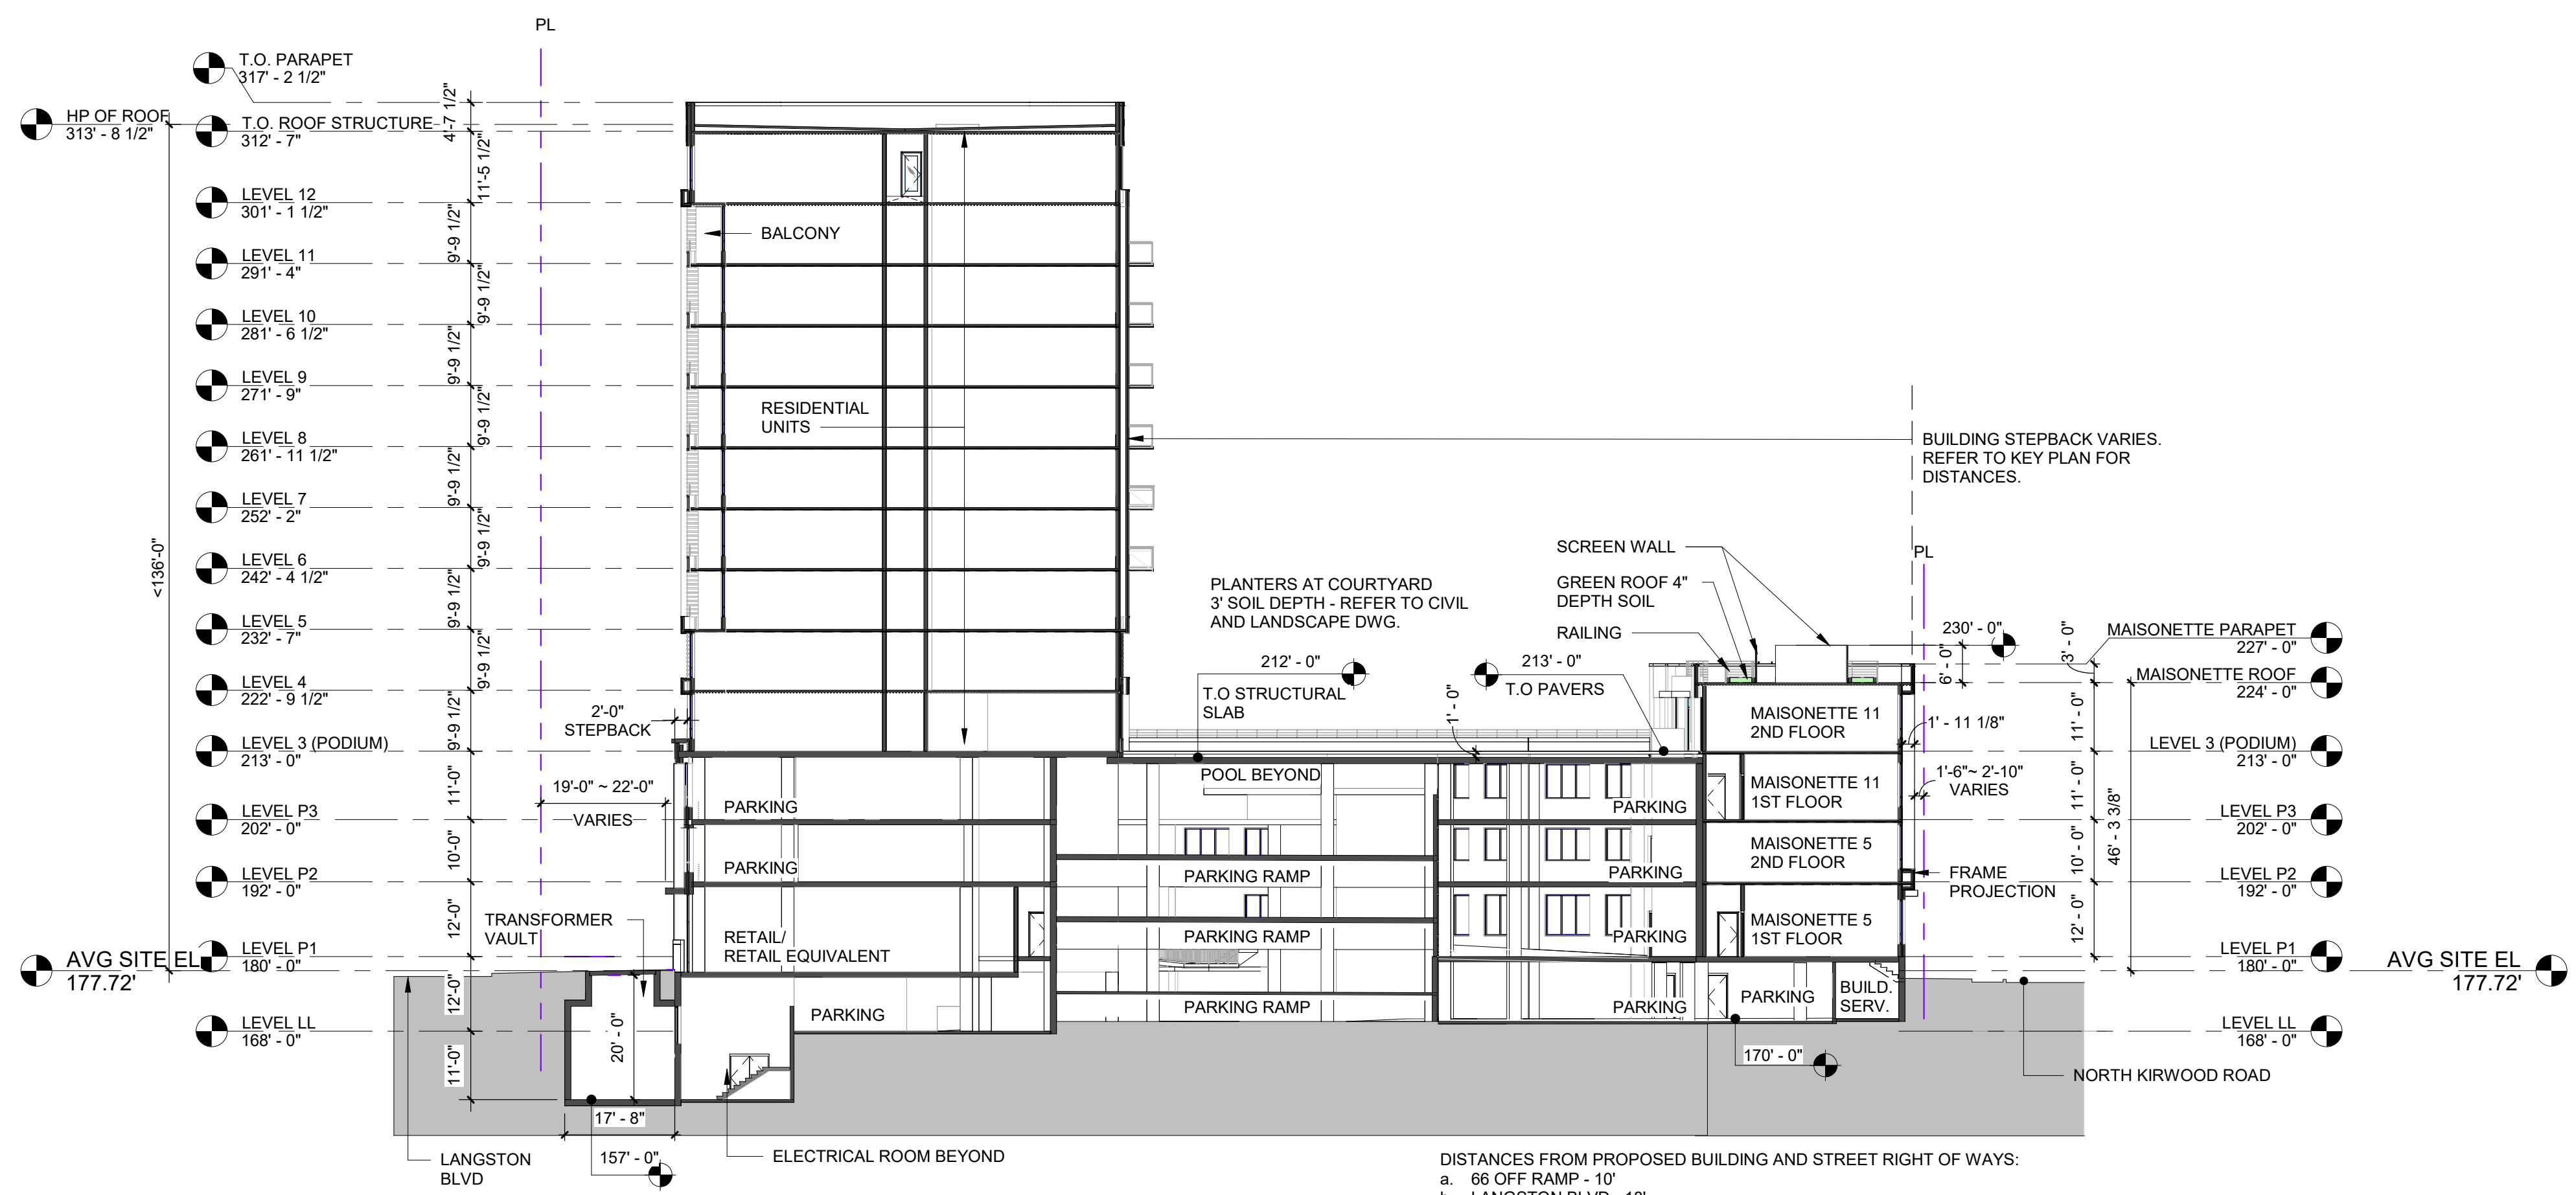DISTANCES FROM PROPOSED BUILDING AND STREET RIGHT OF WAYS:  
a. 66 OFF RAMP - 10'  
b. LANGSTON BLVD - 18'  
c. KIRKWOOD - 1'




**B BUILDING SECTION B-B**  
1" = 20'-0"

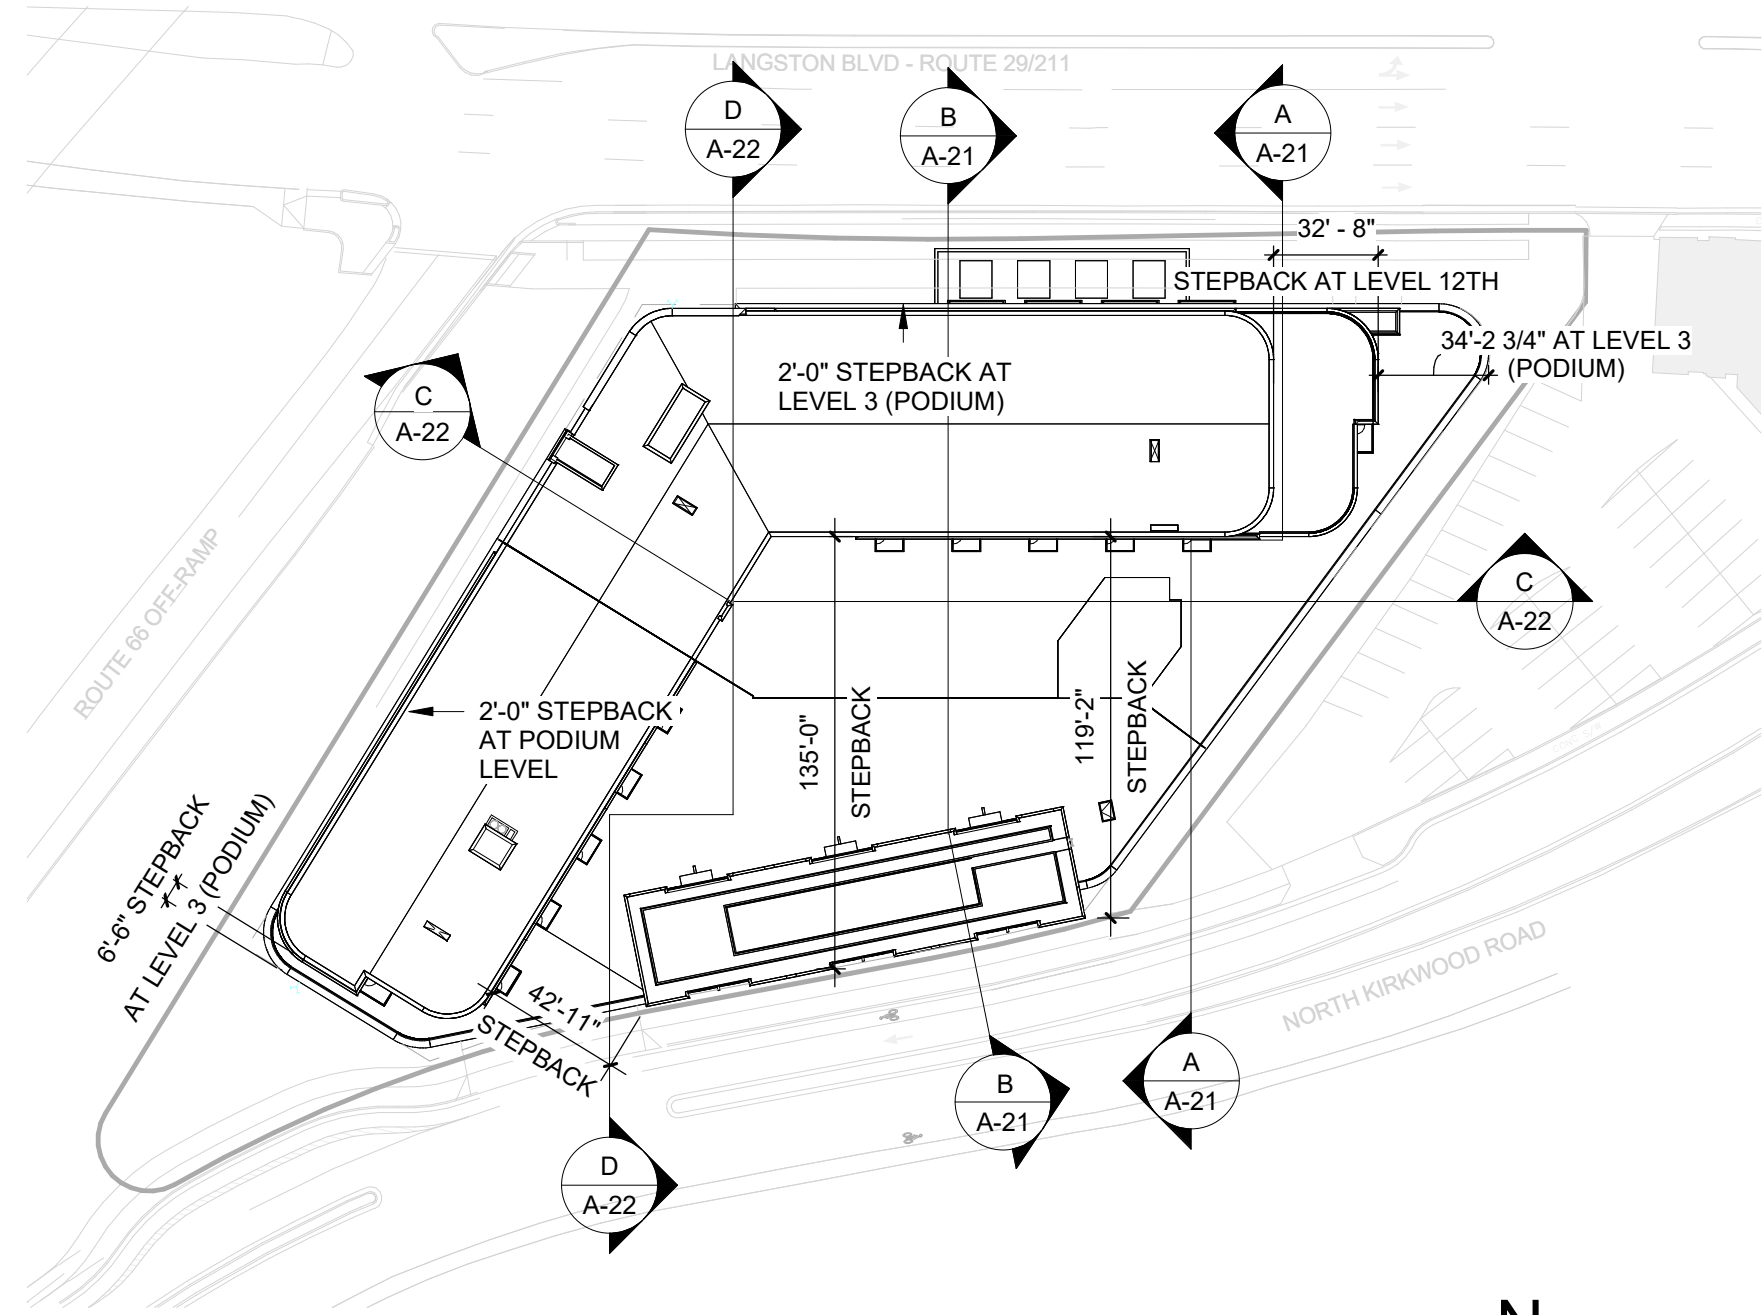
DISTANCES FROM PROPOSED BUILDING AND STREET RIGHT OF WAYS:  
a. 66 OFF RAMP - 10'  
b. LANGSTON BLVD - 18'  
c. KIRKWOOD - 1'



**KEY PLAN**  
1" = 60'-0"

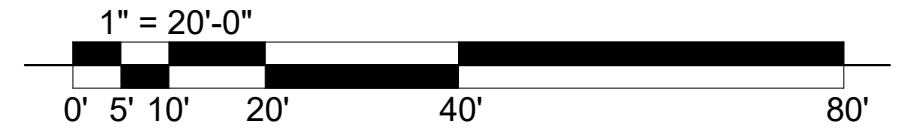




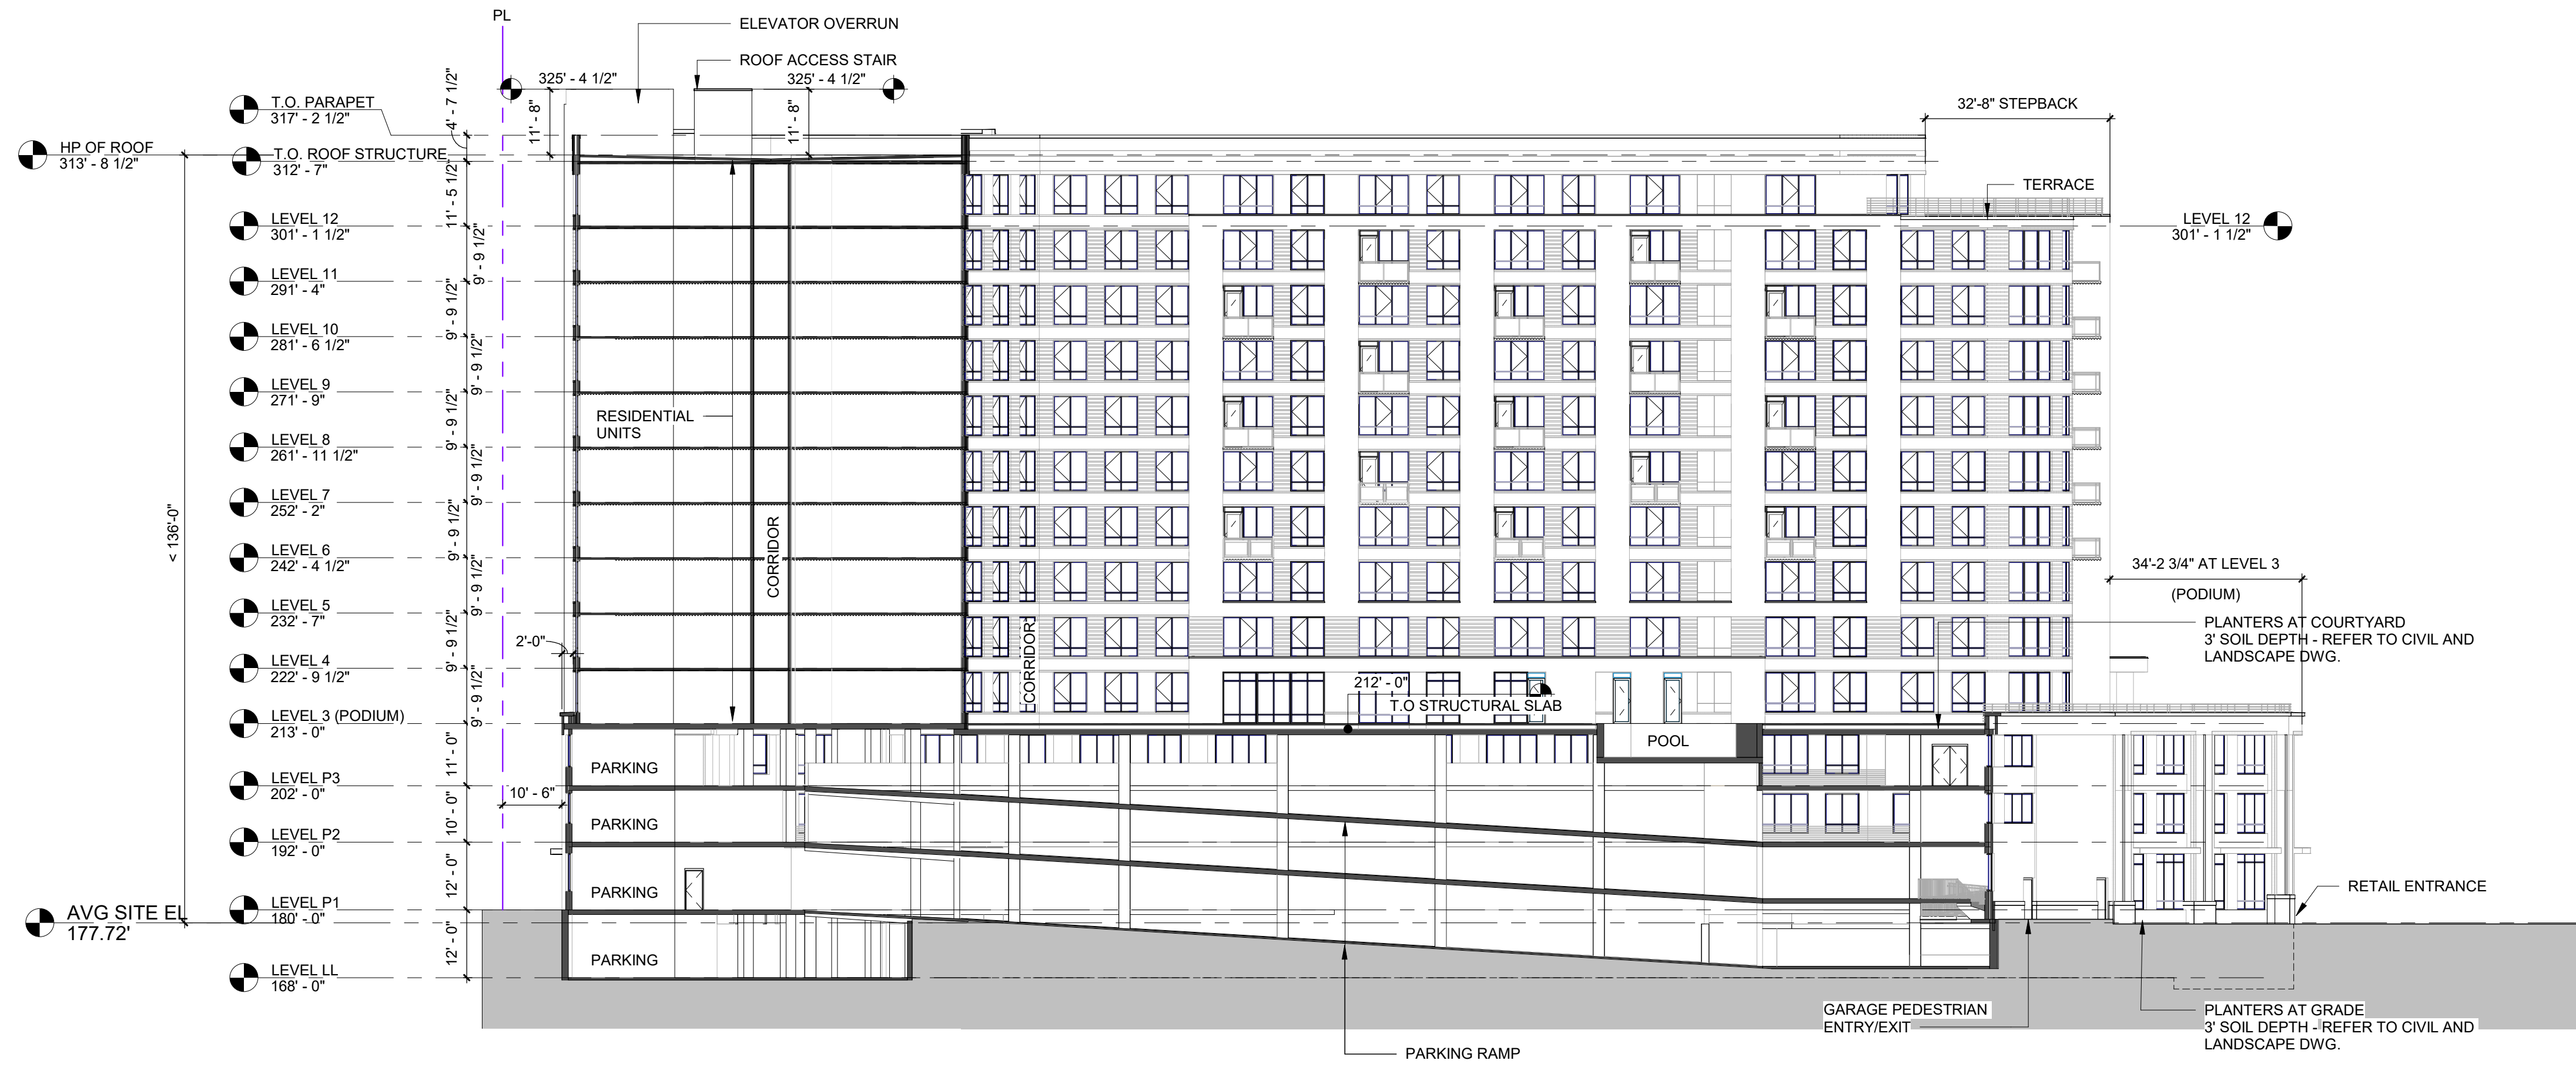


**C BUILDING SECTION C-C**  
1" = 20'-0" ref. [1 / A202]

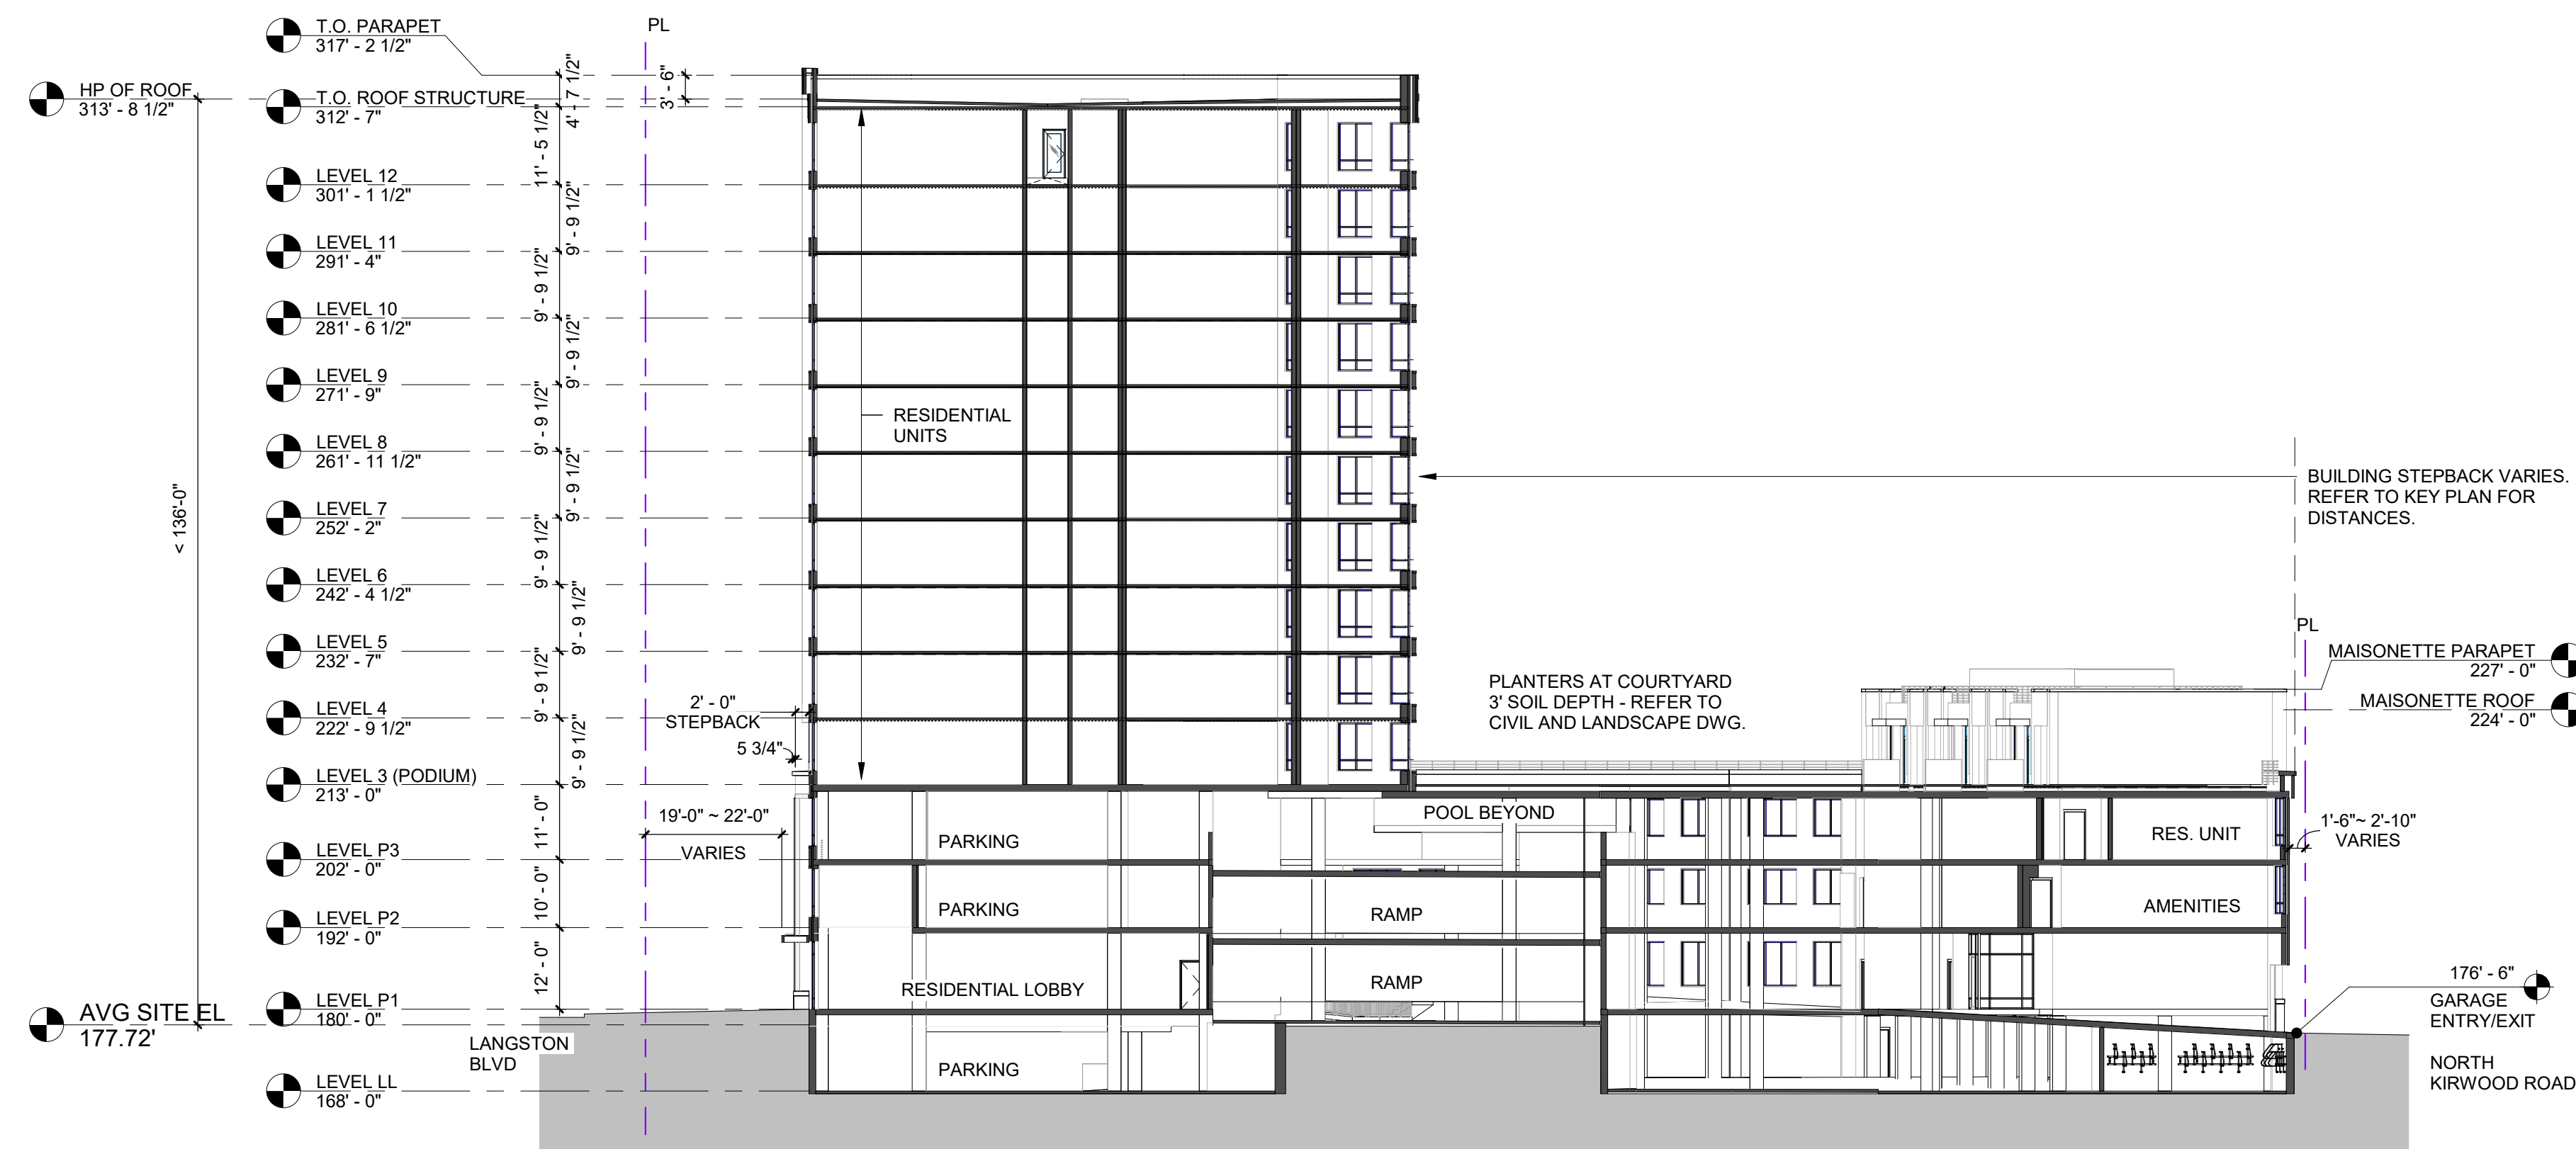DISTANCES FROM PROPOSED BUILDING AND STREET RIGHT OF WAYS:  
a. 66 OFF RAMP - 10'  
b. LANGSTON BLVD - 18'  
c. KIRKWOOD - 1'




**D BUILDING SECTION D-D**  
1" = 20'-0"

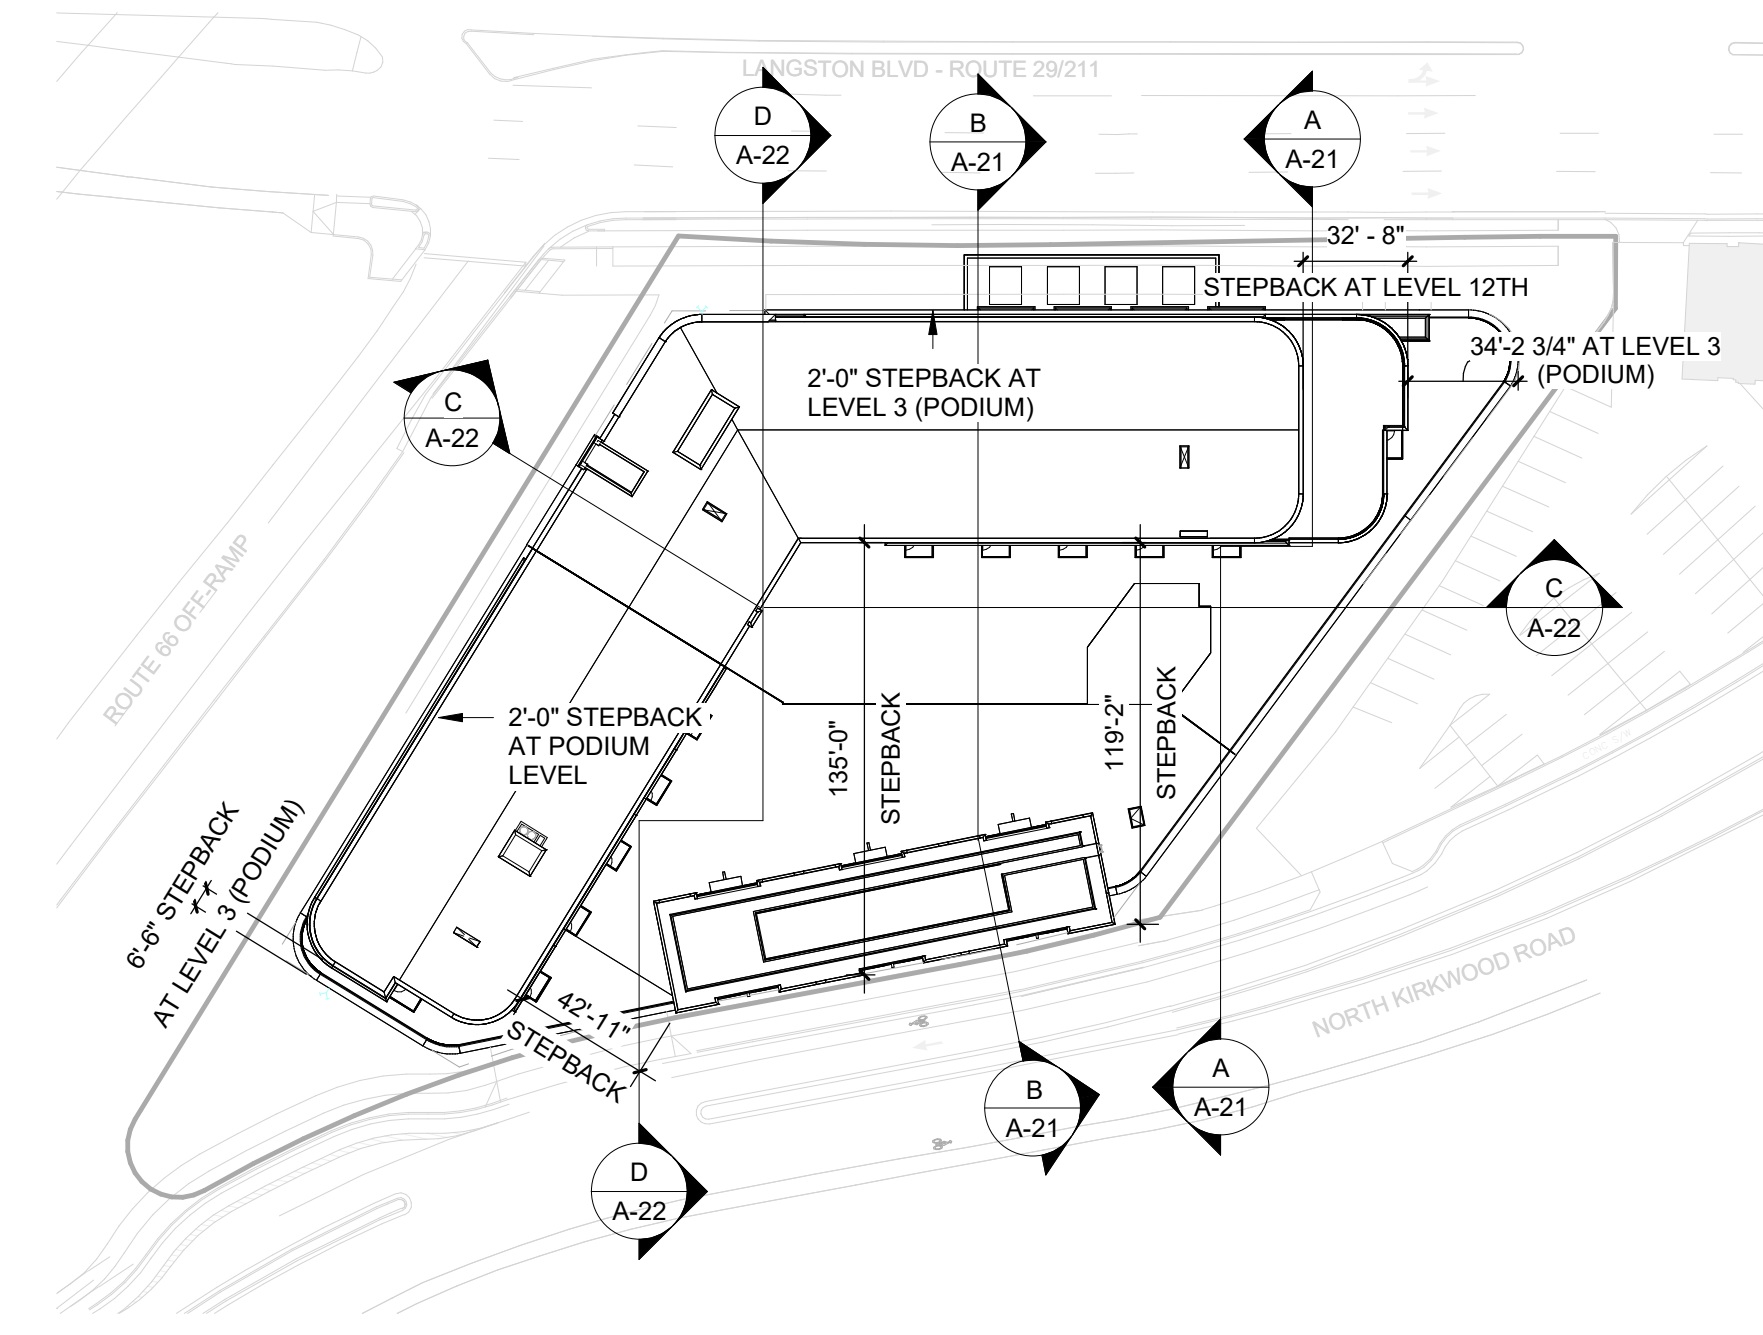DISTANCES FROM PROPOSED BUILDING AND STREET RIGHT OF WAYS:  
a. 66 OFF RAMP - 10'  
b. LANGSTON BLVD - 18'  
c. KIRKWOOD - 1'



**KEY PLAN**  
1" = 60'-0"

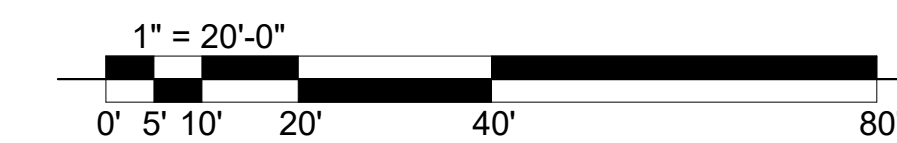















**NOTES:**

- THE SUBJECT PROPERTY IS IDENTIFIED ON ARLINGTON COUNTY, VIRGINIA AS REAL PROPERTY CODE (RPC) NO. 15-012-041 AND IS ZONED C-2.
- THE SUBJECT PROPERTY IS LOCATED IN ZONE X-NOT SHADED (AREAS DETERMINED TO BE OUTSIDE THE 0.2% ANNUAL CHANCE FLOODPLAIN), ZONE X-SHADED (AREAS OF 0.2% ANNUAL CHANCE FLOOD; AREAS OF 1% ANNUAL CHANCE FLOOD WITH AVERAGE DEPTHS OF LESS THAN 1 FOOT OR WITH DRAINAGE AREAS LESS THAN 1 SQUARE MILE; AND AREA PROTECTED BY LEVEES FROM THE 1% ANNUAL CHANCE FLOOD), AND ZONE AE (SPECIAL FOOD HAZARD AREAS SUBJECT TO INUNDATION BY THE 1% ANNUAL CHANCE FLOOD. BASE FLOOD ELEVATIONS DETERMINED) AS SHOWN ON THE FEDERAL EMERGENCY MANAGEMENT AGENCY, FLOOD INSURANCE RATE MAP (FIRM) NUMBER 510130038C, COMMUNITY PANEL 515520 038 C, FOR ARLINGTON COUNTY, DATED AUGUST 19, 2013.
- THE HORIZONTAL DATUM SHOWN HEREON IS REFERENCED TO VIRGINIA COORDINATE SYSTEM OF 1983 (VCS '83).
- THE VERTICAL DATUM SHOWN HEREON IS REFERENCED TO THE NORTH AMERICAN VERTICAL DATUM OF 1988 (NAVD 88).
- THE HORIZONTAL AND VERTICAL DATUMS SHOWN HEREON ARE BASED ON A GPS SURVEY PERFORMED BY VIKI VIRGINIA, LLC ON MARCH 24, 2023.
- BOUNDARY INFORMATION SHOWN HEREON IS BASED UPON A FIELD RUN SURVEY BY VIKI VIRGINIA, LLC.
- THE SURVEY CONTROL ESTABLISHED BY VIKI VIRGINIA, LLC AND USED TO DETERMINE THE BOUNDARY HAS A HORIZONTAL PRECISION OF 1:291432 WHICH EXCEEDS THE MINIMUM HORIZONTAL PRECISION OF 1:20,000 AS REQUIRED BY THE COMMONWEALTH OF VIRGINIA.
- CONTOUR INTERVAL SHOWN HEREON IS 2'-0".
- THE AVERAGE SITE ELEVATION TAKEN AT THE PERIMETER OF THE SUBJECT PROPERTY IS 177.72'.
- BUILDING HEIGHT CALCULATIONS FOR THE SUBJECT PROPERTY ARE BASED UPON THE VERTICAL DIFFERENCE BETWEEN THE ROOF ELEVATION AND THE AVERAGE SITE ELEVATION (177.72').
- THE SUBJECT PROPERTY IS NOT LOCATED IN A HISTORIC DISTRICT PER ARLINGTON COUNTY LOCAL HISTORIC SITES AND DISTRICTS MAP DATED 2004.
- A PORTION OF THE SUBJECT PROPERTY LIES WITHIN A RESOURCE PROTECTION AREA (RPA) PER ARLINGTON COUNTY STREAMS, WATERSHEDS, AND RESOURCE PROTECTION AREAS MAP DATED 2007.
- THE EXISTING CONDITIONS SURVEY WAS COMPLETED UNDER THE DIRECT RESPONSIBLE CARE OF LISA M. GOODWIN, L.S. FROM AN ACTUAL GROUND SURVEY MADE UNDER MY SUPERVISION; THAT THE ORIGINAL DATA WAS OBTAINED ON MARCH 29, 2024 THRU APRIL 2, 2024.
- UTILITIES SHOWN HEREON ARE BASED UPON: SUE QUALITY LEVEL B (OL-B) - FIELD SURVEY UTILIZING SURFACE GEOPHYSICAL TECHNIQUES TO DETERMINE THE EXISTENCE AND APPROXIMATE HORIZONTAL POSITION OF UNDERGROUND UTILITIES WITHIN THE AREA OF INTEREST; UTILITIES LOCATED OUTSIDE THE AREA OF INTEREST ARE OL-C OR OL-D. GRAVITY DEPENDENT UTILITY SYSTEMS (STORM AND SANITARY SEWERS) SHOWN HEREON ARE NOT INCLUDED IN THE OL-B SURVEY; FIELD SURVEY OF VISIBLE ABOVE-GROUND UTILITY FACILITIES, SUCH AS MANHOLES, VALVE BOXES, ETC.; IN ADDITION TO EXISTING UTILITY RECORDS.
- STEWART TITLE GUARANTY COMPANY, COMMITMENT OF TITLE INSURANCE, FILE NO. 8083-JIAT-C WITH AN EFFECTIVE DATE OF JULY 26, 2022 AT 8:00 A.M. HAS BEEN INCORPORATED INTO THIS SURVEY. ALL KNOWN, PLOTTABLE EASEMENTS OF RECORD ARE SHOWN.
- COMMON BOUNDARY LINES WITH THE SUBJECT PROPERTY AND ADJOINING BOUNDARIES ARE CONTIGUOUS, WITH NO GAPS, CORES OR OVERLAPS, UNLESS NOTED OTHERWISE HEREON.
- THERE IS NO OBSERVED EVIDENCE OF WETLANDS FIELD DELINEATION ON THE SUBJECT PROPERTY.
- THERE IS NO OBSERVED EVIDENCE OF CEMETERIES OR BURIAL GROUNDS ON THE SUBJECT PROPERTY.

**LEGAL DESCRIPTION:**

BEING ALL OF THE PROPERTY OF RP LANGSTON I LLC AS RECORDED IN INSTRUMENT 20230100005740 AMONG THE LAND RECORDS OF ARLINGTON COUNTY, VIRGINIA AND BEING MORE PARTICULARLY DESCRIBED AS FOLLOWS:  
 BEGINNING FOR THE SAME AT A DRILL HOLE FOUND LYING ON THE SOUTHERLY RIGHT-OF-WAY LINE OF LANGSTON BOULEVARD - RTE 29-211 (VARIABLE WIDTH PUBLIC R/W), SAID DRILL HOLE FOUND ALSO MARKING THE COMMON NORTHERLY CORNER BETWEEN THE AFORESAID PROPERTY OF RP LANGSTON I LLC AND THE PROPERTY OF FAMOUS PAWN, INC. AS RECORDED IN INSTRUMENT 20230100004248 AMONG THE AFORESAID LAND RECORDS; THENCE DEPARTING SAID SOUTHERLY RIGHT-OF-WAY LINE OF LANGSTON BOULEVARD AND RUNNING WITH SAID PROPERTY OF FAMOUS PAWN, INC. THE FOLLOWING TWO (2) COURSES AND DISTANCES:  
 1. SOUTH 02°51'10" WEST, 22.41 FEET TO A PK NAIL FOUND; THENCE  
 2. SOUTH 39°14'10" WEST, 237.43 FEET TO AN OPEN END IRON PIPE FOUND MARKING A POINT OF CURVATURE (NON-TANGENT) LYING ON THE NORTHERLY RIGHT-OF-WAY LINE OF NORTH KIRKWOOD ROAD (VARIABLE WIDTH PUBLIC R/W); THENCE DEPARTING THE AFORESAID PROPERTY OF FAMOUS PAWN, INC. (INST 20230100004248) AND RUNNING WITH SAID NORTHERLY RIGHT-OF-WAY LINE OF NORTH KIRKWOOD ROAD THE FOLLOWING FOUR (4) COURSES AND DISTANCES:  
 3. 64.39 FEET ALONG THE ARC OF A CURVE TO THE RIGHT HAVING A RADIUS OF 680.12 FEET AND A CHORD BEARING AND DISTANCE OF SOUTH 79°10'55" WEST, 64.37 FEET TO A REBAR FOUND MARKING A POINT OF TANGENCY; THENCE  
 4. SOUTH 81°53'40" WEST, 90.21 FEET TO AN IRON PIPE FOUND W/CAP MARKING A POINT OF CURVATURE (TANGENT); THENCE  
 5. 157.42 FEET ALONG THE ARC OF A CURVE TO THE LEFT HAVING A RADIUS OF 471.74 FEET AND A CHORD BEARING AND DISTANCE OF SOUTH 72°20'05" WEST, 156.69 FEET TO AN IRON PIPE FOUND W/CAP MARKING A POINT OF REVERSE CURVATURE; THENCE  
 6. 42.24 FEET ALONG THE ARC OF A CURVE TO THE RIGHT HAVING A RADIUS OF 16.00 FEET AND A CHORD BEARING AND DISTANCE OF NORTH 41°34'51" WEST, 31.00 FEET TO AN IRON PIPE FOUND W/CAP (BENT) (NON-TANGENT) MARKING THE INTERSECTION OF THE LINE OF NORTH KIRKWOOD ROAD AND THE SOUTHEASTERNLY RIGHT-OF-WAY LINE OF INTERSTATE 66 - RAMP F (VARIABLE WIDTH PUBLIC R/W); THENCE DEPARTING SAID NORTHERLY RIGHT-OF-WAY LINE OF NORTH KIRKWOOD ROAD AND RUNNING WITH SAID SOUTHEASTERNLY RIGHT-OF-WAY LINE OF INTERSTATE 66 - RAMP F THE FOLLOWING TWO (2) COURSES AND DISTANCES:  
 7. NORTH 34°04'10" EAST, 171.29 FEET TO AN OPEN END IRON PIPE FOUND; THENCE  
 8. NORTH 34°04'10" EAST, 152.46 FEET TO A DRILL HOLE FOUND MARKING A POINT OF CURVATURE (NON-TANGENT) LYING ON THE AFORESAID SOUTHERLY RIGHT-OF-WAY LINE OF LANGSTON BOULEVARD; THENCE DEPARTING THE AFORESAID SOUTHEASTERNLY RIGHT-OF-WAY LINE OF INTERSTATE 66 - RAMP F AND RUNNING WITH SAID SOUTHERLY RIGHT-OF-WAY LINE OF LANGSTON BOULEVARD THE FOLLOWING THREE (3) COURSES AND DISTANCES:  
 9. 116.21 FEET ALONG THE ARC OF A CURVE TO THE LEFT HAVING A RADIUS OF 1387.60 FEET AND A CHORD BEARING AND DISTANCE OF SOUTH 86°10'29" EAST, 116.17 FEET TO A POINT OF TANGENCY MARKED BY AN 1" OPEN END IRON PIPE FOUND; THENCE  
 10. SOUTH 88°34'26" EAST, 129.34 FEET TO A DRILL HOLE FOUND MARKING A POINT OF CURVATURE (TANGENT); THENCE  
 11. 47.16 FEET ALONG THE ARC OF A CURVE TO THE RIGHT HAVING A RADIUS OF 1850.00 FEET AND A CHORD BEARING AND DISTANCE OF SOUTH 87°50'37" EAST, 47.15 FEET TO THE POINT OF BEGINNING CONTAINING 73,254 SQUARE FEET OR 1.68168 ACRES OF LAND, MORE OR LESS.

**LEGEND:**

- |                              |                              |
|------------------------------|------------------------------|
| CONC CONCRETE                | ⊗ ELECTRICAL MANHOLE         |
| C&G CURB AND GUTTER          | ⊕ ELECTRICAL JUNCTION BOX    |
| TRANS ELECTRICAL TRANSFORMER | ⊙ GUY POLE                   |
| ASPH ASPHALT                 | ⊙ LIGHT POLE                 |
| ESMT EASEMENT                | ⊙ GROUND LIGHT               |
| BLDG BUILDING                | ⊙ UTILITY POLE               |
| RCP REINFORCED CONCRETE PIPE | ⊙ PHONE MANHOLE              |
| CMP CORRUGATED METAL PIPE    | ⊙ CABLE TELEVISION PEDESTAL  |
| R/W RIGHT-OF-WAY             | ⊙ PUBLIC UTILITIES EASEMENTS |
| HCR HANDICAP RAMP            | ⊙ SANITARY SEWER CONDUIT     |
| DB DEED BOOK                 | ⊙ STORM DRAIN CONDUIT        |
| PG PAGE                      | ⊙ WATER CONDUIT              |
| SSWR SANITARY SEWER          | ⊙ GUARD RAIL                 |
| STRM STORM SEWER/DRAIN       | ⊙ TREE                       |
|                              | ⊙ HANDICAP                   |
|                              | ⊙ HVAC UNIT                  |
|                              | ⊙ UNKNOWN UTILITY MANHOLE    |
|                              | ⊙ BOLLARD                    |
|                              | ⊙ CENTERLINE                 |
|                              | ⊙ SIGN POST                  |
|                              | ⊙ IRON PIPE FOUND            |
|                              | ⊙ REBAR FOUND                |
|                              | ⊙ PKNAIL FOUND               |
|                              | ⊙ DRILL HOLE FOUND           |
|                              | ⊙ TRAFFIC CONTROL BOX        |
|                              | ⊙ TRAFFIC SIGNAL POLE        |
|                              | ⊙ STORM DRAIN MANHOLE        |
|                              | ⊙ CATCH BASIN RIM            |
|                              | ⊙ INLETS                     |
|                              | ⊙ CURB INLET                 |
|                              | ⊙ SANITARY MANHOLE           |
|                              | ⊙ SANITARY CLEANOUT          |
|                              | ⊙ WATER METER                |
|                              | ⊙ WATER MANHOLE              |
|                              | ⊙ WATER VALVE                |
|                              | ⊙ FIRE HYDRANT               |
|                              | ⊙ FIRE DEPARTMENT CONNECTION |
|                              | ⊙ IRRIGATION CONTROL VALVE   |


**AREA TABULATION:**

RPC 15-012-041 73,254 SF OR 1.68168 AC EX ZONE: C-2



CURVE TABLE					
CURVE	LENGTH	RADIUS	DELTA	TANGENT	CHORD BRG
C1	116.21'	1387.60'	004°47'54"	58.14'	S86°10'29"E
C2	47.16'	1850.00'	001°27'38"	23.58'	S87°50'37"E
C3	64.39'	680.12'	005°25'29"	32.22'	S79°10'55"W
C4	157.42'	471.74'	019°07'11"	79.45'	S72°20'05"W
C5	42.24'	16.00'	151°17'18"	62.51'	N41°34'51"W

**PARKING TABULATION:**

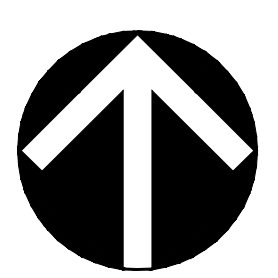STANDARD STRIPED PARKING SPACES 58  
 HANDICAP STRIPED PARKING SPACES 4  
 TOTAL STRIPED PARKING SPACES ON SITE 62  
 \* PARKING SPACES SHOWN HEREON ARE BASED ON FIELD LOCATIONS AND VISUAL INSPECTION. VIKI VIRGINIA, LLC DOES NOT CERTIFY THAT SPACES ARE STRIPED IN ACCORDANCE WITH REQUIRED JURISDICTIONAL STANDARDS.




**GRAPHIC SCALE**

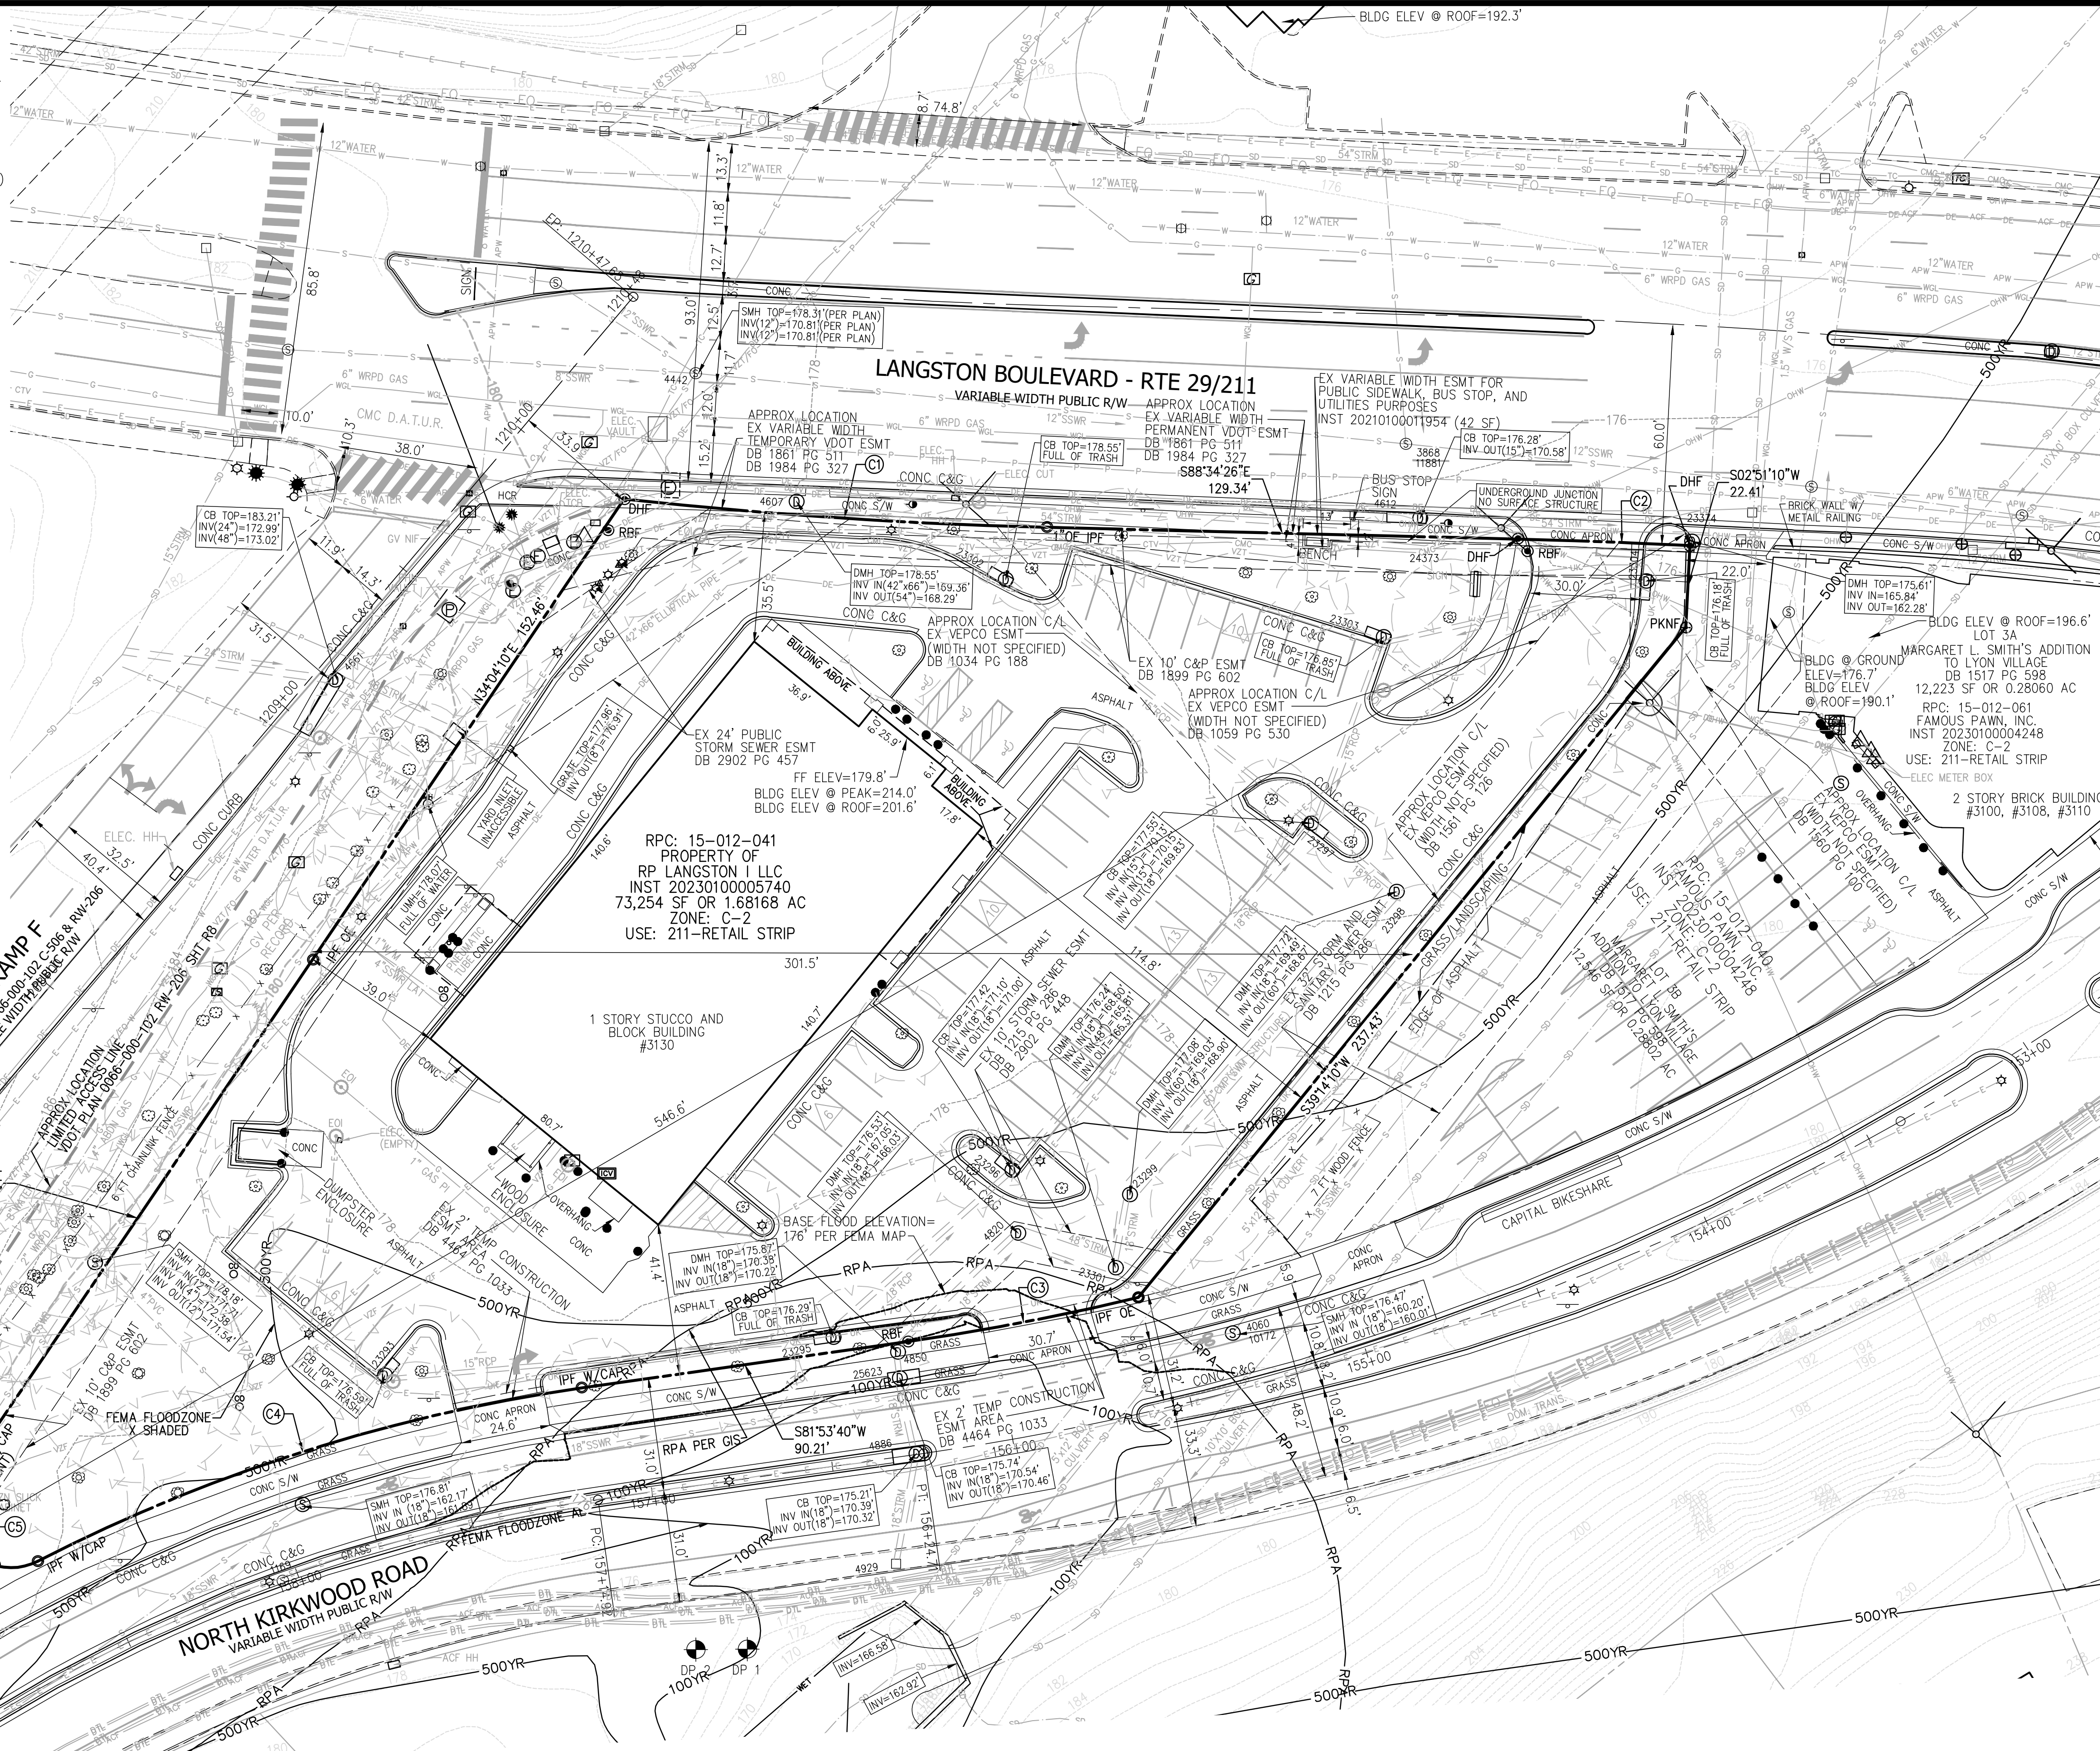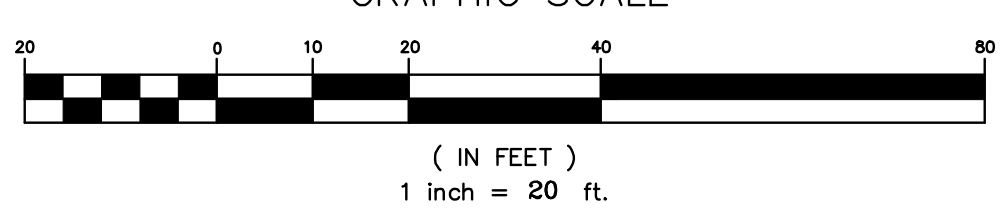

**VIKA VIRGINIA, LLC**  
 8180 Greensboro Dr., Suite 200  
 Tysons, VA 22102  
 703.442.7800 | vika.com  
 Our Site Set on the Future.

PLAN STATUS	DATE
4.1 SITE PLAN SUBMISSION	08/09/2024
4.1 SITE PLAN RESUBMISSION	10/29/2024

POST-APPROVAL SHEET STATUS	DATE

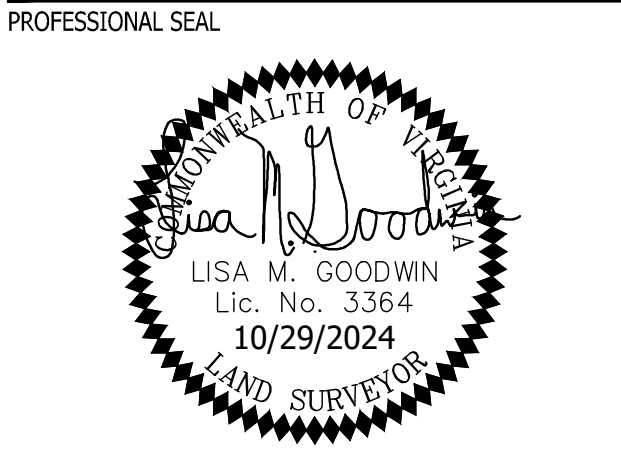

**3130 LANGSTON BOULEVARD**  
 4.1 SITE PLAN  
 ARLINGTON COUNTY, VIRGINIA

**CERTIFIED SURVEY**

DRAWN BY: LMG  
 DESIGNED BY: LMG  
 DATE ISSUED: 08/09/2024  
 DWG. SCALE: 1" = 25'  
 VIKI NO.: VV8574A  
 SHEET NO.: C-01



















Tree No.	Species	Size	CRZ	Field Condition	Species Rating	Disturbed Area Within CRZ	Canopy Position	Total Score	Status	Invasive Species	Replacement Trees Requirement	Tree Replacement Totals For All Trees Inventoried (FOR INFORMATION ONLY)	Existing Tree Condition Observations
		*DBH (in)	R (ft)	%		%							
729	Quercus phellos, Willow Oak	15.3	16	0.75	0.75	100.0%	Dominant	8.6	Remove	NO	2	2	NO APPARENT BIOTIC ISSUES OBSERVED. GOOD COLOR, VIGOR, VITALITY & STRUCTURE. DEADWOOD AT LOWER CANOPY. ROOT GIRDLE.
709	Quercus phellos, Willow Oak	15.7	16	0.75	0.75	100.0%	Dominant	8.8	Remove	NO	2	2	NO APPARENT BIOTIC ISSUES OBSERVED. GOOD COLOR, VIGOR, VITALITY & STRUCTURE. DEADWOOD AT LOWER CANOPY.
710	Quercus phellos, Willow Oak	20.6	21	0.63	0.75	100.0%	Dominant	9.7	Remove	NO	2	2	NO SEVERE BIOTIC ISSUES OBSERVED. GOOD COLOR, VIGOR & VITALITY. FAIR/GOOD (F/G) STRUCTURE. DEADWOOD IN CANOPY. INVASIVE ENGLISH IVY POPULATED IN CRZ. INVASIVE VINE FROM GRADE TO CANOPY.
711	Zelkova serrata, Zelkova	27.0	27	0.63	0.75	100.0%	Dominant	12.8	Remove	NO	3	3	NO SEVERE BIOTIC ISSUES OBSERVED. GOOD COLOR, VIGOR & VITALITY. FAIR/GOOD (F/G) STRUCTURE. ENGLISH IVY (EI) POPULATED AT GRADE IN CRITICAL ROOT ZONE AND FROM GRADE TO CANOPY. MULTI-STEM TRUNK UNION W/ LOW ANGLE "V" CONNECTIONS. DEADWOOD POPULATED W/ FUN.
712	Acer rubrum, Red Maple	9.6	10	0.60	0.70	100.0%	Codominant	4.0	Remove	NO	1	1	NO SEVERE BIOTIC ISSUES OBSERVED. GOOD COLOR, VIGOR & VITALITY. ASYMMETRIC CANOPY WITH DEADWOOD. ROOT GIRDLE AT GRADE. UPPER TRUNK STEM HAS AN APPROX ~12" LEAN.
713	Zelkova serrata, Zelkova	25.0	25	0.65	0.75	100.0%	Dominant	12.2	Remove	NO	3	3	NO SEVERE BIOTIC ISSUES OBSERVED. GOOD COLOR, VIGOR & VITALITY. FAIR/GOOD STRUCTURE. DEADWOOD IN CANOPY. ENGLISH IVY (EI) POPULATED AT GRADE IN CRITICAL ROOT ZONE AND FROM GRADE TO CANOPY. MULTI-STEM TRUNK UNION W/ LOW ANGLE "V" CONNECTIONS.
714	Quercus phellos, Willow Oak	24.0	24	0.75	0.75	100.0%	Dominant	13.5	Remove	NO	3	3	NO APPARENT BIOTIC ISSUES OBSERVED. GOOD COLOR, VIGOR, VITALITY & STRUCTURE. TREE SHOWS ROOT GIRDLE.
715	Tsuga canadensis, Dwarf Weeping Hemlock	18.0	0	0.00	0.60	N/A	Dominant	0.0	Remove	NO	0	0	TREE - 715 IS DEAD.
716	Zelkova serrata, Zelkova	34.7	35	0.62	0.75	26.5%	Dominant	16.1	Remove	NO	4	4	NO SEVERE BIOTIC ISSUES OBSERVED. GOOD COLOR, VIGOR & VITALITY. FAIR/POOR (F/P) STRUCTURE. MULTI-STEM TRUNK UNION W/ LOW ANGLE "V" & INCLUDED BARK/DEADWOOD IN CANOPY & INVASIVE ENGLISH IVY FROM GRADE TO UPPER TRUNK STEM. T-717 W/ EXTREM INVASIVE ENGLISH IVY & WILD GRAPE FROM GRADE TO CANOPY. TREE WITH SIGNIFICANT DEADWOOD & POOR SCAFFOLD BRANCHING.
717	Pyrus calleryana, Callery Pear	8.3	9	0.10	0.50	0.0%	Codominant	0.4	Preserve	YES	0	0	T-718 SHOWS DECLINE. EXISTING INVASIVE ENGLISH IVY FROM GRADE TO CANOPY. ~25" UPPER CANOPY LEAN. POOR SCAFFOLD BRANCHING & LOW CANOPY RATIO. FAIR/POOR STRUCTURE.
718	Pyrus calleryana, Callery Pear	6.7	8	0.28	0.50	0.0%	Codominant	1.1	Preserve	YES	0	1	T-719 W/ V-POOR STRUCTURE. INVASIVE ENGLISH IVY FROM GRADE TO CANOPY. ~20" UPPER CANOPY TRUNK STEM LEAN. V-POOR CANOPY RATION & SCAFFOLD BRANCHING.
719	Pyrus calleryana, Callery Pear	3.8	8	0.23	0.50	0.0%	Intermediate	0.4	Preserve	YES	0	0	NO SEVERE BIOTIC ISSUES OBSERVED. GOOD COLOR, VIGOR & VITALITY. FAIR/GOOD SCAFFOLD BRANCHING. LOW CANOPY RATIO.
719.1	Prunus serotina, Black Cherry	5.8	8	0.60	0.55	0.0%	Codominant	1.9	Preserve	NO	0	1	T-720 IS IN DECLINE W/ SIGNIFICANT DEADWOOD IN CANOPY. POOR CANOPY RATIO & SCAFFOLD BRANCHING. ~15" LEAN. EXFOLIATING BARK ON TRUNK STEM.
720	Robinia pseudoacacia, Black Locust	12.7	13	0.18	0.55	0.0%	Codominant	1.3	Preserve	NO	0	0	T-720 W/ EXTREM INVASIVE ENGLISH IVY EMBEDDED INTO TRUNK STEM. EXFOLIATING BARK. LOW CANOPY RATIO & POOR SCAFFOLD BRANCHING. DEAD STEM AT ROOT CROWN.
721	Robinia pseudoacacia, Black Locust	9.0	9	0.50	0.55	0.0%	Intermediate	2.5	Preserve	NO	0	1	T-722 IS DEAD.
722	Robinia pseudoacacia, Black Locust	11.3	0	0.00	0.55	N/A	Codominant	0.0	Preserve	NO	0	0	T-723 W/ EXTREM INVASIVE ENGLISH IVY FROM GRADE TO CANOPY. EXFOLIATING BARK ON TRUNK STEM AT GRADE. V-LOW CANOPY RATIO. POOR SCAFFOLD BRANCHING.
723	Robinia pseudoacacia, Black Locust	12.0	12	0.10	0.55	0.0%	Codominant	0.7	Preserve	NO	0	0	T-724 W/ EXTREM EMBEDDED ENGLISH IVY FROM GRADE TO CANOPY. TREE IS TOPPED. TREE IS DEAD.
724	Robinia pseudoacacia, Black Locust	14.0	0	0.00	0.55	N/A	Codominant	0.0	Preserve	NO	0	0	EXTREM EMBEDDED ENGLISH IVY FROM GRADE TO UPPER CANOPY. TREE W/ V-LOW CANOPY RATIO.
724.1	Robinia pseudoacacia, Black Locust	12.5	13	0.00	0.55	N/A	Codominant	0.0	Preserve	NO	0	0	T-724.2 IS DEAD WITH ~20" LEAN.
724.2	Robinia pseudoacacia, Black Locust	7.0	0	0.00	0.55	N/A	Codominant	0.0	Preserve	NO	0	0	T-725 W/ EXTREM EMBEDDED ENGLISH IVY FROM GRADE TO CANOPY. TREE IS DEAD.
725	Robinia pseudoacacia, Black Locust	16.0	0	0.00	0.55	N/A	Codominant	0.0	Preserve	NO	0	0	T-726 W/ EXTREM EMBEDDED ENGLISH IVY FROM GRADE TO CANOPY. V-POOR CANOPY RATIO.
726	Robinia pseudoacacia, Black Locust	14.7	15	0.15	0.55	0.0%	Codominant	1.2	Preserve	NO	0	1	T-727 WITH SEVERE EMBEDDED INVASIVE ENGLISH IVY VINES FROM GRADE TO CANOPY. FAIR/POOR SCAFFOLD BRANCHING & CANOPY RATIO.
727	Catalpa speciosa, Catalpa	11.2	12	0.35	0.55	0.0%	Codominant	2.2	Preserve	YES	0	1	T-728 CANOPY W/ V-SEVERE INVASIVE WILD GRAPE VINE. V-POOR SCAFFOLD BRANCHING & CANOPY RATIO.
728	Pyrus calleryana, Callery Pear	3.5	8	0.15	0.50	0.0%	Intermediate	0.3	Preserve	YES	0	0	NO APPARENT BIOTIC ISSUES OBSERVED. GOOD COLOR, VIGOR, VITALITY AND STRUCTURE. TREE WITH SLIGHT CANOPY DEADWOOD.
729	Quercus phellos, Willow Oak	15.3	16	0.75	0.75	100.0%	Dominant	8.6	Remove	NO	2	2	NO APPARENT BIOTIC ISSUES OBSERVED. GOOD COLOR, VIGOR, VITALITY AND STRUCTURE. TREE WITH SLIGHT CANOPY DEADWOOD.
730	Quercus phellos, Willow Oak	12.4	13	0.73	0.75	100.0%	Dominant	6.8	Remove	NO	2	2	NO APPARENT BIOTIC ISSUES OBSERVED. GOOD COLOR, VIGOR, VITALITY AND STRUCTURE. TREE WITH SLIGHT CANOPY DEADWOOD.
731	Quercus phellos, Willow Oak	15.8	16	0.70	0.75	100.0%	Dominant	8.3	Remove	NO	2	2	NO SEVERE BIOTIC ISSUES OBSERVED. GOOD COLOR, VIGOR, VITALITY & STRUCTURE. TREE WITH SLIGHT CANOPY DEADWOOD.
732	Pyrus calleryana, Callery Pear	3.5	8	0.15	0.50	0.0%	Intermediate	0.3	Preserve	YES	0	0	T-732.1 W/ V-SEVERE INVASIVE WILD GRAPE VINE IN CANOPY. V-POOR SCAFFOLD BRANCHING & LOW CANOPY RATIO. ASYMMETRIC CANOPY.
732.1	Pyrus calleryana, Callery Pear	4.7	8	0.20	0.50	0.0%	Intermediate	0.5	Preserve	YES	0	0	T-733 W/ VERY POOR SCAFFOLD BRANCHING. TREE W/ ~18" LEAN. INVASIVE GRAPE VINE THROUGH CANOPY.
733	Pyrus calleryana, Callery Pear	4.4	8	0.30	0.50	0.0%	Intermediate	0.7	Preserve	YES	0	0	NO SEVERE BIOTIC ISSUES OBSERVED. GOOD COLOR, VIGOR & VITALITY. FAIR/GOOD STRUCTURE. TREE W/ MULTI-TRUNK STEM UNION AT ~5VF. ASYMMETRICAL CANOPY W/ DEADWOOD.
734	Catalpa speciosa, Catalpa	10.5	11	0.55	0.45	0.0%	?	2.6	Preserve	YES	0	1	NO SEVERE BIOTIC ISSUES OBSERVED. GOOD COLOR, VIGOR, VITALITY & STRUCTURE. SLIGHT CANOPY DEADWOOD. NO ROOT FLAIR.
735	Pyrus calleryana, Callery Pear	8.0	8	0.45	0.50	0.0%	Intermediate	1.8	Preserve	YES	0	1	NO APPARENT BIOTIC ISSUES OBSERVED. GOOD COLOR, VIGOR, VITALITY & STRUCTURE. MULTI-STEM UNION AT ~7VF. NO ROOT FLAIR AT GRADE.
736	Pyrus calleryana, Callery Pear	3.0	8	0.35	0.50	0.0%	Intermediate	0.5	Preserve	YES	0	0	NO SEVERE BIOTIC ISSUES OBSERVED. GOOD COLOR, VIGOR, VITALITY & STRUCTURE. ROOT GIRDLE AT GRADE W/ EXPOSED CRZ AIR GRADE.
737	Pyrus calleryana, Callery Pear	5.0	8	0.35	0.50	0.0%	Intermediate	0.9	Preserve	YES	0	0	NO SEVERE BIOTIC ISSUES OBSERVED. GOOD COLOR, VIGOR, VITALITY & STRUCTURE. CANOPY WITH DEADWOOD AND LOW CANOPY RATIO.
738	Pyrus calleryana, Callery Pear	5.2	8	0.50	0.50	0.0%	Intermediate	1.3	Preserve	YES	0	1	NO SEVERE BIOTIC ISSUES OBSERVED. GOOD COLOR, VIGOR & VITALITY. FAIR/POOR STRUCTURE/VERY ASYMMETRICAL CANOPY W/ INVASIVE VEG. POOR CANOPY RATIO.
739	Pyrus calleryana, Callery Pear	3.0	8	0.30	0.50	0.0%	Intermediate	0.5	Preserve	YES	0	0	TR-739 WITH SEVERE INVASIVE VEG IN CANOPY & VERY POOR STRUCTURE. POOR CANOPY RATIO. TREE W/ ~20" LEAN.
											EXISTING TREE REPLACEMENT SUBTOTAL	26	

Tree No.	Species	Size	CRZ	Field Condition	Species Rating	Disturbed Area Within CRZ	Canopy Position	Total Score	Status	Invasive Species	Replacement Trees Requirement	Tree Replacement Totals For All Trees Inventoried (FOR INFORMATION ONLY)	Existing Tree Condition Observations
		*DBH (in)	R (ft)	%		%							
740	Fagus grandifolia, American Beech	11.0	11	0.53	0.80	0.0%	Dominant	4.7	Preserve	NO	0	1	NO SEVERE BIOTIC ISSUES OBSERVED. GOOD COLOR, VIGOR & VITALITY. SEVERE INVASIVE VINE EMBEDDED INTO TRUNK STEM FROM GRADE TO CANOPY.
741	Pyrus calleryana, Callery Pear	3.0	8	0.30	0.50	100.0%	Suppressed	0.5	Remove	YES	0	0	T-714 HAS POOR CANOPY STRUCTURE. VERY POOR CANOPY RATIO. INVASIVE VINE THROUGH CANOPY. TRUNK STEM W/ ~22" LEAN.
742	Pyrus calleryana, Callery Pear	4.0	8	0.30	0.50	100.0%	Suppressed	0.6	Remove	YES	0	0	T-742 WITH VERY POOR CANOPY STRUCTURE. INVASIVE VEG THROUGH CANOPY. TREE WITH ~32" LEAN. V-POOR CANOPY RATIO & W/ INVASIVE VEG.
743	Fagus grandifolia, American Beech	17.0	17	0.68	0.80	0.0%	Dominant	9.2	Preserve	NO	0	2	NO SEVERE BIOTIC ISSUES OBSERVED. GOOD COLOR, VIGOR, VITALITY & STRUCTURE. SEVERE INVASIVE HONEYSUCKLE ROOTED IN CRZ. SLIGHT DEADWOOD IN CANOPY.
744	Acer rubrum, Red Maple	15.5	16	0.66	0.70	100.0%	Dominant	2.3	Remove	NO	1	1	NO SEVERE BIOTIC ISSUES OBSERVED. GOOD COLOR, VIGOR VITALITY & STRUCTURE. INVASIVE VEG AT LOW TRUNK STEM.
745	Zelkova serrata, Zelkova	10.5	11	0.68	0.75	100.0%	Codominant	5.4	Remove	NO	2	2	NO APPARENT BIOTIC ISSUES OBSERVED. GOOD COLOR, VIGOR, VITALITY & STRUCTURE. SIGNIFICANT ROOT GIRDLE AT GRADE.
746	Zelkova serrata, Zelkova	17.5	18	0.65	0.75	100.0%	Codominant	8.5	Remove	NO	2	2	NO APPARENT BIOTIC ISSUES OBSERVED. GOOD COLOR, VIGOR, VITALITY & STRUCTURE. TREE W/ SIGNIFICANT CANOPY PRUNING. EMBEDDED ENGLISH IVY AT LOW TRUNK STEM.
747	Zelkova serrata, Zelkova	12.4	13	0.68	0.75	100.0%	Codominant	6.3	Remove	NO	2	2	NO APPARENT BIOTIC ISSUES OBSERVED. GOOD COLOR, VIGOR, VITALITY & STRUCTURE. SLIGHT CANOPY DEADWOOD. ROOT GIRDLE AT GRADE.
748	Zelkova serrata, Zelkova	11.4	12	0.68	0.75	100.0%	Codominant	4.1	Remove	NO	1	1	NO APPARENT BIOTIC ISSUES OBSERVED. GOOD COLOR, VIGOR, VITALITY & STRUCTURE. INVASIVE ENGLISH IVY AT LOW TRUNK STEM.
749	Quercus phellos, Willow Oak	16.0	16	0.75	0.75	100.0%	Dominant	9.0	Remove	NO	2	2	NO APPARENT BIOTIC ISSUES OBSERVED. GOOD COLOR, VIGOR, VITALITY & STRUCTURE.
750	Zelkova serrata, Zelkova	10.0	10	0.70	0.75	100.0%	Dominant	5.3	Remove	NO	2	2	NO APPARENT BIOTIC ISSUES OBSERVED. GOOD COLOR, VIGOR, VITALITY & STRUCTURE. SLIGHT CANOPY DEADWOOD. ROOT GIRDLE AT GRADE. EXPOSED CRZ AT GRADE.
751	Quercus phellos, Willow Oak	16.8	17	0.75	0.75	100.0%	Dominant	9.5	Remove	NO	2	2	NO APPARENT BIOTIC ISSUES OBSERVED. GOOD COLOR, VIGOR, VITALITY & STRUCTURE.
752	Zelkova serrata, Zelkova	14.0	14	0.70	0.75	100.0%	Dominant	7.4	Remove	NO	2	2	NO APPARENT BIOTIC ISSUES OBSERVED. GOOD COLOR, VIGOR, VITALITY & STRUCTURE. SLIGHT CANOPY DEADWOOD. ROOT GIRDLE AT GRADE. MULTI-TRUNK STEM UNION AT ~10VF.
753	Acer rubrum, Red Maple	14.8	15	0.67	0.70	100.0%	Codominant	6.9	Remove	NO	2	2	NO APPARENT BIOTIC ISSUES OBSERVED. GOOD COLOR, VIGOR & VITALITY. LOW TO MODERATE CANOPY RATIO. ROOT GIRDLE AT GRADE. FAIR/GOOD SCAFFOLD BRANCHING.
754	Acer rubrum, Red Maple	13.0	13	0.70	0.70	100.0%	Dominant	6.4	Remove	NO	2	2	NO APPARENT BIOTIC ISSUES OBSERVED. GOOD COLOR, VIGOR, VITALITY & STRUCTURE. NO ROOT FLAIR AT GRADE. SLIGHT CANOPY DEADWOOD.
755	Acer rubrum, Red Maple	12.8	13	0.72	0.70	100.0%	Dominant	6.5	Remove	NO	2	2	NO APPARENT BIOTIC ISSUES OBSERVED. GOOD COLOR, VIGOR, VITALITY & STRUCTURE. ROOT GIRDLE AT GRADE.
756	Acer rubrum, Red Maple	13.3	14	0.70	0.70	100.0%	Dominant	1.5	Remove	NO	1	1	NO APPARENT BIOTIC ISSUES OBSERVED. GOOD COLOR, VIGOR, VITALITY & STRUCTURE. ROOT GIRDLE AT GRADE. SLIGHT DEADWOOD.
757	Prunus x yedoensis, Yoshino Cherry	10.4	11	0.59	0.55	100.0%	Intermediate	3.4	Remove	NO	1	1	T-757 SHOW STRESS. LOW LEAF CANOPY DENSITY. ROOT GIRDLE AT GRADE. POOR SCAFFOLD BRANCHING.
758	Prunus x yedoensis, Yoshino Cherry	10.5	11	0.58	0.55	100.0%	Intermediate	3.3	Remove	NO	1	1	NO APPARENT BIOTIC ISSUES OBSERVED. GOOD COLOR, VIGOR, VITALITY & STRUCTURE. ROOT GIRDLE AT GRADE.
759	Pyrus calleryana, Callery Pear	7.4	8	0.70	0.50	100.0%	Intermediate	2.6	Remove	YES	1	1	NO APPARENT BIOTIC ISSUES OBSERVED. GOOD COLOR, VIGOR, VITALITY & STRUCTURE. NO ROOT FLAIR.
760	Acer rubrum, Red Maple	16.0	16	0.68	0.70	100.0%	Dominant	1.9	Remove	NO	1	1	NO SEVERE BIOTIC ISSUES OBSERVED. GOOD COLOR, VIGOR, VITALITY & STRUCTURE. SIGNIFICANT ROOT GIRDLE AT GRADE. SLIGHT CANOPY DEADWOOD.
761	Acer rubrum, Red Maple	15.7	16	0.70	0.70	100.0%	Dominant	7.7	Remove	NO	2	2	NO APPARENT BIOTIC ISSUES OBSERVED. GOOD COLOR, VIGOR, VITALITY & STRUCTURE. ROOT GIRDLE AT GRADE.
762	Prunus x yedoensis, Yoshino Cherry	7.6	8	0.67	0.55	100.0%	Intermediate	2.8	Remove	NO	1	1	NO SEVERE BIOTIC ISSUES OBSERVED. GOOD COLOR, VIGOR & VITALITY. FAIR/GOODS STRUCTURE & SCAFFOLD BRANCHING. SLIGHT CANOPY DEADWOOD. NO ROOT FLAIR.
763	Prunus x yedoensis, Yoshino Cherry	12.0	12	0.69	0.55	100.0%	Intermediate	4.6	Remove	NO	1	1	NO APPARENT BIOTIC ISSUES OBSERVED. GOOD COLOR, VIGOR, VITALITY & STRUCTURE. ROOT GIRDLE AT GRADE.
764	Pyrus calleryana, Callery Pear	12.0	12	0.68	0.50	100.0%	Codominant	4.1	Remove	YES	1	1	NO APPARENT BIOTIC ISSUES OBSERVED. GOOD COLOR, VIGOR, VITALITY & STRUCTURE. MULTI-STEM UNION AT ~7VF. NO ROOT FLAIR AT GRADE.
765	Zelkova serrata, Zelkova	8.2	9	0.68	0.75	100.0%	Intermediate	4.2	Remove	NO	1	1	NO SEVERE BIOTIC ISSUES OBSERVED. GOOD COLOR, VIGOR, VITALITY & STRUCTURE. ROOT GIRDLE AT GRADE W/ EXPOSED CRZ AIR GRADE.
766	Quercus phellos, Willow Oak	18.0	18	0.75	0.75	100.0%	Dominant	10.1	Remove	NO	3	3	NO APPARENT BIOTIC ISSUES OBSERVED. GOOD COLOR, VIGOR, VITALITY & STRUCTURE. CANOPY WITH DEADWOOD AND LOW CANOPY RATIO.
											EXISTING TREE REPLACEMENT SUBTOTAL	36	
											EXISTING TREE REPLACEMENT GRAND TOTAL	62	
											EXISTING TREE REPLACEMENT FOR ALL TREES INVENTORIED	73	

DBH = Diameter at Breast Height (measured 4.5 feet above existing grade or as noted).

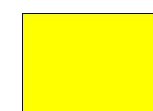
\* = Diameter measurement as recorded at the root crown where tree has a codominant, or multi-stem trunk which precludes a measurement at 4.5 ft above existing grade.

Critical Root Zone (CRZ): For trees with < 8" caliper trunk stem, CRZ shall be 8-ft radius around the trunk of the tree. Those trees with > 8" caliper trunk stem, for each 1" diameter trunk stem at breast height equals 1-ft of CRZ diameter. CRZ for trees

Conditions Ratings provided as percentages as based on methods outlined in the 9th edition of the "Guide for Plant Appraisal", published by the International Society of Arboriculture.

\\VA-PROJECTS2.vika.com\projects\Projects\8574\8574\DATA\Landscape & Trees\Langston Blvd Tree Inventory (2024.10.29).xlsx\Sheet1

LEGEND



EXISTING TREE TO BE REMOVED

PLAN PREPARED BY: NELSON P. KIRCHNER, RLA

ISA CERTIFIED ARBORIST No. MA-4720AM

SIGNATURE *[Signature]*

DATE 2024.10.29





















































# WATER QUALITY - VRRM

DEQ Virginia Runoff Reduction Method Re-Development Compliance Spreadsheet - Version 3.0

BMP Design Specifications List: 2013 Draft Stds & Specs

## Site Summary

Project Title: 3130 LANGSTON  
Date: 45516

Total Rainfall (in):	43
Total Disturbed Acreage:	2.0600

## Site Land Cover Summary

Pre-ReDevelopment Land Cover (acres)	A Soils	B Soils	C Soils	D Soils	Totals	% of Total
Forest/Open (acres)	0.0000	0.0000	0.0000	0.0000	0.0000	0.0000
Managed Turf (acres)	0.0000	0.0000	0.0000	0.5000	0.5000	24.2718
Impervious Cover (acres)	0.0000	0.0000	0.0000	1.5600	1.5600	75.7282
					2.0600	100.0000

Post-ReDevelopment Land Cover (acres)	A Soils	B Soils	C Soils	D Soils	Totals	% of Total
Forest/Open (acres)	0.0000	0.0000	0.0000	0.0000	0.0000	0.0000
Managed Turf (acres)	0.0000	0.0000	0.0000	0.1900	0.1900	9.2233
Impervious Cover (acres)	0.0000	0.0000	0.0000	1.8700	1.8700	90.7767
					2.0600	100.0000

## Site Tv and Land Cover Nutrient Loads

	Final Post-Development (Post-ReDevelopment & New Impervious)	Post-Development	Post-Development (New Impervious)	Adjusted Pre-Development
Site Rv	0.8854	0.8740	0.9500	0.8740
Treatment Volume (ft <sup>3</sup> )	6,621.1200	5,552.0850	1,069.0350	5,552.0850
TP Load (lb/yr)	4.1600	3.4884	0.6717	3.4884

Pre-ReDevelopment TP Load per acre (lb/acre/yr)	Final Post-Development TP Load per acre (lb/acre/yr)	Post-ReDevelopment TP Load per acre (lb/acre/yr)
1.9900	2.0200	1.9900

Total TP Load Reduction Required (lb/yr)	1.2422	0.6977	0.5446
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	Final Post-Development Load (Post-ReDevelopment & New Impervious)	Pre-ReDevelopment
TN Load (lb/yr)	29.7602	26.2197

## Site Compliance Summary

Maximum % Reduction Required Below Pre-ReDevelopment Load	20%
---	-----

Total Runoff Volume Reduction (ft <sup>3</sup> )	1,506.4942
Total TP Load Reduction Achieved (lb/yr)	1.2864
Total TN Load Reduction Achieved (lb/yr)	10.6664
Remaining Post Development TP Load (lb/yr)	2.8736
Remaining TP Load Reduction (lb/yr) Required	0.0000

**\*\* TARGET TP REDUCTION EXCEEDED BY 0.0442 LB/YEAR \*\***

## Drainage Area Summary

	D.A. A	D.A. B	D.A. C	D.A. D	D.A. E	Total
Forest/Open (acres)	0.0000	0.0000	0.0000	0.0000	0.0000	0.0000
Managed Turf (acres)	0.1900	0.0000	0.0000	0.0000	0.0000	0.1900
Impervious Cover (acres)	1.8700	0.0000	0.0000	0.0000	0.0000	1.8700
Total Area (acres)	2.0600	0.0000	0.0000	0.0000	0.0000	2.0600

## Drainage Area Compliance Summary

	D.A. A	D.A. B	D.A. C	D.A. D	D.A. E	Total
TP Load Reduced (lb/yr)	1.2864	0.0000	0.0000	0.0000	0.0000	1.2864
TN Load Reduced (lb/yr)	10.6664	0.0000	0.0000	0.0000	0.0000	10.6664

## Drainage Area A Summary

Land Cover Summary	A Soils	B Soils	C Soils	D Soils	Total	% of Total
Forest/Open (acres)	0.0000	0.0000	0.0000	0.0000	0.0000	0
Managed Turf (acres)	0.0000	0.0000	0.0000	0.1900	0.1900	9
Impervious Cover (acres)	0.0000	0.0000	0.0000	1.8700	1.8700	91
					2.0600	

## BMP Selections

Practice	Managed Turf Credit Area (acres)	Impervious Cover Credit Area (acres)	BMP Treatment Volume (ft <sup>3</sup> )	TP Load from Upstream Practices (lbs)	Untreated TP Load to Practice (lbs)	TP Removed (lb/yr)	TP Remaining (lb/yr)	Downstream Treatment to be Employed
1.a. Vegetated Roof #1 (Spec #5)		0.0372	128.2500	0.0805	0.0805	0.0362	0.0443	
2.i. To Stormwater Planter, Urban Bioretention (Spec #9, Appendix A)		1.0503	3,621.9542	0.0000	2.2731	1.2502	1.0229	

Total Impervious Cover Treated (acres)	1.0875
Total Turf Area Treated (acres)	0.0000
Total TP Load Reduction Achieved in D.A. (lb/yr)	1.2864
Total TN Load Reduction Achieved in D.A. (lb/yr)	10.6664

## Runoff Volume and CN Calculations

Target Rainfall Event (in)	1-year storm	2-year storm	10-year storm
	2.69	3.11	4.84

Drainage Areas	RV & CN	Drainage Area A	Drainage Area B	Drainage Area C	Drainage Area D	Drainage Area E
CN	95	0	0	0	0	0
RR (ft <sup>3</sup> )	1,506.4942	0.0000	0.0000	0.0000	0.0000	0.0000
1-year return period	RV w RR (two-in)	2.2474	0.0000	0.0000	0.0000	0.0000
	RV w RR (two-in)	2.0460	0.0000	0.0000	0.0000	0.0000
	CN adjusted	94	0	0	0	0
2-year return period	RV w RR (two-in)	2.6604	0.0000	0.0000	0.0000	0.0000
	RV w RR (two-in)	2.4590	0.0000	0.0000	0.0000	0.0000
	CN adjusted	94	0	0	0	0
10-year return period	RV w RR (two-in)	4.3735	0.0000	0.0000	0.0000	0.0000
	RV w RR (two-in)	4.1721	0.0000	0.0000	0.0000	0.0000
	CN adjusted	94	0	0	0	0

# STORMWATER PLANTER SIZING COMPUTATIONS

SWM Planter ID	BUILDING/LOCATION	DA TO SP (Ac.) (Total)	Rv	SURFACE AREA REQ'D (SFT)	Tv REQ'D (CFT)	SURFACE AREA PROV'D (SFT)	PONDING DEPTH (INCH)	SOIL DEPTH (FT)	GRAVEL DEPTH (FT)	PONDING Vr	SOIL Vr	GRAVEL Vr	STORAGE DEPTH (FT)	Tv PROV'D (CFT)
SWM PLANTER SP#1	PODIUM	0.38	0.95	930	1,302	1,440	3	3	1	1	0.25	0.4	1.40	2,016
SWM PLANTER SP#2	PODIUM	0.33	0.95	804	1,125	1,220	3	3	1	1	0.25	0.4	1.40	1,708
SWM PLANTER SP#3	AT GRADE	0.21	0.95	434	716	500	6	3	1	1	0.25	0.4	1.65	825
SWM PLANTER SP#4	AT GRADE	0.12	0.95	252	430	276	6	3	1	1	0.25	0.4	1.71	471
<b>SWM PLANTERS TOTALS</b>		<b>1.04</b>		<b>2419.13</b>	<b>3572.63</b>	<b>3436.00</b>								<b>5020.19</b>

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Note: Sizing based on DCR Spec# 9-A

SA(REQ'D)=Tv/SD

Tv(REQ'D)=1''\*Rv\*A/12

Tv(PROV'D)=SA\*SUM OF STORAGE

g DA is the Surface Area of the SWM Planter; This is thadded to Non-Veg Area and included in V.

# EXTENSIVE GREEN ROOF SIZING COMPUTATIONS

## DEQ Extensive Green Roof Sizing Chart - 3130 LANGSTON

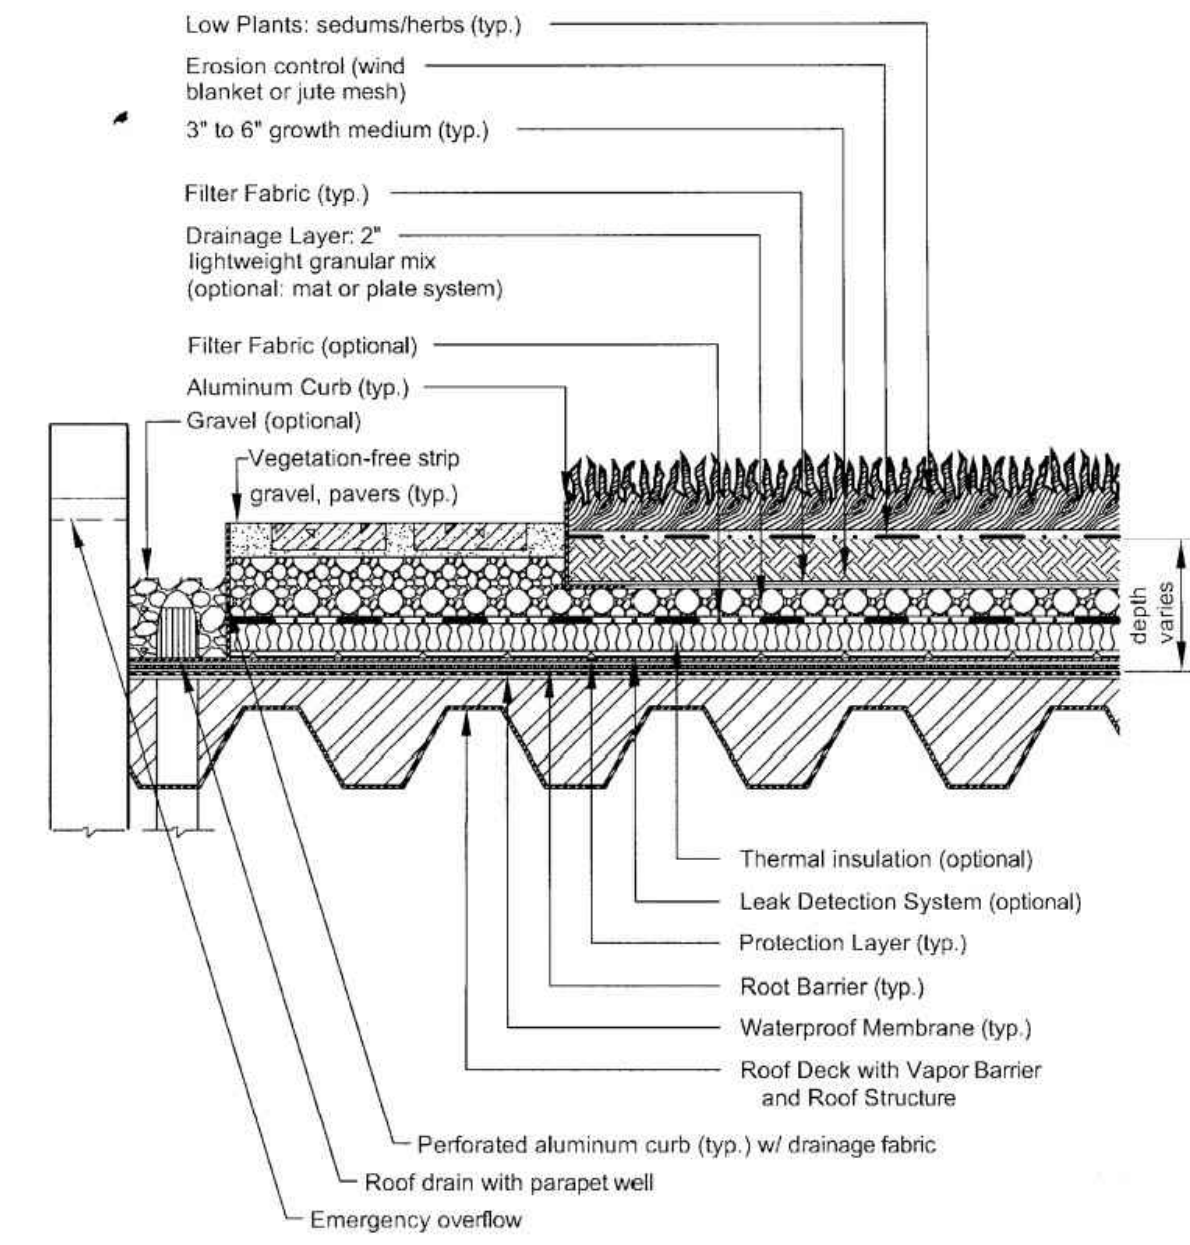
GREEN ROOF NUMBER	INTENSIVE/EXTENSIVE	DA (VEGETATIVE) (SQ. FT.)	DA (NON-VEGETATIVE) (SQ. FT.)	Rv	Tv REQ'D (CFT)	SURFACE AREA PROV'D (SFT)	SOIL DEPTH (in)	MEDIA POROSITY	Tv PROV'D (CFT)
GREEN ROOF 1	EXTENSIVE	1620	0	0.95	128	1620	4	0.30	162
Total		0.04	0.00		128	1620			162

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Note: Sizing based on DCR Spec# 5

Tv(REQ'D)=1''\*Rv\*DA/12


Tv(PROV'D)=(Surface Area\*Soil Depth\*Porosity)/12



CROSS SECTION VIEW (NTS)

Figure 5.2. Typical Section - Extensive Vegetated Roof (Source: Northern VA Regional Commission)

# EXTENSIVE GREEN ROOF TYPICAL DETAIL

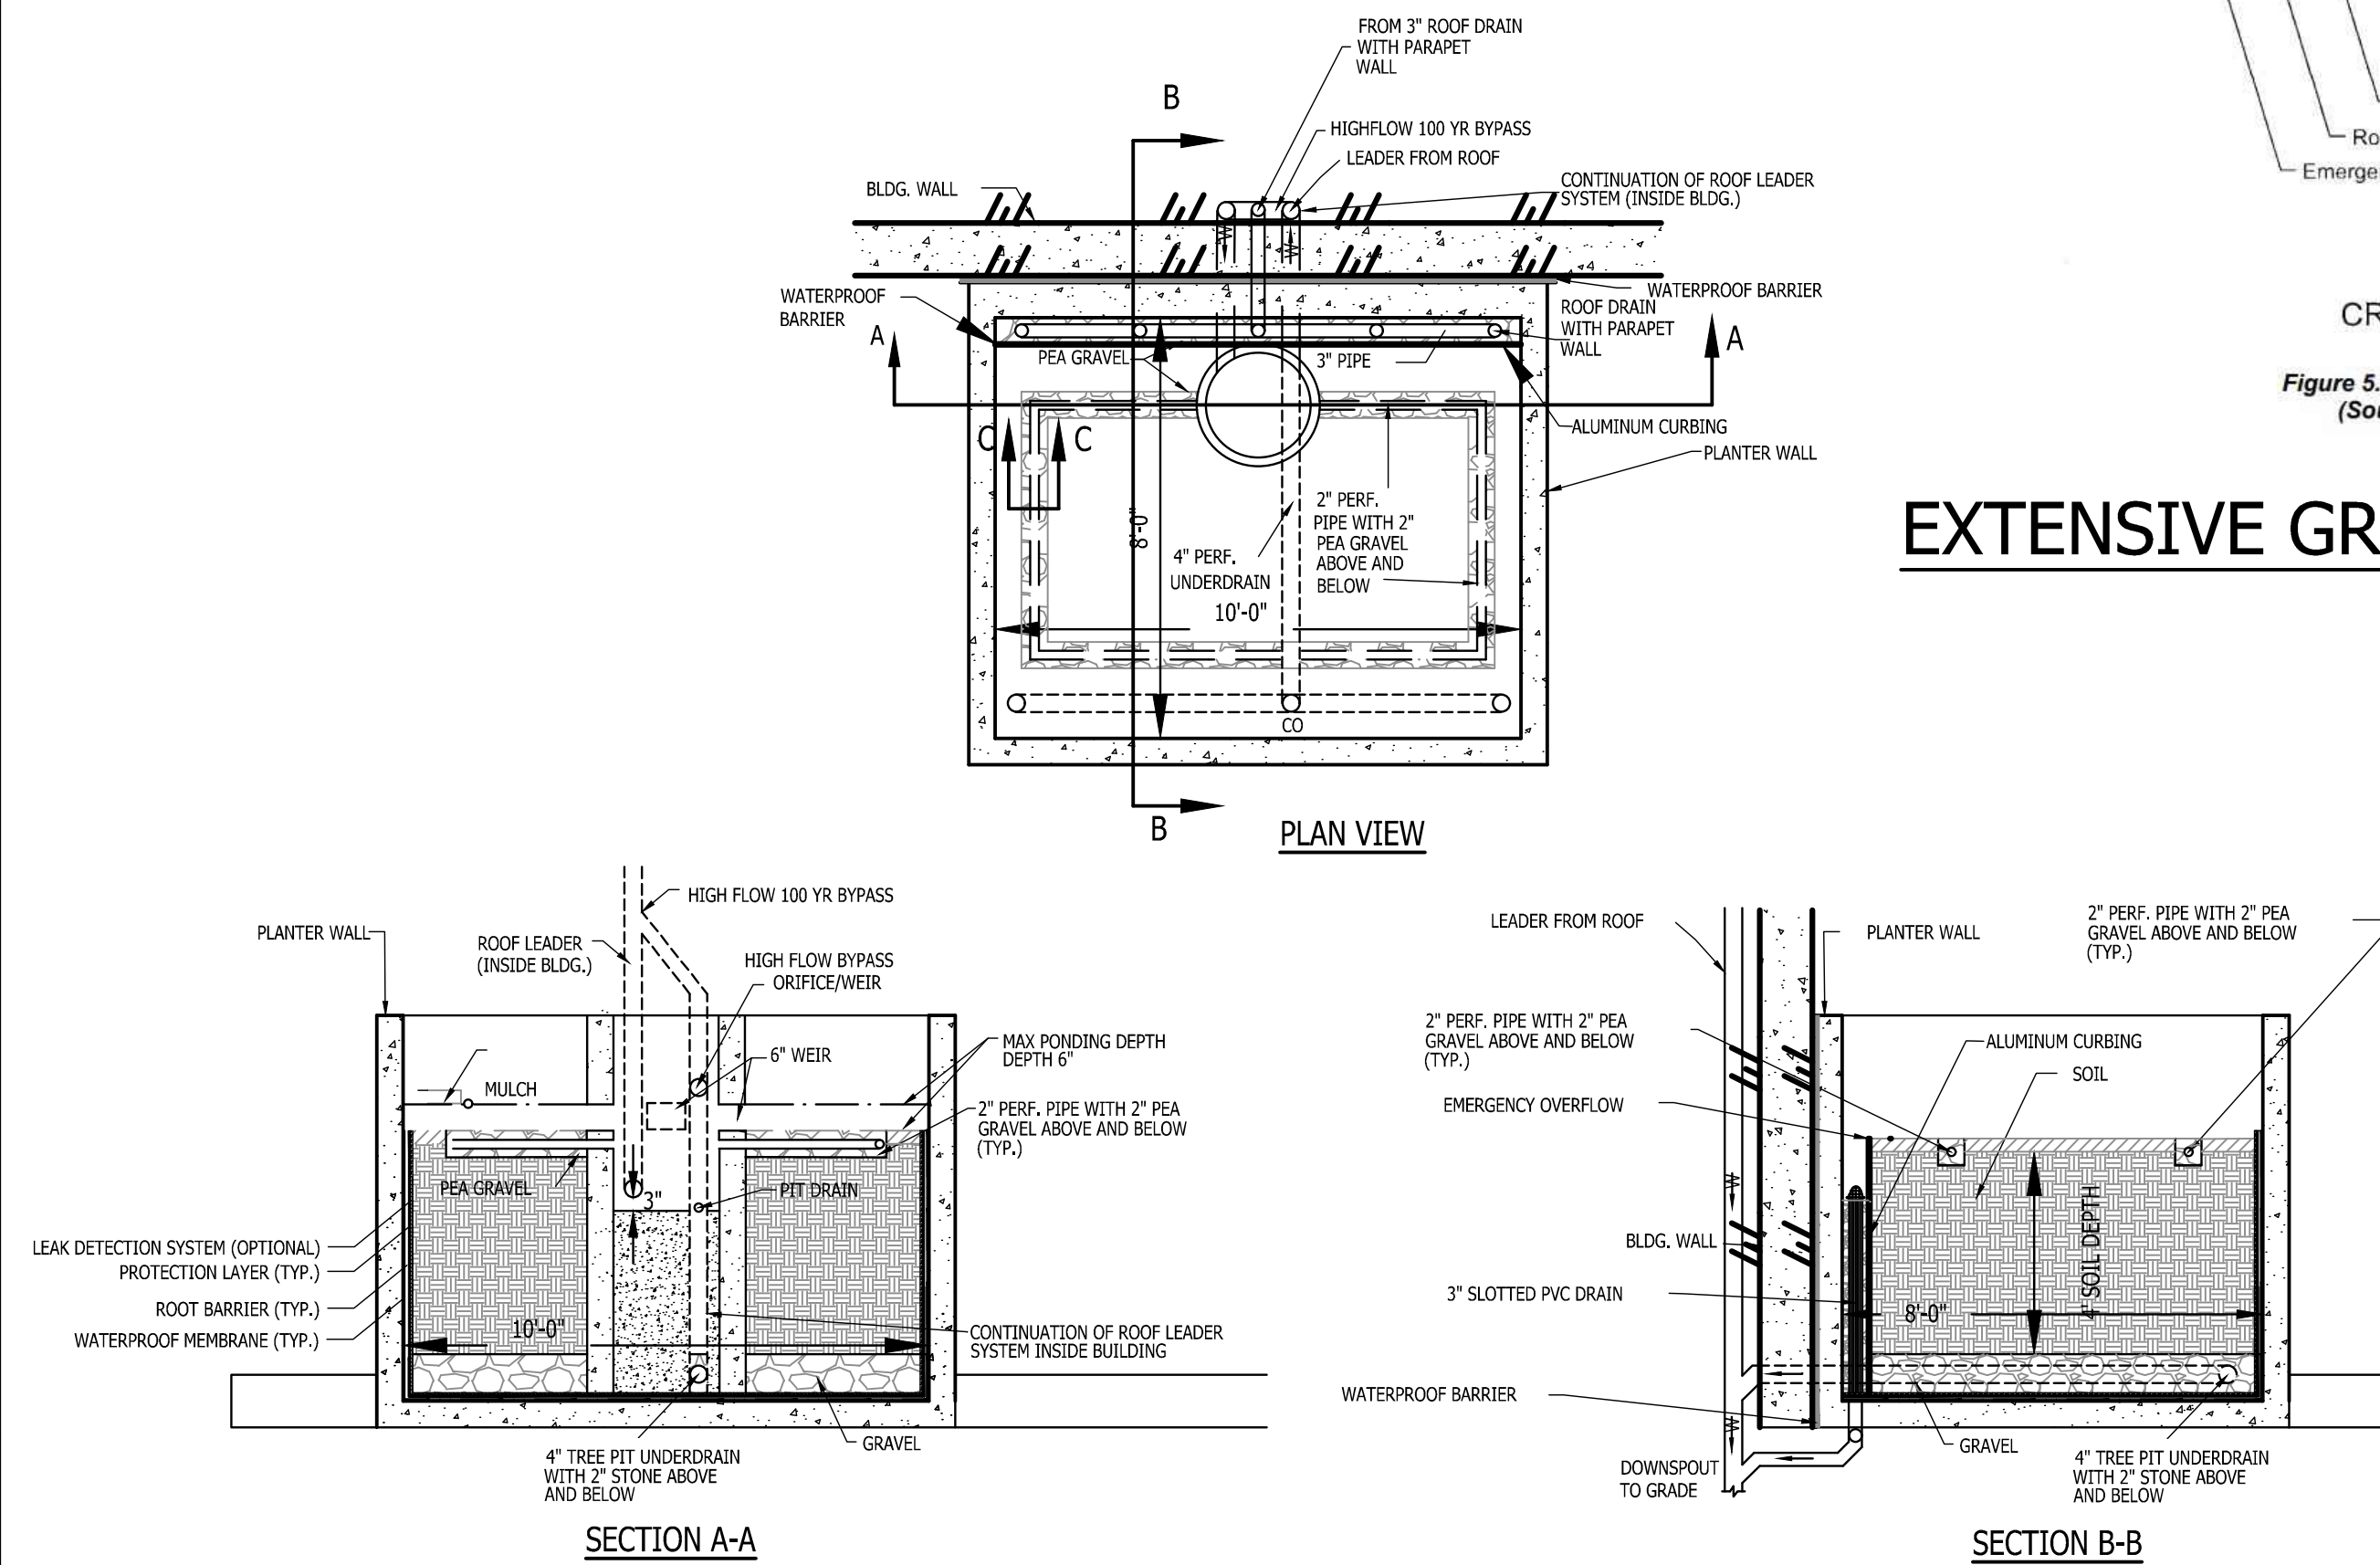

# TYPICAL STORMWATER PLANTER DETAIL ON BUILDING (RAISED PLANTER)

NOT TO SCALE

NOTE: PER CLEARINGHOUSE SPEC NO. 9A SECTION 9-A-5 IF THE 2500 SF CONTRIBUTING DRAINAGE AREA IS EXCEED, THE DESIGN SHALL BE IN ACCORDANCE WITH LEVEL 1 BIORETENTION.



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Tysons, VA 22102  
703.442.7800 | vika.com

Our Site Set on the Future.

V 12.00

PLAN STATUS	DATE
4.1 SITE PLAN SUBMISSION	08/09/2024
4.1 SITE PLAN RESUBMISSION	10/29/2024

POST-APPROVAL SHEET STATUS	DATE

PROFESSIONAL SEAL



3130 LANGSTON BOULEVARD  
4.1 SITE PLAN

ARLINGTON COUNTY, VIRGINIA

# SWM COMPUTATIONS

DRAWN BY:	
DESIGNED BY:	
DATE ISSUED:	08/09/2024
DWG. SCALE:	AS NOTED
VIKA NO.:	VV8574A
SHEET NO.:	C-18















3130 LANGSTON BOULEVARD

THE PROJECT CONSISTS OF A SERIES OF STREET LEVEL, PODIUM AND ROOF LEVEL SPACES, WHICH CREATE AMENITY ZONES FOR BUILDING RESIDENTS AND COMMUNITY MEMBERS. THESE AREAS PROVIDE OPPORTUNITIES FOR BIOPHILIC DESIGNS THAT CONNECT PEOPLE TO NATURE AND ALLOW LIGHT AND AIR INTO DWELLINGS.

6 DESIGN PRINCIPLES OF BIOPHILIA:

1. GREEN ENVELOPE
2. NATURE-INSPIRED FORMS & SHAPES
3. LIGHT
4. ORGANIC PATTERNS & PROCESSES
5. HUMAN RELATIONSHIPS TO NATURE
6. SENSORY EXPERIENCES

GREEN ENVELOPE:

THE SPACE DESIGN PROVIDES A "GREEN ENVELOPE" ON ALL SIDES THAT BENEFITS FROM A LANDSCAPE PALETTE THAT INCLUDES GROUNDCOVERS, SHRUBS, AND TREES TO MAXIMIZE VERTICAL GREEN EXPOSURE AND VISUAL / TACTILE ACCESSIBILITY.

ELEMENTS OF URBAN AND STREETScape DESIGN INCLUDE ALL NATURAL MATERIALS SUCH AS WOOD ON BENCHES (HIGH CONTACT, SENSE OF TOUCH) AND PLANTER WALLS WITH SEATING (HIGH CONTACT, SENSE OF SMELL).

NATURE-INSPIRED FORMS & SHAPES:

THE PUBLIC SPACE GEOMETRY REFLECTS AN ORGANIC ORGANIZATIONAL APPROACH, THAT GENTLY GUIDES PEDESTRIAN ACCESS AND WALKABILITY OF THE OVERALL SPACE.

LIGHT:

THE DESIGN AND LAYOUT ALLOW NATURAL LIGHT TO PERMEATE THROUGHOUT.

ORGANIC PATTERNS & PROCESSES:

NATURAL COMPONENTS OF THE DESIGN, SUCH AS TREES, WILL CONTRIBUTE TEXTURAL RICHNESS WITH INTERESTING BARK, LEAF AND BRANCH PATTERNS, AND COLORS DURING VARIOUS SEASONS REFLECTING CYCLICAL NATURAL PROCESSES.

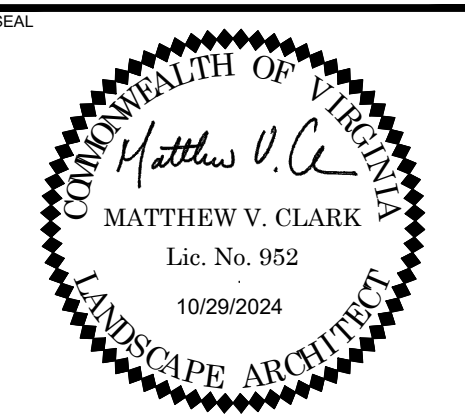
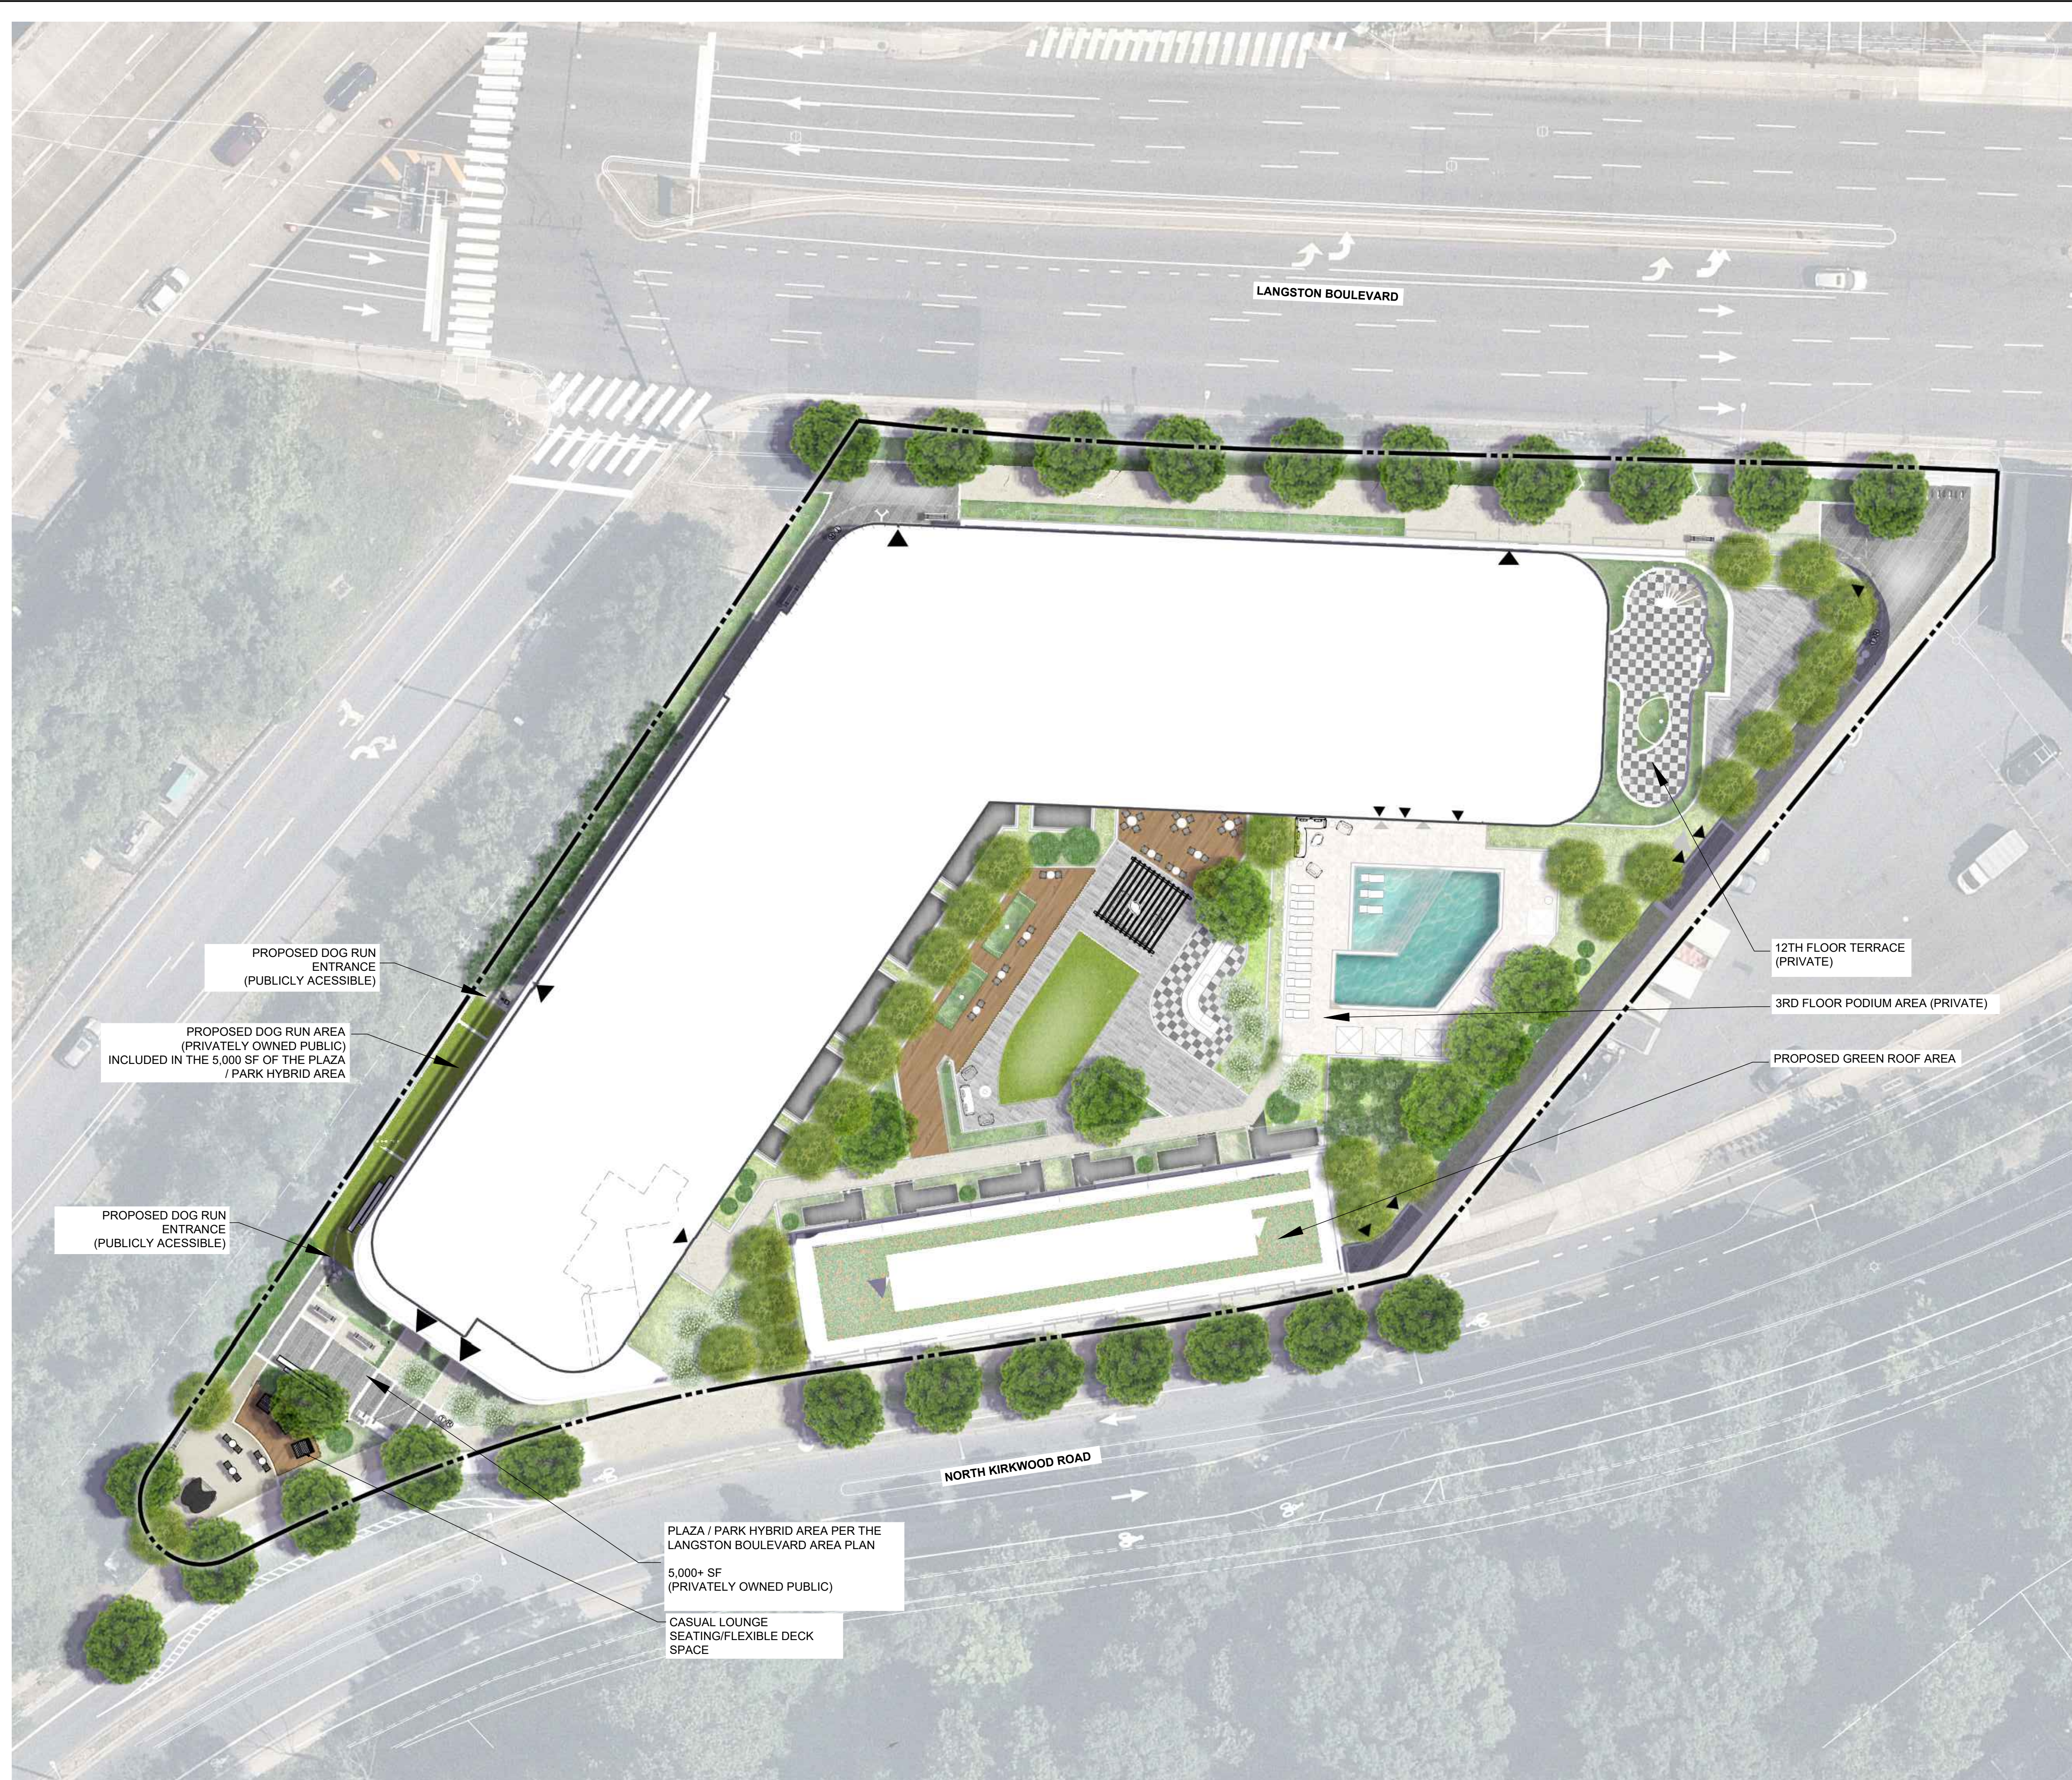
HUMAN RELATIONSHIPS TO NATURE:

THE MOST BASIC CONNECTION THAT HUMANS HAVE WITH NATURE IS WITH THE VEGETATIVE ENVIRONMENT. DIVERSE PLANT PALETTES REMIND US OF EXPANSIVE OPEN FIELDS, WOODED AREAS, AND OTHER DESIRABLE NATURE SETTINGS.

THE PLANT PALETTE ENVISIONED FOR THE PROJECT INTENDS TO BRING A TRUE CONNECTION VIA PLANT SELECTIONS THAT ARE NATIVE, HAVE SEASONAL INTEREST, AND SUPPORT URBAN HABITAT SUCH AS POLLINATORS.

SENSORY EXPERIENCES:  
CONNECTIONS TO OUR LIVING ENVIRONMENTS ARE THROUGH SENSORY EXPERIENCES

- TOUCH: TEXTURAL DESIGN VIA HARDSCAPE / LANDSCAPE ELEMENTS.
- SIGHT: VIEWS ARE INTERNALLY AND EXTERNALLY FOCUSED, DELIBERATELY ORCHESTRATED BY THE LOCATION AND PLACEMENT OF BENCHES.
- SMELL: BREEZY SPACES CARRIES SCENTS FROM GRASSES AND OTHER PLANTS MOVING IN THE WIND.
- SOUND: THE RUSTLING OF TREE LEAVES IN THE WIND, AS WELL AS THE TREE CANOPY, AND OTHER DESIGN FEATURES MITIGATING NOISE FROM THE OVERALL NEIGHBORING ACTIVITY.



PROJECT  
**3130 LANGSTON BOULEVARD**

ROONEY PROPERTIES, LLC  
3130 LANGSTON BOULEVARD  
ARLINGTON, VA 22201

LANDDESIGN PROJ.# 2024074

REVISION / ISSUANCE

NO.	DESCRIPTION	DATE
1	4.1 SITE PLAN SUBMISSION	08/09/2024
2	4.1 SITE PLAN RESUBMISSION	10/29/2024

DESIGNED BY: GC  
DRAWN BY: JM  
CHECKED BY: AC

SCALE: NORTH (VCB 83)  
VERT: N/A  
HORZ: 1"=20'  
0 10' 20' 40'

SHEET TITLE

ILLUSTRATIVE PLAN



SHEET NUMBER

L-100



REFERENCE NOTES SCHEDULE

CODE	DESCRIPTION	DETAIL
<b>FURNISHINGS</b>		
F-101	BENCH - TYPE 1	1/L-511
F-102	BENCH - TYPE 2	2/L-511
F-104	BISTRO TABLE AND CHAIRS	3/L-512
F-105	TRASH + RECYCLING	5/L-511
F-106	PET WASTE STATION	6/L-511
F-107	BIKE RACK	7/L-511
F-112	LOUNGE CHAIR	3/L-511
F-113	PLAY ELEMENT	5/L-512
F-114	BOTTLE FILLER & BIKE REPAIR STATION	6/L-512
F-116	WATER FOUNTAIN WITH PET BOWL	4/L-511
<b>LIGHTING &amp; ELECTRICAL</b>		
L-101	STREETLIGHT - COUNTY STANDARD	1/L-521
L-102	STRING LIGHTS	2/L-521
L-103	PATH LIGHT	3/L-521
L-105	OUTDOOR OUTLET WITH USB PORTS	4/L-521
<b>PAVING &amp; CURBS</b>		
P-101	CONCRETE PAVING	1/L-501
P-102	UNIT PAVERS - TYPE 1	2/L-501
P-106	DECOMPOSED GRANITE	6/L-501
P-108	SYNTHETIC LAWN	8/L-501
P-109	DECK	9/L-501
P-111	CONCRETE FLUSH CURB	
<b>RAILINGS &amp; FENCES</b>		
R-101	FENCE - TYPE 1	1/L-551
R-102	GATE - TYPE 1	3/L-551
<b>LEGEND</b>		
[Pattern]	PLANT BED	
[Pattern]	BIORETENTION PLANT BED	
[Pattern]	LAWN	
<b>UTILITY LEGEND</b>		
[Symbol]	EXISTING SANITARY SEWER	
[Symbol]	EXISTING STORM SEWER	
[Symbol]	EXISTING STORM DRAIN	
[Symbol]	EXISTING OVERHEAD ELECTRIC	
[Symbol]	EXISTING DOMINION ELECTRIC	
[Symbol]	EXISTING ELECTRIC	
[Symbol]	EXISTING PHONE	
[Symbol]	EXISTING VERIZON FIBER OPTIC	
[Symbol]	EXISTING WATER MAIN	
[Symbol]	EXISTING WATER	
[Symbol]	EXISTING NATURAL GAS	
[Symbol]	EXISTING GAS	
[Symbol]	EXISTING UNIDENTIFIED UTILITY LINE	
[Symbol]	PROPOSED WATER MAIN	
[Symbol]	PROPOSED WATER METER CLEAR ZONE	
[Symbol]	PROPOSED STORM SEWER	

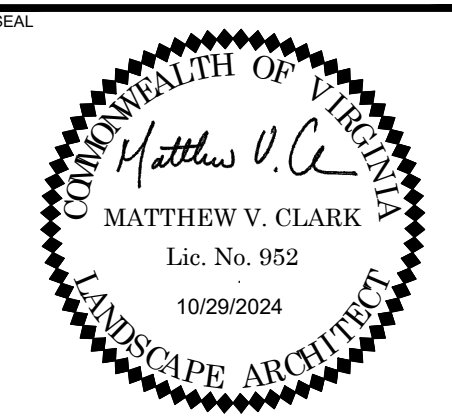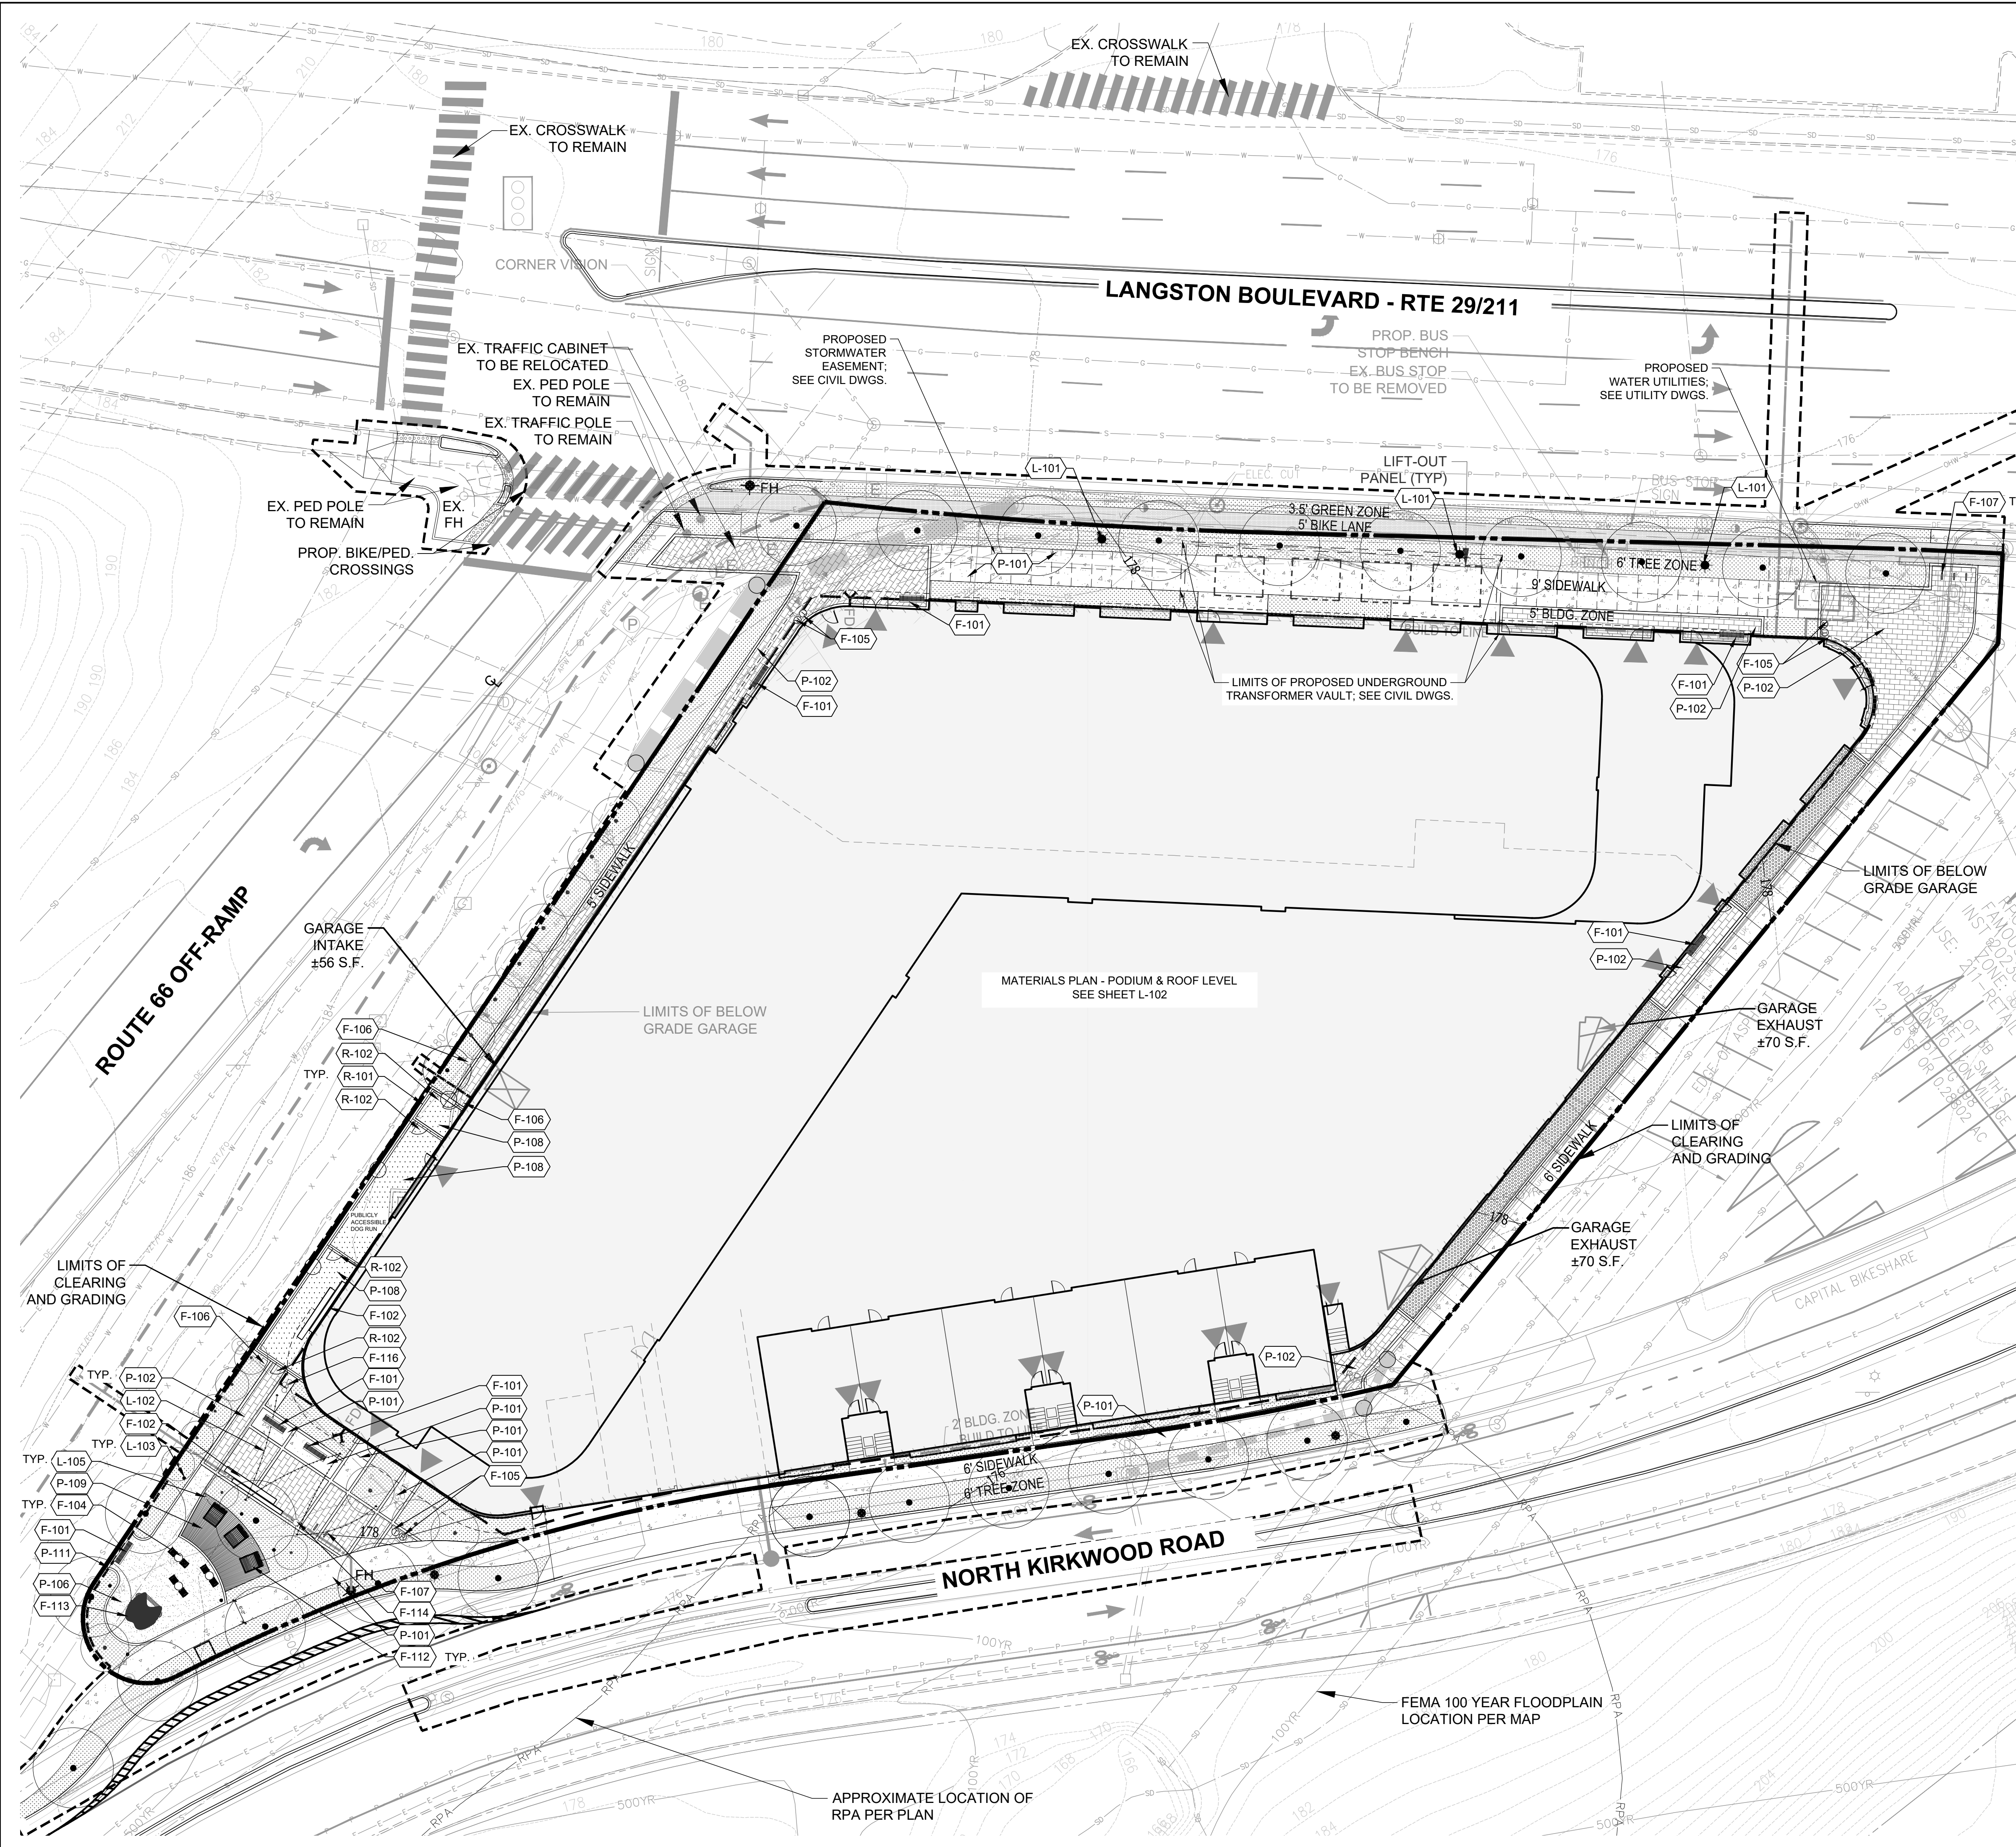

3130 LANGSTON BOULEVARD


ROONEY PROPERTIES, LLC  
3130 LANGSTON BOULEVARD  
ARLINGTON, VA 22201

LANDDESIGN PROJ.# 2024074

REVISION / ISSUANCE

NO.	DESCRIPTION	DATE
1	4.1 SITE PLAN SUBMISSION	08/09/2024
2	4.1 SITE PLAN RESUBMISSION	10/29/2024

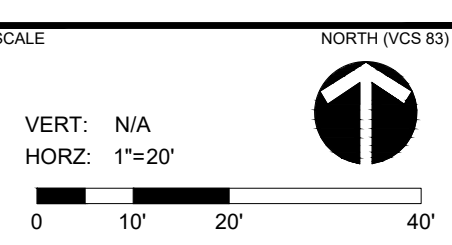DESIGNED BY: XX  
DRAWN BY: XX  
CHECKED BY: XX



MATERIALS PLAN - GROUND LEVEL

SHEET NUMBER

L-101





REFERENCE NOTES SCHEDULE

CODE	DESCRIPTION	DETAIL
<b>CUSTOM</b>		
(C-101)	GRILL STATION	1/L-541
<b>FURNISHINGS</b>		
(F-108)	SHADE STRUCTURE - TYPE 1	8/L-511
(F-109)	SHADE STRUCTURE - TYPE 2	9/L-511
(F-110)	SHADE STRUCTURE - TYPE 3	1/L-512
(F-111)	FIRE ELEMENT	2/L-512
(F-115)	DINING TABLE AND CHAIRS	4/L-512
<b>PAVING &amp; CURBS</b>		
(P-101)	CONCRETE PAVING	1/L-501
(P-103)	UNIT PAVERS - TYPE 2	3/L-501
(P-104)	UNIT PAVERS - TYPE 3	4/L-501
(P-105)	UNIT PAVERS - TYPE 4	5/L-501
(P-107)	POOL DECK	7/L-501
(P-110)	DECK - ON STRUCTURE	1/L-502
<b>POOL</b>		
(PL-101)	POOL	/
<b>RAILINGS &amp; FENCES</b>		
(R-104)	FENCE - TYPE 2	2/L-551
(R-105)	GATE - TYPE 2	4/L-551
<b>WALLS &amp; STAIRS</b>		
(W-101)	BIORETENTION WALL	1/L-531
(W-102)	METAL PLANTER WALL	2/L-531

LEGEND

- PLANT BED
- BIORETENTION PLANT BED
- LAWN

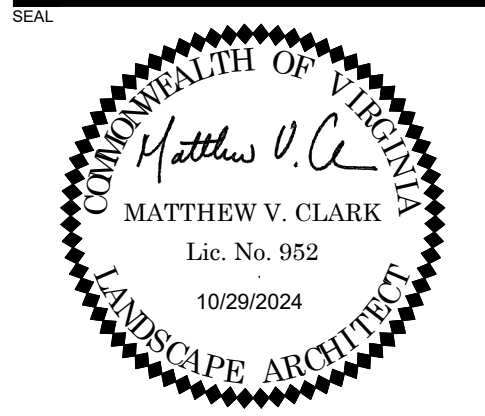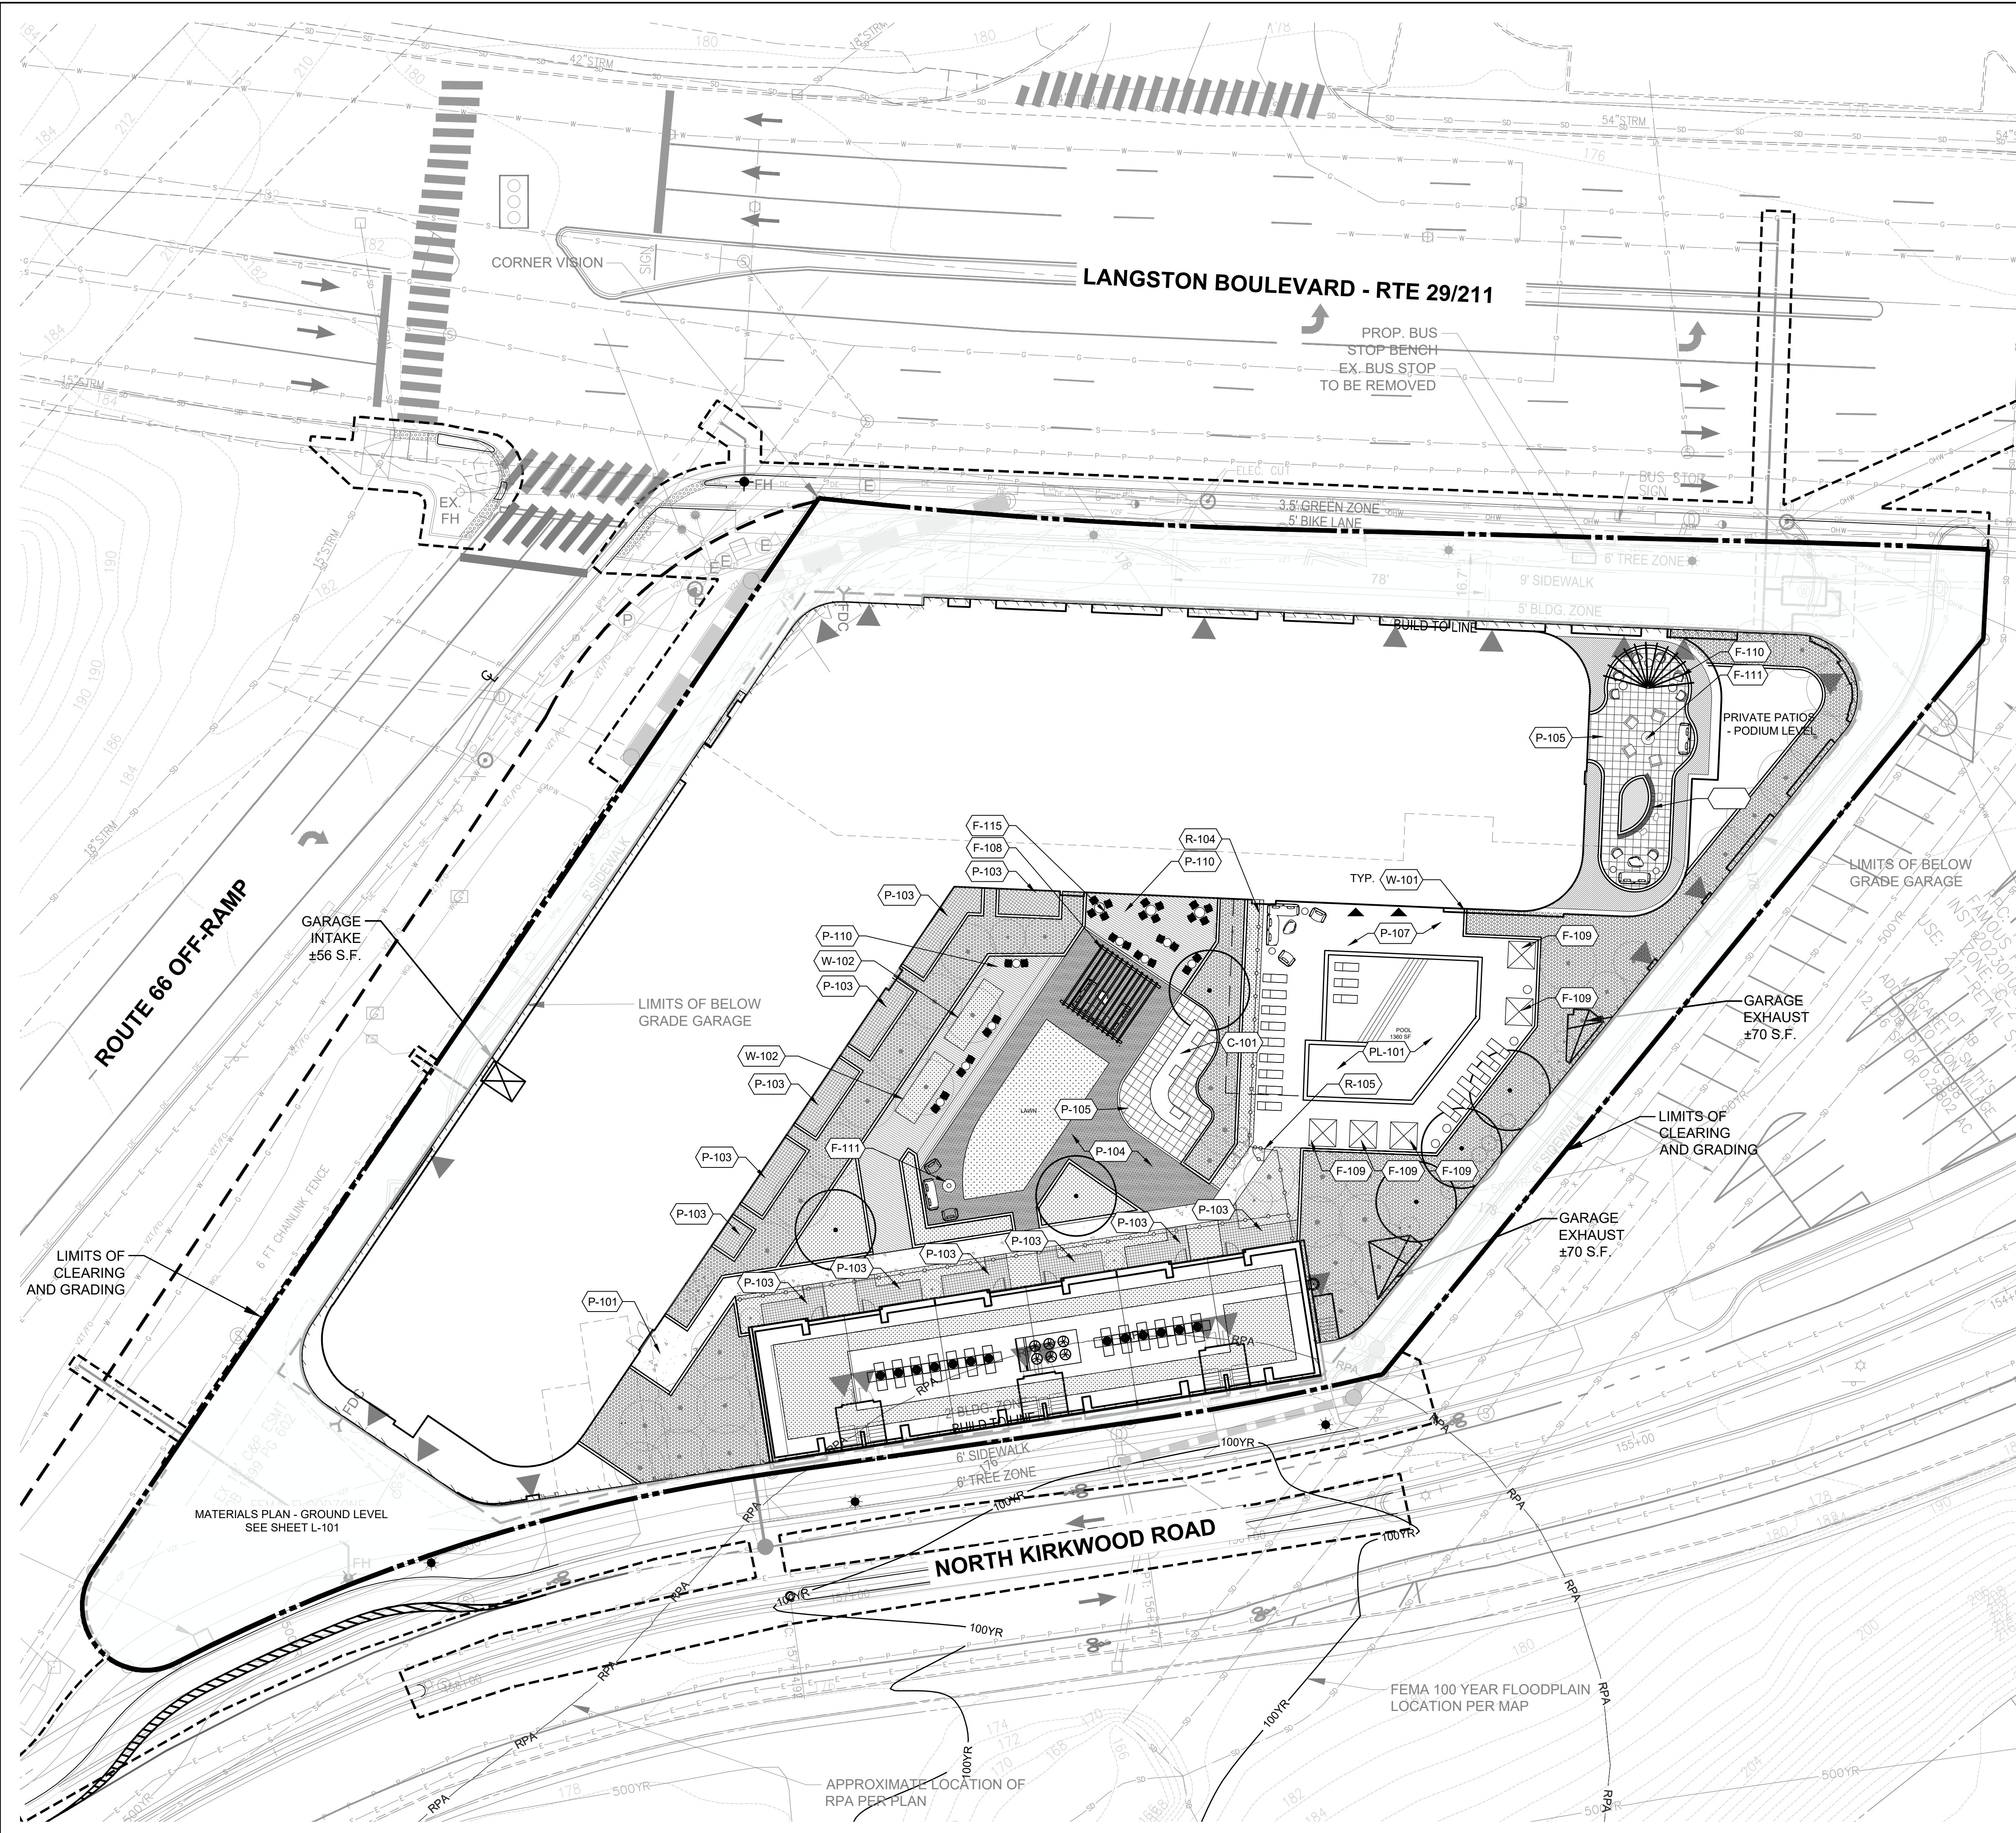NOTE: UNREFERENCED MOVEABLE FURNISHINGS FOR REFERENCE ONLY. SITE FURNISHINGS TO BE FINALIZED AT TIME OF CONSTRUCTION.



3130 LANGSTON BOULEVARD

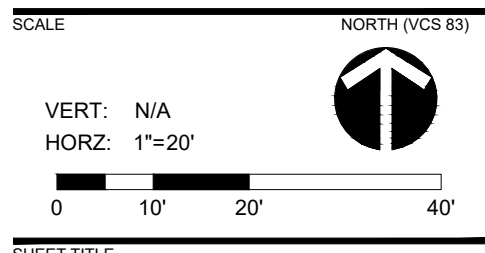
ROONEY PROPERTIES, LLC  
3130 LANGSTON BOULEVARD  
ARLINGTON, VA 22201

LANDDESIGN PROJ# 2024074

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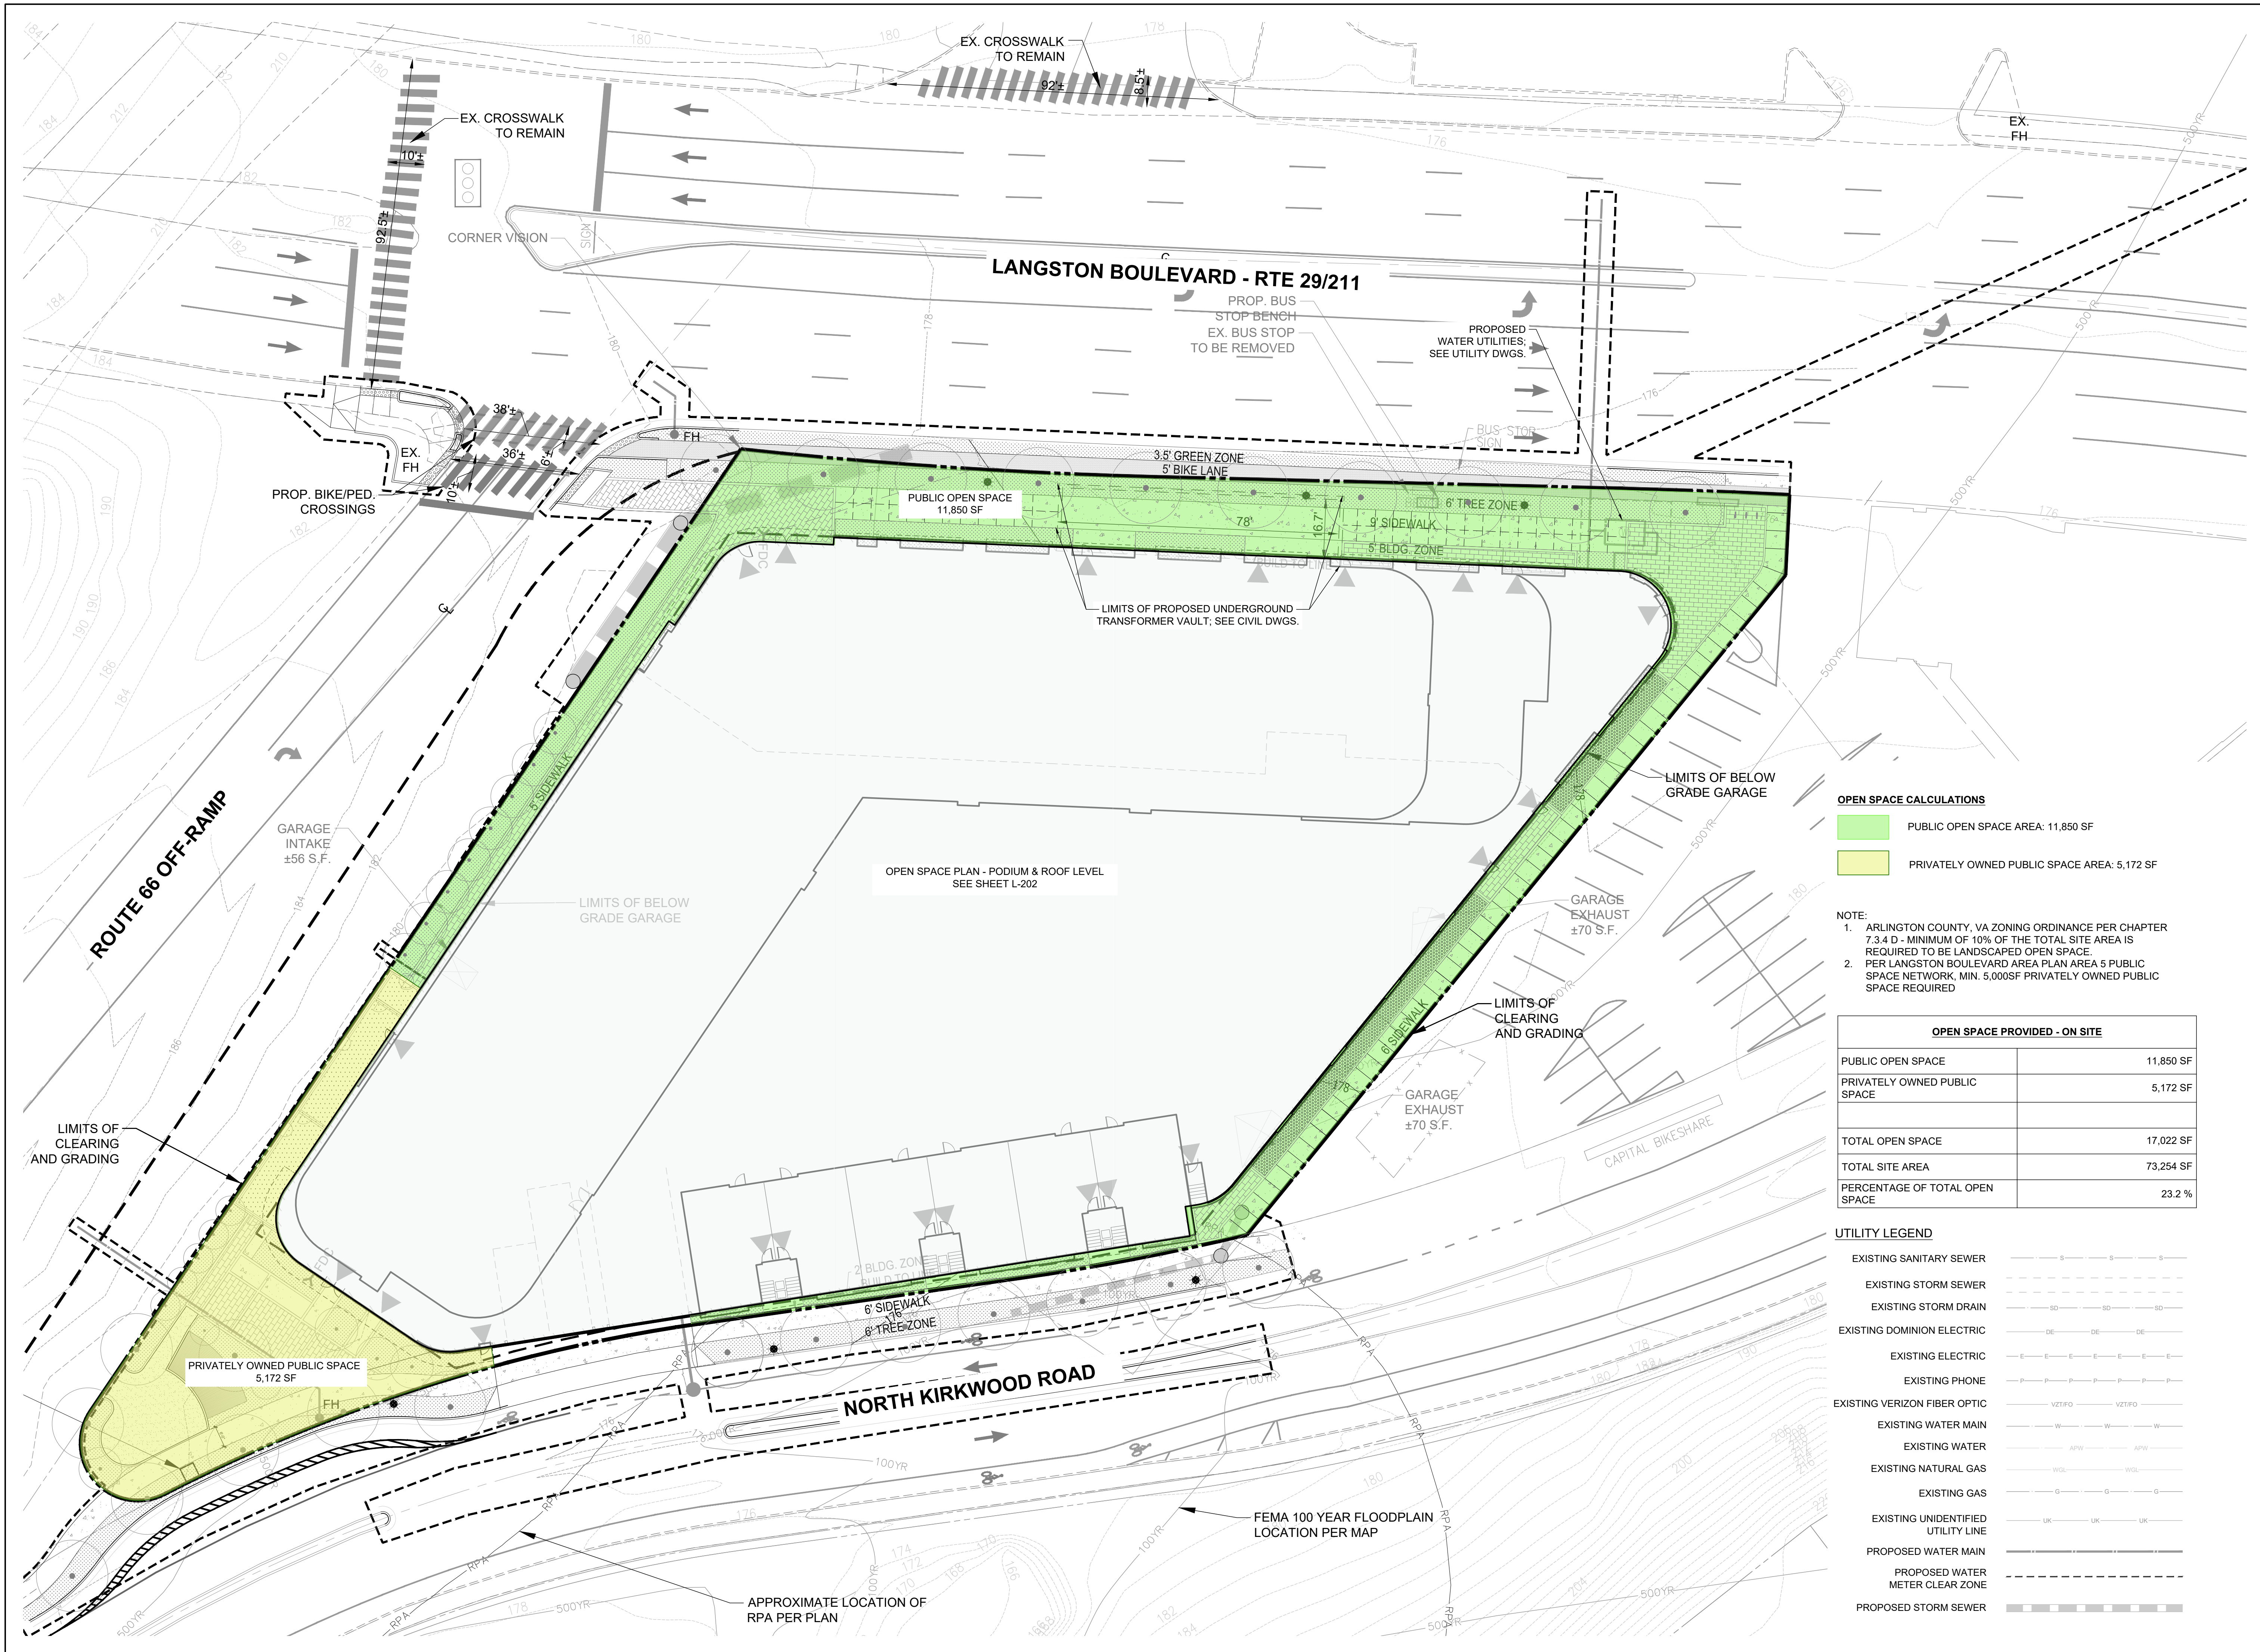
DESIGNED BY: GC  
DRAWN BY: JM  
CHECKED BY: AC



MATERIALS PLAN - PODIUM & ROOF LEVEL

SHEET NUMBER  
**L-102**





**OPEN SPACE CALCULATIONS**

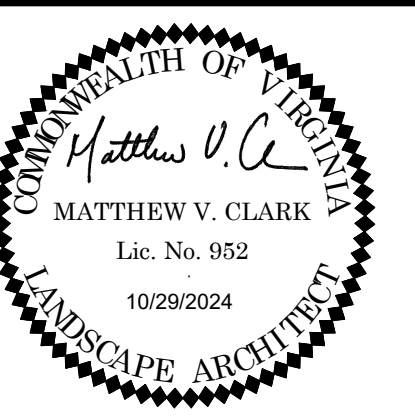
- PUBLIC OPEN SPACE AREA: 11,850 SF
- PRIVATELY OWNED PUBLIC SPACE AREA: 5,172 SF

- NOTE:**
1. ARLINGTON COUNTY, VA ZONING ORDINANCE PER CHAPTER 7.3.4 D - MINIMUM OF 10% OF THE TOTAL SITE AREA IS REQUIRED TO BE LANDSCAPED OPEN SPACE
  2. PER LANGSTON BOULEVARD AREA PLAN AREA 5 PUBLIC SPACE NETWORK, MIN. 5,000SF PRIVATELY OWNED PUBLIC SPACE REQUIRED

OPEN SPACE PROVIDED - ON SITE	
PUBLIC OPEN SPACE	11,850 SF
PRIVATELY OWNED PUBLIC SPACE	5,172 SF
<b>TOTAL OPEN SPACE</b>	<b>17,022 SF</b>
TOTAL SITE AREA	73,254 SF
PERCENTAGE OF TOTAL OPEN SPACE	23.2 %

**UTILITY LEGEND**

- EXISTING SANITARY SEWER
- EXISTING STORM SEWER
- EXISTING STORM DRAIN
- EXISTING DOMINION ELECTRIC
- EXISTING ELECTRIC
- EXISTING PHONE
- EXISTING VERIZON FIBER OPTIC
- EXISTING WATER MAIN
- EXISTING WATER
- EXISTING NATURAL GAS
- EXISTING GAS
- EXISTING UNIDENTIFIED UTILITY LINE
- PROPOSED WATER MAIN
- PROPOSED WATER METER CLEAR ZONE
- PROPOSED STORM SEWER



**3130 LANGSTON BOULEVARD**

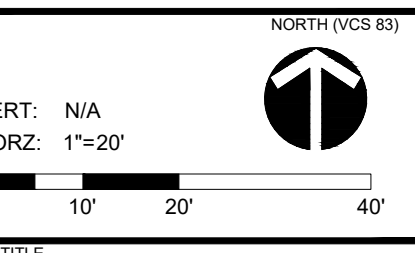
ROONEY PROPERTIES, LLC  
3130 LANGSTON BOULEVARD  
ARLINGTON, VA 22201

LANDDESIGN PROJ# 2024074

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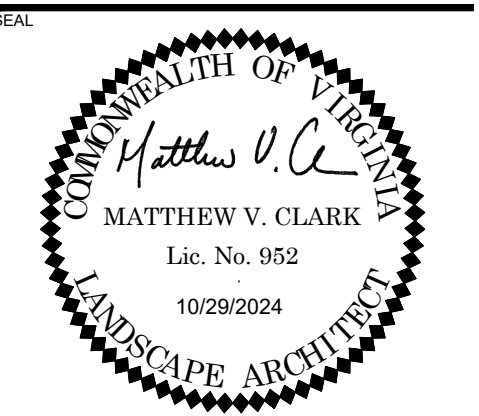
DESIGNED BY: GC  
DRAWN BY: JM  
CHECKED BY: AC



**OPEN SPACE PLAN - GROUND LEVEL**

SHEET NUMBER  
**L-201**





**3130 LANGSTON BOULEVARD**

ROONEY PROPERTIES, LLC  
3130 LANGSTON BOULEVARD  
ARLINGTON, VA 22201

LANDDESIGN PROJ# 2024074

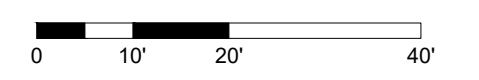
**REVISION / ISSUANCE**

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1	4.1 SITE PLAN SUBMISSION	08/09/2024
2	4.1 SITE PLAN RESUBMISSION	10/29/2024

DESIGNED BY: GC  
DRAWN BY: JM  
CHECKED BY: AC

SCALE: NORTH (VCS 8)

VERT: N/A  
HORZ: 1"=20'



SHEET TITLE  
**OPEN SPACE PLAN - PODIUM & ROOF LEVEL**

SHEET NUMBER  
**L-202**


**PRIVATE OPEN SPACE CALCULATIONS**

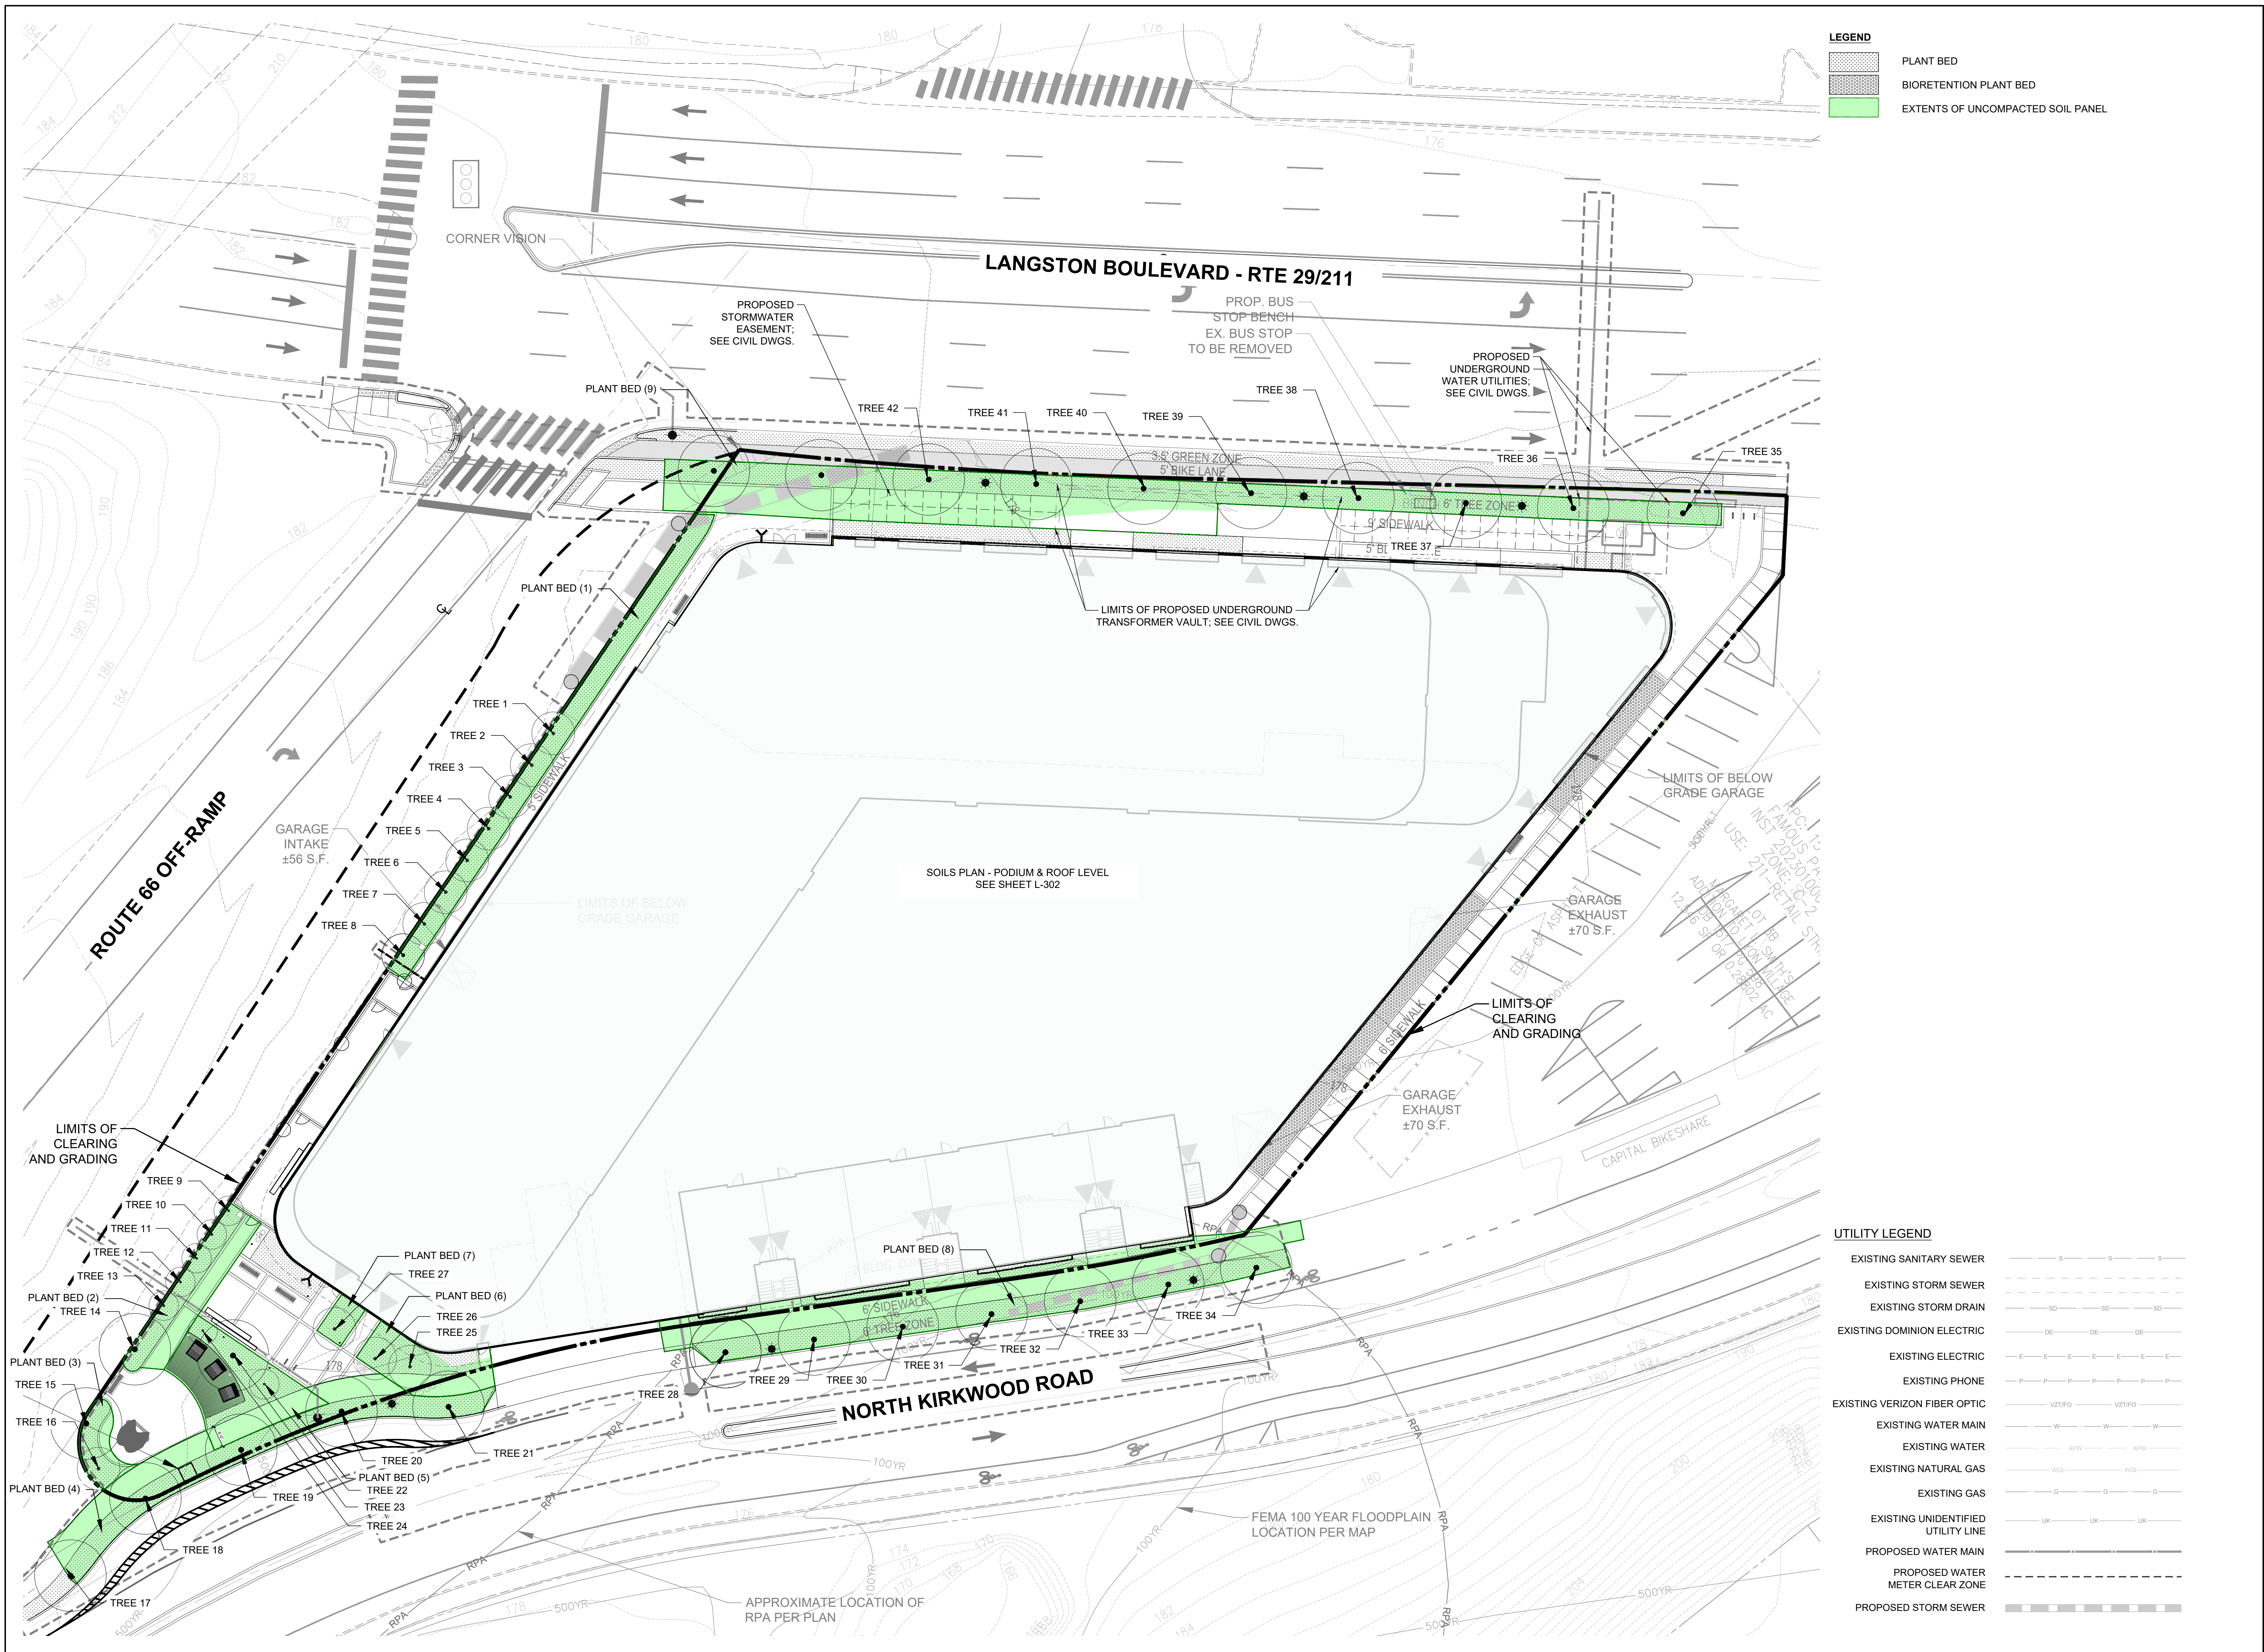- LEVEL 3 OPEN SPACE AREA: 18,733 SF
- LEVEL 12 OPEN SPACE AREA: 1,922 SF

NOTE: PER LANGSTON BOULEVARD AREA PLAN, MIN. 25% PRIVATE OPEN SPACE REQUIRED OF THE BUILDABLE AREA.

PRIVATE OPEN SPACE PROVIDED - ON SITE	
LEVEL 3	18,733 SF
LEVEL 12	1,922 SF
<b>TOTAL OPEN SPACE</b>	<b>20,655</b>
<b>TOTAL SITE AREA</b>	<b>73,254 SF</b>
<b>PERCENTAGE OF TOTAL PRIVATE OPEN SPACE</b>	<b>28.1%</b>






**LEGEND**

- PLANT BED
- BIORETENTION PLANT BED
- EXTENTS OF UNCOMPACTED SOIL PANEL

**UTILITY LEGEND**

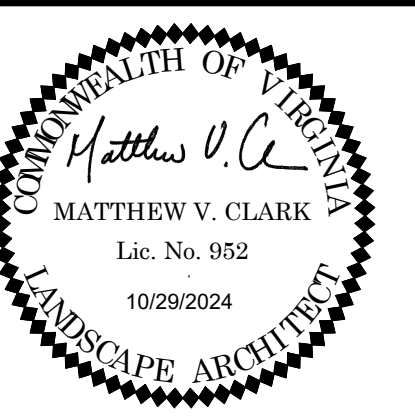- EXISTING SANITARY SEWER
- EXISTING STORM SEWER
- EXISTING STORM DRAIN
- EXISTING DOMINION ELECTRIC
- EXISTING ELECTRIC
- EXISTING PHONE
- EXISTING VERIZON FIBER OPTIC
- EXISTING WATER MAIN
- EXISTING WATER
- EXISTING NATURAL GAS
- EXISTING GAS
- EXISTING UNIDENTIFIED UTILITY LINE
- PROPOSED WATER MAIN
- PROPOSED WATER METER CLEAR ZONE
- PROPOSED STORM SEWER



**3130 LANGSTON BOULEVARD**

ROONEY PROPERTIES, LLC  
3130 LANGSTON BOULEVARD  
ARLINGTON, VA 22201

LANDDESIGN PROJ.# 2024074

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CHECKED BY: AC

SCALE: NORTH (NCS 83)

VERT: N/A  
HORZ: 1"=20'

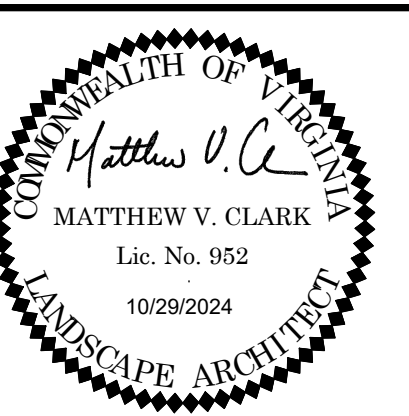
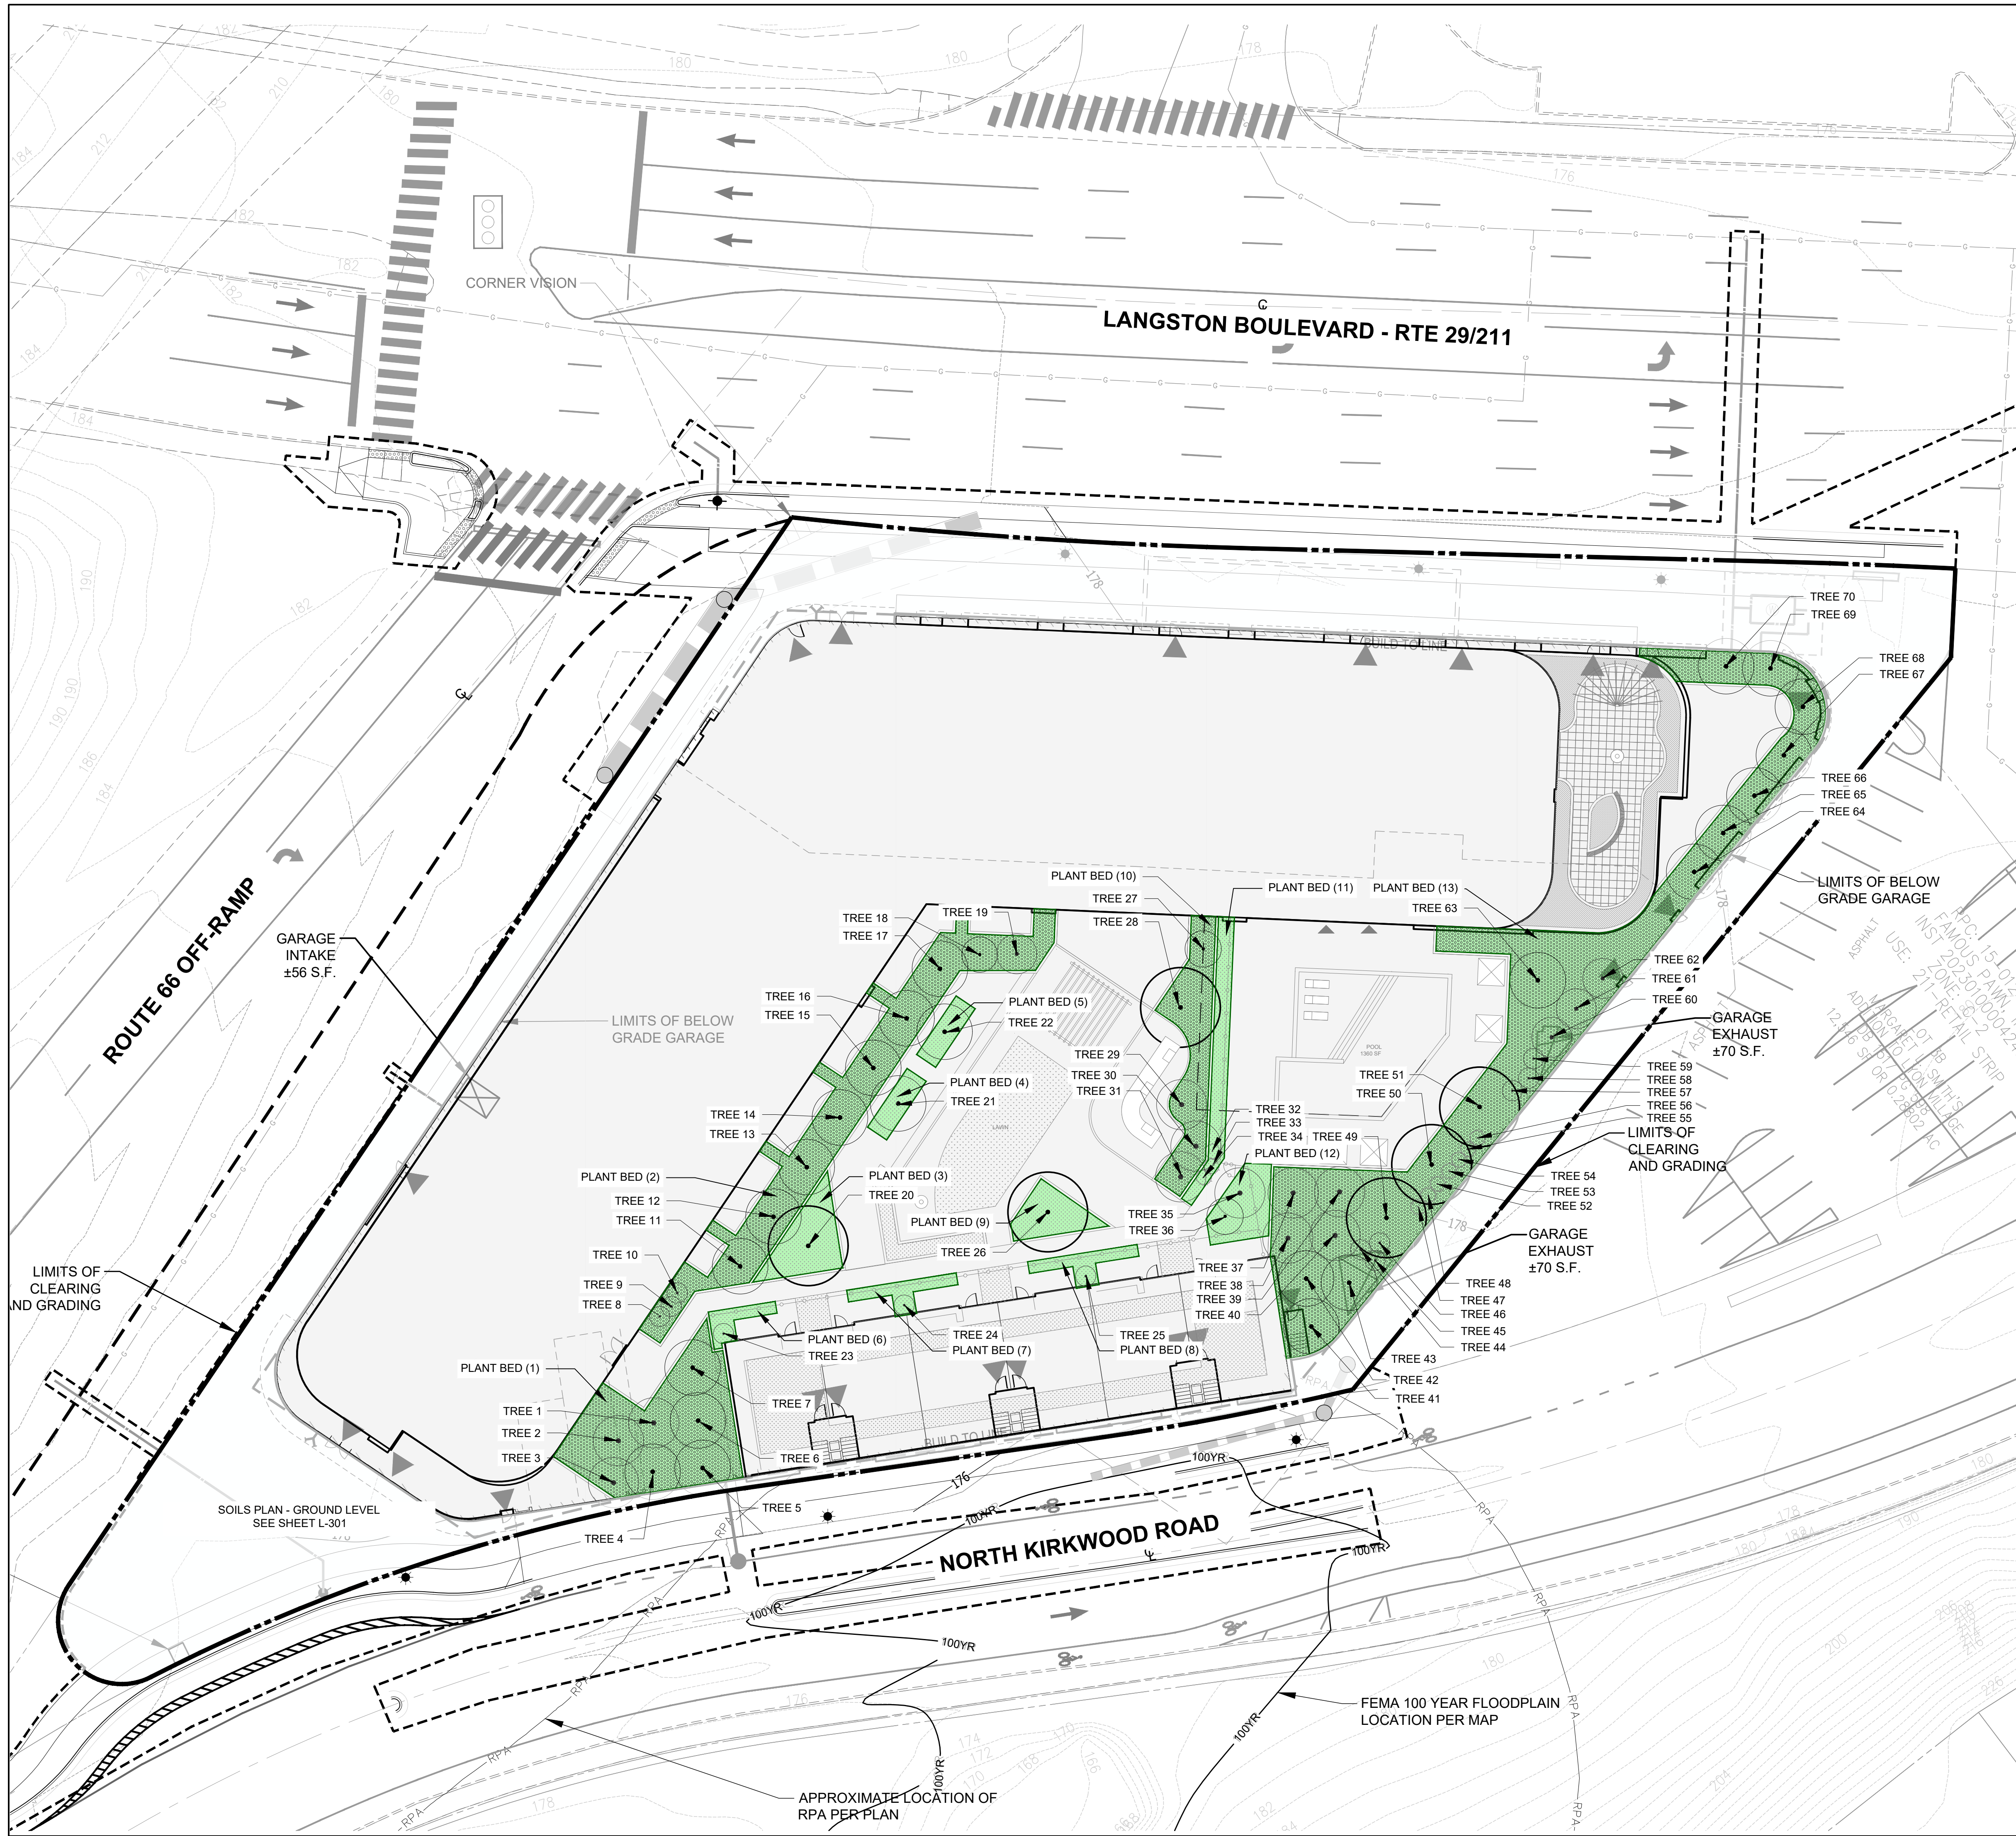
**SOILS PLAN - GROUND LEVEL**

SHEET NUMBER  
**L-301**



**LEGEND**

	PLANT BED
	BIORETENTION PLANT BED
	LAWN
	EXTENTS OF UNCOMPACTED SOIL



**3130 LANGSTON BOULEVARD**

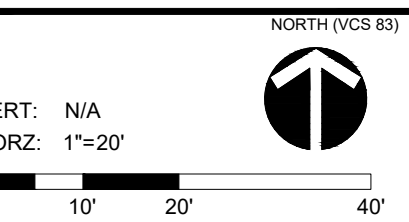
ROONEY PROPERTIES, LLC  
3130 LANGSTON BOULEVARD  
ARLINGTON, VA 22201

LANDDESIGN PROJ.# 2024074

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SHEET TITLE  
**SOILS PLAN - PODIUM & ROOF LEVEL**


SHEET NUMBER  
**L-302**



SOIL VOLUME TABULATION - GROUND LEVEL						
LOCATION	PIT SOIL AREA(SF)	TREE	TREE SOIL AREA(SF)	TREE SOIL VOLUME PROVIDED (3 FT DEPTH)	VOLUME REQUIREMENT (CU FT / TREE)	SIZE
PLANTBED 1	865	TREE 1	108.125	324.37	300	SMALL
		TREE 2	108.125	324.37	300	SMALL
		TREE 3	108.125	324.37	300	SMALL
		TREE 4	108.125	324.37	300	SMALL
		TREE 5	108.125	324.37	300	SMALL
		TREE 6	108.125	324.37	300	SMALL
		TREE 7	108.125	324.37	300	SMALL
		TREE 8	108.125	324.37	300	SMALL
PLANTBED 2*	550	TREE 9	110	330	300	MEDIUM
		TREE 10	110	330	300	MEDIUM
		TREE 11	110	330	300	MEDIUM
		TREE 12	110	330	300	MEDIUM
		TREE 13	110	330	300	MEDIUM
		TREE 14	110	330	300	LARGE
PLANTBED 3*	203	TREE 15	101.5	304.5	300	LARGE
		TREE 16	101.5	304.5	300	SMALL
PLANTBED 4*	1260	TREE 17	252	756	300	LARGE
		TREE 18	252	756	300	LARGE
		TREE 19	252	756	300	LARGE
		TREE 20	252	756	300	LARGE
PLANTBED 5*	785	TREE 21	252	756	300	LARGE
		TREE 22	261.6	784.9	300	SMALL
		TREE 23	261.6	784.9	300	LARGE
		TREE 24	261.6	784.9	300	SMALL
PLANTBED 6*	465	TREE 25	232.5	697.5	300	SMALL
		TREE 26	232.5	697.5	300	SMALL
PLANTBED 7	101	TREE 27	101	303	300	SMALL
PLANTBED 8*	2513	TREE 28	359	1077	1000	LARGE
		TREE 29	359	1077	1000	LARGE
		TREE 30	359	1077	1000	LARGE
		TREE 31	359	1077	1000	LARGE
		TREE 32	359	1077	1000	LARGE
		TREE 33	359	1077	1000	LARGE
		TREE 34	359	1077	1000	LARGE
		TREE 35	391.5	1174.5	1000	LARGE
PLANTBED 9*	3132	TREE 36	391.5	1174.5	1000	LARGE
		TREE 37	391.5	1174.5	1000	LARGE
		TREE 38	391.5	1174.5	1000	LARGE
		TREE 39	391.5	1174.5	1000	LARGE
		TREE 40	391.5	1174.5	1000	LARGE
		TREE 41	391.5	1174.5	1000	LARGE
		TREE 42	391.5	1174.5	1000	LARGE

\*NOTE: SOIL AREAS NOTED ON THIS PLAN WITH A \* SYMBOL INCLUDE CONTINUOUS UNCOMPACTED SOIL PANEL UNDER SUSPENDED HARDSCAPE  
 \*\*NOTE: SOIL AREAS NOTED ON THIS PLAN WITH A Ø SYMBOL INCLUDE STRUCTURAL CELLS

SOIL VOLUME TABULATION - PODIUM AND ROOF LEVEL						
LOCATION	PIT SOIL AREA(SF)	TREE	TREE SOIL AREA(SF)	TREE SOIL VOLUME PROVIDED (3 FT DEPTH)	VOLUME REQUIREMENT (CU FT / TREE)	SIZE
PLANTBED 1	1130	TREE 1	161	483	300	SMALL
		TREE 2	161	483	300	SMALL
		TREE 3	161	483	300	SMALL
		TREE 4	161	483	300	MEDIUM
		TREE 5	161	483	300	MEDIUM
		TREE 6	161	483	300	MEDIUM
		TREE 7	161	483	300	MEDIUM
		TREE 8	102	308	300	SMALL
		TREE 9	102	308	300	SMALL
		TREE 10	102	308	300	SMALL
		TREE 11	102	308	300	MEDIUM
		TREE 12	102	308	300	MEDIUM
		TREE 13	102	308	300	MEDIUM
PLANTBED 2	1440	TREE 14	102	308	300	MEDIUM
		TREE 15	102	308	300	MEDIUM
		TREE 16	102	308	300	MEDIUM
		TREE 17	102	308	300	MEDIUM
		TREE 18	102	308	300	MEDIUM
		TREE 19	102	308	300	SMALL
		TREE 20	281	843	300	LARGE
		TREE 21	100	300	300	MEDIUM
		TREE 22	100	300	300	MEDIUM
		TREE 23	100	300	300	SMALL
		TREE 24	113	339	300	SMALL
		TREE 25	115	345	300	SMALL
		TREE 26	194	582	300	LARGE
PLANTBED 3	281	TREE 27	108.4	325.2	300	MEDIUM
		TREE 28	108.4	325.2	300	LARGE
		TREE 29	108.4	325.2	300	SMALL
		TREE 30	108.4	325.2	300	SMALL
		TREE 31	108.4	325.2	300	SMALL
		TREE 32	100	300	300	SMALL
		TREE 33	100	300	300	SMALL
		TREE 34	100	300	300	SMALL
		TREE 35	119	357	300	SMALL
		TREE 36	119	357	300	SMALL
		TREE 37	113.6	340.8	300	SMALL
		TREE 38	113.6	340.8	300	SMALL
		TREE 39	113.6	340.8	300	SMALL
PLANTBED 4	100	TREE 40	113.6	340.8	300	SMALL
		TREE 41	113.6	340.8	300	MEDIUM
		TREE 42	113.6	340.8	300	MEDIUM
		TREE 43	113.6	340.8	300	MEDIUM
		TREE 44	113.6	340.8	300	SMALL
		TREE 45	113.6	340.8	300	SMALL
		TREE 46	113.6	340.8	300	SMALL
		TREE 47	113.6	340.8	300	SMALL
		TREE 48	113.6	340.8	300	SMALL
		TREE 49	113.6	340.8	300	LARGE
		TREE 50	113.6	340.8	300	LARGE
		TREE 51	113.6	340.8	300	LARGE
		TREE 52	113.6	340.8	300	SMALL
TREE 53	113.6	340.8	300	SMALL		
TREE 54	113.6	340.8	300	SMALL		
TREE 55	113.6	340.8	300	SMALL		
TREE 56	113.6	340.8	300	SMALL		
TREE 57	113.6	340.8	300	SMALL		
TREE 58	113.6	340.8	300	SMALL		
TREE 59	113.6	340.8	300	SMALL		
TREE 60	113.6	340.8	300	MEDIUM		
TREE 61	113.6	340.8	300	MEDIUM		
TREE 62	113.6	340.8	300	MEDIUM		
TREE 63	113.6	340.8	300	MEDIUM		
TREE 64	113.6	340.8	300	MEDIUM		
TREE 65	113.6	340.8	300	MEDIUM		
TREE 66	113.6	340.8	300	MEDIUM		
TREE 67	113.6	340.8	300	MEDIUM		
TREE 68	113.6	340.8	300	MEDIUM		
TREE 69	113.6	340.8	300	MEDIUM		
TREE 70	113.6	340.8	300	MEDIUM		

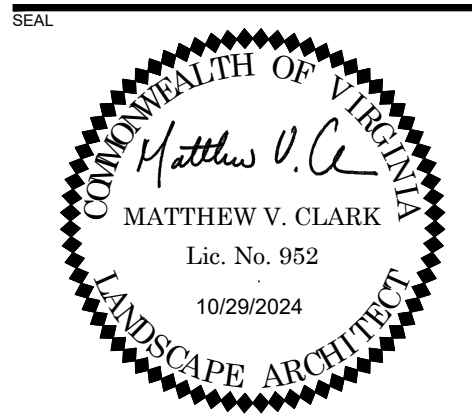

**3130 LANGSTON BOULEVARD**

ROONEY PROPERTIES, LLC  
3130 LANGSTON BOULEVARD  
ARLINGTON, VA 22201

LANDDESIGN PROJ.# 2024074

**REVISION / ISSUANCE**

NO.	DESCRIPTION	DATE
1	4.1 SITE PLAN SUBMISSION	08/09/2024
2	4.1 SITE PLAN RESUBMISSION	10/29/2024

DESIGNED BY: GC  
DRAWN BY: JM  
CHECKED BY: AC

SCALE: NORTH (VCB 8)

VERT: N/A  
HORZ: N/A

SHEET TITLE

SOIL VOLUME TABULATIONS

SHEET NUMBER

**L-303**



PLANT SCHEDULE

SYMBOL CODE BOTANICAL / COMMON NAME

EVERGREEN TREES

ILOP ILEX OPACA / AMERICAN HOLLY

SHADE TREES

ACRU ACER RUBRUM 'OCTOBER GLORY' TM / OCTOBER GLORY MAPLE

GYM KEN GYMNOCLADUS DIOICUS / KENTUCKY COFFEETREE

SMALL DECIDUOUS

AMCA AMELANCHIER CANADENSIS / CANADIAN SERVICEBERRY

CECA CERCIS CANADENSIS / EASTERN REDBUD

STREET TREES

QUBI QUERCUS BICOLOR / SWAMP WHITE OAK

QUCO QUERCUS COCCINEA / SCARLET OAK

QUIM QUERCUS IMBRICARIA / SHINGLE OAK

QULY QUERCUS LYRATA / OVERCUP OAK

ULVF ULMUS AMERICANA 'VALLEY FORGE' / AMERICAN ELM

LEGEND

PLANT BED  
BIORETENTION PLANT BED  
LAWN

NOTES:

- ARLINGTON COUNTY ZONING PER CHAPTER 14.2.2 LANDSCAPING REQUIRES MINIMUM TWENTY FIVE PERCENT (25%) SHRUB COVERAGE AT MATURITY.
- TREES PLANTED ABOVE STORM SEWER TO HAVE A MINIMUM OF 3' SOIL DEPTH.

SHRUB COVERAGE CALCULATIONS

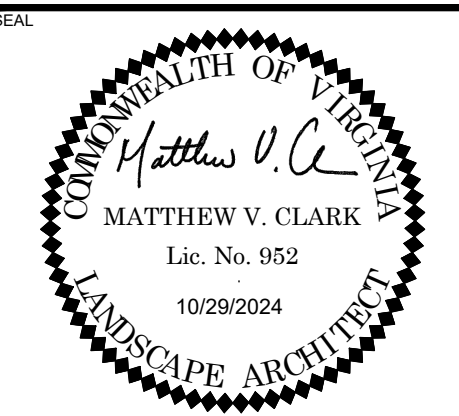
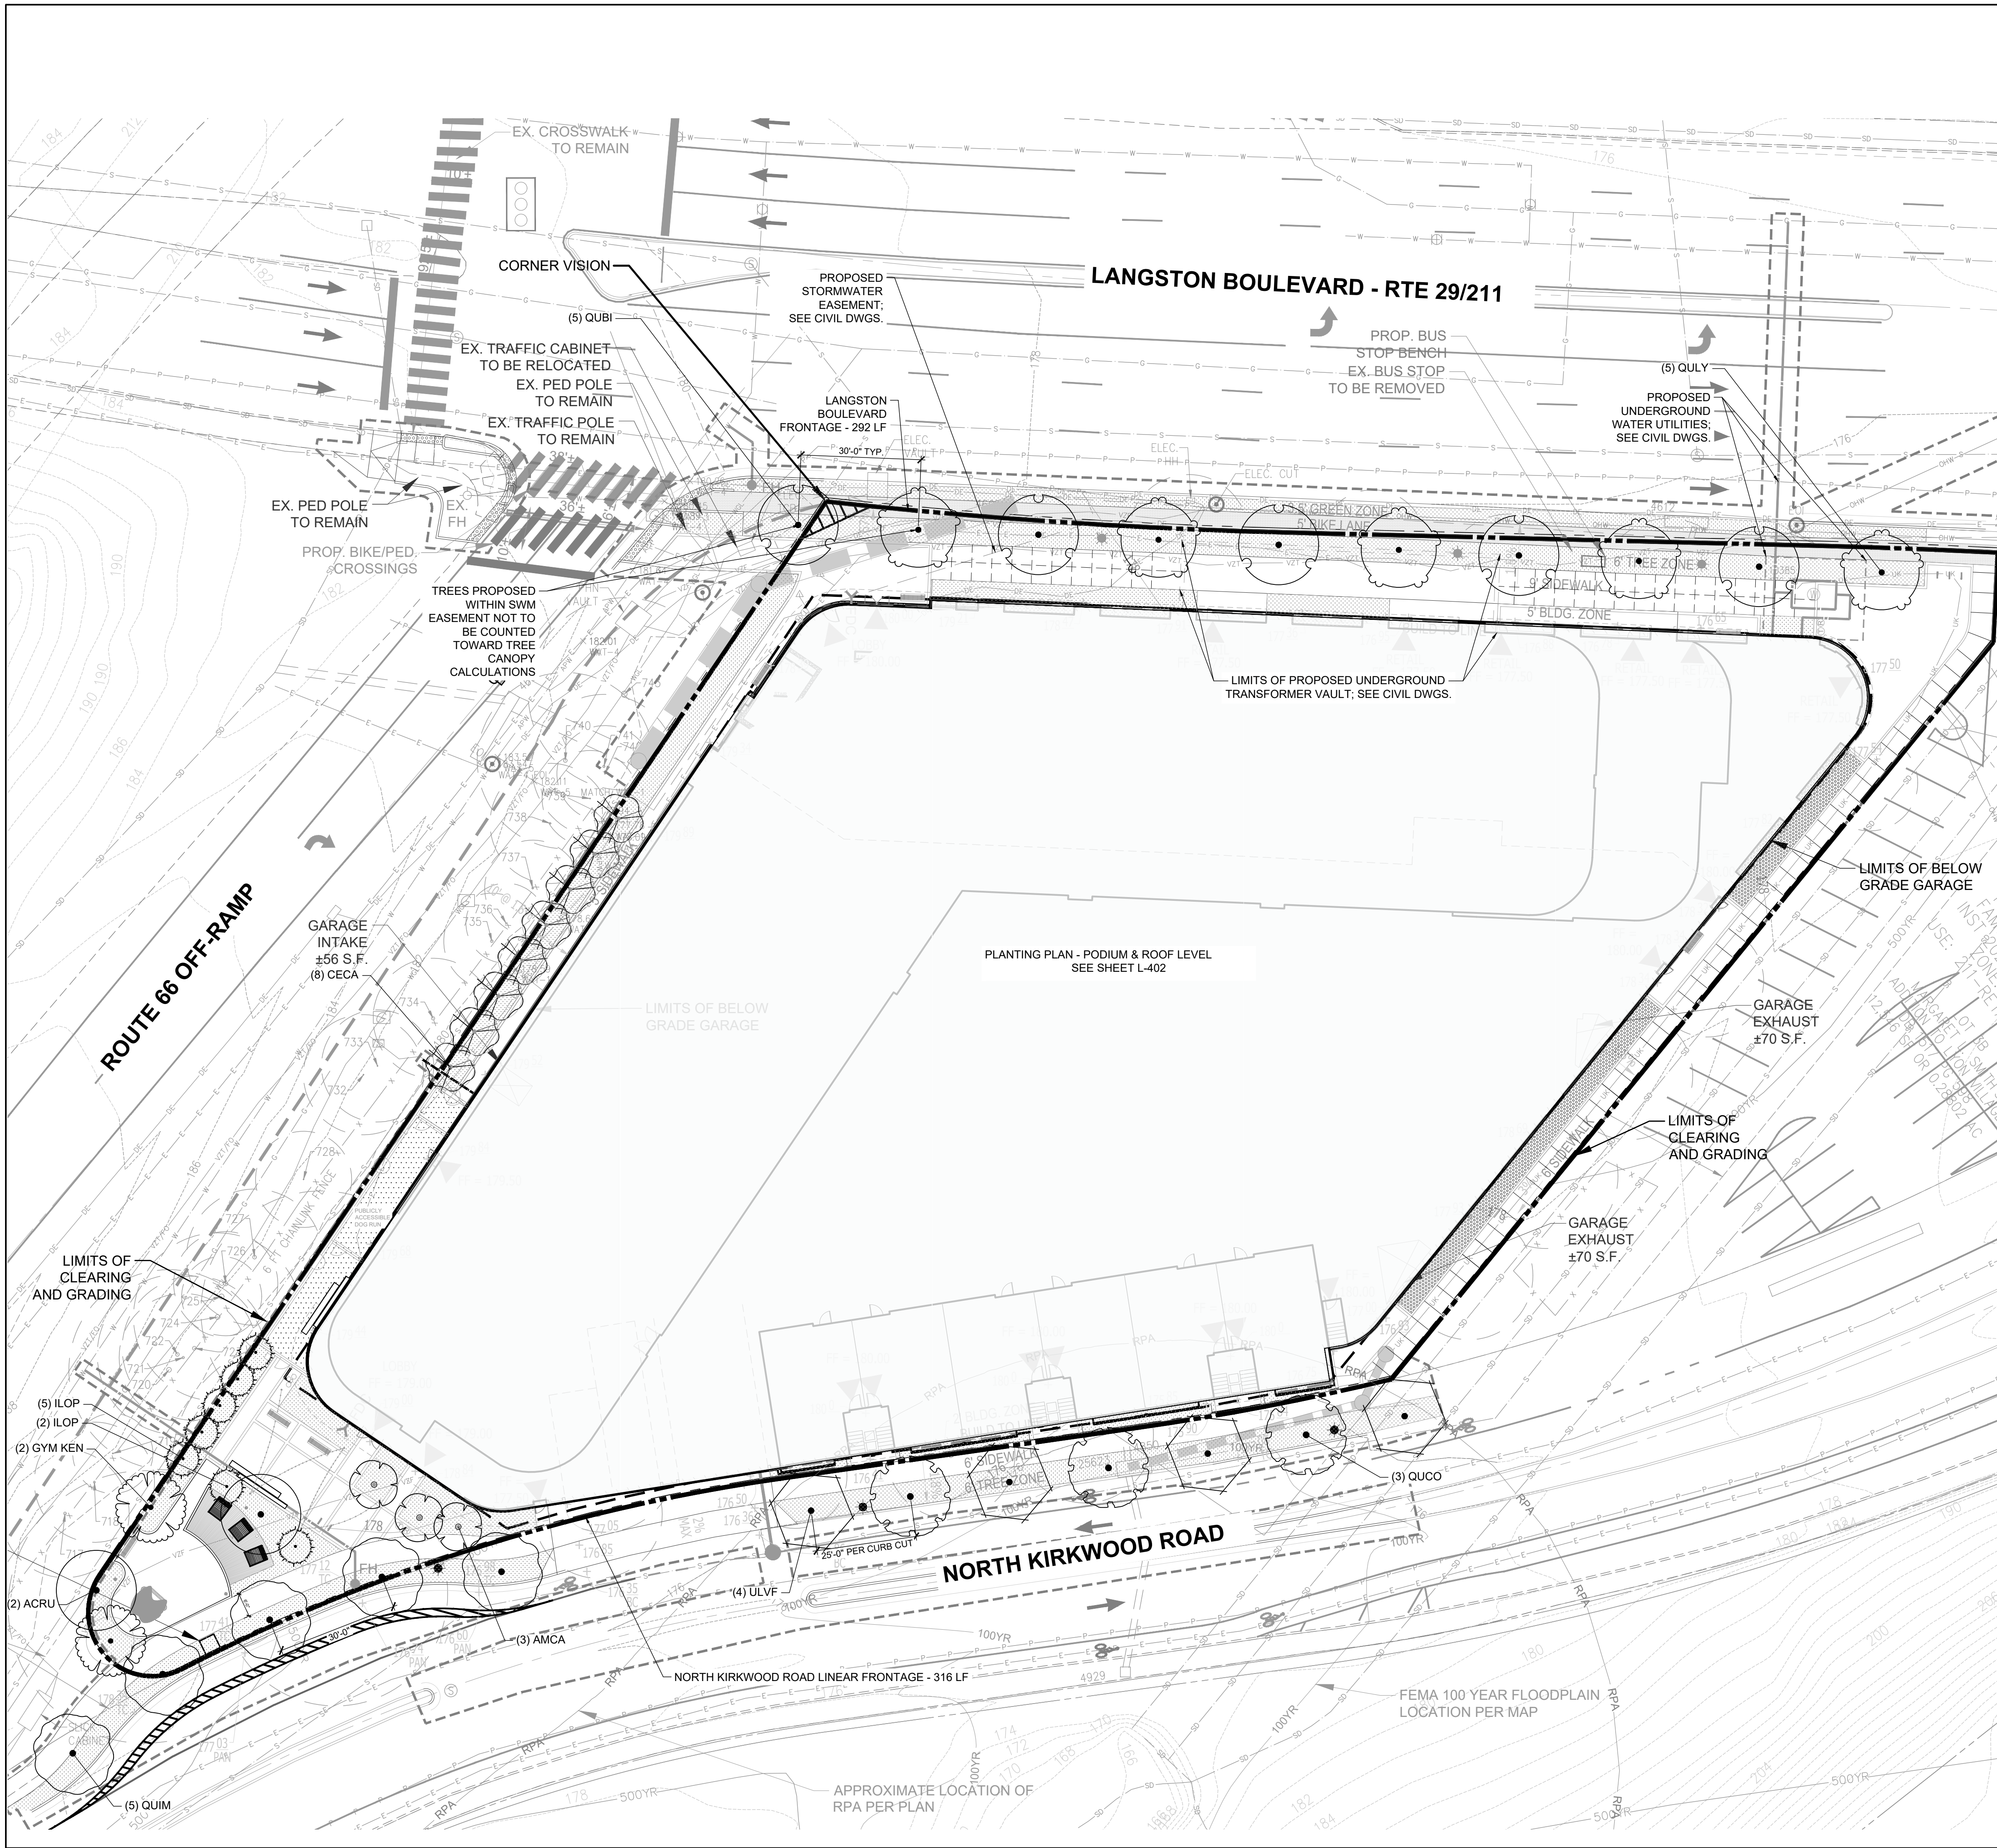
GROUND LEVEL  
TOTAL SHRUB COVERAGE PROVIDED: 1839 SF  
TOTAL PLANT BED AREA: 7355 SF  
PERCENT OF SHRUB COVERAGE PROVIDED: 25%

PODIUM LEVEL  
TOTAL SHRUB COVERAGE PROVIDED: 2142 SF  
TOTAL PLANT BED AREA: 8566 SF  
PERCENT OF SHRUB COVERAGE PROVIDED: 25%

ROOF LEVEL  
TOTAL SHRUB COVERAGE PROVIDED: 193 SF  
TOTAL PLANT BED AREA: 770 SF  
PERCENT OF SHRUB COVERAGE PROVIDED: 25%

UTILITY LEGEND

EXISTING SANITARY SEWER  
EXISTING STORM SEWER  
EXISTING STORM DRAIN  
EXISTING DOMINION ELECTRIC  
EXISTING ELECTRIC  
EXISTING PHONE  
EXISTING VERIZON FIBER OPTIC  
EXISTING WATER MAIN  
EXISTING WATER  
EXISTING NATURAL GAS  
EXISTING GAS  
EXISTING UNIDENTIFIED UTILITY LINE  
PROPOSED GAS  
PROPOSED WATER MAIN  
PROPOSED WATER METER CLEAR ZONE  
PROPOSED STORM SEWER



3130 LANGSTON BOULEVARD

ROONEY PROPERTIES, LLC  
3130 LANGSTON BOULEVARD  
ARLINGTON, VA 22201

LANDDESIGN PROJ.# 2024074

REVISION / ISSUANCE

NO.	DESCRIPTION	DATE
1	4.1 SITE PLAN SUBMISSION	08/09/2024
2	4.1 SITE PLAN RESUBMISSION	10/29/2024

DESIGNED BY: GC  
DRAWN BY: JM  
CHECKED BY: AC

SCALE: NORTH (NCS 83)  
VERT: N/A  
HORZ: 1"=20'  
0 10 20 40'

SHEET TITLE  
PLANTING PLAN - GROUND LEVEL


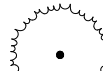
SHEET NUMBER  
L-401



PLANT SCHEDULE L-402

SYMBOL CODE BOTANICAL / COMMON NAME

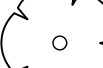




EVERGREEN TREES

-  ILOP ILEX OPACA / AMERICAN HOLLY
-  THOC THUJA OCCIDENTALIS / AMERICAN ARBORVITAE


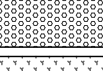

SHADE TREES

-  ACRU ACER RUBRUM 'OCTOBER GLORY' TM / OCTOBER GLORY MAPLE
-  BENI BETULA NIGRA 'BNMTF' TM / DURA HEAT RIVER BIRCH
-  GYM KEN GYMNOCLADUS DIOICUS / KENTUCKY COFFEETREE
-  NYS WIL NYSSA SYLVATICA 'WILDFIRE' / WILDFIRE TUPELO
-  ROPS ROBINIA PSEUDOACACIA / BLACK LOCUST
-  SAS ALB SASSAFRAS ALBIDUM / SASSAFRAS

SMALL DECIDUOUS

-  AMCA AMELANCHIER CANADENSIS / CANADIAN SERVICEBERRY
-  CEOC CEPHALANTHUS OCCIDENTALIS / BUTTONBUSH
-  COFL CORNUS FLORIDA / FLOWERING DOGWOOD
-  MAG SWE MAGNOLIA VIRGINIANA / SWEETBAY MAGNOLIA
-  VIB LEN VIBURNUM LENTAGO / NANNYBERRY

LEGEND

-  PLANT BED
-  BIORETENTION PLANT BED
-  LAWN

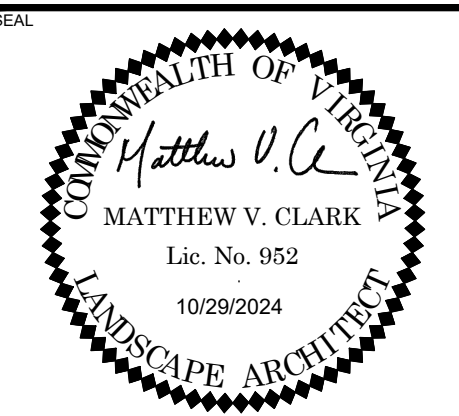
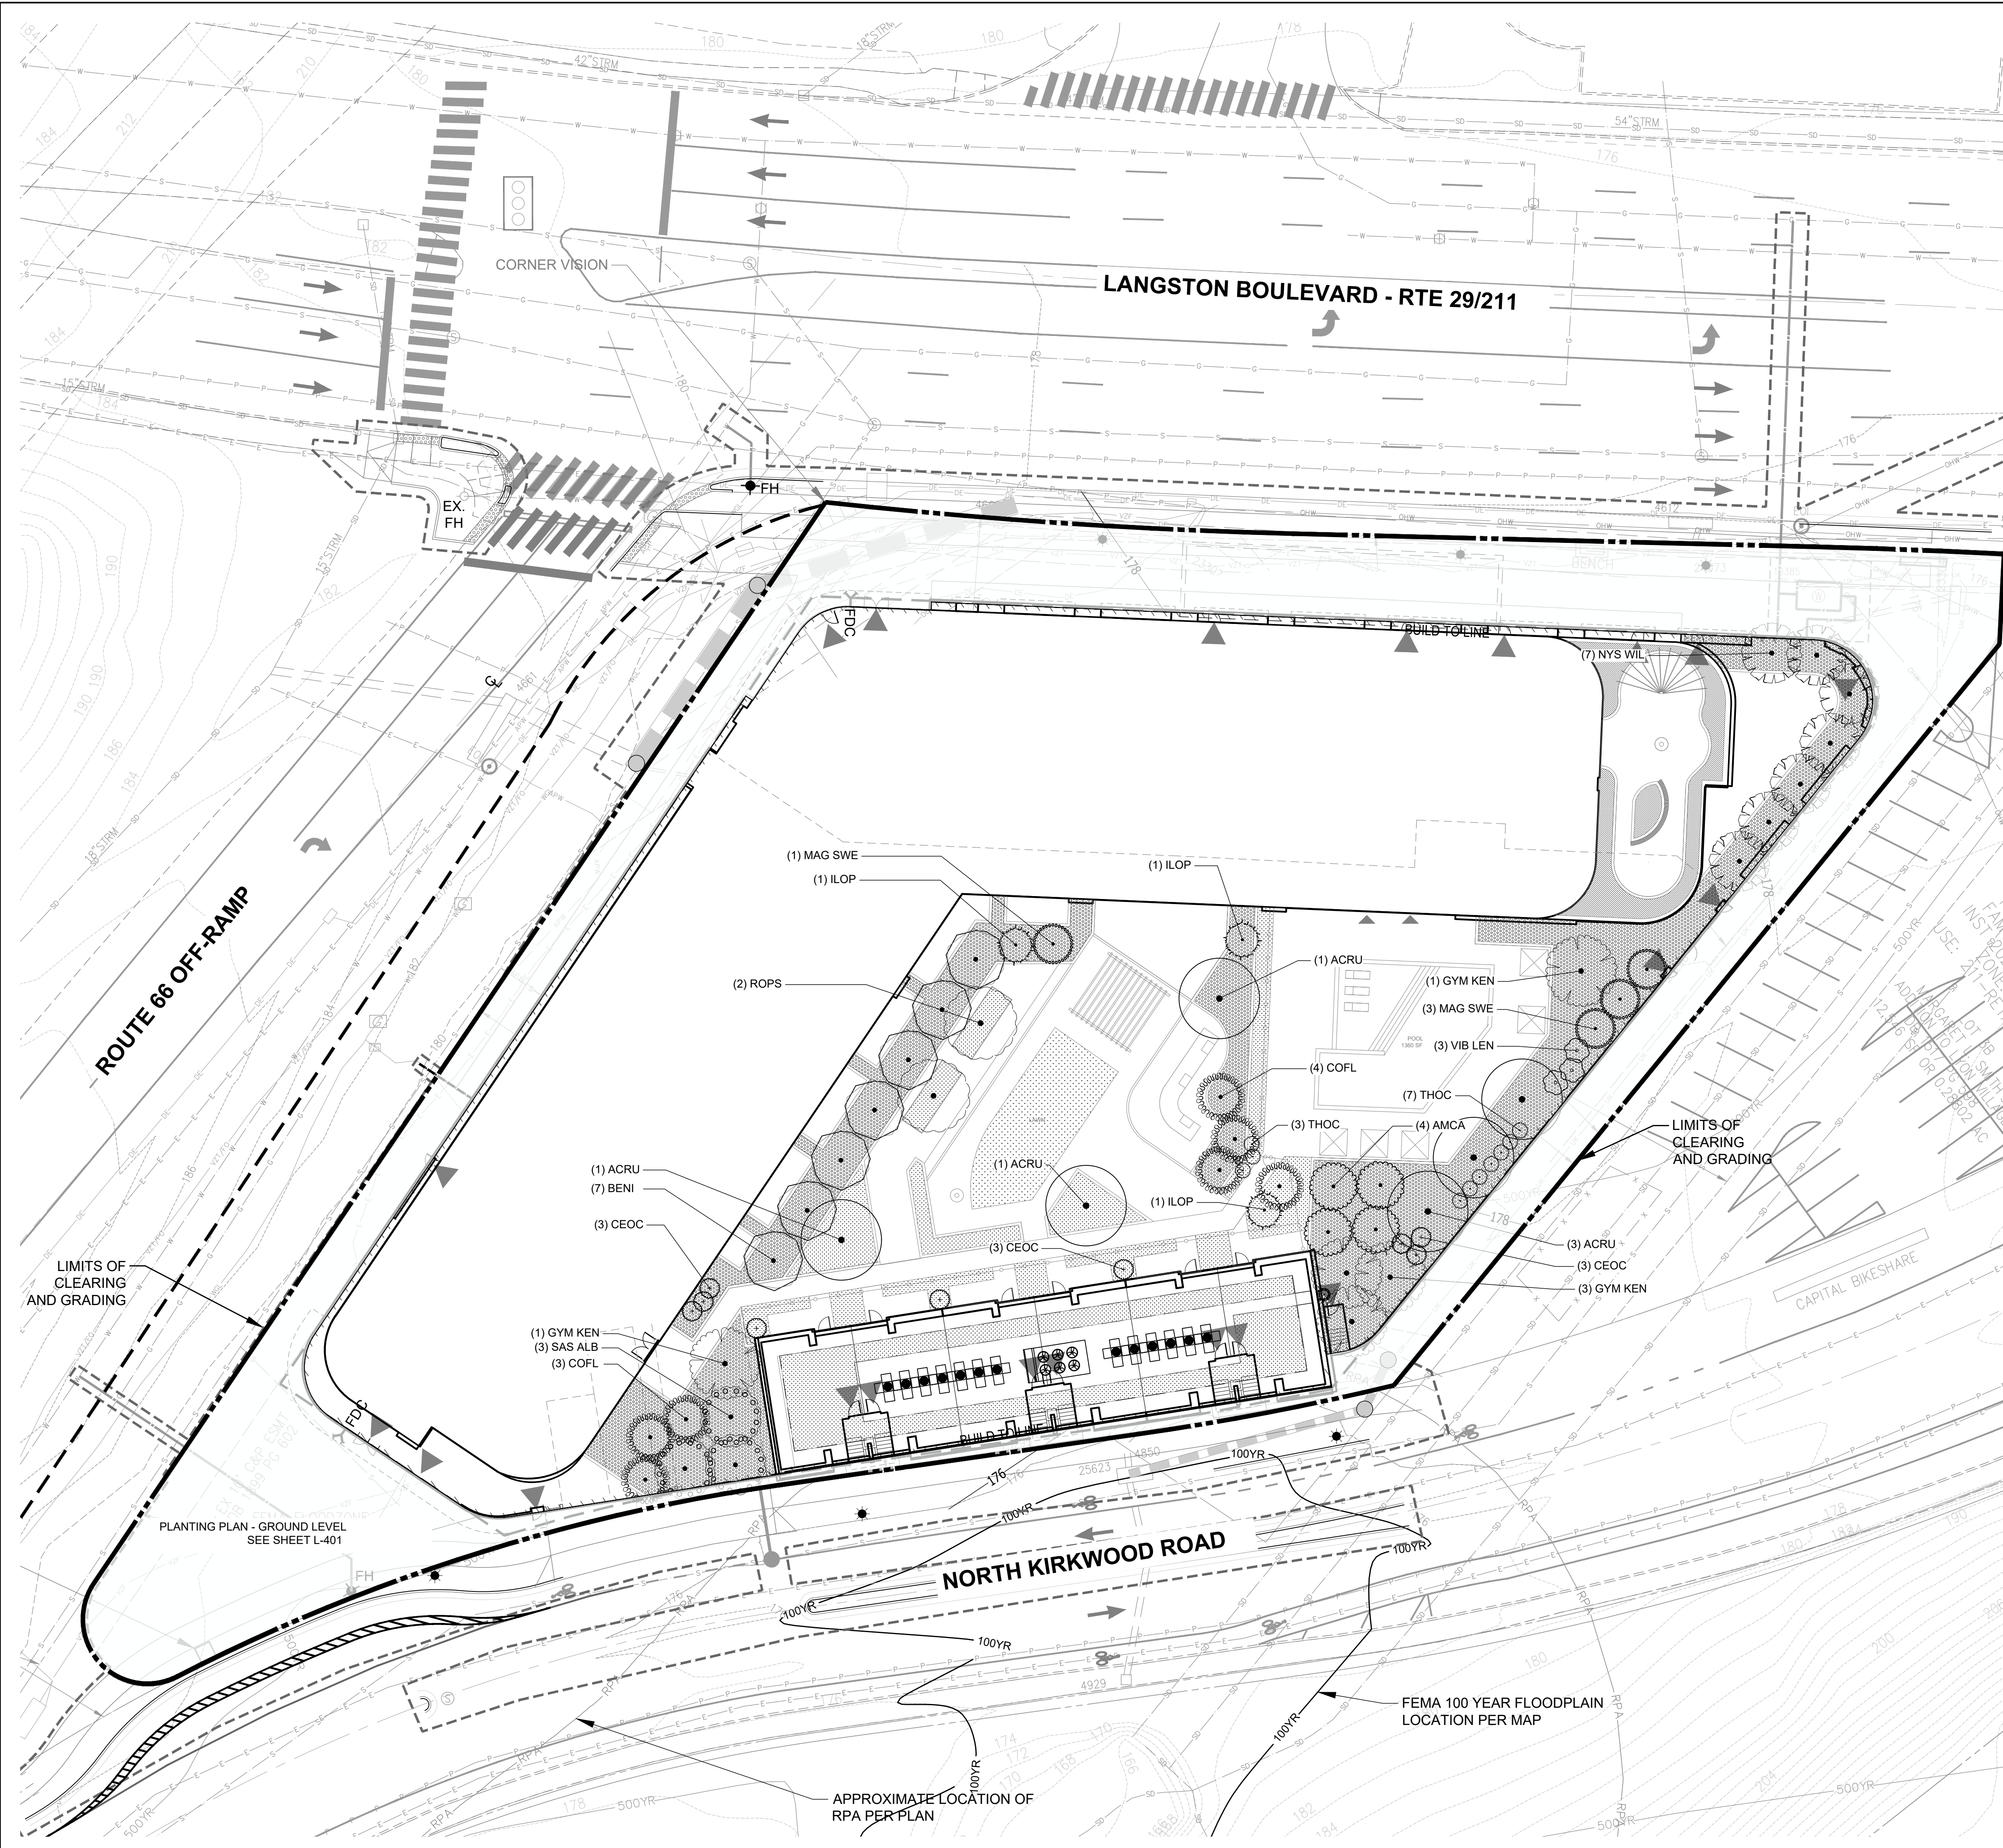
NOTE: ARLINGTON COUNTY ZONING PER CHAPTER 14.2.2 LANDSCAPING REQUIRES MINIMUM TWENTY FIVE PERCENT (25%) SHRUB COVERAGE AT MATURITY.

SHRUB COVERAGE CALCULATIONS

GROUND LEVEL  
TOTAL SHRUB COVERAGE PROVIDED: 1839 SF  
TOTAL PLANT BED AREA: 7355 SF  
PERCENT OF SHRUB COVERAGE PROVIDED: 25%

PODIUM LEVEL  
TOTAL SHRUB COVERAGE PROVIDED: 2142 SF  
TOTAL PLANT BED AREA: 8566 SF  
PERCENT OF SHRUB COVERAGE PROVIDED: 25%

ROOF LEVEL  
TOTAL SHRUB COVERAGE PROVIDED: 193 SF  
TOTAL PLANT BED AREA: 770 SF  
PERCENT OF SHRUB COVERAGE PROVIDED: 25%



3130 LANGSTON BOULEVARD


ROONEY PROPERTIES, LLC  
3130 LANGSTON BOULEVARD  
ARLINGTON, VA 22201

LANDDESIGN PROJ# 2024074

REVISION / ISSUANCE

NO.	DESCRIPTION	DATE
1	4.1 SITE PLAN SUBMISSION	08/09/2024
2	4.1 SITE PLAN RESUBMISSION	10/29/2024

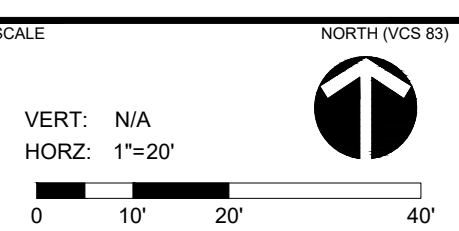DESIGNED BY: GC  
DRAWN BY: JM  
CHECKED BY: AC









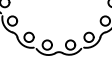
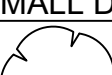











PLANTING PLAN - PODIUM & ROOF LEVEL

SHEET NUMBER  
**L-402**



PLANT SCHEDULE

SYMBOL	CODE	QTY	BOTANICAL / COMMON NAME	CONTAINER	CAL	HT.	SPD.
<b>EVERGREEN TREES</b>							
	ILOP	10	ILEX OPACA / AMERICAN HOLLY 218.75 CHESAPEAKE BAY PRESERVATION ORDINANCE COVERAGE; 900 CF SOIL REQUIRED	B & B		6' - 7'	
	THOC	10	THUJA OCCIDENTALIS / AMERICAN ARBORVITAE 600 CF SOIL VOLUME; 62.5 TREE CANOPY COVERAGE	-		6' - 7'	
<b>SHADE TREES</b>							
	ACRU	8	ACER RUBRUM 'OCTOBER GLORY' TM / OCTOBER GLORY MAPLE 1200 CF SOIL REQUIRED; 393.75 CANOPY COVERAGE	B & B		2"-2 1/2"	
	BENI	7	BETULA NIGRA 'BNMTF' TM / DURA HEAT RIVER BIRCH 900 CF SOIL REQUIRED; 218.75 CANOPY COVERAGE	B & B	3.5" CAL	8' - 10'	5' - 7'
	GYM KEN	7	GYMNOCLADUS DIOICUS / KENTUCKY COFFEETREE 1200 CF SOIL REQUIRED; 218.75 CHESAPEAKE BAY PRESERVATION ORDINANCE COVERAGE	B & B		2"-2 1/2"	
	NYS WIL	7	NYSSA SYLVATICA 'WILDFIRE' / WILDFIRE TUPELO 1200 CF SOIL VOLUME REQUIRED; 312.75 CHESAPEAKE BAY PRESERVATION ORDINANCE COVERAGE	B & B		1 3/4" - 2"	
	ROPS	2	ROBINIA PSEUDOACACIA / BLACK LOCUST 900 CF SOIL REQUIRED; 218.75 CHESAPEAKE BAY PRESERVATION ORDINANCE COVERAGE	B & B		2"-2 1/2"	
	SAS ALB	3	SASSAFRAS ALBIDUM / SASSAFRAS 900 CF SOIL VOLUME REQUIRED; 218.75 CHESAPEAKE BAY PRESERVATION ORDINANCE COVERAGE	B & B		6' - 7'	
<b>SMALL DECIDUOUS</b>							
	AMCA	7	AMELANCHIER CANADENSIS / CANADIAN SERVICEBERRY 600 CF SOIL REQUIRED; 137.5 CANOPY COVERAGE; SINGLE TRUNK	B & B		6' - 7'	
	CEOC	9	CEPHALANTHUS OCCIDENTALIS / BUTTONBUSH 600 CF SOIL VOLUME REQUIRED; 62.5 CHESAPEAKE BAY PRESERVATION ORDINANCE COVERAGE	15 GAL		6' - 7'	
	CECA	8	CERCIS CANADENSIS / EASTERN REDBUD 600 CF SOIL REQUIRED; 137.5 CANOPY COVERAGE	B & B		1" MIN.	
	COFL	7	CORNUS FLORIDA / FLOWERING DOGWOOD 600 CF SOIL VOLUME REQUIRED; 137.5 CHESAPEAKE BAY PRESERVATION ORDINANCE COVERAGE	B & B		6' - 7'	
	MAG SWE	4	MAGNOLIA VIRGINIANA / SWEETBAY MAGNOLIA SEMI EVERGREEN; 600 CF SOIL VOLUME REQUIRED; 137.5 CHESAPEAKE BAY PRESERVATION ORDINANCE COVERAGE	B & B		6' - 7'	
	VIB LEN	3	VIBURNUM LENTAGO / NANNYBERRY SINGLE STEM; 600 CF SOIL REQUIRED; 62.5 CHESAPEAKE BAY PRESERVATION ORDINANCE COVERAGE	15 GAL		6' - 7'	
<b>STREET TREES</b>							
	QUBI	5	QUERCUS BICOLOR / SWAMP WHITE OAK 1200 CF SOIL REQUIRED; 393.75 CANOPY COVERAGE	B & B		1 3/4" - 2"	
	QUCO	3	QUERCUS COCCINEA / SCARLET OAK 1200 SF SOIL VOLUME; 393.75 TREE CANOPY CREDIT	B & B		1 3/4" - 2"	
	QUIM	5	QUERCUS IMBRICARIA / SHINGLE OAK 1200 CF SOIL REQUIRED; 393.75 CHESAPEAKE BAY PRESERVATION ORDINANCE COVERAGE	B & B		1 3/4" - 2"	
	QULY	5	QUERCUS LYRATA / OVERCUP OAK 1200 SF SOIL VOLUME; 393.75 TREE CANOPY CREDIT	B & B		1 3/4" - 2"	
	ULVF	4	ULMUS AMERICANA 'VALLEY FORGE' / AMERICAN ELM 1200 CF SOIL REQUIRED; 393.75 CANOPY COVERAGE	B & B		1 3/4" - 2"	

TREE REPLACEMENT AND 20-YEAR CANOPY CALCULATIONS	
PER ARLINGTON COUNTY CODE AND CHESAPEAKE BAY PRESERVATION ORDINANCE	
20-YR TREE CANOPY REQUIREMENT	
PROPERTY BOUNDARY AREA	73,254.00 SF
REQUIRED 20-YR TREE CANOPY (35%):	25638.9 SF
20-YR TREE CANOPY PRESERVED (SF):	0.00 SF
20-YEAR TREE CANOPY TO BE MET THROUGH PLANTING (SF):	25,638.90 SF

20-YEAR TREE CANOPY: PROPOSED PLANTINGS							
QTY	SPECIES	COMMON NAME	SIZE AT PLANTING (FT)	CALIPER AT PLANTING (IN)	SPREAD AT PLANTING (FT)	SIZE	20-YR COVERAGE (SF)
10	Ilex opaca	American Holly	6-7'	-	3	SMALL	218.75
10	Thuja occidentalis	American arborvitae	6-7'	-	3	SMALL	62.50
8	Acer rubrum 'October Glory'	October Glory maple	-	2-2.5	3	LARGE	393.75
7	Betula nigra 'BNMTF'	Dura Heat river birch	8 - 10'	-	5 - 7	MEDIUM	218.75
7	Gymnocladus dioicus	Kentucky Coffeetree	-	2-2.5	3	MEDIUM	218.75
7	Nyssa sylvatica	Black Tupelo	-	1.75-2	5	MEDIUM	312.50
2	Robinia pseudoacacia	Black Locust	-	2-2.5	3	MEDIUM	218.75
3	Sassafras albidum	Sassafras	6-7'	-	3	MEDIUM	218.75
7	Amelanchier canadensis	Canadian serviceberry	6-7'	-	3	SMALL	137.95
9	Cephalanthus occidentalis	Buttonbush	6-7'	-	3	SMALL	62.50
8	Cercis canadensis	eastern redbud	-	1"	3	SMALL	137.50
7	Cornus florida	Flowering Dogwood	6-7'	-	3	SMALL	137.50
4	Magnolia virginiana	Sweetbay Magnolia	6-7'	-	3	SMALL	137.50
3	Viburnum lentago	Nannyberry	6-7'	-	3	SMALL	62.50
4	Quercus bicolor	swamp white oak	-	1.75-2	5	LARGE	393.75
3	Quercus coccinea	scarlet oak	-	1.75-2	5	LARGE	393.75
5	Quercus imbricaria	Shingle Oak	-	1.75-2	5	LARGE	393.75
4	Quercus lyrata	overcup oak	-	1.75-2	5	LARGE	393.75
4	Ulmus americana 'Valley Forge'	American elm	-	1.75-2	5	LARGE	393.75
112						TOTAL 20-YR COVERAGE PROPOSED (SF)	24509.40

REQUIRED TREE CANOPY	25638.90 SF
PRESERVED TREE CANOPY	0.00 SF
PROPOSED TREE CANOPY	24509.40 SF
TOTAL TREE CANOPY	24509.40 SF

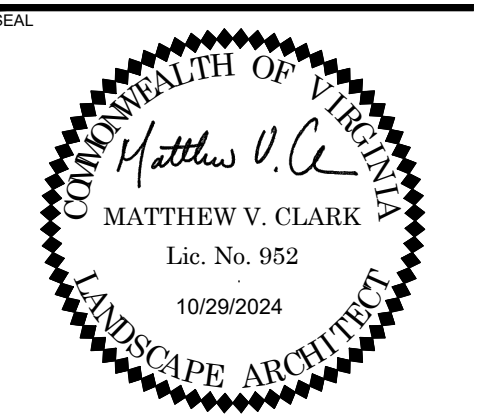
MISSING TREE CANOPY - TREE FUND  
1129.50 SF

SHRUB COVERAGE CALCULATIONS

GROUND LEVEL  
TOTAL SHRUB COVERAGE PROVIDED: 1839 SF  
TOTAL PLANT BED AREA: 7355 SF  
PERCENT OF SHRUB COVERAGE PROVIDED: 25%

PODIUM LEVEL  
TOTAL SHRUB COVERAGE PROVIDED: 2142 SF  
TOTAL PLANT BED AREA: 8566 SF  
PERCENT OF SHRUB COVERAGE PROVIDED: 25%

ROOF LEVEL  
TOTAL SHRUB COVERAGE PROVIDED: 193 SF  
TOTAL PLANT BED AREA: 770 SF  
PERCENT OF SHRUB COVERAGE PROVIDED: 25%



PROJECT  
**3130 LANGSTON BOULEVARD**  
ROONEY PROPERTIES, LLC  
3130 LANGSTON BOULEVARD  
ARLINGTON, VA 22201

REVISION / ISSUANCE		
NO.	DESCRIPTION	DATE
1	4.1 SITE PLAN SUBMISSION	08/09/2024
2	4.1 SITE PLAN RESUBMISSION	10/29/2024

DESIGNED BY: GC  
DRAWN BY: JM  
CHECKED BY: AC

SCALE: NORTH (VCB 8)  
VERT: N/A  
HORZ: N/A

SHEET TITLE  
**PLANT SCHEDULE AND 20 YEAR CANOPY WORKSHEET**  
SHEET NUMBER  
**L-403**









NOTE: OR CLIENT/COUNTY APPROVED EQUAL.

1 CONCRETE PAVING  
L-501 PICTORIAL

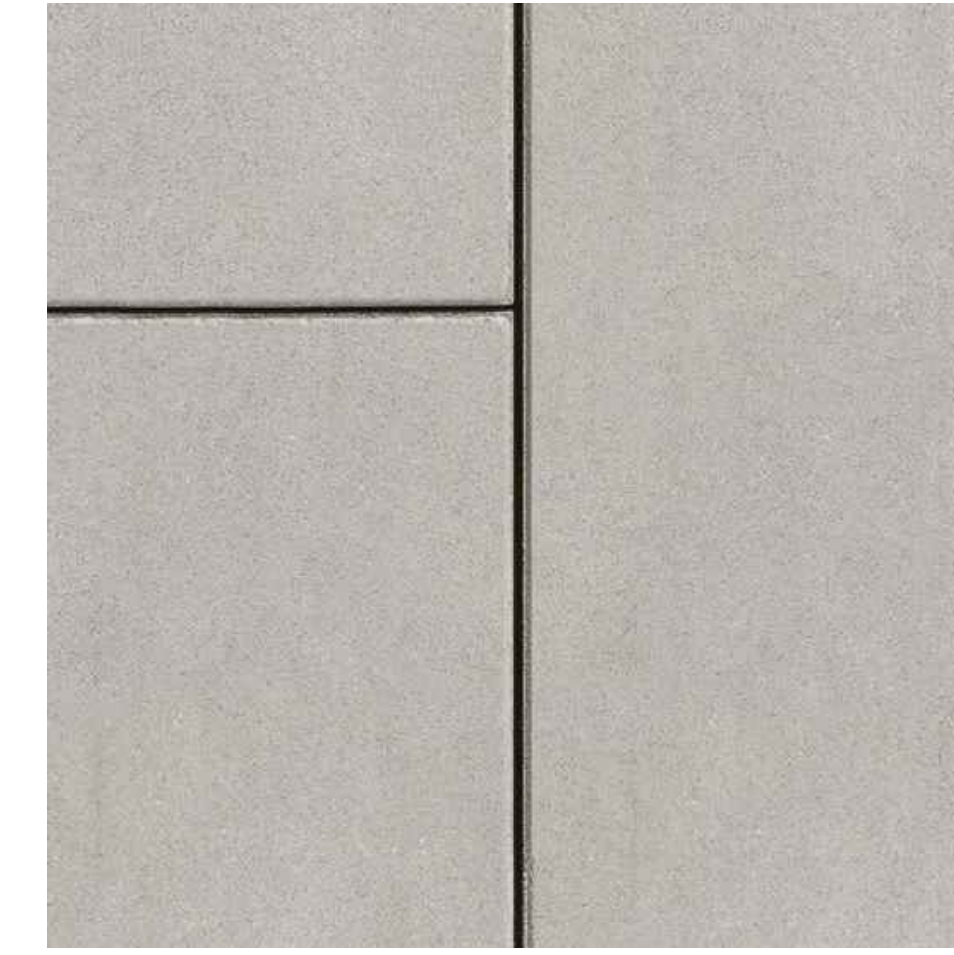
NTS



NOTE: OR CLIENT/COUNTY APPROVED EQUAL.

4 UNIT PAVERS - TYPE 3  
L-501 PICTORIAL

NTS



NOTE: OR CLIENT/COUNTY APPROVED EQUAL.

7 POOL DECK  
L-501 PICTORIAL

NTS



NOTE: OR CLIENT/COUNTY APPROVED EQUAL.

2 UNIT PAVERS - TYPE 1  
L-501 PICTORIAL

NTS



NOTE: OR CLIENT/COUNTY APPROVED EQUAL.

5 UNIT PAVERS - TYPE 4  
L-501 PICTORIAL

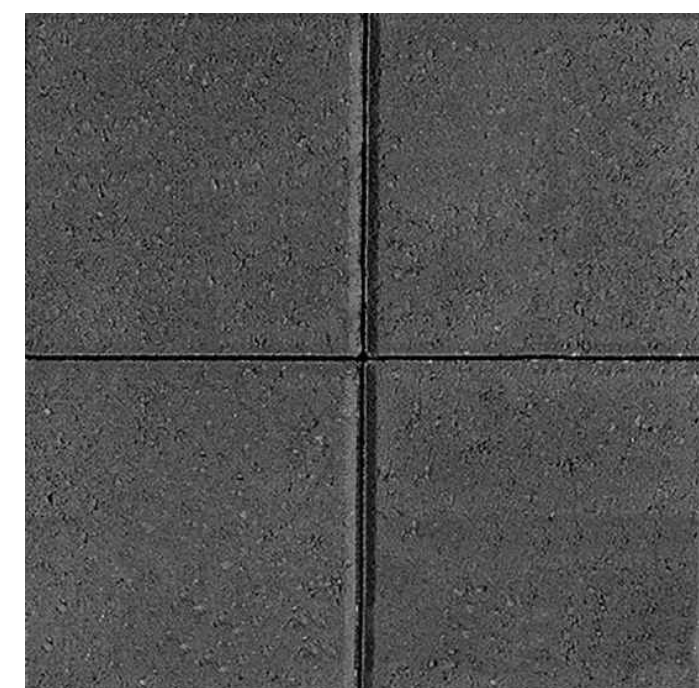
NTS



NOTE: OR CLIENT/COUNTY APPROVED EQUAL.

8 SYNTHETIC LAWN  
L-501 PICTORIAL

NTS



NOTE: OR CLIENT/COUNTY APPROVED EQUAL.

3 UNIT PAVERS - TYPE 2  
L-501 PICTORIAL

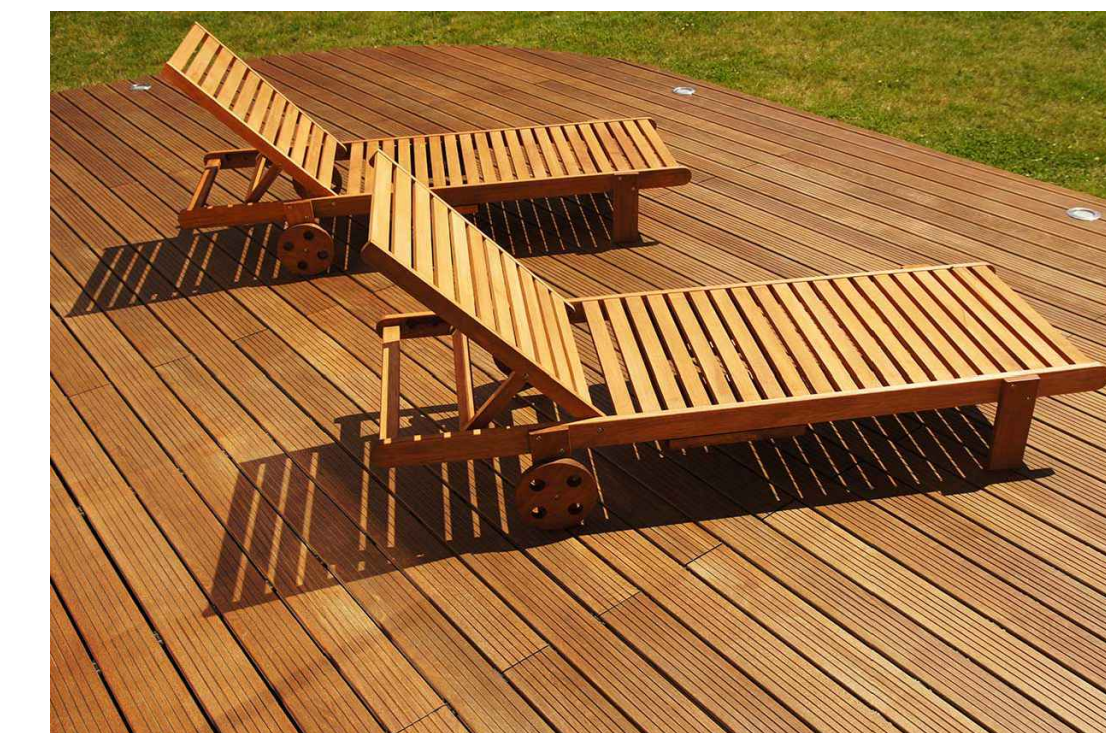
NTS



NOTE: OR CLIENT/COUNTY APPROVED EQUAL.

6 DECOMPOSED GRANITE  
L-501 PICTORIAL


NTS



NOTE: OR CLIENT/COUNTY APPROVED EQUAL.

9 DECK  
L-501 PICTORIAL

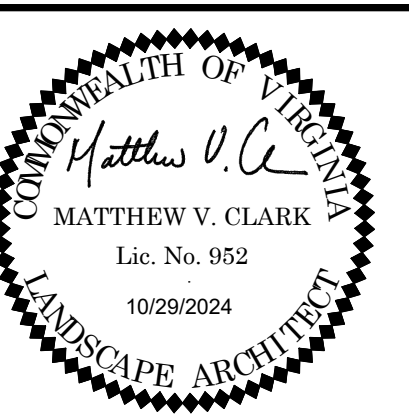NTS



3130 LANGSTON BOULEVARD

ROONEY PROPERTIES, LLC  
3130 LANGSTON BOULEVARD  
ARLINGTON, VA 22201

LANDDESIGN PROJ.# 2024074

REVISION / ISSUANCE

NO.	DESCRIPTION	DATE
1	4.1 SITE PLAN SUBMISSION	08/09/2024
2	4.1 SITE PLAN RESUBMISSION	10/29/2024

DESIGNED BY: XX  
DRAWN BY: XX  
CHECKED BY: XX

SCALE: NORTH (VCS 83)

VERT: N/A  
HORZ:

SHEET TITLE

DETAILS - HARDSCAPE

SHEET NUMBER

L-501






NOTE: OR CLIENT/COUNTY  
APPROVED EQUAL.

**1 DECK - ON STRUCTURE**

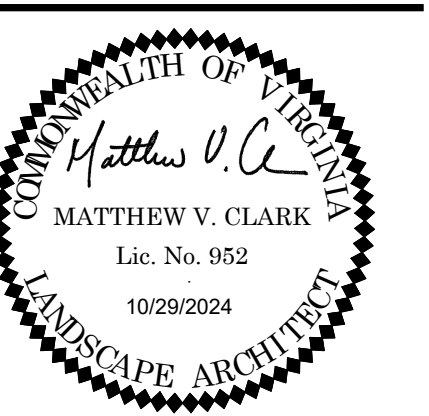L502 PICTORIAL

NTS



**3130 LANGSTON BOULEVARD**

ROONEY PROPERTIES, LLC  
3130 LANGSTON BOULEVARD  
ARLINGTON, VA 22201

LANDDESIGN PROJ.# 2024074

**REVISION / ISSUANCE**

NO.	DESCRIPTION	DATE
1	4.1 SITE PLAN SUBMISSION	08/09/2024
2	4.1 SITE PLAN RESUBMISSION	10/29/2024

DESIGNED BY: GC  
DRAWN BY: JM  
CHECKED BY: AC

SCALE: NORTH (VCB 83)

VERT: N/A  
HORZ:

**DETAILS - HARDSCAPE**

SHEET NUMBER

**L-502**

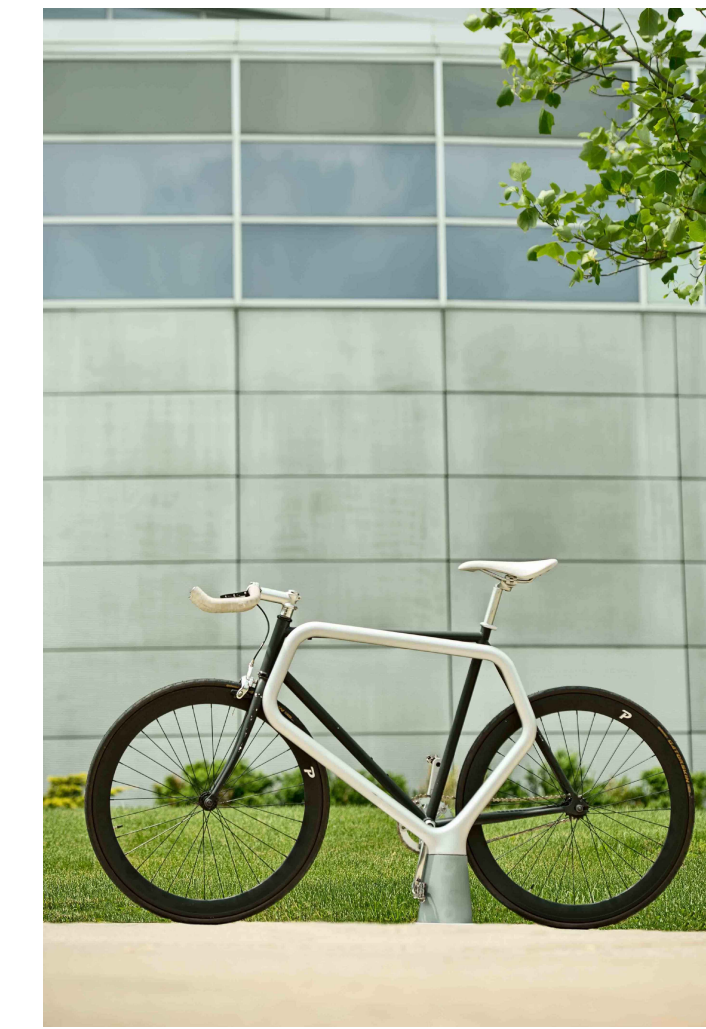




NOTE: OR CLIENT/COUNTY APPROVED EQUAL.



NOTE: OR CLIENT/COUNTY APPROVED EQUAL.  
COLOR: CHROME



NOTE: OR CLIENT/COUNTY APPROVED EQUAL.

1 BENCH - TYPE 1  
L-511 PICTORIAL

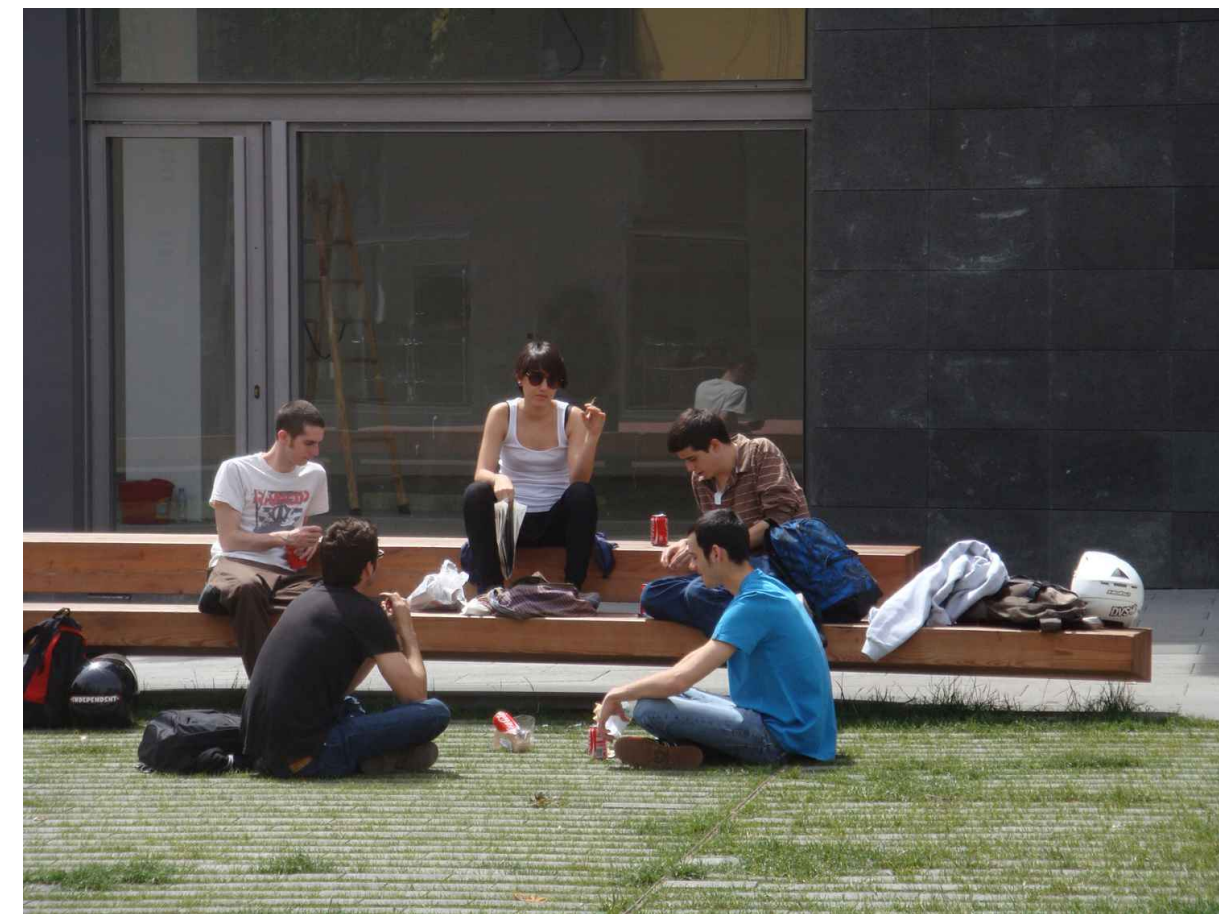
NTS

4 WATER FOUNTAIN WITH PET BOWL  
L-511 PICTORIAL

NTS

7 BIKE RACK  
L-511 PICTORIAL


NTS



NOTE: OR CLIENT/COUNTY APPROVED EQUAL.



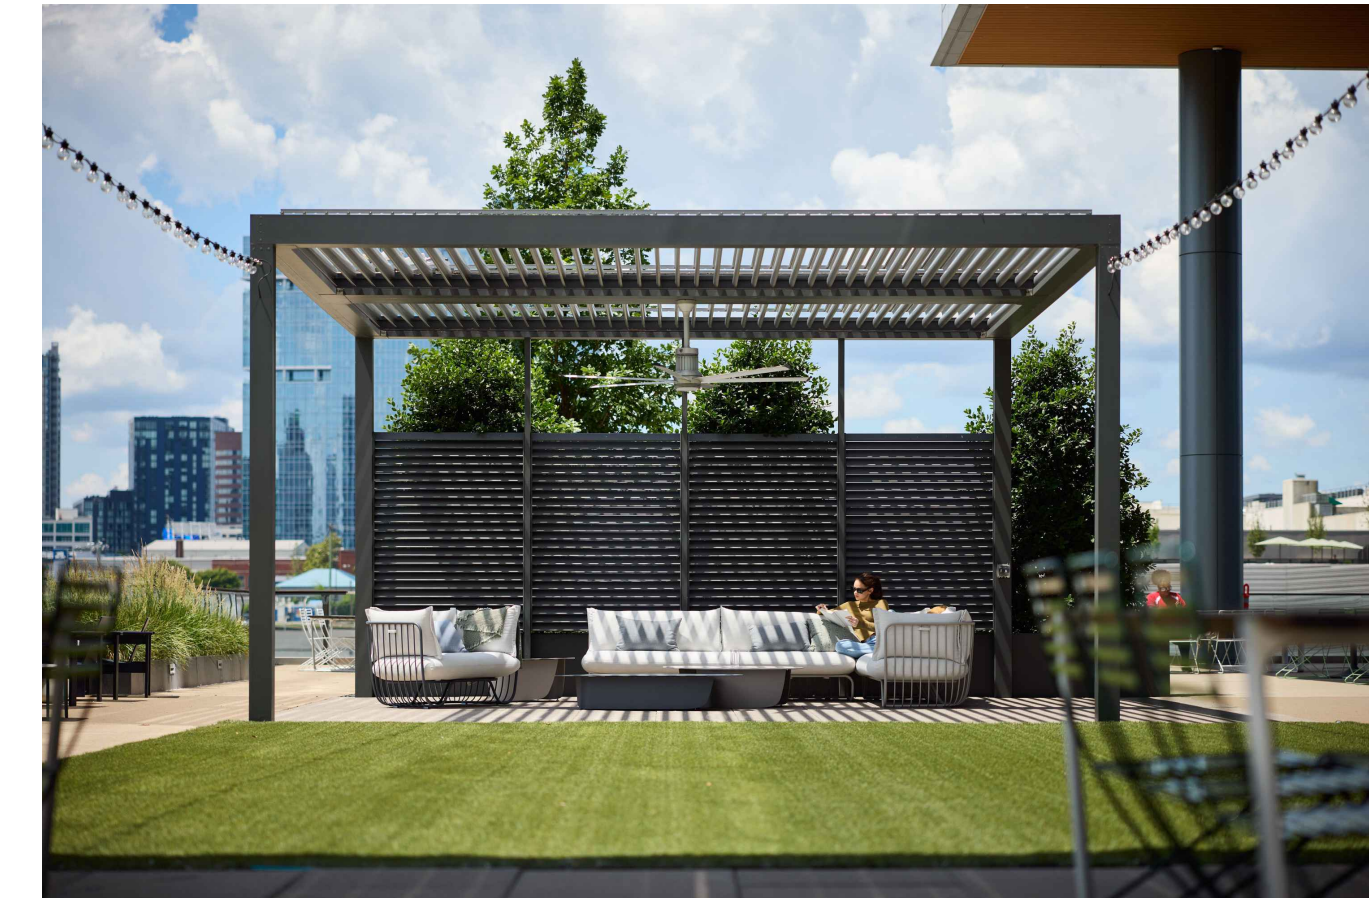NOTE: OR CLIENT/COUNTY APPROVED EQUAL.



NOTE: OR CLIENT/COUNTY APPROVED EQUAL.

2 BENCH - TYPE 2  
L-511 PICTORIAL

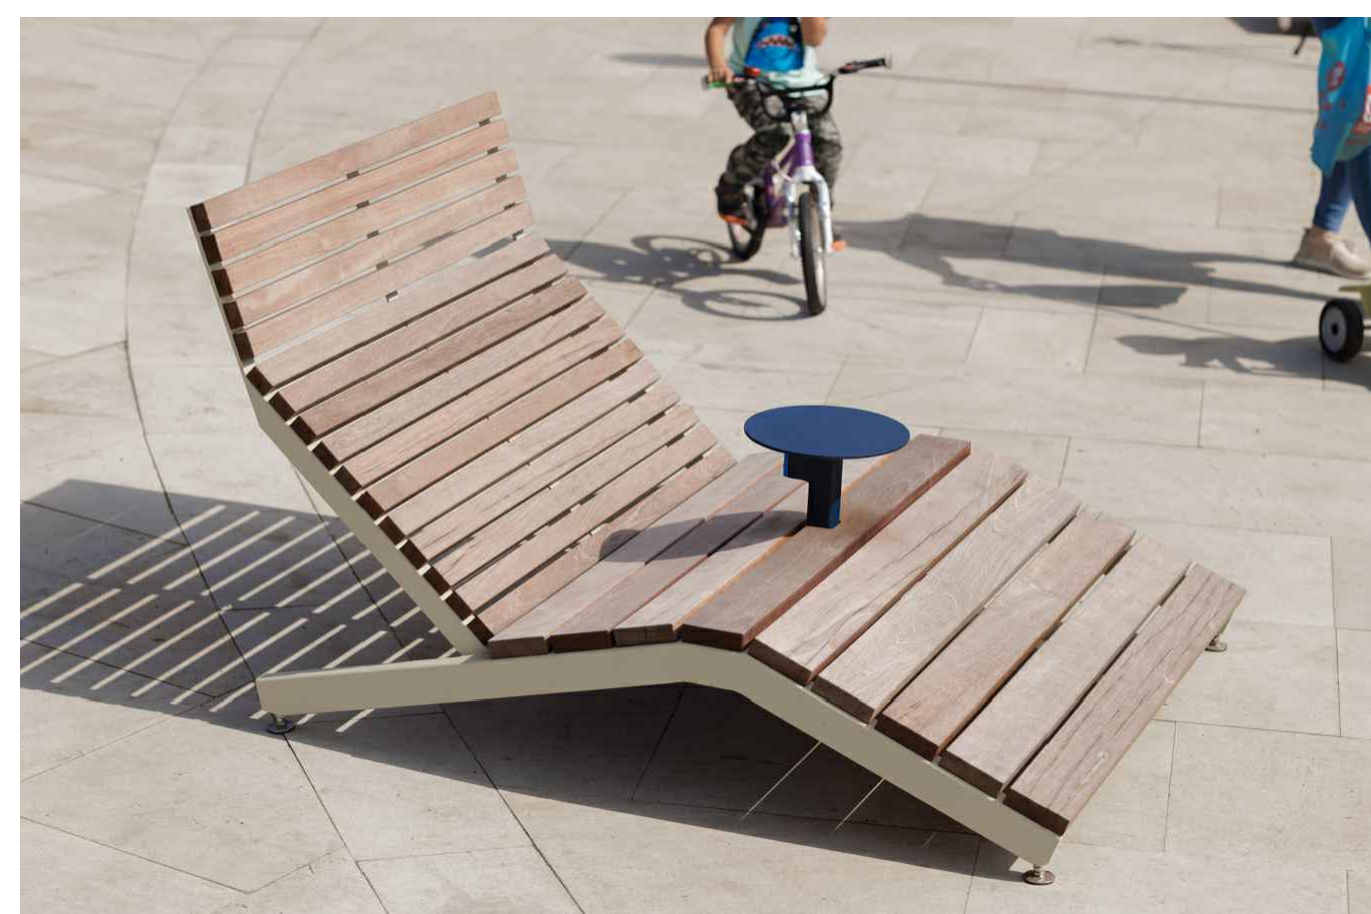
NTS

5 TRASH + RECYCLING  
L-511 PICTORIAL

NTS

8 SHADE STRUCTURE - TYPE 1  
L-511 PICTORIAL

NTS



NOTE: OR CLIENT/COUNTY APPROVED EQUAL.



NOTE: OR CLIENT/COUNTY APPROVED EQUAL.  
COLOR: TBD



NOTE: OR CLIENT/COUNTY APPROVED EQUAL.

3 LOUNGE CHAIR - TYPE 1  
L-511 PICTORIAL

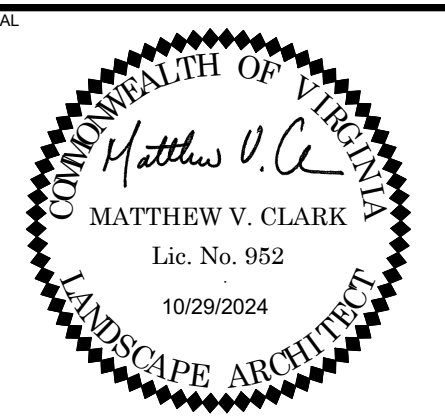
NTS

6 PET WASTE STATION  
L-511 PICTORIAL

NTS

9 SHADE STRUCTURE - TYPE 2  
L-511 PICTORIAL

NTS



PROJECT  
**3130 LANGSTON BOULEVARD**

ROONEY PROPERTIES, LLC  
3130 LANGSTON BOULEVARD  
ARLINGTON, VA 22201

LANDDESIGN PROJ.# 2024074

REVISION / ISSUANCE

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1	4.1 SITE PLAN SUBMISSION	08/09/2024
2	4.1 SITE PLAN RESUBMISSION	10/29/2024

DESIGNED BY: GC  
DRAWN BY: JM  
CHECKED BY: AC

SCALE: NORTH (VCS 83)

VERT: N/A  
HORZ: N/A

SHEET TITLE

DETAILS - FURNISHINGS

SHEET NUMBER

L-511





NOTE: OR CLIENT/COUNTY APPROVED EQUAL.



CHAIR PRECEDENT IMAGE



TABLE WITH UMBRELLA PRECEDENT IMAGE

NOTE: OR CLIENT/COUNTY APPROVED EQUAL. COLORS: TBD

**1** SHADE STRUCTURE - TYPE 3  
L-512 PICTORIAL

NTS

**4** DINING TABLE AND CHAIRS  
L-512 PICTORIAL

NTS



NOTE: OR CLIENT/COUNTY APPROVED EQUAL. COLORS: TBD



NOTE: OR CLIENT/COUNTY APPROVED EQUAL.

**2** FIRE ELEMENT  
L-512 PICTORIAL

NTS

**5** PLAY ELEMENT  
L-512 PICTORIAL

NTS



NOTE: OR CLIENT/COUNTY APPROVED EQUAL. COLORS: TBD



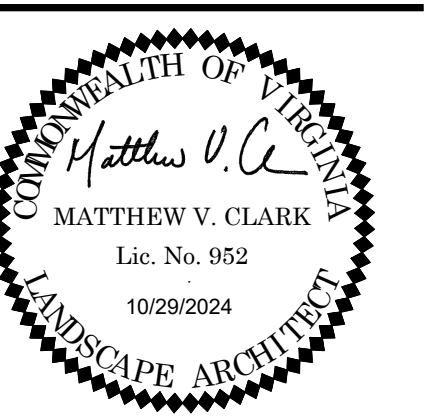
NOTE: OR CLIENT/COUNTY APPROVED EQUAL. COLOR: CHROME

**3** BISTRO TABLE + CHAIRS  
L-512 PICTORIAL

NTS

**6** BOTTLE FILLER & BIKE REPAIR STATION  
L-512 PICTORIAL

NTS



**3130 LANGSTON BOULEVARD**

ROONEY PROPERTIES, LLC  
3130 LANGSTON BOULEVARD  
ARLINGTON, VA 22201

LANDDESIGN PROJ.# 2024074

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NO.	DESCRIPTION	DATE
1	4.1 SITE PLAN SUBMISSION	08/09/2024
2	4.1 SITE PLAN RESUBMISSION	10/29/2024

DESIGNED BY: GC  
DRAWN BY: JM  
CHECKED BY: AC

SCALE: NORTH (VCS 83)

VERT: N/A  
HORZ: N/A

SHEET TITLE

DETAILS - FURNISHINGS

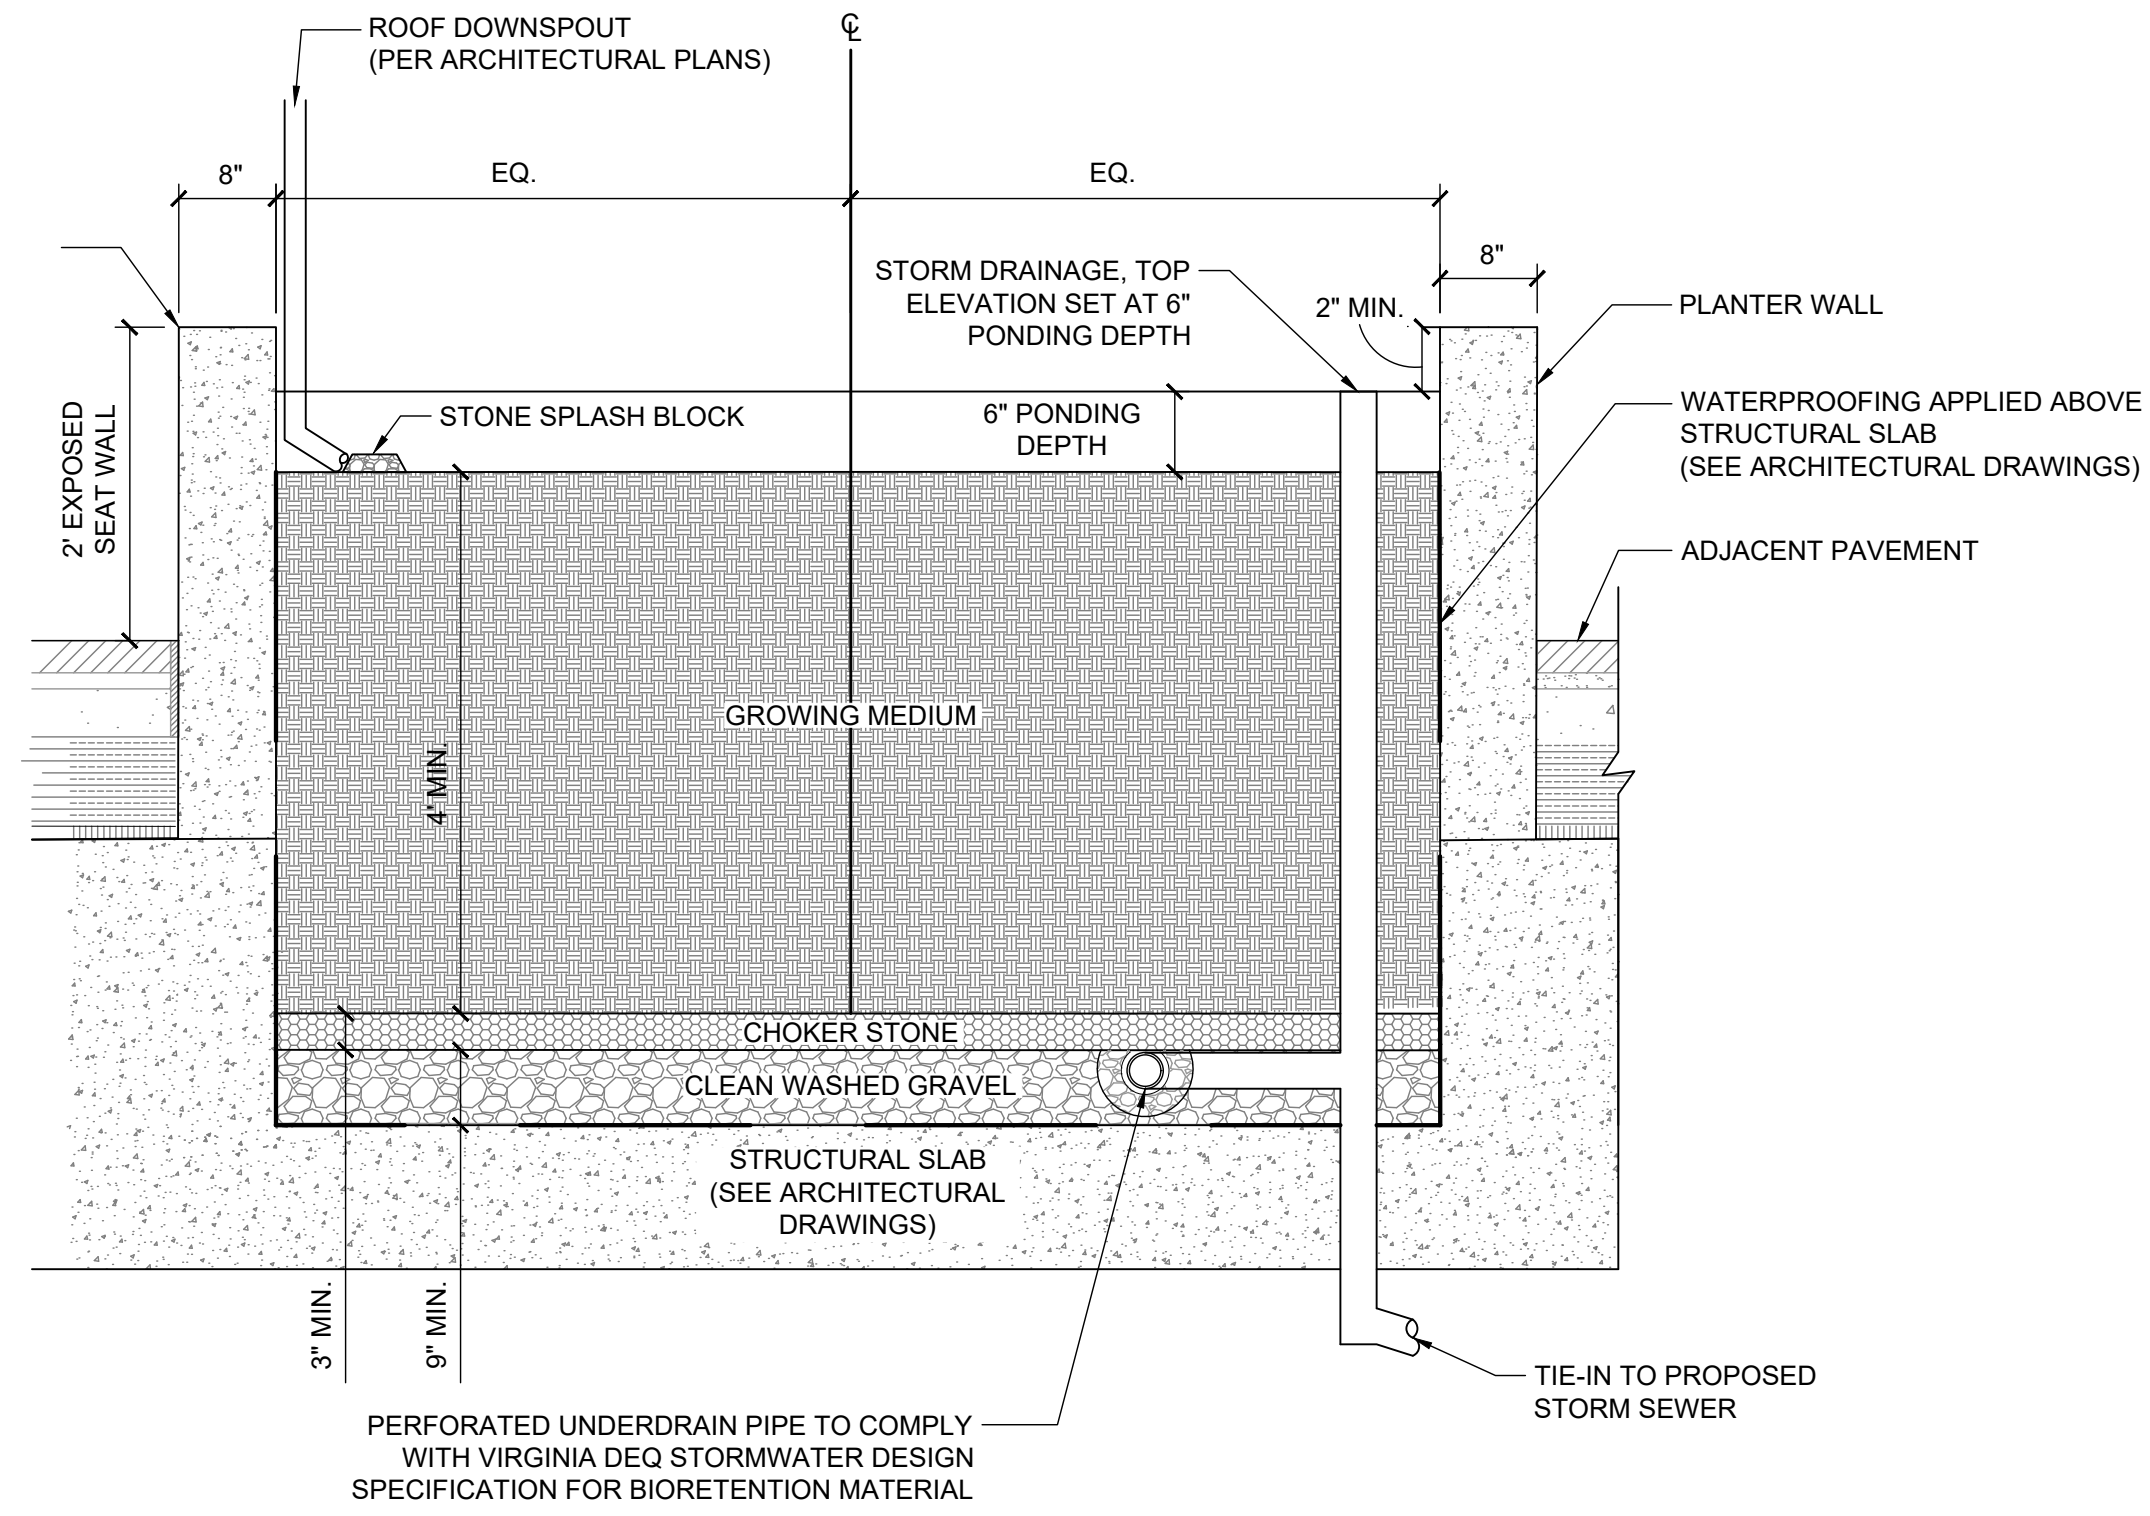
SHEET NUMBER

L-512











**1** BIORETENTION WALL  
SECTION

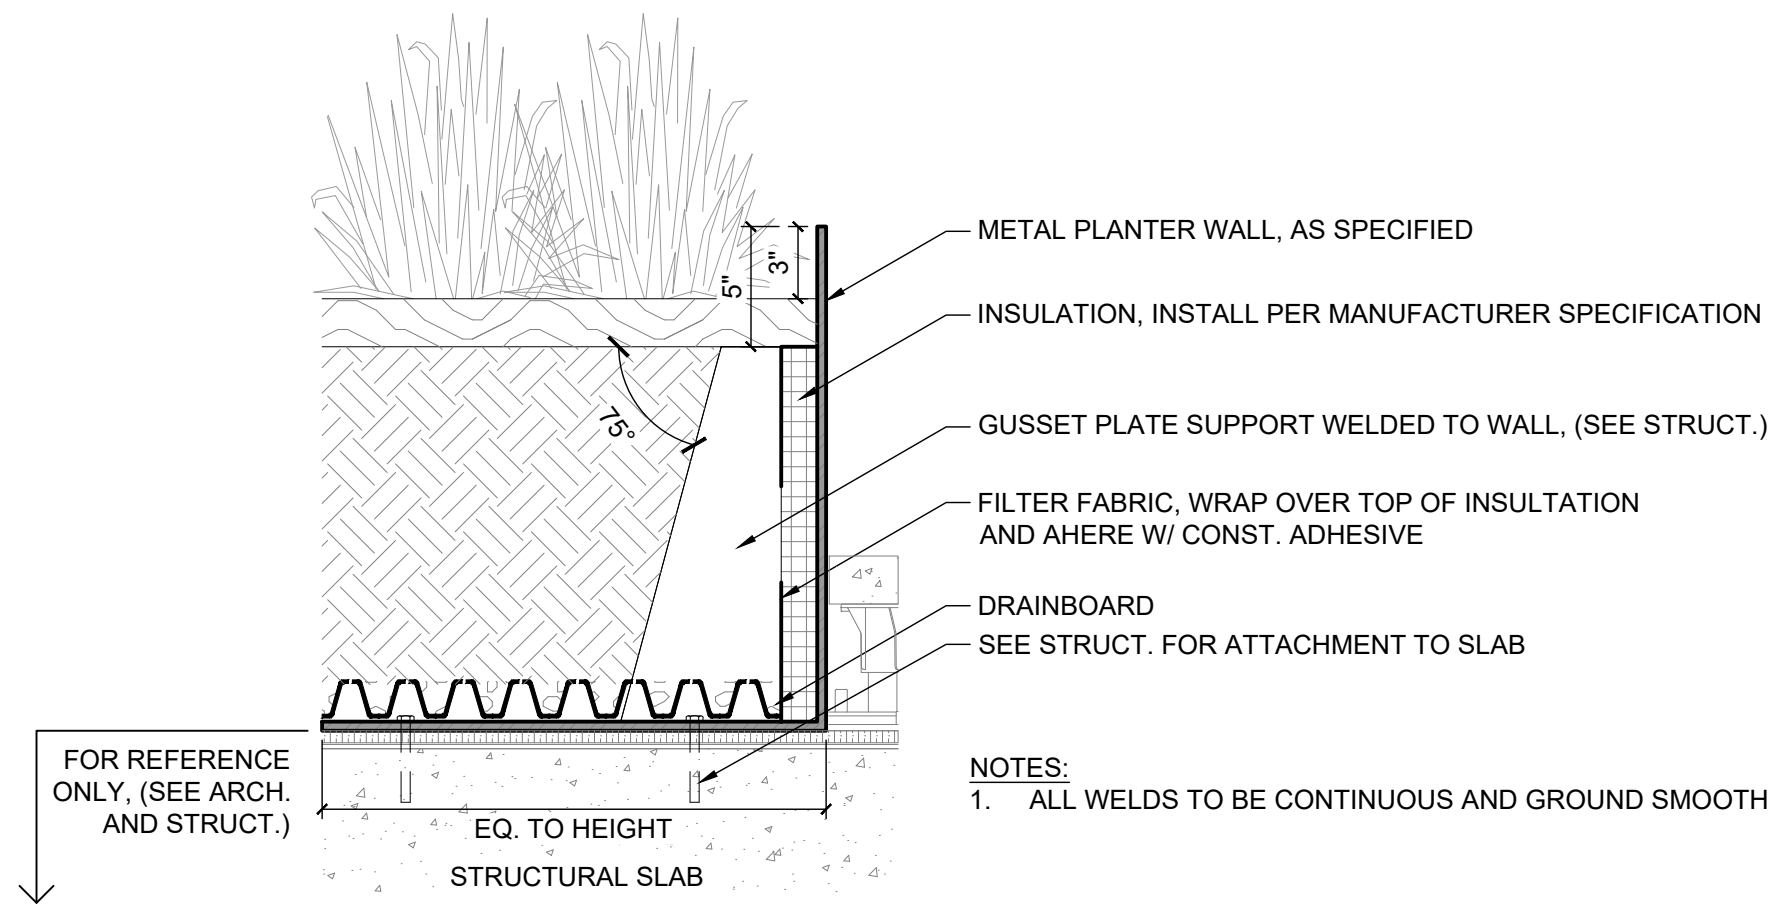1" = 1'



**2** METAL PLANTER WALL  
SECTION

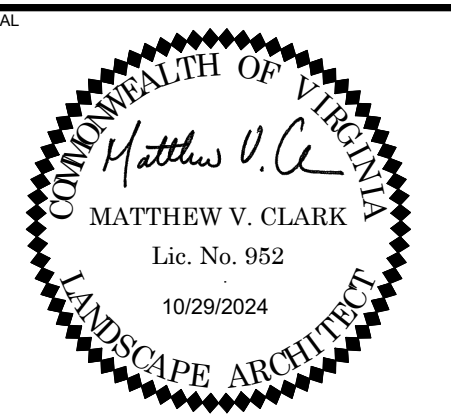1 1/2" = 1'-0"



**3130 LANGSTON BOULEVARD**

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1	4.1 SITE PLAN SUBMISSION	08/09/2024
2	4.1 SITE PLAN RESUBMISSION	10/29/2024

DESIGNED BY: GC  
DRAWN BY: JM  
CHECKED BY: AC

SCALE: NORTH (VCS 83)

VERT: N/A  
HORZ: AS NOTED

SHEET TITLE

DETAILS - WALLS

SHEET NUMBER

L-531

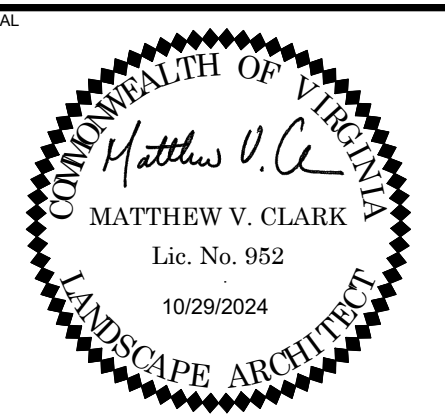




NOTE: OR CLIENT/COUNTY  
APPROVED EQUAL.

**1 GRILL STATION**  
L-541 PICTORIAL

NTS



**3130 LANGSTON BOULEVARD**

ROONEY PROPERTIES, LLC  
3130 LANGSTON BOULEVARD  
ARLINGTON, VA 22201

LANDDESIGN PROJ.# 2024074

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1	4.1 SITE PLAN SUBMISSION	08/09/2024
2	4.1 SITE PLAN RESUBMISSION	10/29/2024

DESIGNED BY: GC  
DRAWN BY: JM  
CHECKED BY: AC

SCALE: NORTH (VCB 83)

VERT: N/A  
HORZ:

SHEET TITLE

DETAILS - CUSTOM

SHEET NUMBER

L-541





NOTE: OR CLIENT/COUNTY APPROVED EQUAL.



NOTE: OR CLIENT/COUNTY APPROVED EQUAL.

**1** FENCE - TYPE 1  
L-551 PICTORIAL

NTS

**4** GATE - TYPE 2  
L-551 PICTORIAL

NTS



NOTE: OR CLIENT/COUNTY APPROVED EQUAL.

**2** FENCE - TYPE 2  
L-551 PICTORIAL

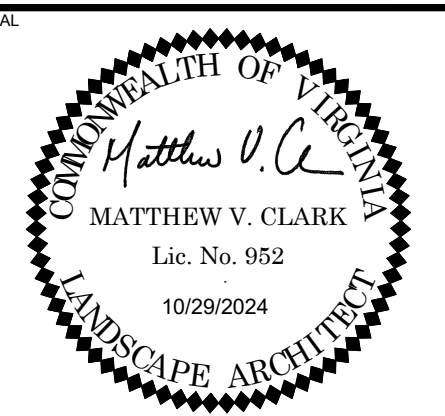
NTS



NOTE: OR CLIENT/COUNTY APPROVED EQUAL.

**3** GATE - TYPE 1  
L-551 PICTORIAL

NTS



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DESIGNED BY: GC  
DRAWN BY: JM  
CHECKED BY: AC

SCALE: NORTH (VCS 83)

VERT: N/A  
HORZ:

SHEET TITLE

DETAILS - FENCES


SHEET NUMBER

**L-551**



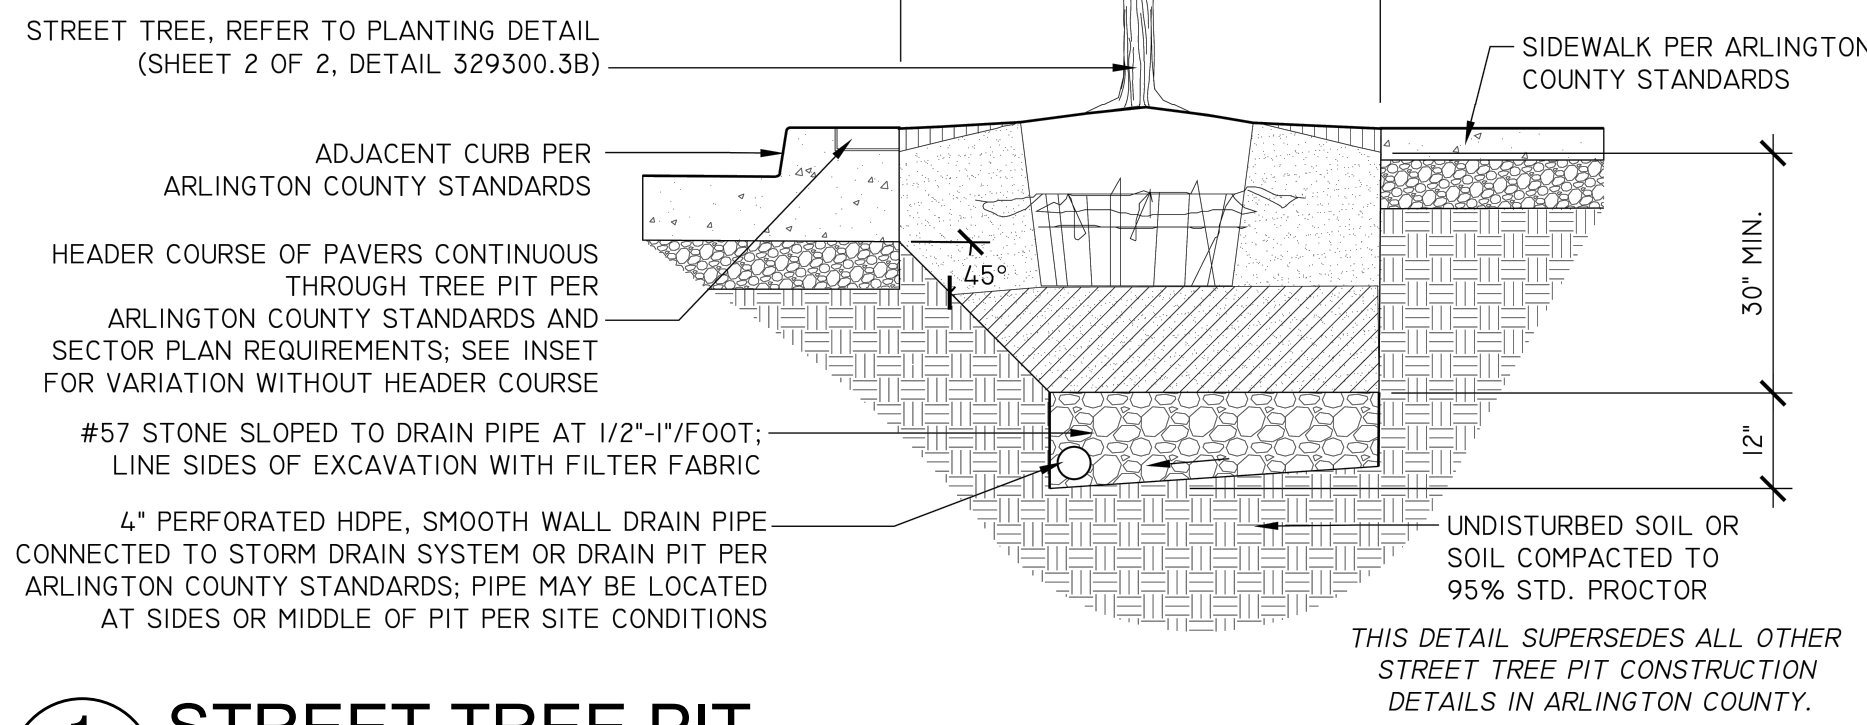NOTES

1. TREE GRATES MAY ONLY BE USED UPON APPROVAL OF ARLINGTON COUNTY URBAN FORESTER.
2. REFER TO DETAIL 329300.5 FOR GENERAL STREET TREE PLANTING NOTES.
3. INSTALL RAILING, RAISED CURB, OR BORDER PER APPROVED PLANS.



1 STREET TREE PIT

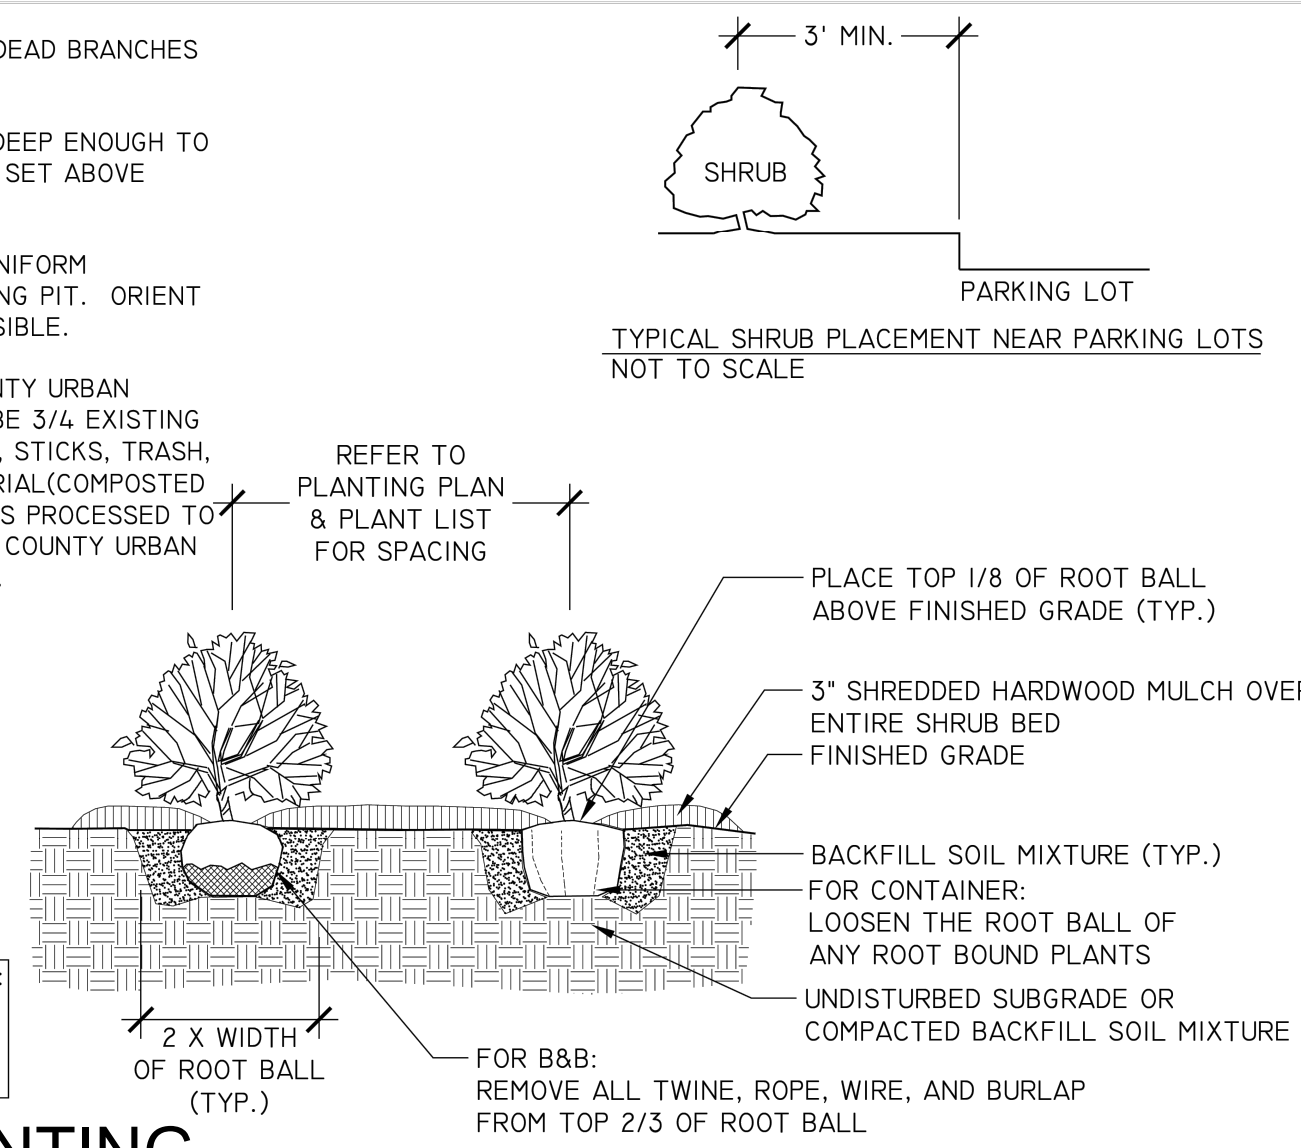
L-601 SECTION 1/2" = 1'-0"

NOTES

1. AT PLANTING PRUNE ONLY BROKEN OR DEAD BRANCHES PER ANSI 300 STANDARD.
2. PLANTING PIT/TRENCH SHALL BE DUG DEEP ENOUGH TO ALLOW AT LEAST 1/8TH OF ROOT BALL TO SET ABOVE EXISTING GRADE.
3. SET PLANTS IN ERECT, STABLE, AND UNIFORM POSITIONS IN THE CENTER OF THE PLANTING PIT. ORIENT BEST FACE OF PLANT TO BE THE MOST VISIBLE.
4. UNLESS OTHERWISE DIRECTED BY COUNTY URBAN FORESTER, BACKFILL SOIL MIXTURE WILL BE 3/4 EXISTING SOIL CLEANED OF DEBRIS (GRAVEL, ROCKS, STICKS, TRASH, ETC.) AND MIXED WITH 1/4 ORGANIC MATERIAL (COMPOSTED BARK, LEAF MOLD, OR OTHER PLANT DEBRIS PROCESSED TO A POINT OF DECAY AND APPROVED BY THE COUNTY URBAN FORESTER. PEAT MOSS MAY NOT BE USED).
5. CONTRACTOR SHALL REMOVE EXCESS SOIL & DEBRIS FROM SITE.
6. DO NOT PLACE MULCH IN CONTACT WITH STEM OF SHRUBS.

THIS DETAIL SUPERSEDES ALL OTHER SHRUB PLANTING DETAILS IN ARLINGTON COUNTY.

ALL PLANTS MUST BE WATERED TWICE: ONCE AT INSTALLATION AND AGAIN WITHIN 48-HOURS OF INSTALLATION, PER THE SPECIFICATIONS.




4 SHRUB PLANTING

L-601 SECTION NTS 1/2" = 1'-0"

NOTES

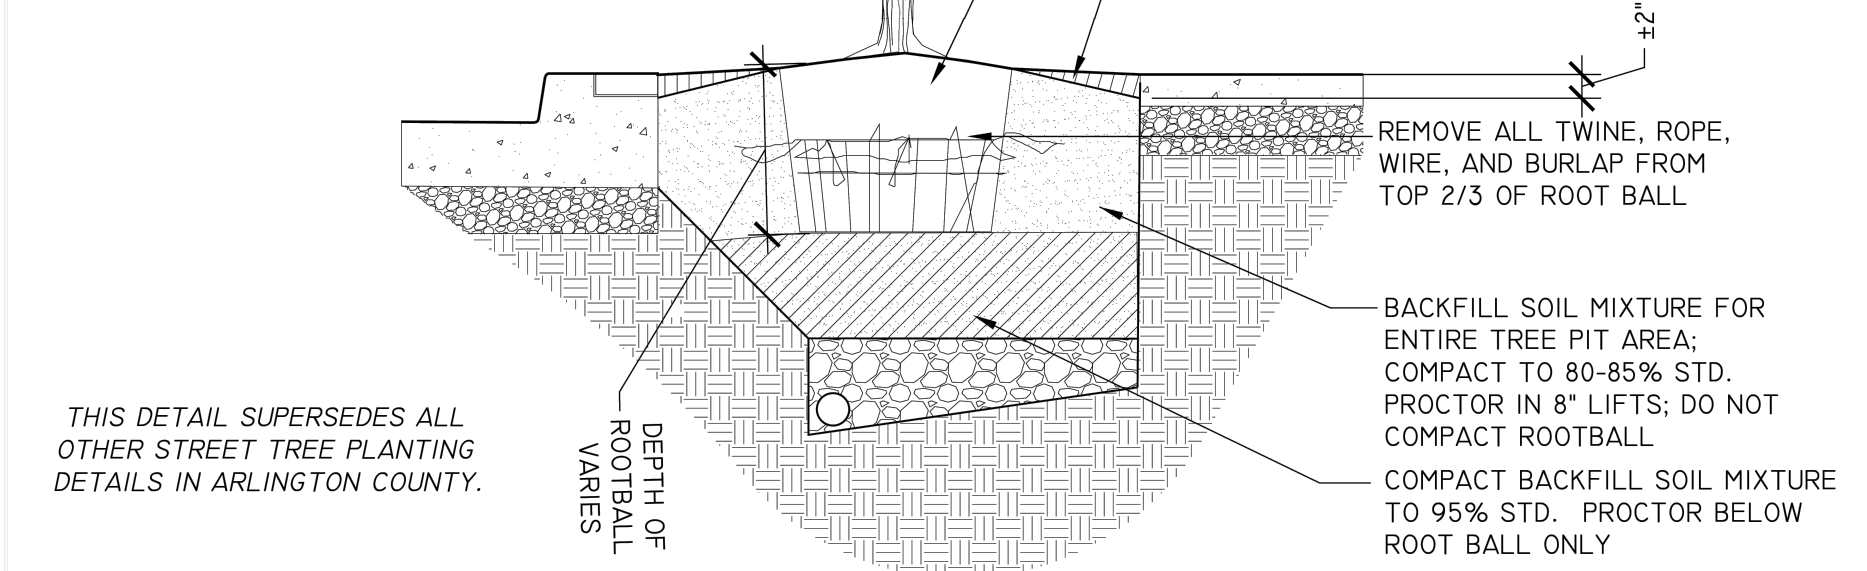1. REFER TO STREET TREE PIT DETAIL (329300.3A) FOR PIT CONSTRUCTION AND INFORMATION ON ADJACENT PAVEMENTS, CURB, AND DRAINAGE.
2. REFER TO DETAIL 329300.5 FOR GENERAL TREE PLANTING NOTES.
3. MOUND SOIL ABOVE SIDEWALK GRADE TO ALLOW FOR SOIL TO SETTLE OVER TIME.




2 TREE PLANTING

L-601 SECTION 1/2" = 1'-0"


PLANT SPACING CHART

SPACING "D"	ROW "A"	PLANTS / S.F.
6" O.C.	5.20" O.C.	4.61
8" O.C.	6.93" O.C.	2.60
10" O.C.	8.66" O.C.	1.66
12" O.C.	10.40" O.C.	1.15
15" O.C.	13.00" O.C.	0.73
18" O.C.	15.60" O.C.	0.51
24" O.C.	20.80" O.C.	0.29

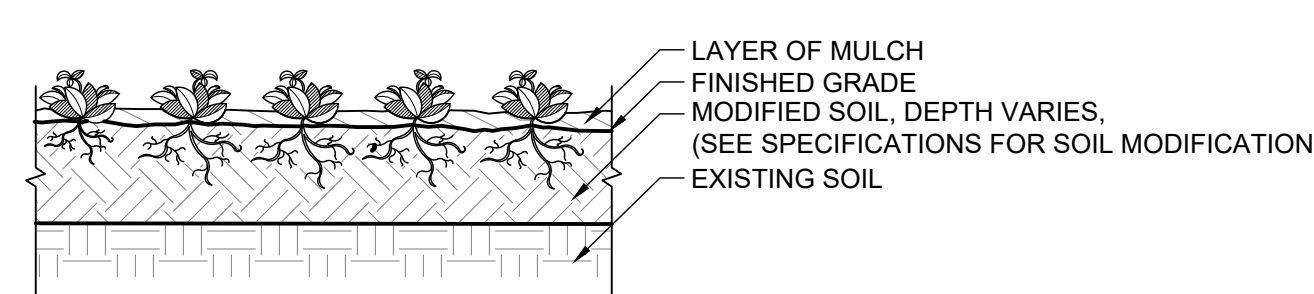


5 GROUNDCOVER SPACING - TRIANGULAR

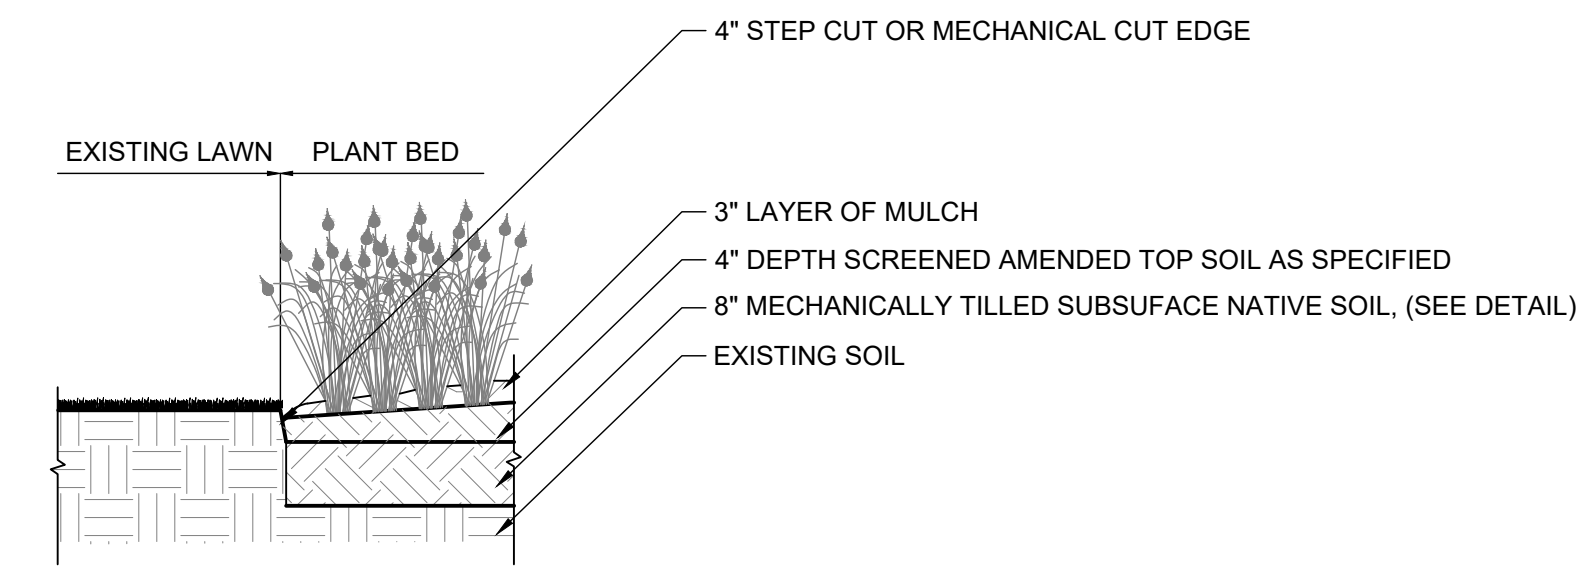L-601 SECTION 1/2" = 1'-0"



7 STEEL CUT EDGE

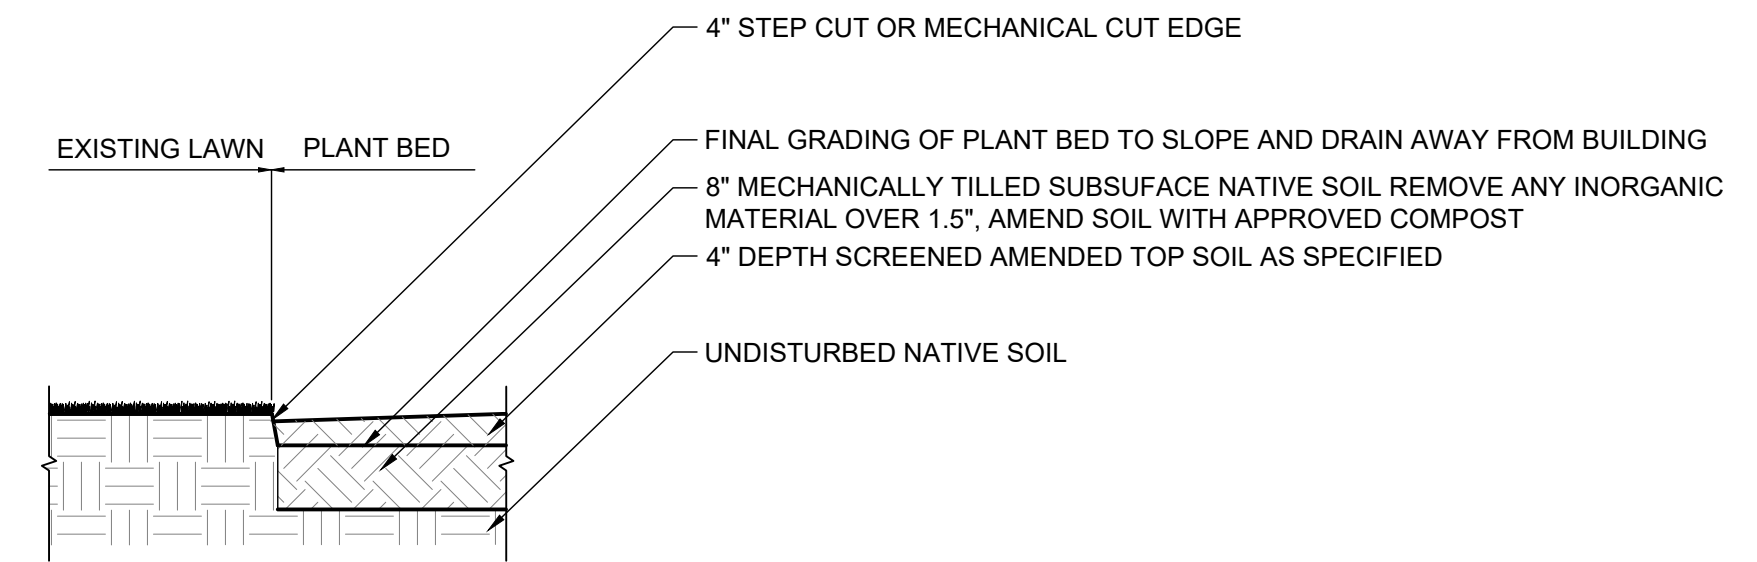L-601 SECTION 1/2" = 1'-0"



8 BED PREP

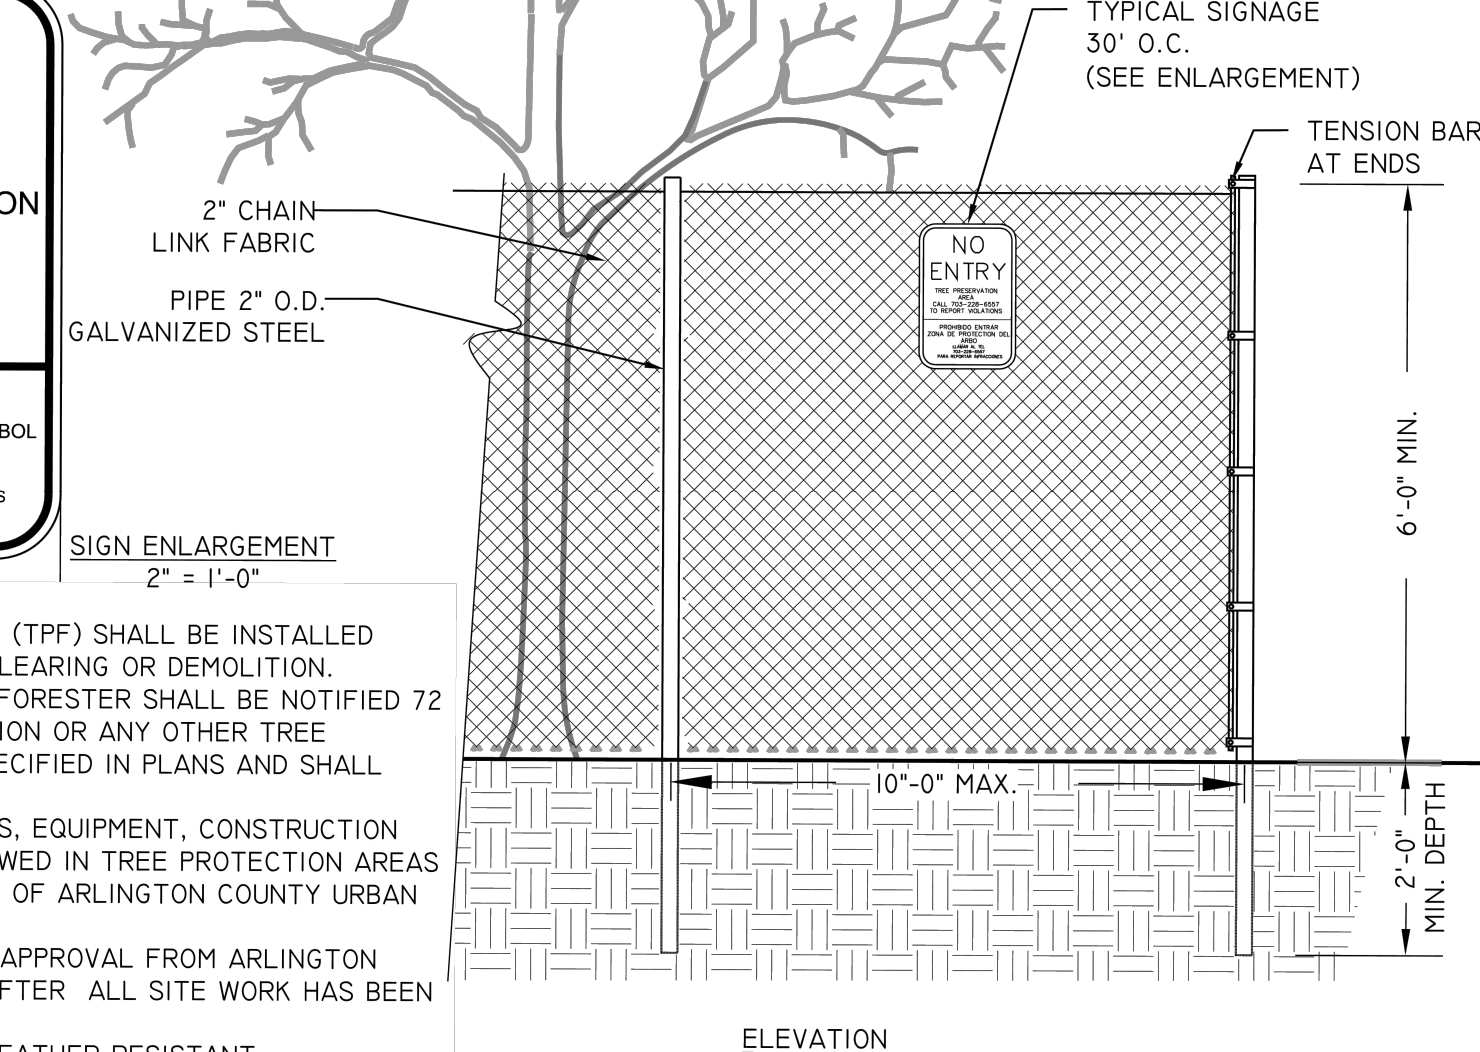
L-601 SECTION 1/2" = 1'-0"

NO ENTRY

TREE PRESERVATION AREA  
CALL: 703-228-6557  
TO REPORT VIOLATIONS


PROHIBIDO ENTRAR  
ZONA DE PROTECCION DEL ARBOL  
LLAMAR AL TEL. 703-228-6557  
PARA REPORTAR INFRACCIONES

- NOTES:
1. TREE PROTECTION FENCE (TPF) SHALL BE INSTALLED PRIOR TO ANY SITE WORK, CLEARING OR DEMOLITION. ARLINGTON COUNTY URBAN FORESTER SHALL BE NOTIFIED 72 HOURS PRIOR TO INSTALLATION OR ANY OTHER TREE PRESERVATION MEASURE SPECIFIED IN PLANS AND SHALL APPROVE LAYOUT.
  2. NO PERSONNEL, VEHICLES, EQUIPMENT, CONSTRUCTION MATERIALS OR DEBRIS ALLOWED IN TREE PROTECTION AREAS WITHOUT WRITTEN CONSENT OF ARLINGTON COUNTY URBAN FORESTER.
  3. REMOVE TPF ONLY WITH APPROVAL FROM ARLINGTON COUNTY URBAN FORESTER AFTER ALL SITE WORK HAS BEEN COMPLETED.
  4. SIGN MATERIAL TO BE WEATHER RESISTANT.




3 PROTECTION FENCE

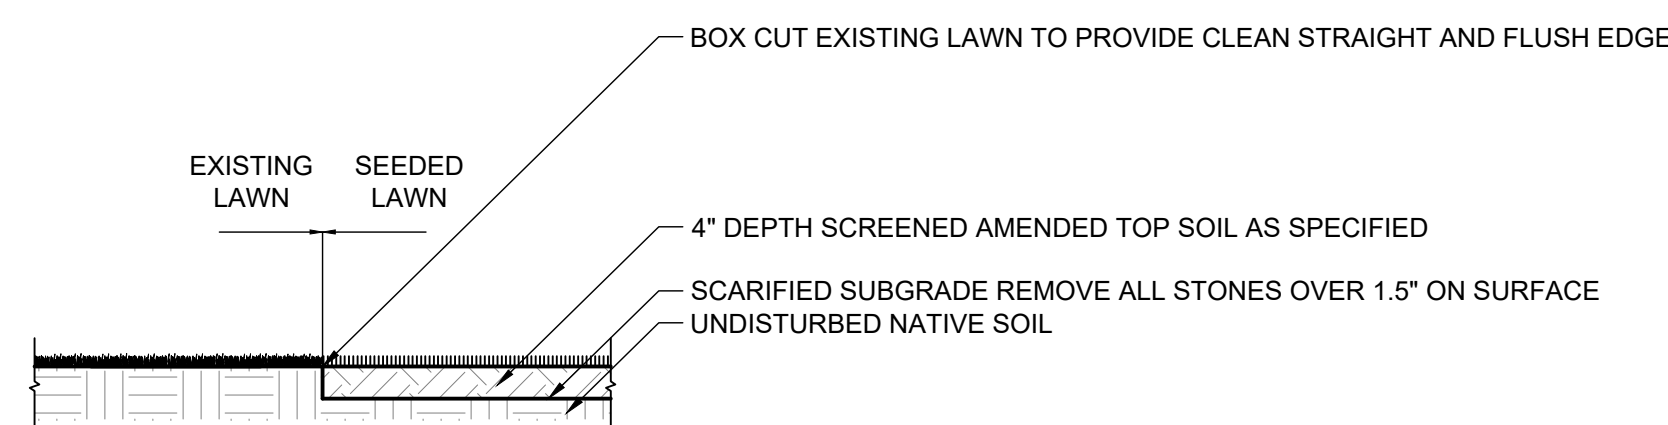L-601 SECTION 1/2" = 1'-0"



6 SEEDED LAWN

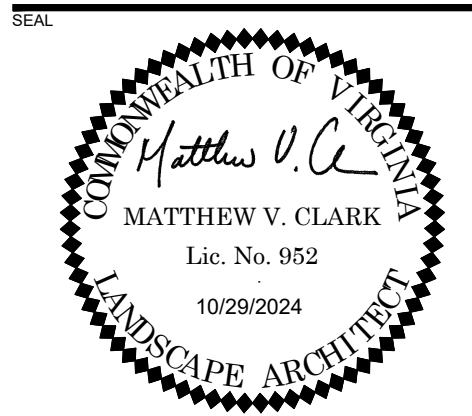L-601 SECTION 1/2" = 1'-0"



3130 LANGSTON BOULEVARD

ROONEY PROPERTIES, LLC  
3130 LANGSTON BOULEVARD  
ARLINGTON, VA 22201

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REVISION / ISSUANCE

NO.	DESCRIPTION	DATE
1	4.1 SITE PLAN SUBMISSION	08/09/2024
2	4.1 SITE PLAN RESUBMISSION	10/29/2024

DESIGNED BY: XX  
DRAWN BY: XX  
CHECKED BY: XX

SCALE: NORTH (VCS-03)

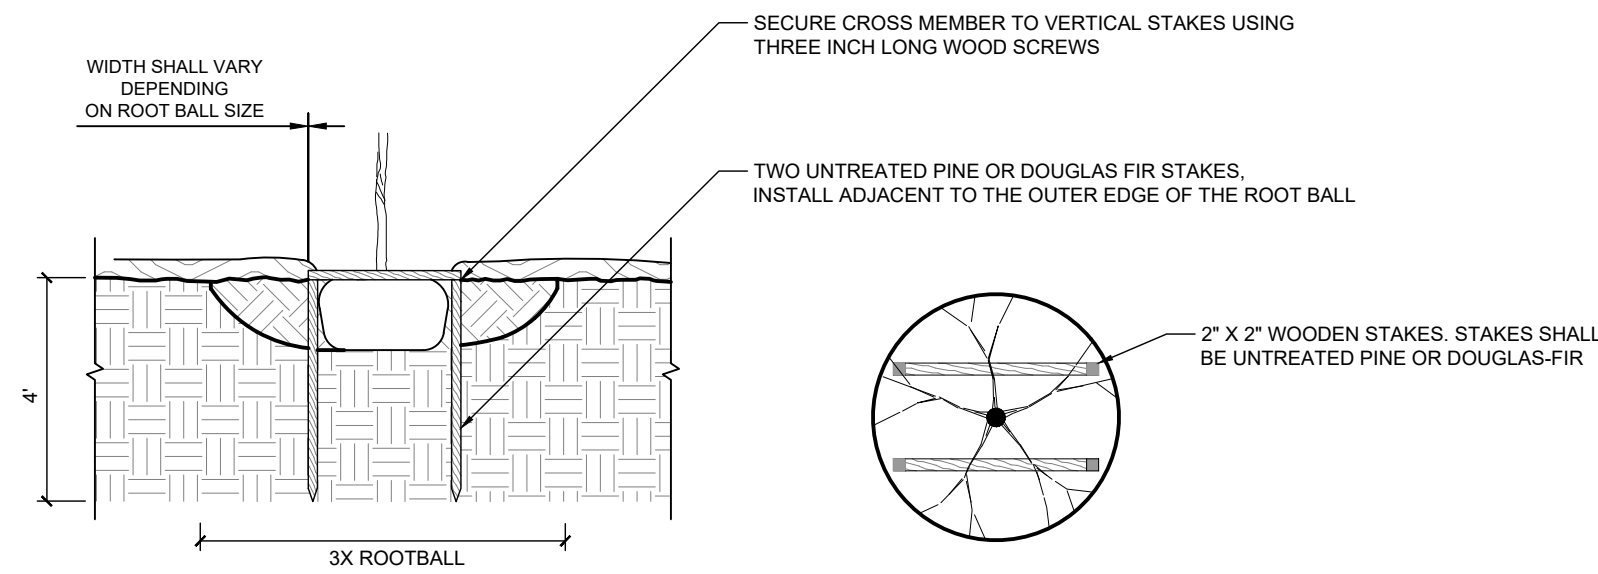
VERT: N/A  
HORZ:

SHEET TITLE  
DETAILS - PLANTING ON GRADE


SHEET NUMBER

L-601






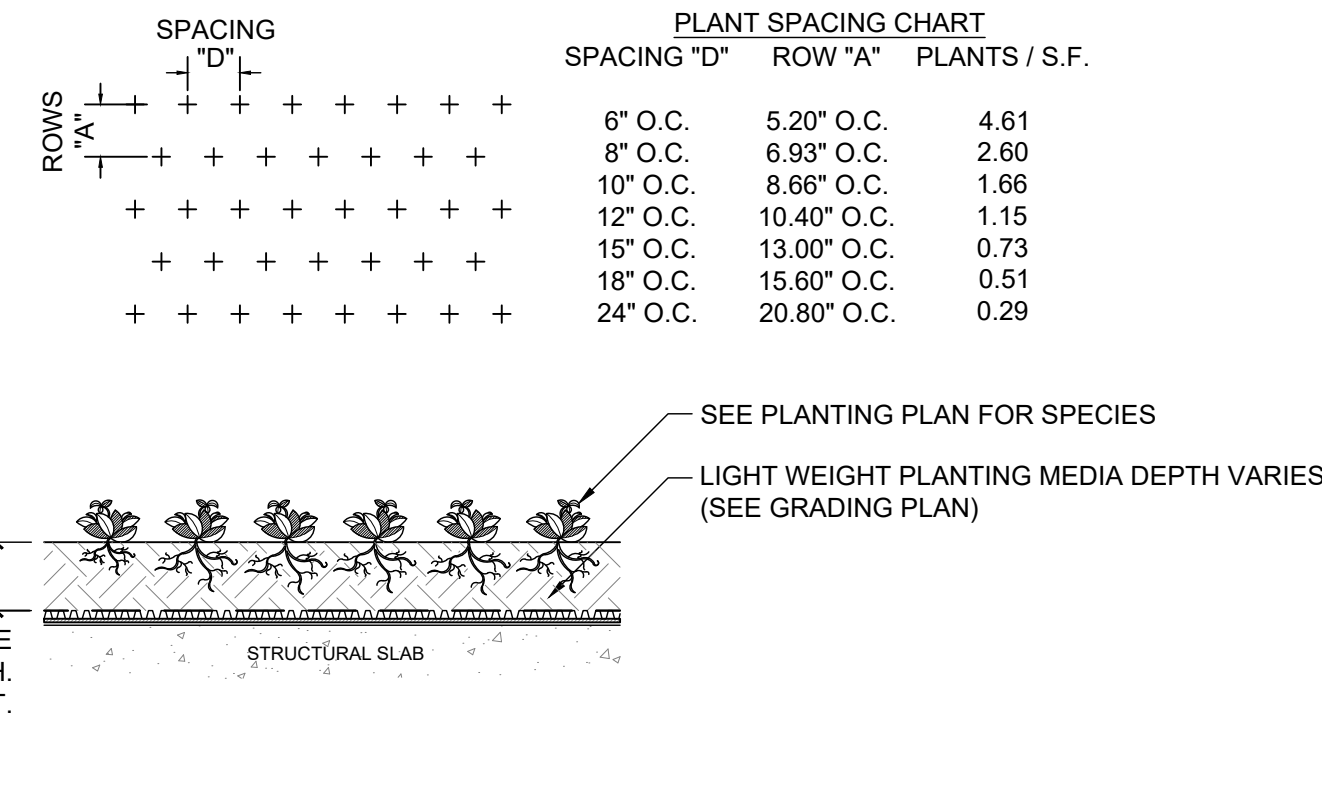
**1 STAKING BELOW GROUND**  
L-602 SECTION 3/8" = 1'-0"



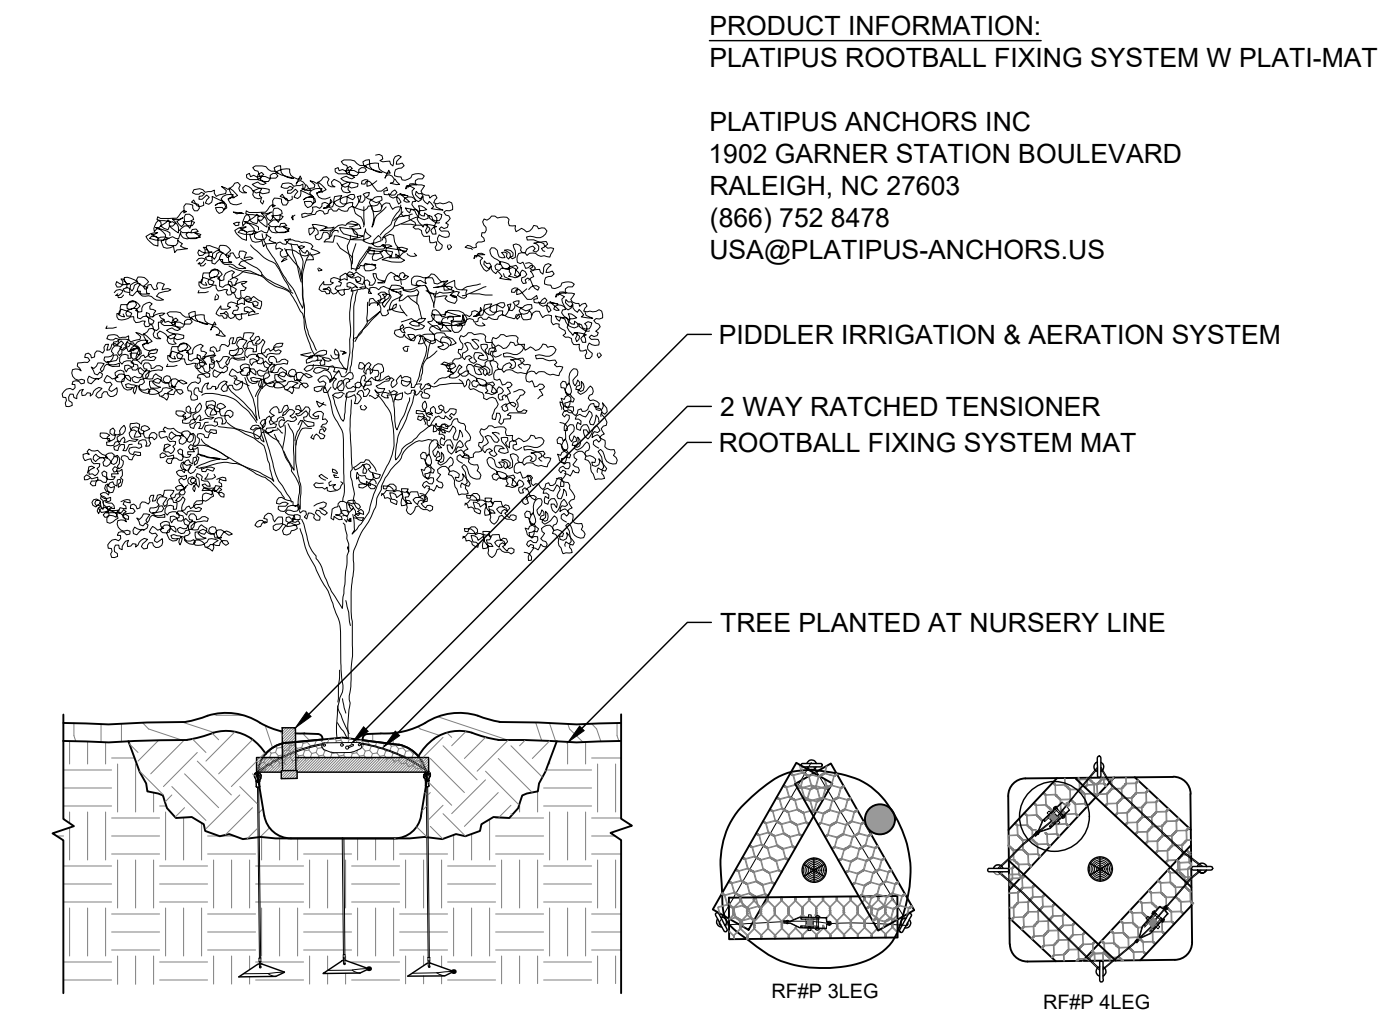
**4 GROUNDCOVER ON STRUCTURE**  
L-602 SECTION 1/2" = 1'-0"



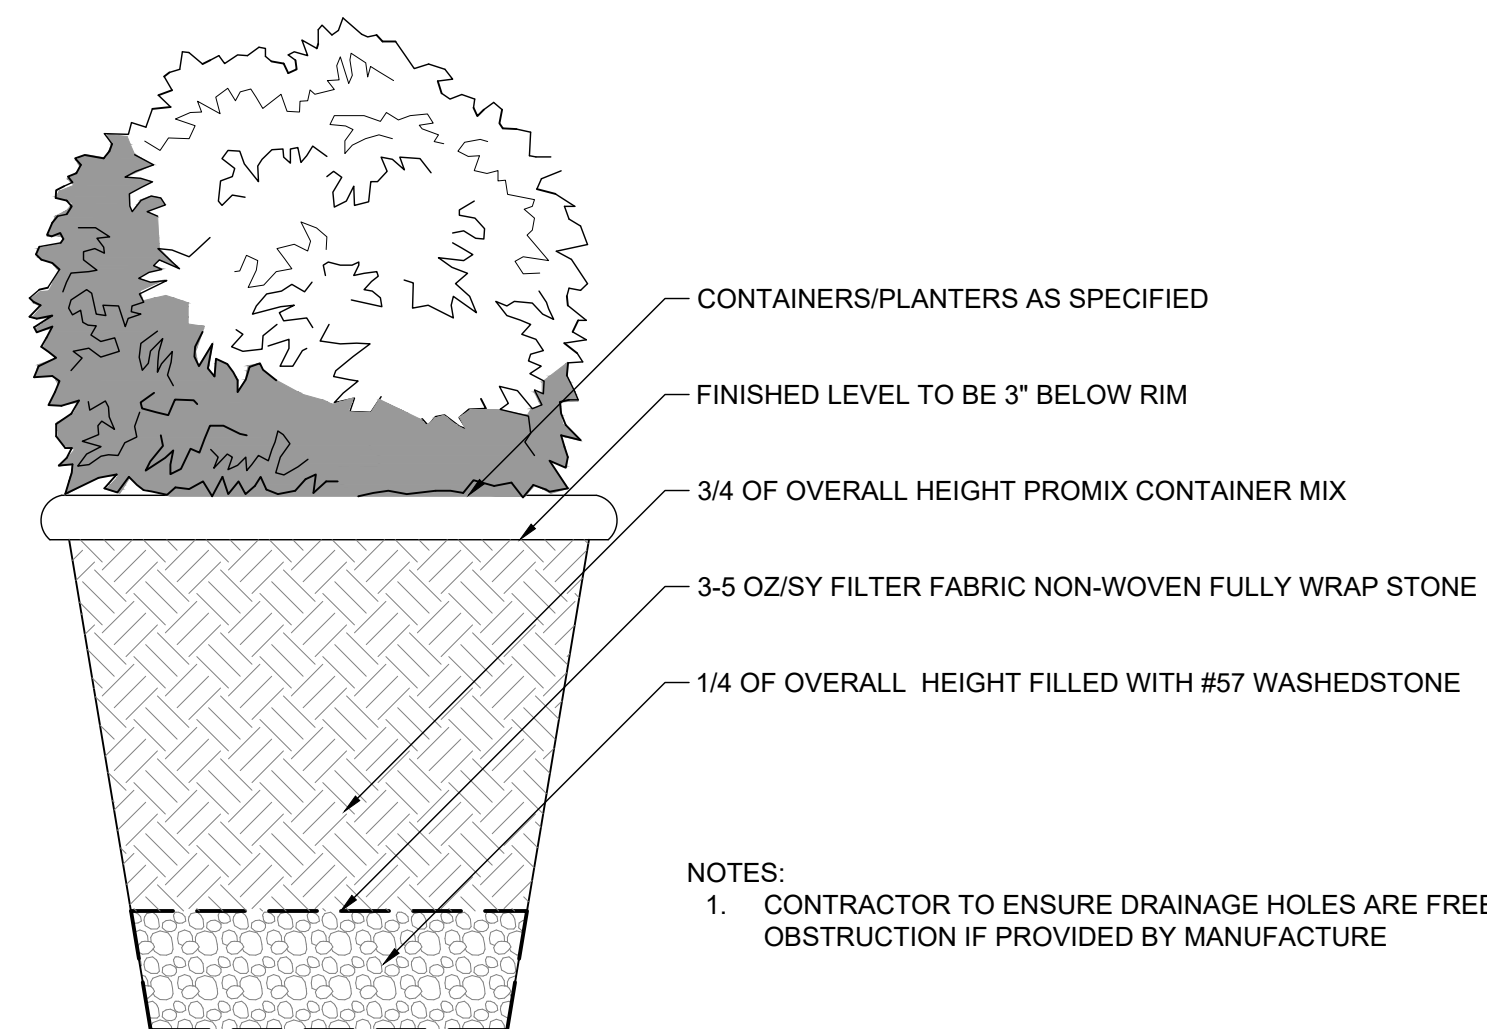
**7 ROOTBALL FIXING SYSTEM W/MAT**  
L-602 SECTION 3/8" = 1'-0"



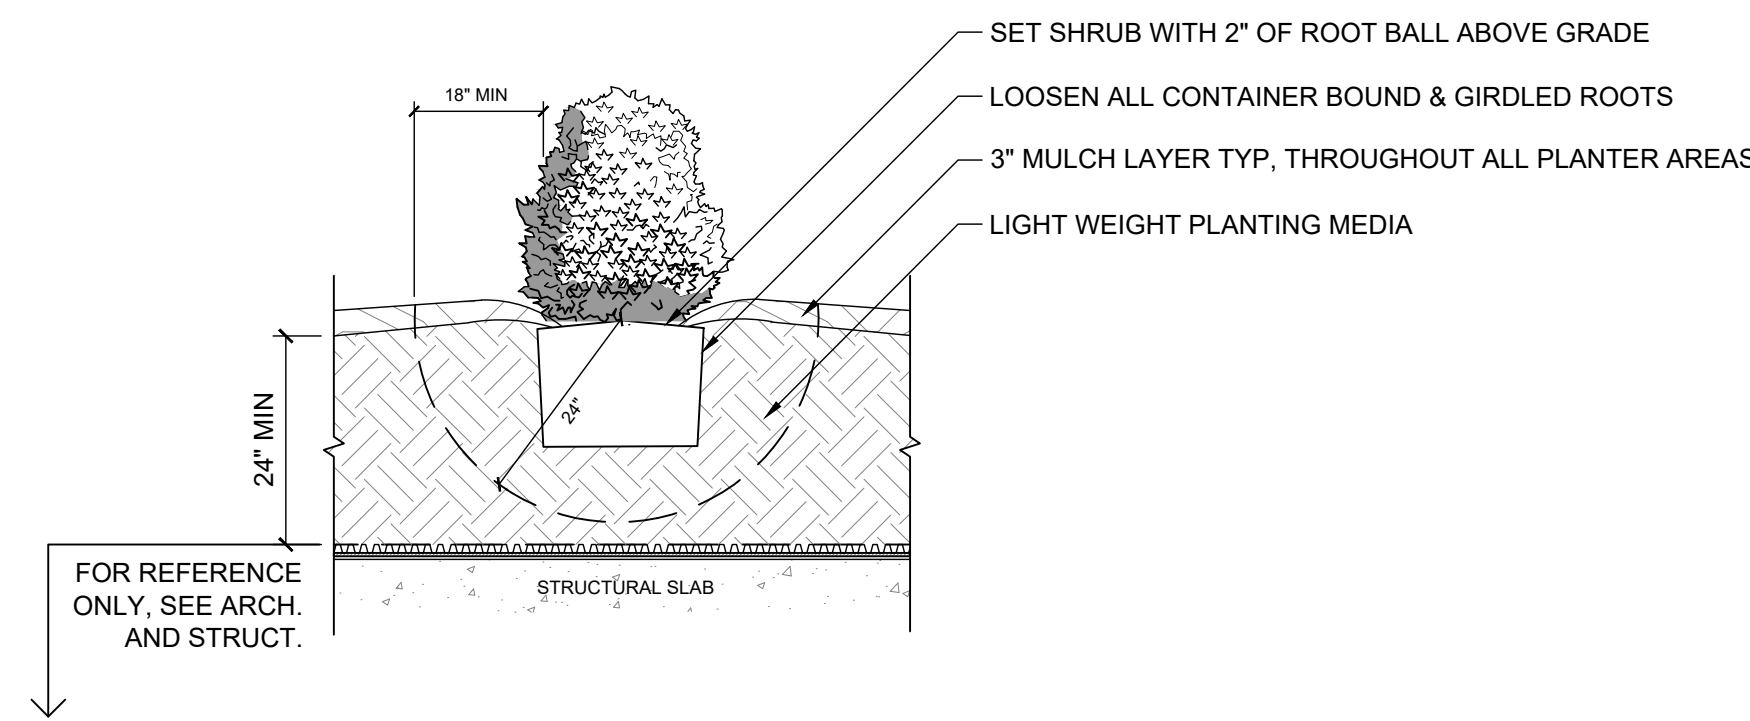
**2 PLANTING IN POT**  
L-602 SECTION 1" = 1'-0"



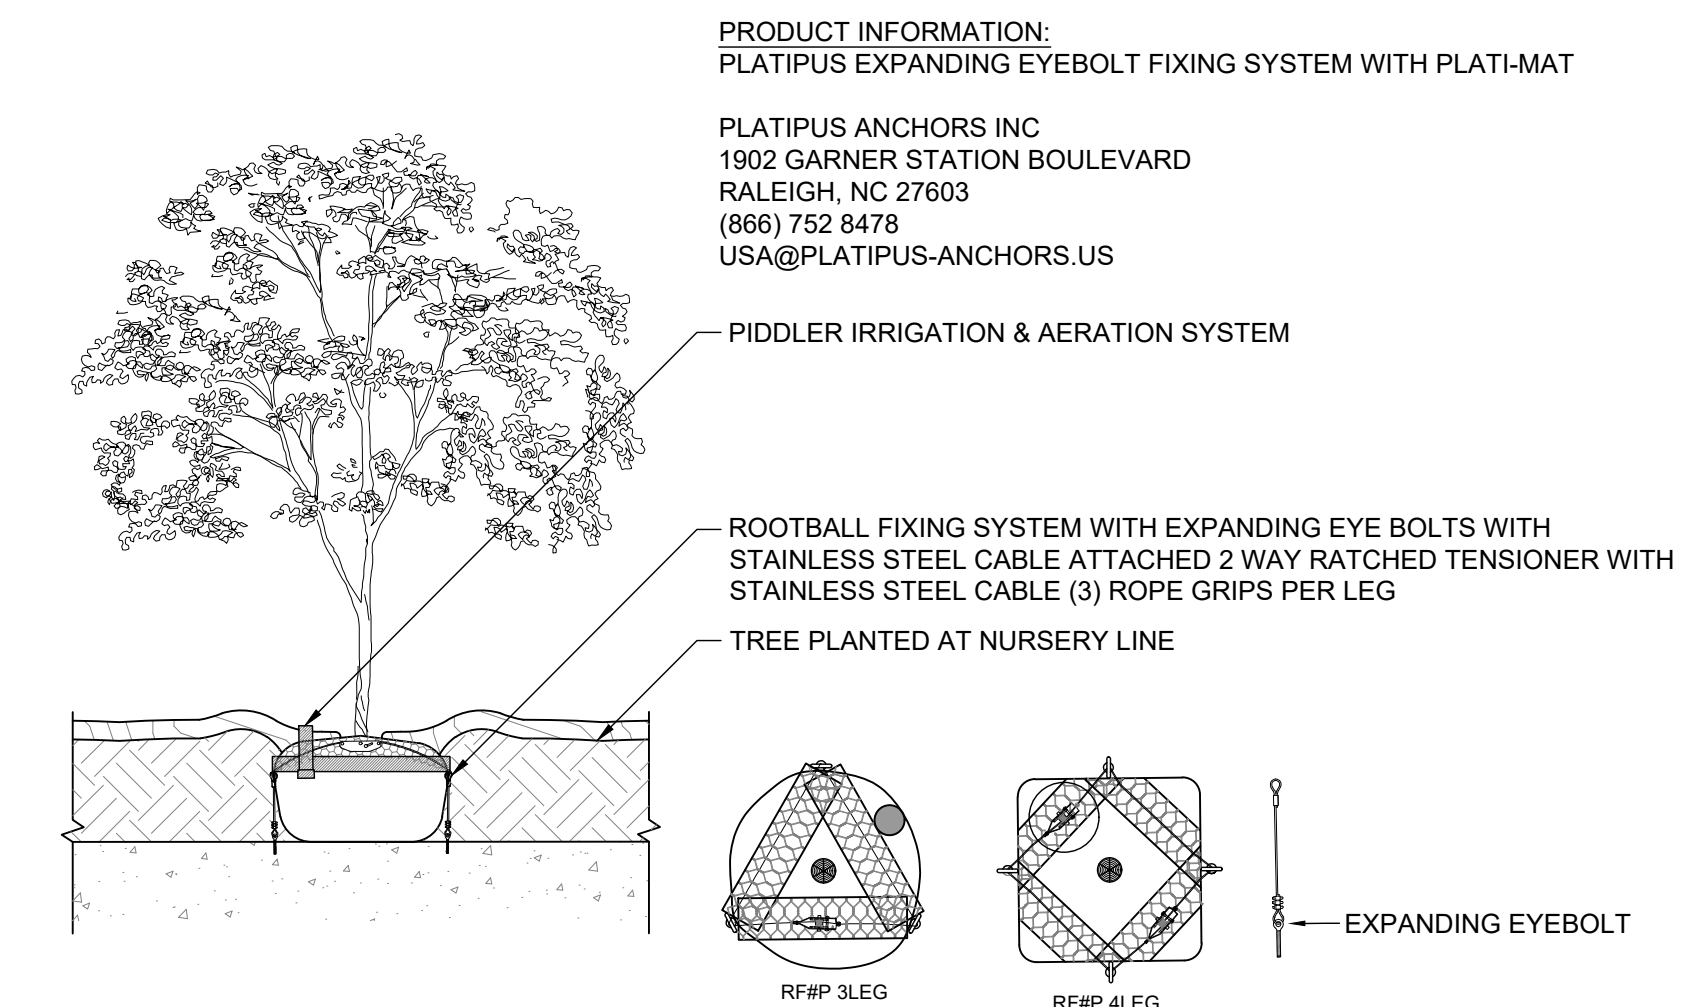
**5 SHRUB PLANTING ON STRUCTURE**  
L-602 SECTION 1/2" = 1'-0"



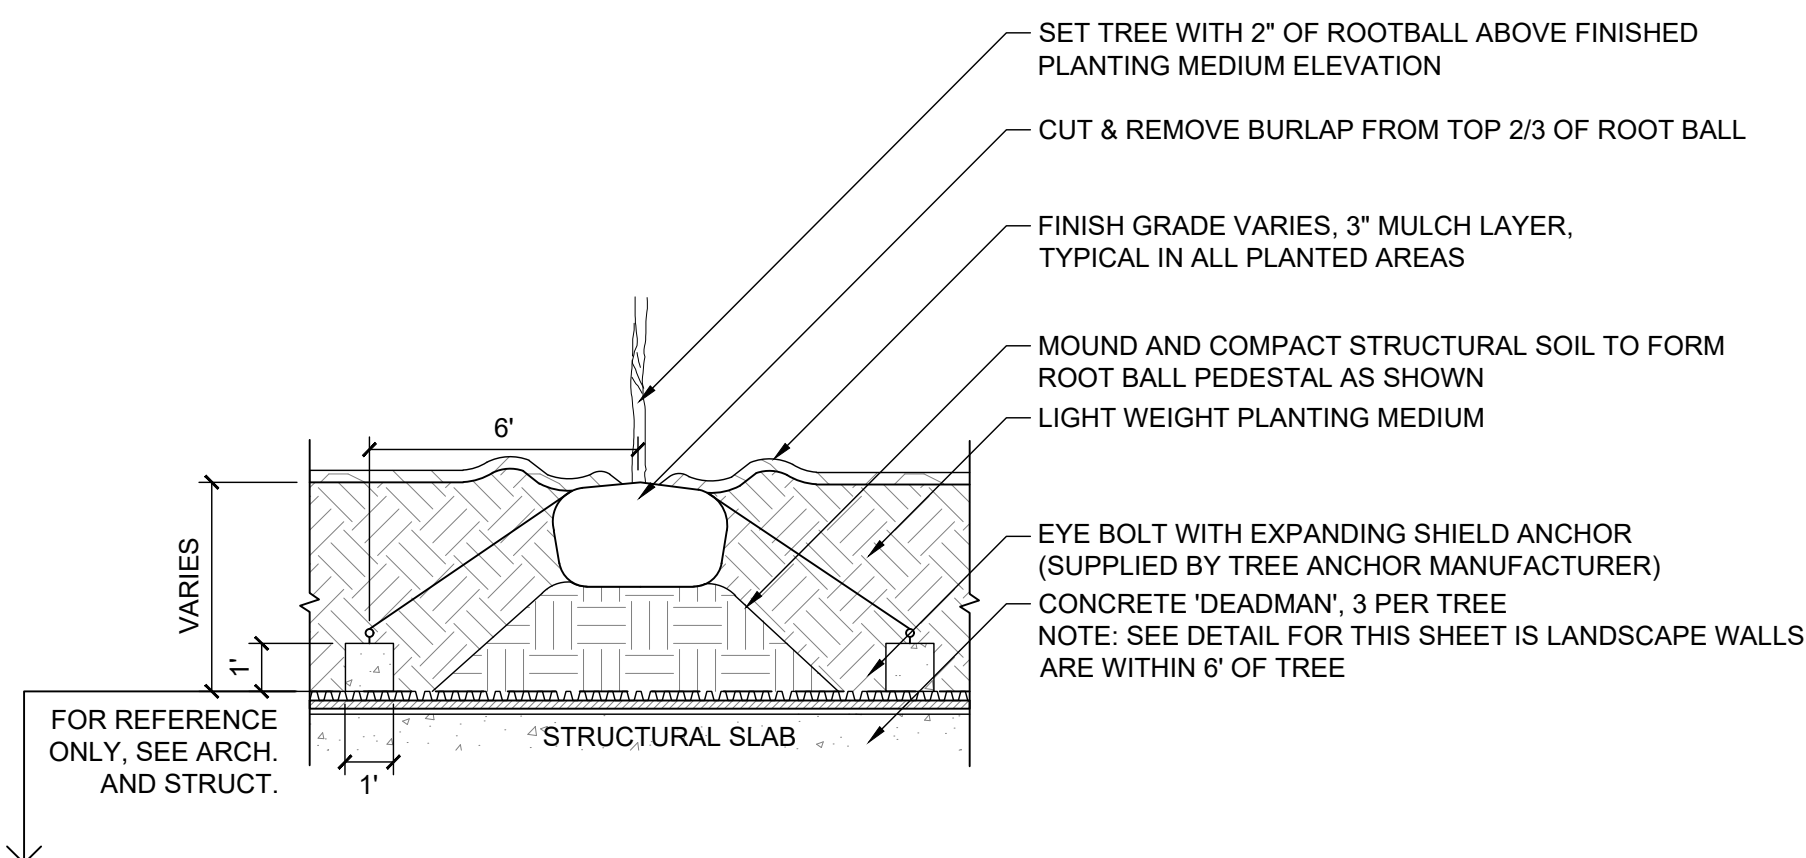
**8 EXPANDING EYEBOLT FIXING SYSTEM W/MAT**  
L-602 SECTION 3/8" = 1'-0"



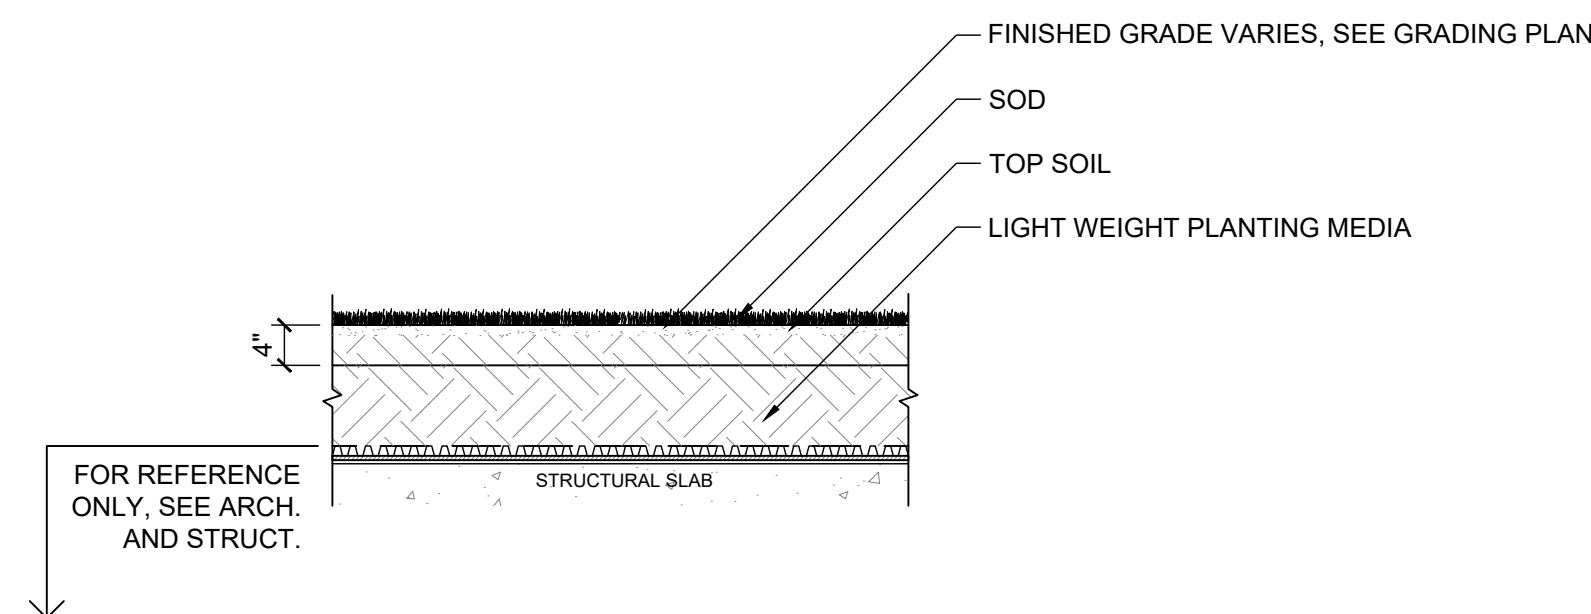**3 TREE PLANTING ON STRUCTURE**  
L-602 SECTION 1/4" = 1'-0"



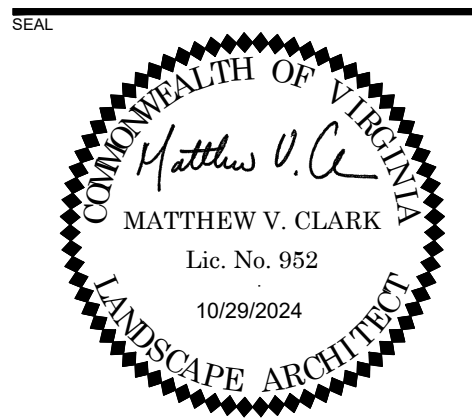**6 LAWN ON STRUCTURE**  
L-602 SECTION 1/2" = 1'-0"



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ROONEY PROPERTIES, LLC  
3130 LANGSTON BOULEVARD  
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DESIGNED BY: GC  
DRAWN BY: JM  
CHECKED BY: AC

SCALE: NORTH (VCS 83)

VERT: N/A  
HORZ:

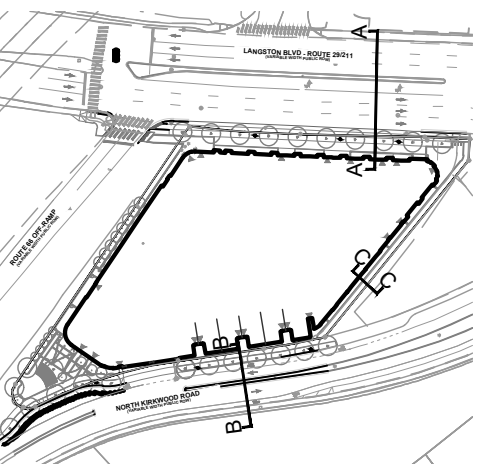
SHEET TITLE

DETAILS - PLANTING ON STRUCTURE


SHEET NUMBER

L-602







KEY MAP  
SCALE: 1" = 200'

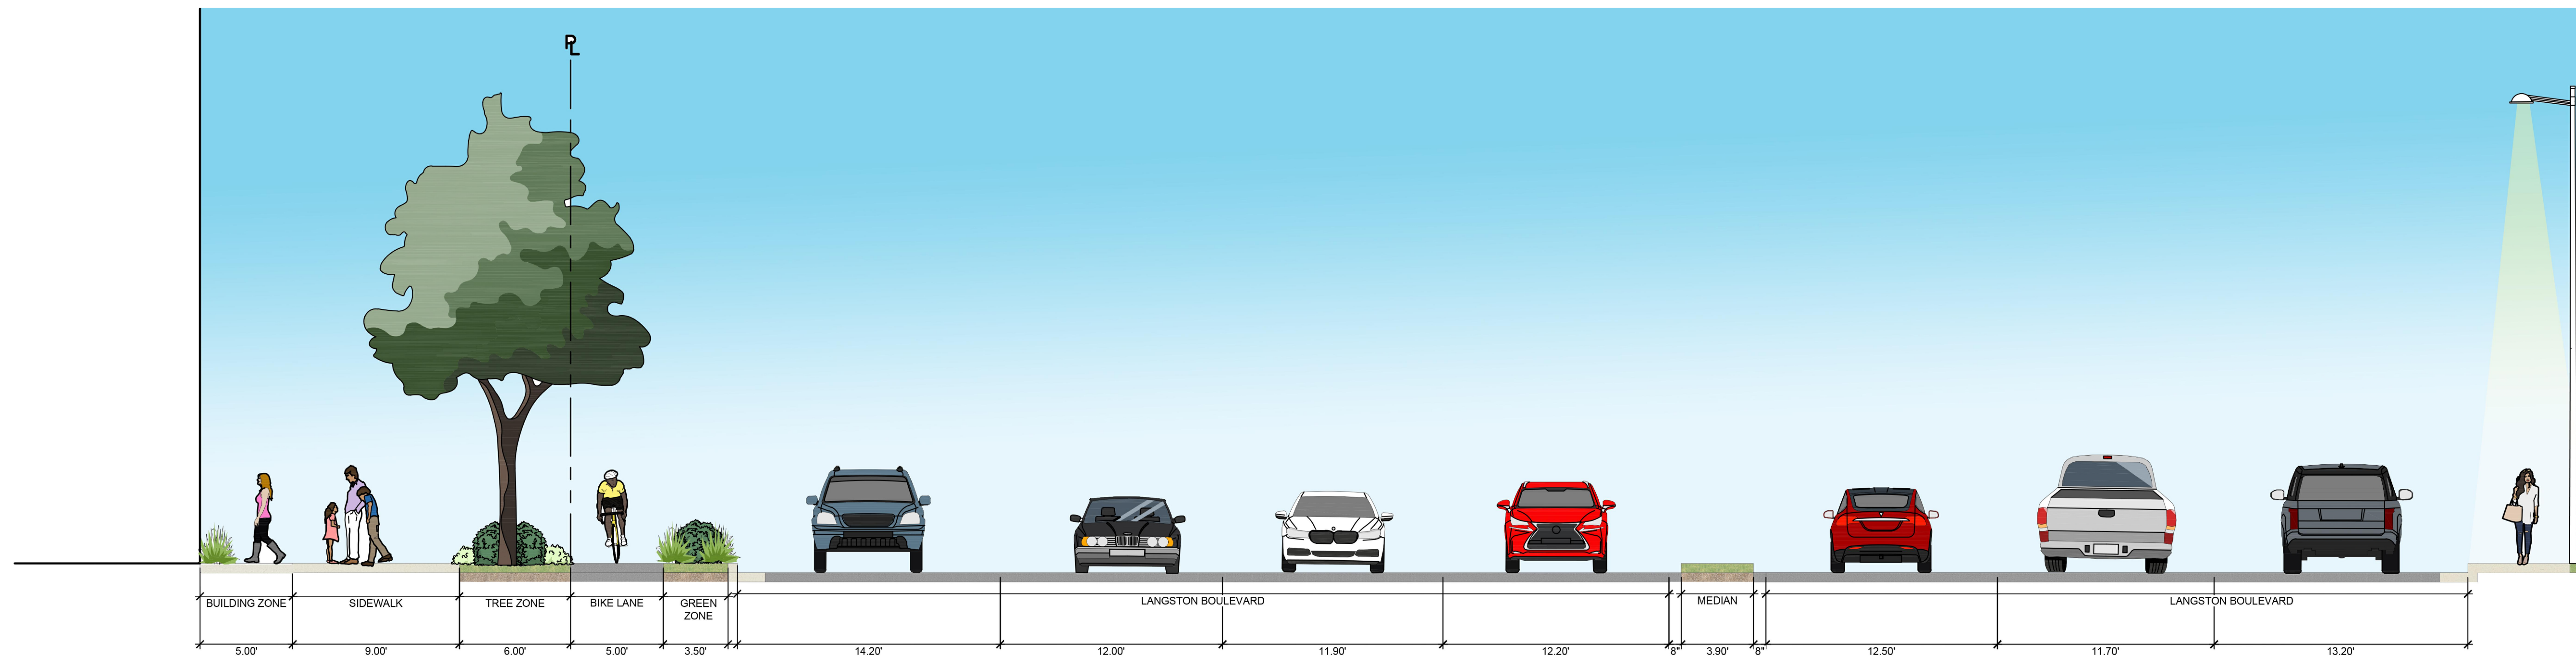


SECTION A-A - LANGSTON BOULEVARD

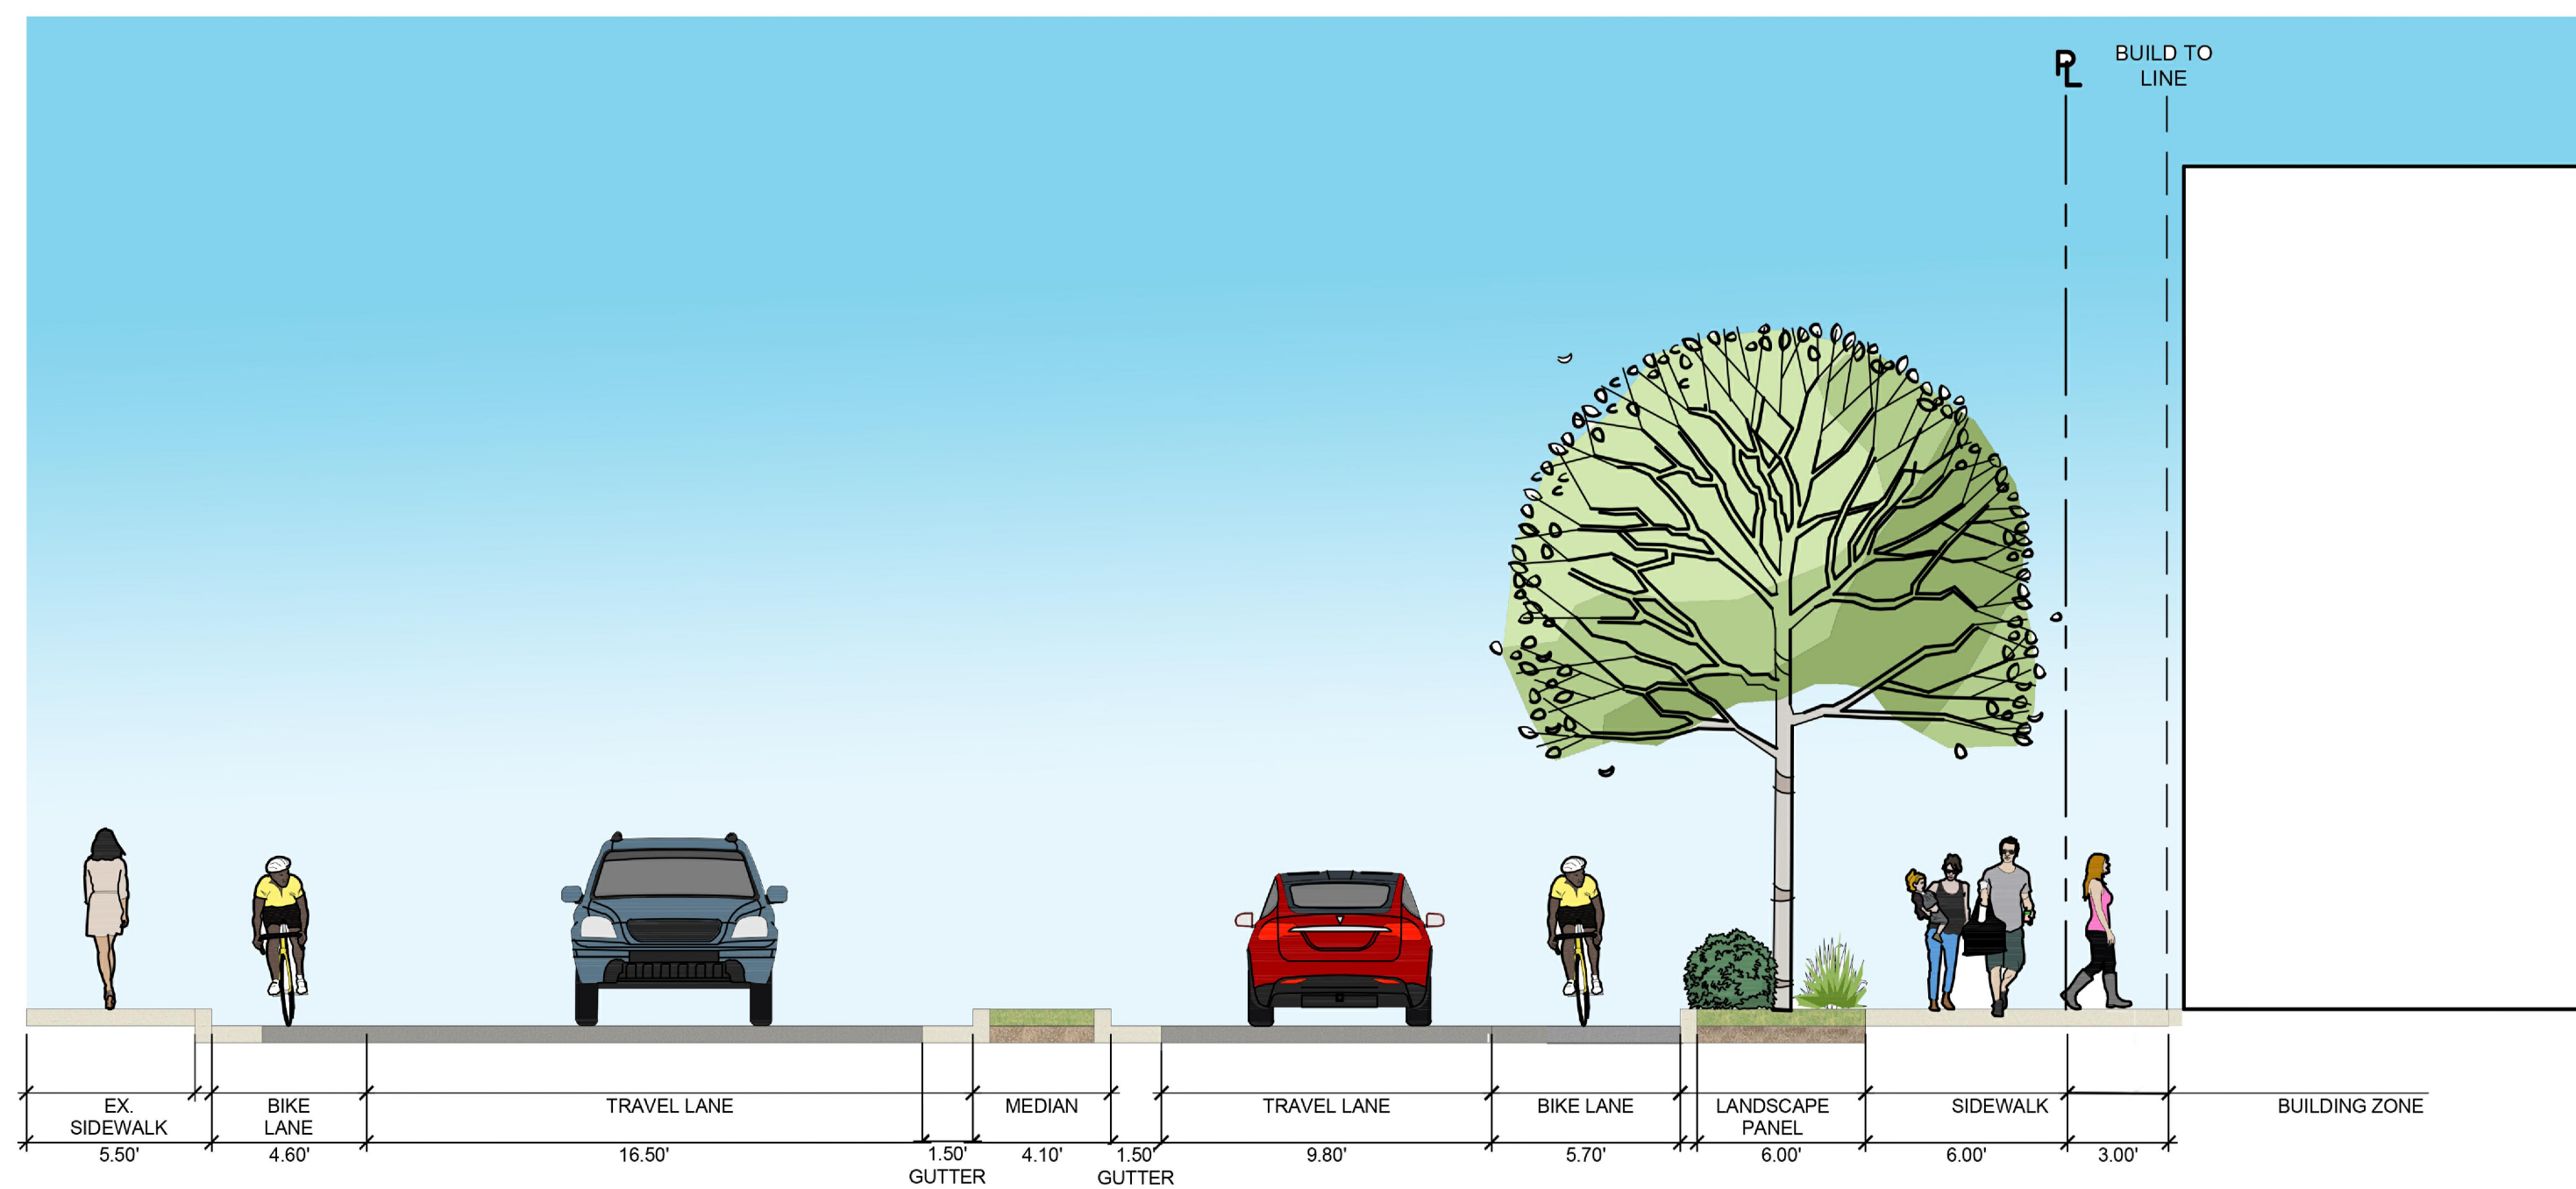

SECTION B-B - NORTH KIRKWOOD ROAD

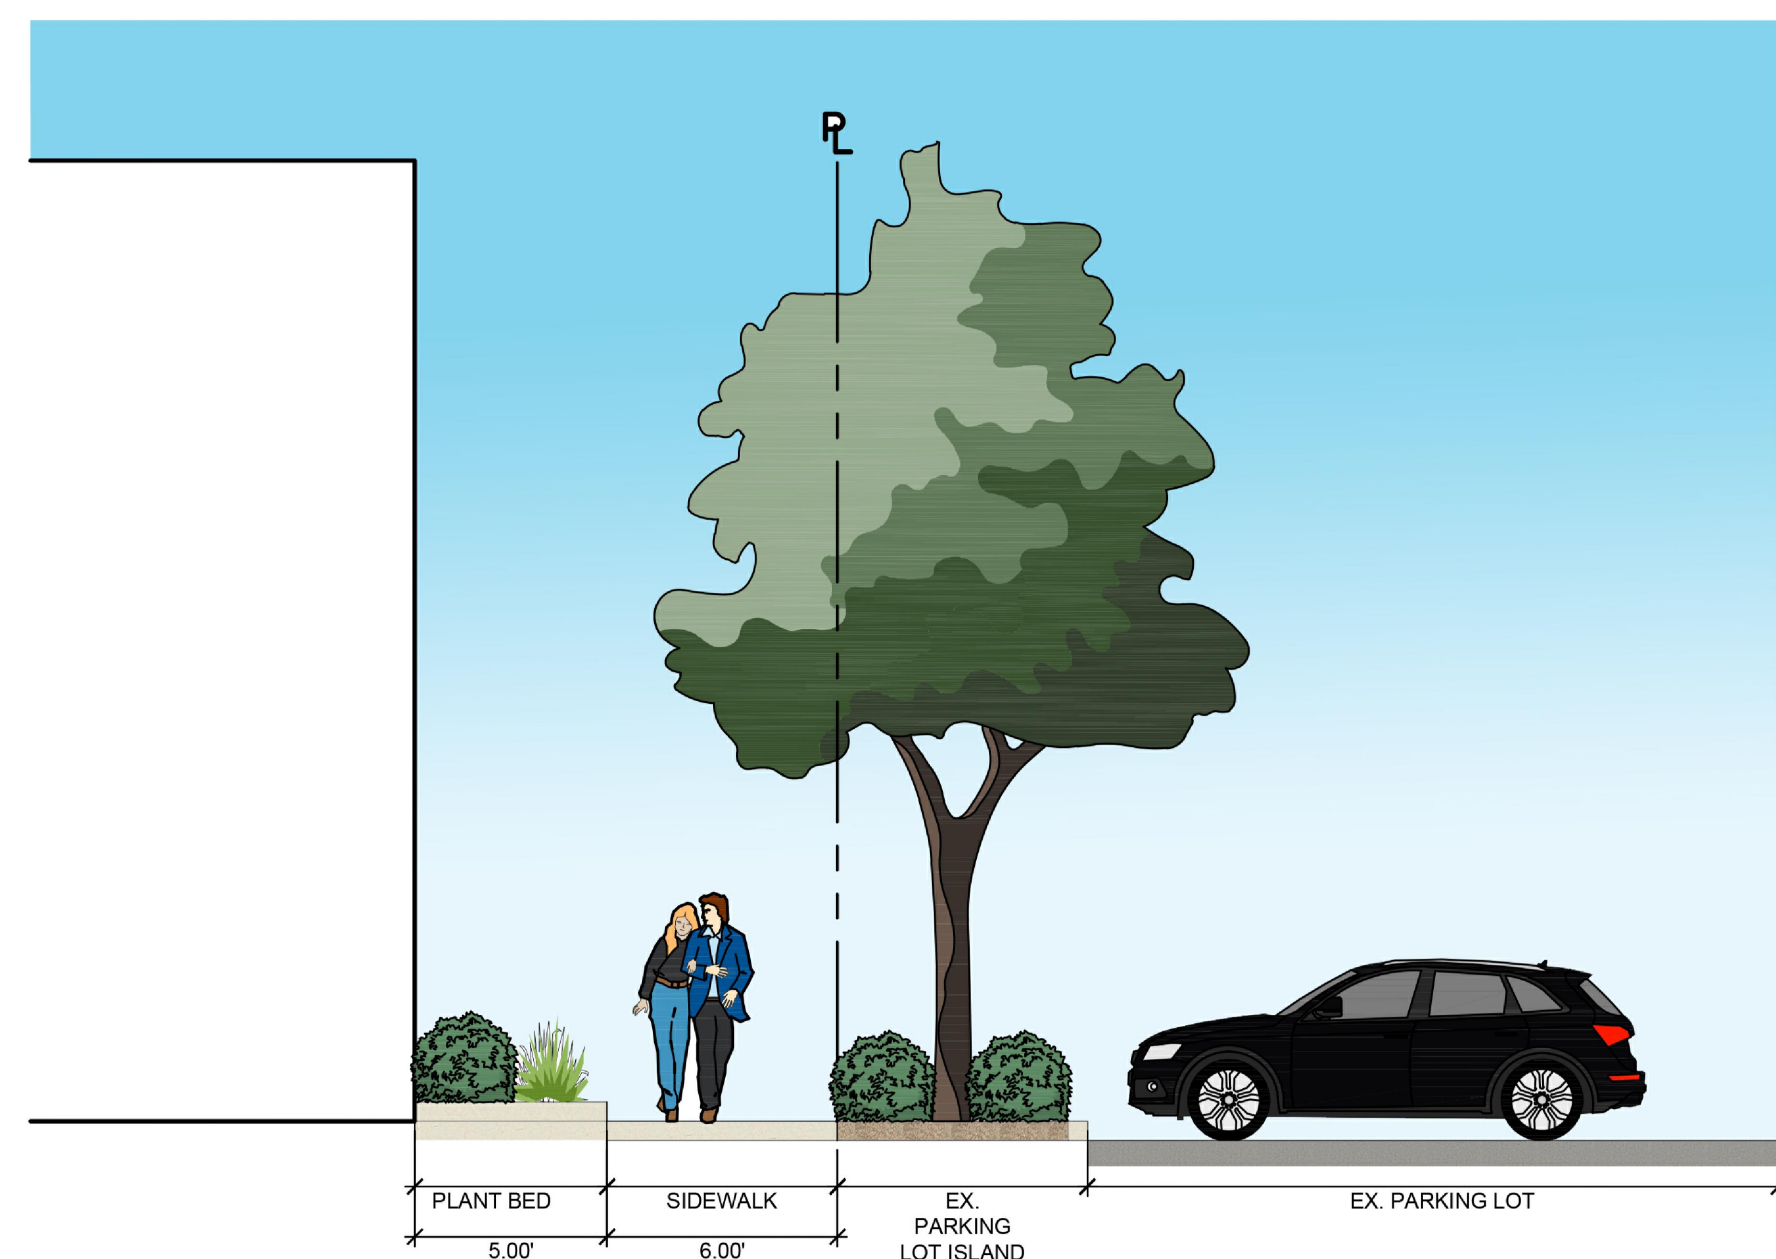

SECTION C-C - EASTERN PROPERTY BOUNDARY

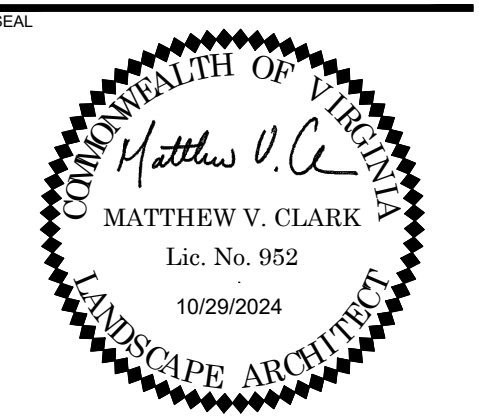

PROJECT

**3130 LANGSTON BOULEVARD**

ROONEY PROPERTIES, LLC  
3130 LANGSTON BOULEVARD  
ARLINGTON, VA 22201

LANDDESIGN PROJ.# 2024074

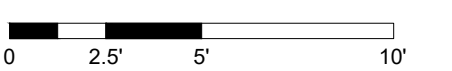
REVISION / ISSUANCE

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DESIGNED BY: GC  
DRAWN BY: JM  
CHECKED BY: AC

SCALE: NORTH (VCS 83)

VERT: N/A  
HORZ: 1" = 5'



SHEET TITLE

DETAILS - SECTIONS

SHEET NUMBER

**L-701**