
VICINITY MAP

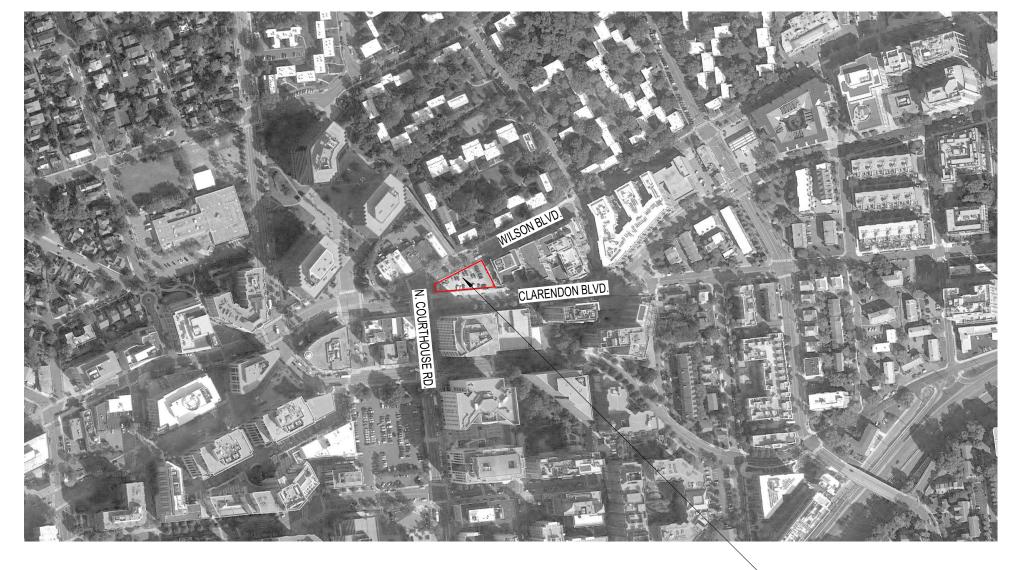

PROJECT SITE

#### CLIENT / OWNER

Greystar 8405 Greensboro Drive Suite 500 McLean, VA 22102 tel: 703.594.8022 www.greystar.com

#### CIVIL

Bowman Consulting 12355 Sunrise Valley Drive Suite 520 Reston, VA 20191 tel: 703.464.1000 www.bowmanconsulting.com

STRUCTURAL

tel: 301.881.1441 www.skaengineers.com

ELECTRICAL

Power Design Inc 11600 9th Street N

St. Petersburg, FA tel: 727.210.492

www.powerdesigninc.us

SK&A Engineers 12435 Park Potomac Avenue Suite 300 Potomac, MD 20854

#### ARCHITECT

Cooper Carry 625 N Washington Street Suite 200 Alexandria, VA 22314 tel: 703.519.6152 www.coopercarry.com

#### LANDSCAPE

Land Design 200 South Peyton Street

Alexandria, VA 22314 tel: 703.549.7784 www.landdesign.com

#### MECHANICAL / PLUMBING

KTA Group 12950 Worldgate Drive Suite 100 Herdon, VA 20170 tel: 703.713.0300 www.ktagroup.com

#### LAND-USE ATTORNEY

Walsh, Colucci, Lubeley & Walsh PC 2200 Clarendon Blvd. Suite 1300 Arlington, VA 22201 tel: 703.528.4700 www.thelandlawyers.com

PROJECT NUMBER: 20200182 PROJECT NAME: 2025 CLARENDON BLVD SHEET NUMBER: 1 - G0.00 - COVER SHEET / INDEX OF DRAWINGS C:\Users\zandian02396\Documents\20200182\_2021\_CH2\_MAIN\_CENTRAL\_nastaranzandiar 2/7/2022 1:13:08 PM

	DRAWING INDEX 4.1
SHEET NO.	SHEET NAME
G0	
1 - G0.00	COVER SHEET / INDEX OF DRAWINGS
1 - G0.01	GENERAL INFORMATION
1 - G0.02	GFA DIAGRAMS AND TABULATIONS
1 - G0.03	GFA DIAGRAMS AND TABULATIONS
1 - G0.04	GFA DIAGRAMS AND TABULATIONS
1 - G0.05	GFA DIAGRAMS AND TABULATIONS
1 - G0.06	GFA DIAGRAMS AND TABULATIONS
1 - G0.07	3D MASSING VIEWS
A1	
1 - A1.00	CONTEXTUAL SITE PLAN
1 - A1.01	CONTEXTUAL STREET SECTION
1 - A1.02	SITE PLAN
A2	
1 - A2.01	FLOOR PLAN - LEVEL G2
1 - A2.02	FLOOR PLAN - LEVEL G1
1 - A2.03	FLOOR PLAN - LEVEL 01
1 - A2.04	FLOOR PLAN - LEVEL 02
1 - A2.05	FLOOR PLAN - LEVEL 03
1 - A2.06	FLOOR PLAN - LEVEL 07 (04-10 SIM)
1 - A2.07	FLOOR PLAN - LEVEL 11
1 - A2.08	FLOOR PLAN - LEVEL 14 (12-15 SIM)
1 - A2.09	FLOOR PLAN - LEVEL 16
1 - A2.10	FLOOR PLAN - PENTHOUSE
1 - A2.11	FLOOR PLAN - PENTHOUSE ROOF
A4	
1 - A4.01	EXTERIOR ELEVATION - SOUTH
1 - A4.02	EXTERIOR ELEVATION - EAST
1 - A4.03	EXTERIOR ELEVATION - NORTH
1 - A4.04	EXTERIOR ELEVATION - WEST
1 - A4.05	BUILDING SECTION - EAST/WEST
1 - A4.06	BUILDING SECTION - NORTH/SOUTH
A5	
1 - A5.01	ENLARGED ELEVATIONS - SOUTH & EAST
1 - A5.02	ENLARGED ELEVATIONS - NORTH & WEST
С	
C02.0	CERTIFIED SURVEY PLAT
C03.0	PRELIMINARY PLAT EXHIBIT
C03.1	PRELIMINARY DEDICATION EXHIBIT
C04.0	SITE AERIAL PHOTOGRAPH
C05.0	PLOT AND LOCATION PLAN
C06.0	PRESENTATION PLAN
C06.1	PRESENTATION PLAN
C07.0	STRIPING AND MARKING PLAN
C07.1	FIRE SERVICE PLAN
C08.0	EXISTING ROAD CROSS SECTIONS
C09.0	PROPOSED ROAD CROSS SECTIONS
C010.0	STORMWATER MANAGEMENT PLAN
C011.0	WATER QUALITY COMPUTATIONS
C011.1	CISTERN COMPUTATIONS
C012.0	CONTEXTUAL PLAN
C013.0	TREE PRESERVATION PLAN
C013.1	TREE PRESERVATION NOTES AND DETAILS
L1	
L000	COVER SHEET
L001	GENERAL NOTES
L002	GENERAL NOTES
L101	MATERIAL PLANS
1 201	OPEN SPACE PLANS

L002	GENERAL NOTES
L101	MATERIAL PLANS
L201	OPEN SPACE PLANS
L401	HARDSCAPE DETAILS
L402	HARDSCAPE DETAILS
L403	HARDSCAPE DETAILS
L501	PLANTING PLANS
L502	PLANTING NOTES
L503	PLANTING DETAILS
L504	PLANTING DETAILS

### 2025 CLARE

### 2025 CLARE ARLINGTO MIXED-USE

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4.1 SITE PLA

	- COOPER CARRY THE CENTER FOR CONNECTIVE ARCHITECTURE
ENDON BLVD	©2021 COOPER CARRY SCOPE DOCUMENTS The Contract Documents Issued for [Conceptual Design, Schematic Design, Design Development, Partial Construction Documents or Other Issuance up to Issued for Construction] are intended to be at that level of development and as such, may be neither complete nor coordinated. The
ENDON BLVD ON, VA 22201 E RESIDENTIAL	[Construction Manager, Contractor, Design/Builder] is responsible for complete and coordinated pricing [and execution] of the Work, and shall include items necessary for the proper execution and completion of the Work, as shown, specified, reasonably inferred or required for a complete Project. For Work of delegated designs; systems, assemblies, components and materials shall comply with national, state and local code requirements. The [Construction Manager, Contractor, Design/Builder] shall inform the Owner and Architect, in timely fashion, of any discovered omissions, inconsistencies or errors in the Contract Documents.         ISSUANCES         No.       Drawing Issue Description       Date         4.1 SUBMISSION       04.16.2021         4.1 SUBMISSION       06.11.2021         4.1 SUBMISSION       02.07.2022
JARY 7, 2022	
	р Т Т Т
	2025 CLARENDON BLVD 2025 CLARENDON BLVD ARLINGTON, VA 22201 GREYSTAR COVER SHEET / INDEX OF DRAWINGS
	STEVE SMITH   Principal-in-Charge 20200182   Principal-in-Charge Project No.   NA/HL 07/30/2021   Project Manager Date   MG 1 - G0.000
13 14 15	NOT ISSUED FOR CONSTRUCTION

PARKING I	MATRIX	*ALL PARKING IS ANTICIPATED TO BE RESIDENTIAL USE ONLY.							
VEHICLE PARKING	LEVEL G2	LEVEL G1	G1 VISITOR	TOTAL					
SPACE TYPE	I		1						
ADA EV CAR	1	1	-	2					
ADA VAN	1	-	1	2					
COMPACT	9	10	-	19					
EV	1	1	-	2					
STANDARD	28	13	9	50					
TOTAL	40	25	10	75					
BICYCLE PARKING	LEVEL G2	LEVEL G1	LEVEL 1	TOTAL					
SPACE TYPE	I		1						
CLASS 1 - TOTAL	176	44	12	233					
(ACCESSIBLE)	7	6	2	15					
SITE	-	-	18	18					

#### **2025 CLARENDON BLVD. - ZONING INFORMATION**

ZONING CATEGORY	ALLOWABLE/REQUIRED	PROPOSED
ZONING CLASSIFICATION:	N/A	C-O-2.5
F.A.R.:	N/A	10.68
SITE AREA:	N/A	25,010 SF
PROPOSED PLAN:	N/A	267,031 TOTAL GFA 263,531 RESIDENTIAL GFA 3,500 RETAIL GFA
HEIGHT / # OF STORIES:	16 STORIES	16 STORIES 165' - 6 3/4" TO PENTHOUSE SLAB MAX 23' PENTHOUSE HEIGHT
MIN. PROPERTY STEP BACKS:	N/A	NONE
# OF UNITS:	N/A	231 UNITS
ACCESSIBLE UNITS:	2%: 5 UNITS	5%: 12 UNITS
RETAIL SLAB TO SLAB HEIGHT	N/A	23' - 0"

	FUNCTION	MIC				ID	100					1 00	5				20		20		NI		2 01							TOTALC	
FLOOR	FUNCTION	MIC					1BR	-	-	_	1 BR-IN	18000 Million - 2000 Secon		-		and been been been been	Sector Managero			R+DE		-	3 BI		_	-	-	_		TOTALS	ELEVATION
LEVEL		А	В	CC	) D-A	Α	A-A	В	D	E	A	A	B-A	С	D	A	Α	В	A	В	B-A	С	A	A-A	В	С	D	Е	F		
LEVEL 01	RETAIL/RESI																														229'-0"
LEVEL 02	AMEN./APT UNITS			1							1			1	1	1		1						1						7	241'-0"
LEVEL 03	APT UNITS	1				3		1	L		1	1		L		1	. 1	L		L	1	. 1			1	1				15	252'-0"
LEVEL 04	APT UNITS	1	1			3		1	1		1	1				1	. 1	L		1	1	1	1		1	1				17	261'-7"
LEVEL 05	APT UNITS	1	1			3		1	L 1		1	1				1	. 1	L		1	1	. 1	1		1	1				17	271'-2"
LEVEL 06	APT UNITS	1	1			3		1	L 1		1	1				1	. 1	L		L	1	. 1	1		1	1				17	280'-9"
LEVEL 07	APT UNITS	1	1			3		1	1		1	1				1	. 1	L		1 1		1	1		1	1				17	290'-4"
LEVEL 08	APT UNITS	1	1			3		1	L 1		1	1				1	. 1	L		l 1		1	1		1	1				17	299'-11"
LEVEL 09	APT UNITS	1	1			3		1	. 1		1	1				1	. 1	L		1 1		1	1		1	1				17	309'-6"
LEVEL 10	APT UNITS	1	1			3		1	. 1		1	1				1	1	L		1 1		1	1		1	1				17	319'-1"
LEVEL 11	APT UNITS	1	1		1	L 1			1	2	2						1	L		l 1		1	1				1	1	1	15	331'-1"
LEVEL 12	APT UNITS	1	1		1	1		1	1	1							1	L		l 1		1	1				1	1	1	15	340'-8"
LEVEL 13	APT UNITS	1	1		1	1		1	1	1							1	L		1 1		1	1				1	1	1	15	350'-3"
LEVEL 14	APT UNITS	1	1		1	1		1	1	1							1	L		1 1		1	1				1	1	1	15	359'-10"
LEVEL 15	APT UNITS	1	1		1	1		1	1	1							1	L		1 1		1	1				1	1	1	15	369'-5"
LEVEL 16	APT UNITS	1	1		1	1		1	1	1							1	L		11		1	1				1	1	1	15	379'-0"
PENTHOUSE	MEETING/POOL																														393'-0"
TOTAL		14	13	1	5 2	L 30		58	3 13	7	9	8	6	1 1	1	9	9 14	1 1	. 14	1 10	4	14	13	1	8	8	6	6	6	231	

PROPOSED (DEVIATION IN ITALICS)

#### NOTES:

1. -A SUFFIX ON UNIT TYPE DENOTES ANSI TYPE A UNITS. 2. - IN SUFFIX DENOTES UNIT WITH INBOARD BEDROOM.

TOTAL RENTABLE SQUARE FOOTAGE BY UNIT TYPE:							
MICRO	15,243 SF						
1 BR	50,582 SF						
2 BR	76,325 SF						
3 BR	70,404 SF						

ZONING CATEGORY

PARKING:

FLOOR LEVEL	FUNCTION	GROSS PARKING	RETAIL GFA	RESIDENTIAL GFA	GFA EXCLUSIONS	
		LOADING AREA				(RETAIL + RESI GFA)
LEVEL G2	RESI. PARKING	20,832	0	0	1,947	0
LEVEL G1	RESI. PARKING	19,493	0	0	2,454	0
LEVEL 1	<b>RETAIL/AMENITIES</b>	4,280	3,500	5,949	0	9,449
LEVEL 2	AMENITIES/UNITS	109	0	10,417	23	10,417
LEVEL 3	UNITS	0	0	15,914	82	15,914
LEVEL 4	UNITS	0	0	17,811	83	17,811
LEVEL 5	UNITS	0	0	17,818	83	17,818
LEVEL 6	UNITS	0	0	17,825	83	17,825
LEVEL 7	UNITS	0	0	17,832	83	17,832
LEVEL 8	UNITS	0	0	17,839	83	17,839
LEVEL 9	UNITS	0	0	17,846	83	17,846
LEVEL 10	UNITS	0	0	17,853	83	17,853
LEVEL 11	UNITS	0	0	15,896	90	15,896
LEVEL 12	UNITS	0	0	16,461	97	16,461
LEVEL 13	UNITS	0	0	16,467	97	16,467
LEVEL 14	UNITS	0	0	16,474	97	16,474
LEVEL 15	UNITS	0	0	16,480	97	16,480
LEVEL 16	UNITS	0	0	16,436	106	16,436
PENTHOUSE LEVEL	AMENITIES/UNITS	0	0	8,213	131	8,213
		44,714	3,500	263,531	5,802	267,031

RETAIL SLAB TO SLAB HEIGHT AT LEVEL 01: 23'-0" \*GFA EXCLUSIONS INCLUDE SHAFTS AND BOH SUPPORT SPACES INCLUDING ELECTRICAL, GENERATOR, PUMP ROOM AND STORAGE. REFER TO SHEETS G0.02-06.

PROPOSED C-O-2.5 10.68 25,010 SF 267,031 TOTAL GFA 263,531 RESIDENTIAL GFA 3,500 RETAIL GFA

RESIDENTIAL:	231 (1/UNIT PER ORDINANCE) 47 (0.2/UNIT PER COUNTY PARKING GUIDELINES)	65 AT LEVELS G2 AND G1 (0.28/UNIT)
RESIDENTIAL VISITORS:	10 (0.5 PER UNIT FOR THE FIRST 200 UNITS)	10 AT LEVEL G1
RETAIL:	16 (1 PER 250 SF)	NO RETAIL PARKING PROVIDED
RESIDENTIAL COMPACT:	8 (0.15/ REQUIRED RESIDENTIAL PARKING)	19 (0.25/ RESIDENTIAL PARKING)
ਵਿਊ RESIDENTIAL ACCESSIBLE: (76-100)	4 (1 VAN)	4 (2 VAN)
RESIDENTIAL COMPACT: RESIDENTIAL ACCESSIBLE: (76-100)		5%: 4 EV CHARGING SPACES PROVIDED (15%: 12 INFRASTRUCTURE PROVIDED)
BIKE PARKING:		
RESIDENTIAL - TENANTS: 1 PER 2.5 UNITS	93	233
RESIDENTIAL - VISITORS: 1 PER 50 UNITS	5	16
RETAIL - EMPLOYEES: 1 PER 25,000 SQ.FT.	1	1
RETAIL - VISITORS: 2 PER 10,000 SQ.FT.	1	1
LOADING:		
RESIDENTIAL: 1 PER 200 UNITS	2 BAYS	2 BAYS AT LEVEL 1 - 15' CLEARANCE
RETAIL:	1 BAY	1 BAY AT LEVEL 1 - 15' CLEARANCE
OVERHEAD CLEARANCE: 15'-0"		
RETAIL FACADE GLASS:		
WEST FACADE	65% FROM 2' TO 10' HIGH	86%
NORTH FACADES	65% FROM 2' TO 10' HIGH	39%
SOUTH FACADE	50% FROM 2' TO 10' HIGH	65%
EAST FACADE	N/A	N/A

ALLOWABLE/REQUIRED

Tota Tota TDRs Site Base Resid Tota Reto LEED Res Ret

Rem Tota Tota Tota Tota Tota

<b>COOPER CARRY</b>
THE CENTER FOR CONNECTIVE ARCHITECTURE

#### UNIT MATRIX

#### DENSITY CHART

#### BONUS DENSITY CALCS

tal C-O-2.5 Site Area (SF)	25,010.00
tal Site Area (AC)	25,010 SF (0.57 AC)
Rs (from Wakefield Manor)	104,789.00 SF
e Area Allocated to Residential	23,781.93 SF ( .545 AC)
e Area Allocated to Retail	1,228.07 SF (.03 AC)
se Density Calculation	
sidential	
Site Area	23,781.93 SF ( .545 AC)
Total Base Residential Units	62 units
TDRs Converted to Units at 1,000 sf/unit	104 units
tal	166 units
tail	
Site Area	1,228.07 SF (.03 AC)
Base Retail GFA	3,070.18 SF
ED Gold Bonus Calculation (0.35 FAR)	
sidential	
LEED Gold Bonus Density	8,323.67 SF of GFA
LEED Gold Bonus Units (using gross avg. unit	
e of 1,138.86 SF)	7 units
tail	
LEED Gold Bonus Density	429.82 SF
maining Bonus Density Calculation	
tal Proposed Units	231
tal Base Density including TDRs	166
tal Retail GFA	3,500 SF
tal LEED GOLD Residential Bonus	7 units
tal LEED Gold Retail Bonus	429.82 SF
tal Remaining Bonus Density	58 units (Approx. 66,053.88 SF)

#### SCOPE DOCUMENTS

The Contract Documents Issued for [Conceptual Design, Schematic Design, Design Development, Partial Construction Documents or Other Issuance up to Issued for Construction] are intended to be at that level of development and as such, may be neither complete nor coordinated. The [Construction Manager, Contractor, Design/Builder] is responsible for complete and coordinated pricing [and execution] of the Work, and shall include items necessary for the proper execution and completion of the Work, as shown, specified, reasonably inferred or required for a complete Project. For Work of delegated designs; systems, assemblies, components and materials shall comply with national, state and local code requirements. The [Construction Manager, Contractor, Design/Builder] shall inform the Owner and Architect, in timely fashion, of any discovered omissions, inconsistencies or errors in the Contract Documents.

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ISSUANCES						
No.	Drawing Issue Description	Date				
	4.1 SUBMISSION	04.16.2021				
	4.1 SUBMISSION	06.11.2021				
	4.1 SUBMISSION	02.07.2022				
	4.1 SUBMISSION	02.25.2022				



#### 2025 CLARENDON BLVD

2025 CLARENDON BLVD ARLINGTON, VA 22201

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GREYSTAR


#### GENERAL INFORMATION

STEVE SMITH	20200182
Principal-in-Charge	Project No.
NA/HL	07/30/2021
Project Manager	Date
MG	
Project Architect	
SG	
Staff Architect	= 1 - G0.01


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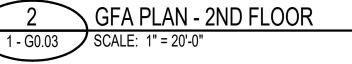
STORAGE 355 SF


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# R: 20200182 PROJECT NAME: 2025 CLARENDON BLVD 1 - G0.03 - GFA DIAGRAMS AND TABULATIONS ian02396\Documents\20200182\_2021\_CH2\_ PROJECT SHEET NU C:\Users



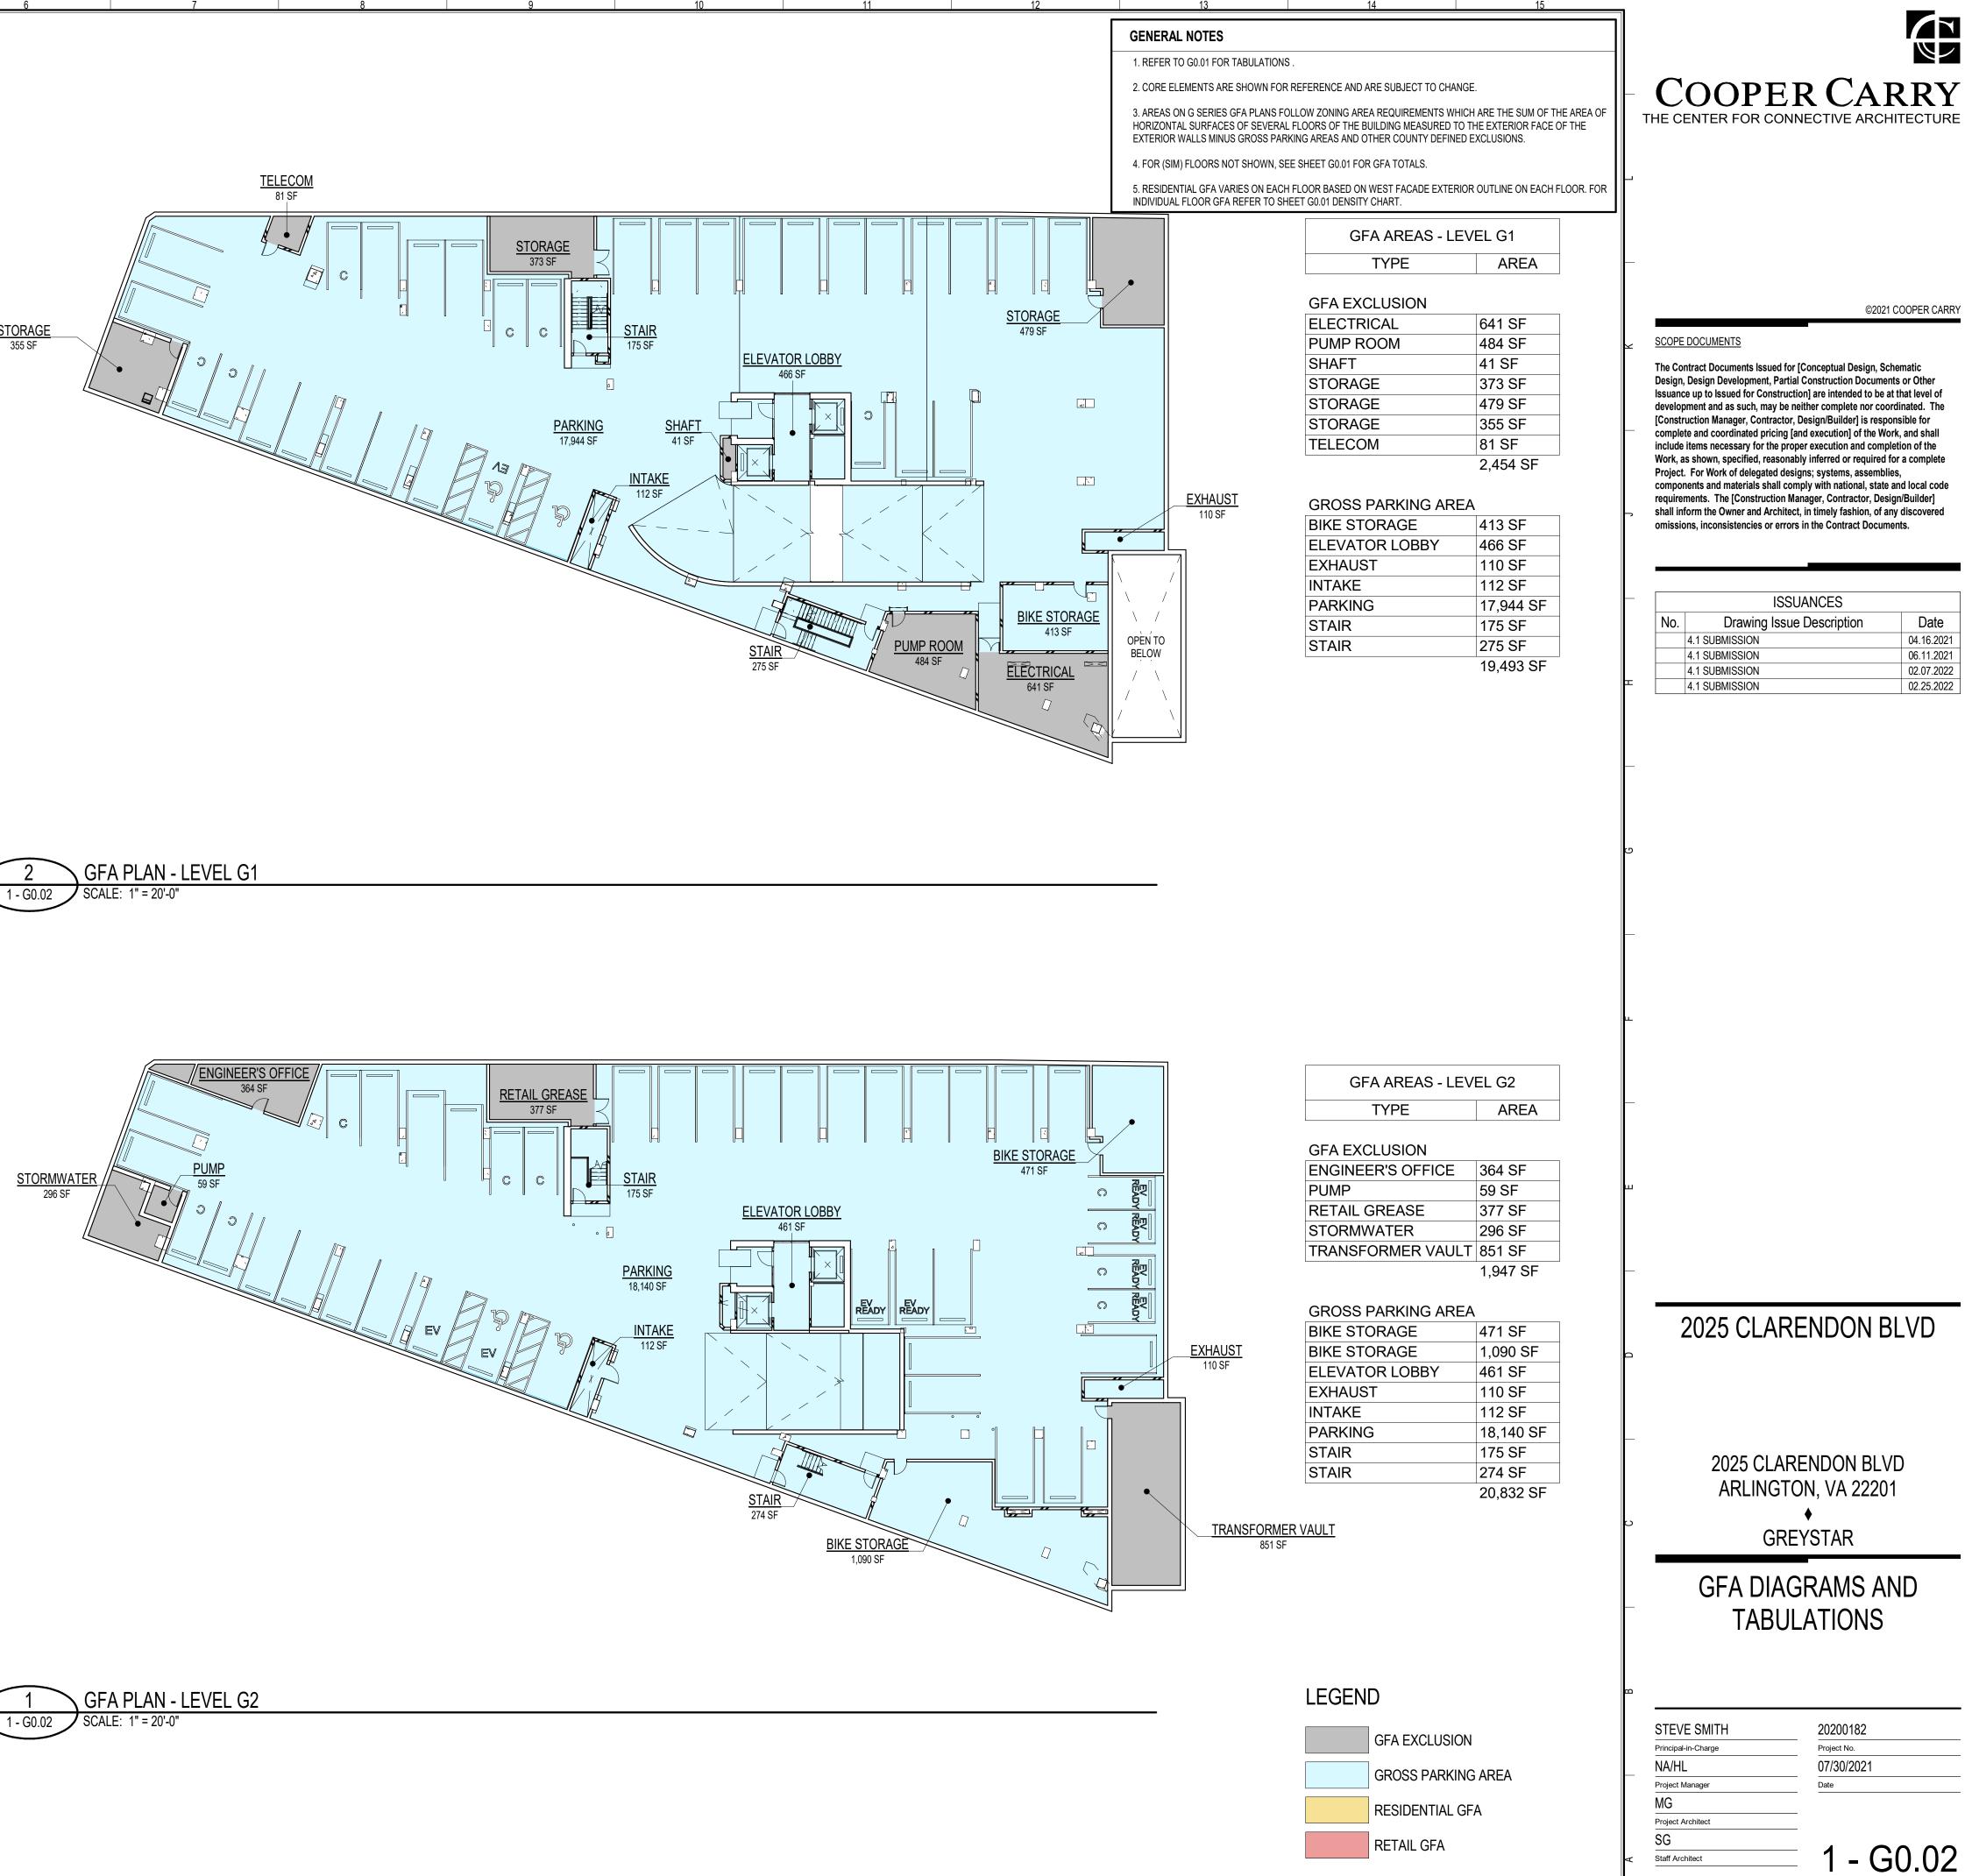

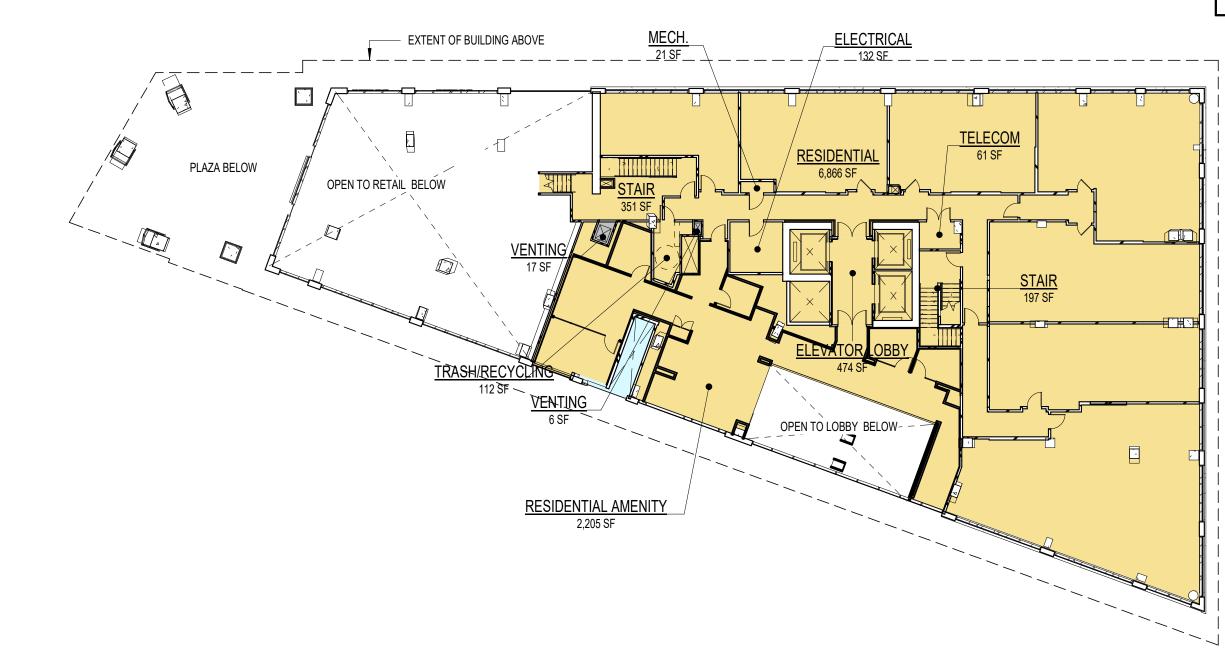

### 1 - G0.03 GFA PLAN - GROUND FLOOR SCALE: 1" = 20'-0"

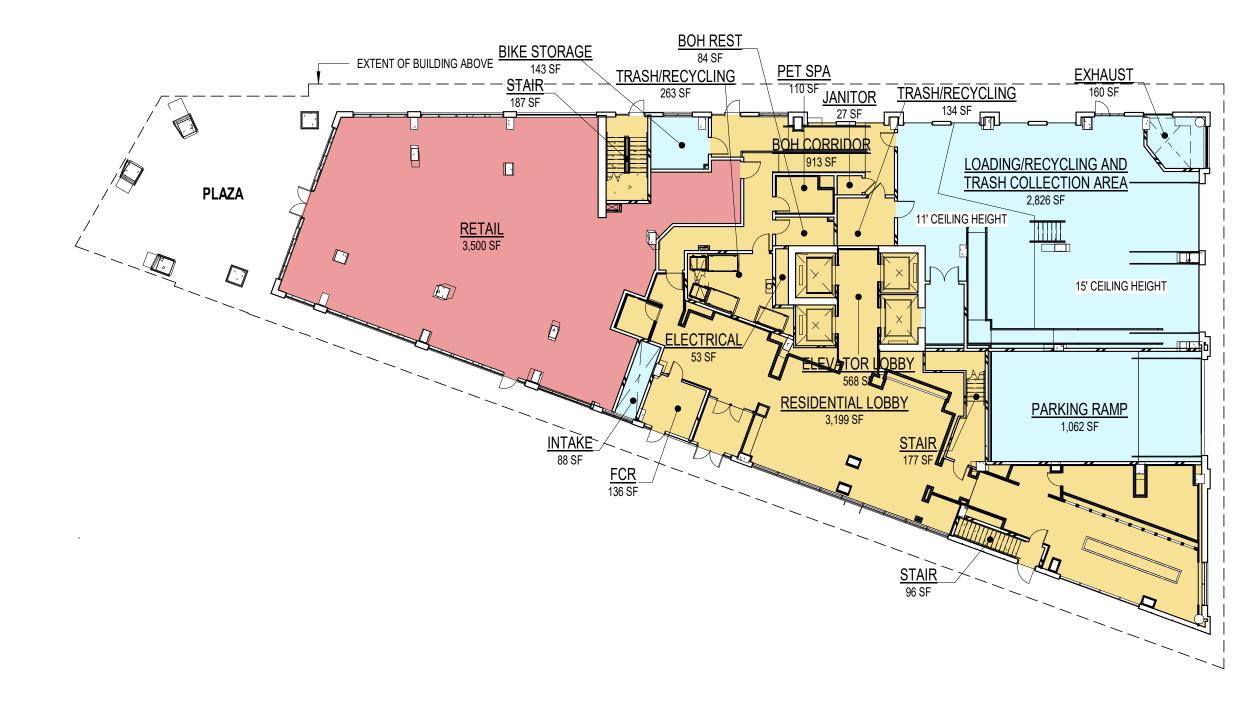

- 1. REFER TO G0.01 FOR TABULATIONS .
- 2. CORE ELEMENTS ARE SHOWN FOR REFERENCE AND ARE SUBJECT TO CHANGE.

3. AREAS ON G SERIES GFA PLANS FOLLOW ZONING AREA REQUIREMENTS WHICH ARE THE SUM OF THE AREA OF HORIZONTAL SURFACES OF SEVERAL FLOORS OF THE BUILDING MEASURED TO THE EXTERIOR FACE OF THE EXTERIOR WALLS MINUS GROSS PARKING AREAS AND OTHER COUNTY DEFINED EXCLUSIONS.

4. FOR (SIM) FLOORS NOT SHOWN, SEE SHEET G0.01 FOR GFA TOTALS.

5. RESIDENTIAL GFA VARIES ON EACH FLOOR BASED ON WEST FACADE EXTERIOR OUTLINE ON EACH FLOOR. FOR INDIVIDUAL FLOOR GFA REFER TO SHEET G0.01 DENSITY CHART.

OOR BASED ON WEST FACADE EXTERIOR G0.01 DENSITY CHART.	OUTLINE ON EACH FLOOR.
GFA AREAS - LEV	/EL 2
TYPE	AREA
GFA EXCLUSION	
VENTING	17 SF
VENTING	6 SF
	23 SF
GROSS PARKING AREA	
INTAKE	109 SF
	109 SF
RESIDENTIAL GFA	
ELECTRICAL	132 SF
ELEVATOR LOBBY	474 SF
MECH.	21 SF
RESIDENTIAL	6,866 SF
RESIDENTIAL AMENITY	2,205 SF
STAIR	351 SF
STAIR	197 SF
TELECOM	61 SF
TRASH/RECYCLING	112 SF
	10,417 SF

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Nork, a Project compo require shall in	items necessary for the proper execution and com as shown, specified, reasonably inferred or required as For Work of delegated designs; systems, assemb nents and materials shall comply with national, stat ments. The [Construction Manager, Contractor, De form the Owner and Architect, in timely fashion, of a ons, inconsistencies or errors in the Contract Docur	for a complete lies, e and local code sign/Builder] any discovered
	ISSUANCES	
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110.	4.1 SUBMISSION	04.16.2021
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	4.1 SUBMISSION       4.1 SUBMISSION       4.1 SUBMISSION       4.1 SUBMISSION	04.16.2021 06.11.2021 02.07.2022
	4.1 SUBMISSION 4.1 SUBMISSION	04.16.2021 06.11.2021

**COOPER CARRY** 

THE CENTER FOR CONNECTIVE ARC

GFA AREAS - LEVEL 1					
TYPE AREA					
GROSS PARKING AREA					
BIKE STORAGE	143 SF				
EXHAUST	160 SF				
INTAKE	88 SF				
LOADING/RECYCLING AND TRASH COLLECTION AREA	2,826 SF				


COLLECTION AREA 1,062 SF PARKING RAMP 4,280 SF

#### **RESIDENTIAL GFA**

BOH CORRIDOR	913 SF
BOH REST	84 SF
ELECTRICAL	53 SF
ELEVATOR LOBBY	568 SF
FCR	136 SF
JANITOR	27 SF
PET SPA	110 SF
RESIDENTIAL LOBBY	3,199 SF
STAIR	177 SF
STAIR	96 SF
STAIR	187 SF
TRASH/RECYCLING	263 SF
TRASH/RECYCLING	134 SF
	5,949 SF

RETAIL GFA	
RETAIL	3,500 SF
	3,500 SF

#### LEGEND

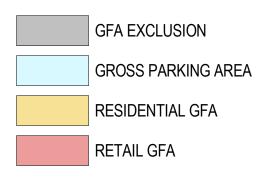



#### 2025 CLARENDON BLVD ARLINGTON, VA 22201 •


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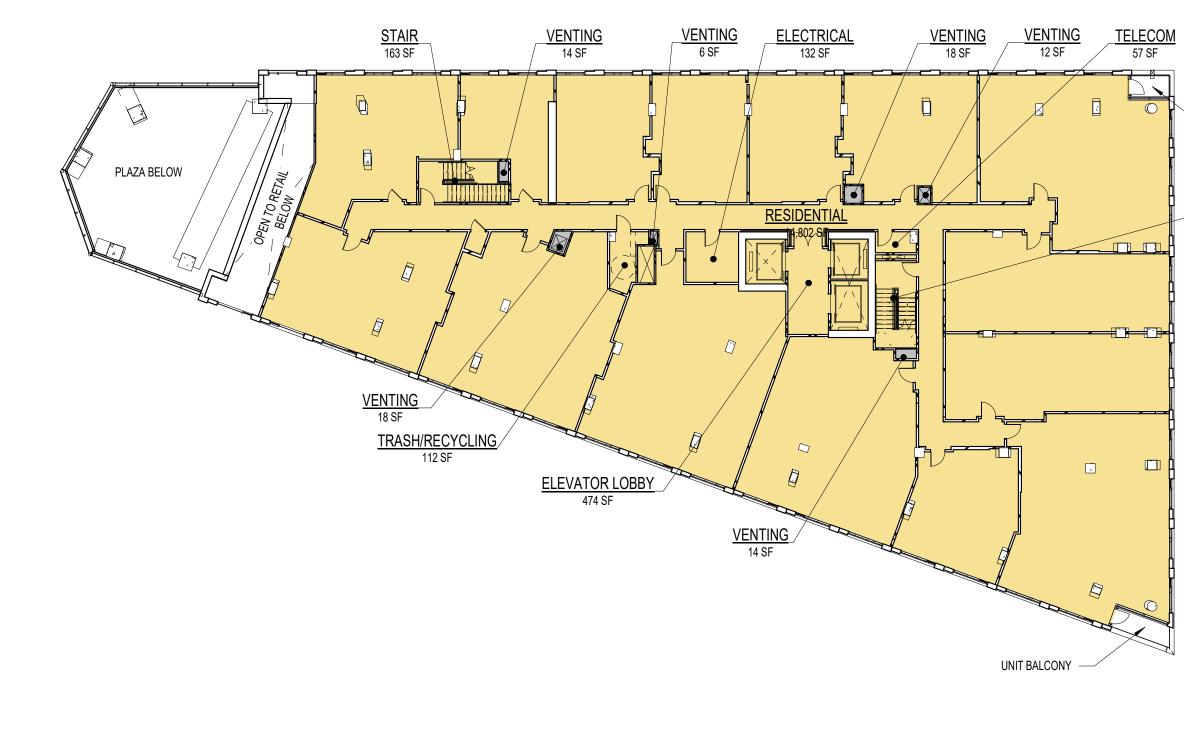
#### GFA DIAGRAMS AND TABULATIONS

TEVE SMITH	20200182
ncipal-in-Charge	Project No.
A/HL	07/30/2021
oject Manager	Date
G	
pject Architect	
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aff Architect	1 _ (i()();
	= 1 - G0.0

# È PROJECT NUMBER: 20200182 PROJECT NAME: 2025 CLARENDON BLVD SHEET NUMBER: 1 - G0.04 - GFA DIAGRAMS AND TABULATIONS C:\Users\zandian02396\Documents\20200182\_2021\_CH2\_





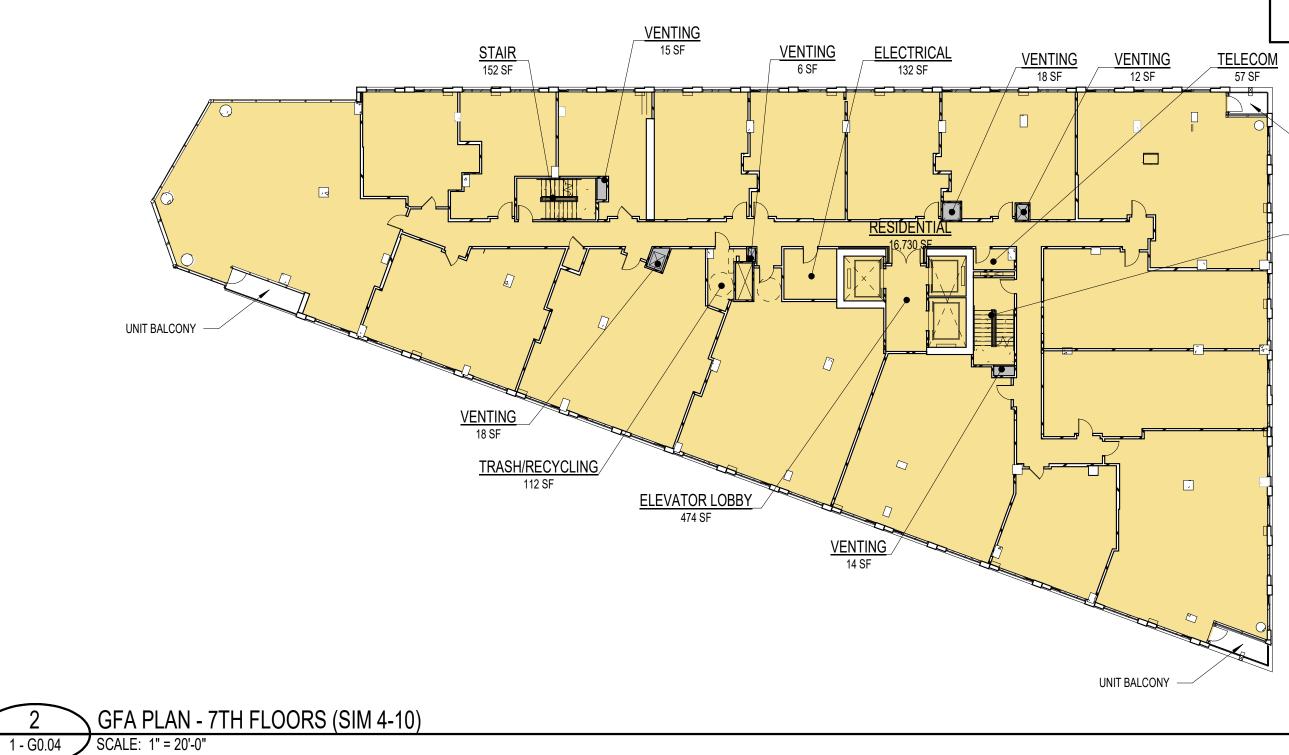

### GFA PLAN - 3RD FLOOR SCALE: 1" = 20'-0"

#### GENERAL NOTES

1. REFER TO G0.01 FOR TABULATIONS .

2. CORE ELEMENTS ARE SHOWN FOR REFERENCE AND ARE SUBJECT TO CHANGE.

3. AREAS ON G SERIES GFA PLANS FOLLOW ZONING AREA REQUIREMENTS WHICH ARE THE SUM OF THE AREA OF HORIZONTAL SURFACES OF SEVERAL FLOORS OF THE BUILDING MEASURED TO THE EXTERIOR FACE OF THE EXTERIOR WALLS MINUS GROSS PARKING AREAS AND OTHER COUNTY DEFINED EXCLUSIONS.

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5. RESIDENTIAL GFA VARIES ON EACH FLOOR BASED ON WEST FACADE EXTERIOR OUTLINE ON EACH FLOOR. FOR INDIVIDUAL FLOOR GFA REFER TO SHEET G0.01 DENSITY CHART.

INDIVIDUAL FLOOR GFA REFER TO	D SHEET GO.01 DENSITY CHART.	OR OUTLINE ON EACH FEO	JR. FUR	
	GFA AREAS - L	EVEL 7		
	TYPE	AREA	_	
		, , , , , , , , , , , , , , , , , , , ,		
UNIT BALCONY	GFA EXCLUSION			©ź
	VENTING	18 SF		
	VENTING	14 SF	×	SCOPE DOCUMENTS
STAIR	VENTING	18 SF		The Contract Documents Issued for [Conceptual Design
176 SF	VENTING	15 SF		Design, Design Development, Partial Construction Docu Issuance up to Issued for Construction] are intended to
	VENTING	6 SF		development and as such, may be neither complete nor
	VENTING	12 SF		[Construction Manager, Contractor, Design/Builder] is re complete and coordinated pricing [and execution] of the
		83 SF		include items necessary for the proper execution and co Work, as shown, specified, reasonably inferred or requi
				Project. For Work of delegated designs; systems, asse
	RESIDENTIAL GFA	132 SF		components and materials shall comply with national, s requirements. The [Construction Manager, Contractor,
	ELECTRICAL ELEVATOR LOBBY	474 SF	Ъ	shall inform the Owner and Architect, in timely fashion, omissions, inconsistencies or errors in the Contract Do
	RESIDENTIAL	16,730 SF		omissions, inconsistencies of errors in the contract bo
	STAIR	152 SF		
	STAIR	176 SF		
	TELECOM	57 SF	_	ISSUANCES
	TRASH/RECYCLING	112 SF		No. Drawing Issue Description
		17,832 SF		4.1 SUBMISSION
		17,002 01		4.1 SUBMISSION
			E E	4.1 SUBMISSION 4.1 SUBMISSION
			ப	
			Ē	
	GFA AREAS - L	EVEL 3		
	TYPE	AREA		
UNIT BALCONY	GFA EXCLUSION			
	VENTING	18 SF		
	VENTING	14 SF	ш	
07.415	VENTING	18 SF		
<u>STAIR</u> 174 SF	VENTING	14 SF		
	VENTING	6 SF		
	VENTING	12 SF		
		82 SF		
	<b>RESIDENTIAL GFA</b>			2025 CLARENDON
	ELECTRICAL	132 SF		
	ELEVATOR LOBBY	474 SF		
	RESIDENTIAL	14,802 SF		
	STAIR	163 SF		
	STAIR	174 SF		
	TELECOM	57 SF		
	TRASH/RECYCLING	112 SF		2025 CLARENDON B
		15,914 SF		ARLINGTON, VA 222
		10,014 01		• · · · · · · · · · · · · · · · · · · ·
			ပ	
				GREYSTAR
				GFA DIAGRAMS /
				TABULATIONS
			m	
	LEGEND			
				STEVE SMITH 20200182
	GFA EXCLUSIO	N		Principal-in-Charge Project No.
				NA/HL 07/30/2021
	GROSS PARKIN	NG AREA		Project Manager Date
				MG
	RESIDENTIAL C	JFA		Project Architect
	RETAIL GFA			SG
			A	Staff Architect

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Date

04.16.2021

06.11.2021 02.07.2022 02.25.2022

ssued for [Conceptual Design, Schematic ent, Partial Construction Documents or Other Construction] are intended to be at that level of , may be neither complete nor coordinated. The ontractor, Design/Builder] is responsible for I pricing [and execution] of the Work, and shall or the proper execution and completion of the , reasonably inferred or required for a complete gated designs; systems, assemblies, s shall comply with national, state and local code truction Manager, Contractor, Design/Builder] Architect, in timely fashion, of any discovered s or errors in the Contract Documents.

COOPER CARRY

THE CENTER FOR CONNECTIVE ARCHITECTURE


#### LARENDON BLVD


#### CLARENDON BLVD NGTON, VA 22201


#### DIAGRAMS AND BULATIONS

#### 20200182 Project No. 07/30/2021 Date - G0.04

# MA PROJECT NUMBER: 20200182 PROJECT NAME: 2025 CLARENDON BLVD SHEET NUMBER: 1 - G0.05 - GFA DIAGRAMS AND TABULATIONS C:\Users\zandian02396\Documents\20200182\_2021\_CH2\_ 2/25/2022 3:59:47 PM

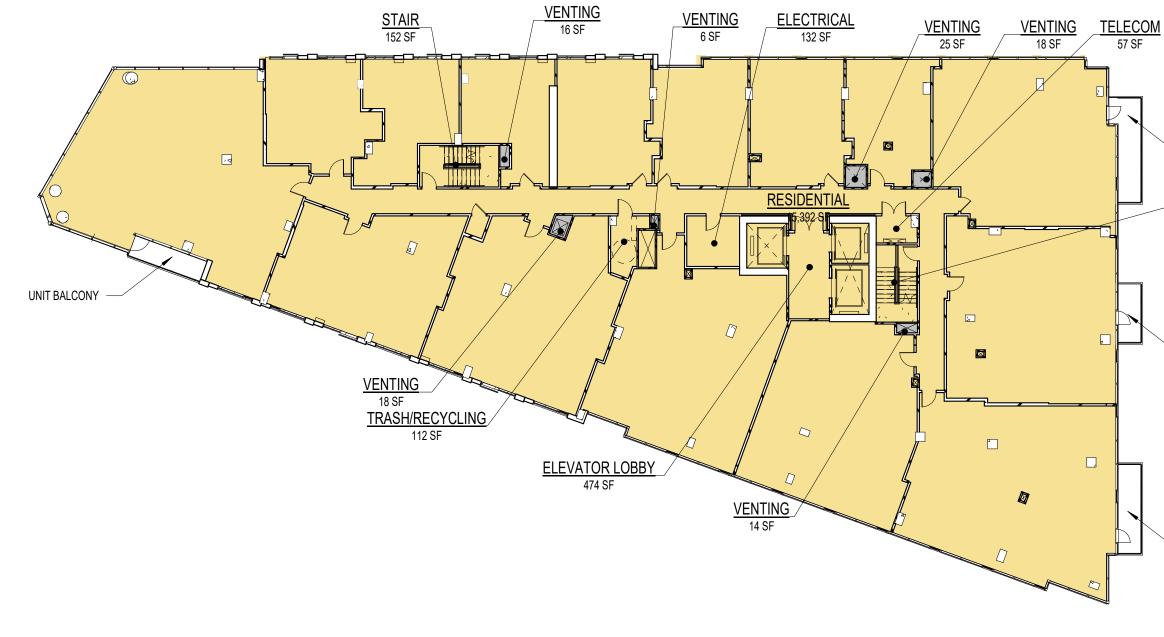

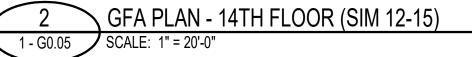


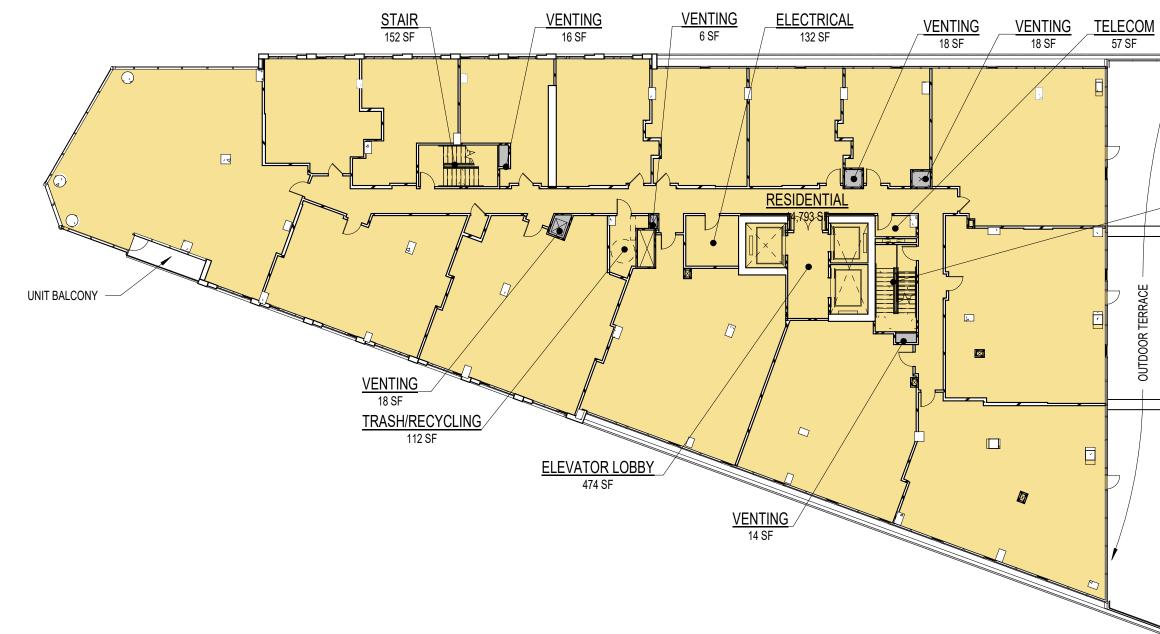


### 1 - G0.05 GFA PLAN - 11TH FLOOR SCALE: 1" = 20'-0"

			COOPER CARRY
HORIZONTAL SURFACES OF SEVE EXTERIOR WALLS MINUS GROSS F	S FOLLOW ZONING AREA REQUIREMENTS WHI RAL FLOORS OF THE BUILDING MEASURED TO PARKING AREAS AND OTHER COUNTY DEFINED , SEE SHEET G0.01 FOR GFA TOTALS.	THE EXTERIOR FACE OF THE	THE CENTER FOR CONNECTIVE ARCHITECTUR
	ACH FLOOR BASED ON WEST FACADE EXTERIO	OR OUTLINE ON EACH FLOOR. FOF	۲   - <sup></sup>
	GFA AREAS - LEY	VELS 14	
	TYPE	AREA	_
	GFA EXCLUSION		
UNIT BALCONY	VENTING	18 SF	©2021 COOPER CAR
	VENTING VENTING	14 SF 25 SF	The Contract Documents Issued for [Conceptual Design, Schematic
STAIR 155 SF	VENTING	16 SF	Design, Design Development, Partial Construction Documents or Other Issuance up to Issued for Construction] are intended to be at that level of
	VENTING VENTING	6 SF 18 SF	development and as such, may be neither complete nor coordinated. The [Construction Manager, Contractor, Design/Builder] is responsible for
		97 SF	complete and coordinated pricing [and execution] of the Work, and shall include items necessary for the proper execution and completion of the Work, as shown, specified, reasonably inferred or required for a complete
UNIT BALCONY	RESIDENTIAL GFA ELECTRICAL ELEVATOR LOBBY RESIDENTIAL STAIR	132 SF 474 SF 15,392 SF 152 SF	Project. For Work of delegated designs; systems, assemblies, components and materials shall comply with national, state and local code requirements. The [Construction Manager, Contractor, Design/Builder] shall inform the Owner and Architect, in timely fashion, of any discovered omissions, inconsistencies or errors in the Contract Documents.
	STAIR TELECOM	155 SF 57 SF	ISSUANCES
	TRASH/RECYCLING	112 SF	No.         Drawing Issue Description         Date           4.1 SUBMISSION         04.16.202
		16,474 SF	4.1 SUBMISSION         04.10.202           4.1 SUBMISSION         06.11.202           4.1 SUBMISSION         02.07.202
UNIT BALCONY			
			_
STAIR 176 SF	GFA AREAS - LEY TYPE GFA EXCLUSION VENTING VENTING VENTING VENTING VENTING	AREA 18 SF 14 SF 18 SF 16 SF 6 SF	
	TYPE GFA EXCLUSION VENTING VENTING VENTING VENTING	AREA 18 SF 14 SF 18 SF 18 SF 16 SF	
	TYPE GFA EXCLUSION VENTING VENTING VENTING VENTING VENTING VENTING	AREA 18 SF 14 SF 18 SF 16 SF 6 SF 18 SF	
	TYPE GFA EXCLUSION VENTING VENTING VENTING VENTING VENTING	AREA 18 SF 14 SF 18 SF 16 SF 6 SF 18 SF	2025 CLARENDON BLVD
	TYPE GFA EXCLUSION VENTING VENTING VENTING VENTING VENTING VENTING VENTING RESIDENTIAL GFA ELECTRICAL ELEVATOR LOBBY RESIDENTIAL STAIR STAIR	AREA         18 SF         14 SF         18 SF         18 SF         16 SF         6 SF         18 SF         90 SF         132 SF         474 SF         14,793 SF         152 SF         176 SF	L 2025 CLARENDON BLVD
	TYPE GFA EXCLUSION VENTING VENTING VENTING VENTING VENTING VENTING RESIDENTIAL GFA ELECTRICAL ELEVATOR LOBBY RESIDENTIAL STAIR	AREA         18 SF         14 SF         18 SF         16 SF         6 SF         18 SF         90 SF         132 SF         474 SF         14,793 SF         152 SF	≏  2025 CLARENDON BLVD
	TYPE GFA EXCLUSION VENTING VENTING VENTING VENTING VENTING VENTING VENTING RESIDENTIAL GFA ELECTRICAL ELEVATOR LOBBY RESIDENTIAL STAIR STAIR TELECOM	AREA         18 SF         14 SF         18 SF         18 SF         16 SF         6 SF         18 SF         90 SF         132 SF         474 SF         14,793 SF         176 SF         57 SF	
	TYPE GFA EXCLUSION VENTING VENTING VENTING VENTING VENTING VENTING VENTING RESIDENTIAL GFA ELECTRICAL ELEVATOR LOBBY RESIDENTIAL STAIR STAIR TELECOM	AREA         18 SF         14 SF         18 SF         16 SF         6 SF         18 SF         90 SF         132 SF         474 SF         14,793 SF         152 SF         176 SF         57 SF         112 SF	2025 CLARENDON BLVD
	TYPE GFA EXCLUSION VENTING VENTING VENTING VENTING VENTING VENTING VENTING RESIDENTIAL GFA ELECTRICAL ELEVATOR LOBBY RESIDENTIAL STAIR STAIR TELECOM	AREA         18 SF         14 SF         18 SF         16 SF         6 SF         18 SF         90 SF         132 SF         474 SF         14,793 SF         152 SF         176 SF         57 SF         112 SF	□ 2025 CLARENDON BLVD ARLINGTON, VA 22201 ↓ GREYSTAR
	TYPE GFA EXCLUSION VENTING VENTING VENTING VENTING VENTING VENTING VENTING RESIDENTIAL GFA ELECTRICAL ELEVATOR LOBBY RESIDENTIAL STAIR STAIR TELECOM	AREA         18 SF         14 SF         18 SF         16 SF         6 SF         18 SF         90 SF         132 SF         474 SF         14,793 SF         152 SF         176 SF         57 SF         112 SF	2025 CLARENDON BLVD ARLINGTON, VA 22201 ◆
	TYPE GFA EXCLUSION VENTING VENTING VENTING VENTING VENTING VENTING VENTING RESIDENTIAL GFA ELECTRICAL ELEVATOR LOBBY RESIDENTIAL STAIR STAIR TELECOM	AREA         18 SF         14 SF         18 SF         16 SF         6 SF         18 SF         90 SF         132 SF         474 SF         14,793 SF         152 SF         176 SF         57 SF         112 SF	2025 CLARENDON BLVD ARLINGTON, VA 22201 GREYSTAR GFA DIAGRAMS AND
	TYPE GFA EXCLUSION VENTING VENTING VENTING VENTING VENTING VENTING RESIDENTIAL GFA ELECTRICAL ELEVATOR LOBBY RESIDENTIAL STAIR STAIR TELECOM TRASH/RECYCLING	AREA         18 SF         14 SF         18 SF         16 SF         6 SF         18 SF         90 SF         132 SF         474 SF         14,793 SF         152 SF         176 SF         57 SF         112 SF         15,896 SF	Constant of the second
	TYPE GFA EXCLUSION VENTING VENTING VENTING VENTING VENTING VENTING VENTING RESIDENTIAL GFA ELECTRICAL ELEVATOR LOBBY RESIDENTIAL STAIR TELECOM TRASH/RECYCLING <b>LEGEND</b>	AREA         18 SF         14 SF         18 SF         16 SF         6 SF         18 SF         90 SF         132 SF         474 SF         14,793 SF         152 SF         176 SF         57 SF         112 SF         15,896 SF	2025 CLARENDON BLVD ARLINGTON, VA 22201 GREYSTAR GFA DIAGRAMS AND TABULATIONS
	TYPE GFA EXCLUSION VENTING VENTING VENTING VENTING VENTING VENTING VENTING RESIDENTIAL GFA ELECTRICAL ELEVATOR LOBBY RESIDENTIAL STAIR TELECOM TRASH/RECYCLING IELECOM TRASH/RECYCLING	AREA         18 SF         14 SF         18 SF         16 SF         6 SF         18 SF         90 SF         132 SF         474 SF         14,793 SF         152 SF         176 SF         57 SF         112 SF         15,896 SF	Constant of the second
	TYPE GFA EXCLUSION VENTING VENTING VENTING VENTING VENTING VENTING VENTING RESIDENTIAL GFA ELECTRICAL ELEVATOR LOBBY RESIDENTIAL STAIR TELECOM TRASH/RECYCLING <b>LEGEND</b>	AREA         18 SF         14 SF         18 SF         16 SF         6 SF         18 SF         90 SF         132 SF         474 SF         14,793 SF         152 SF         176 SF         57 SF         112 SF         15,896 SF	C 2025 CLARENDON BLVD ARLINGTON, VA 22201 ◆ GREYSTAR GFA DIAGRAMS AND TABULATIONS C 2020182 Principal-in-Charge 20200182 Principal-in-Charge 20200182


# MA PROJECT NUMBER: 20200182 PROJECT NAME: 2025 CLARENDON BLVD SHEET NUMBER: 1 - G0.06 - GFA DIAGRAMS AND TABULATIONS C:\Users\zandian02396\Documents\20200182\_2021\_CH2\_ 2/25/2022 3:59:49 PM

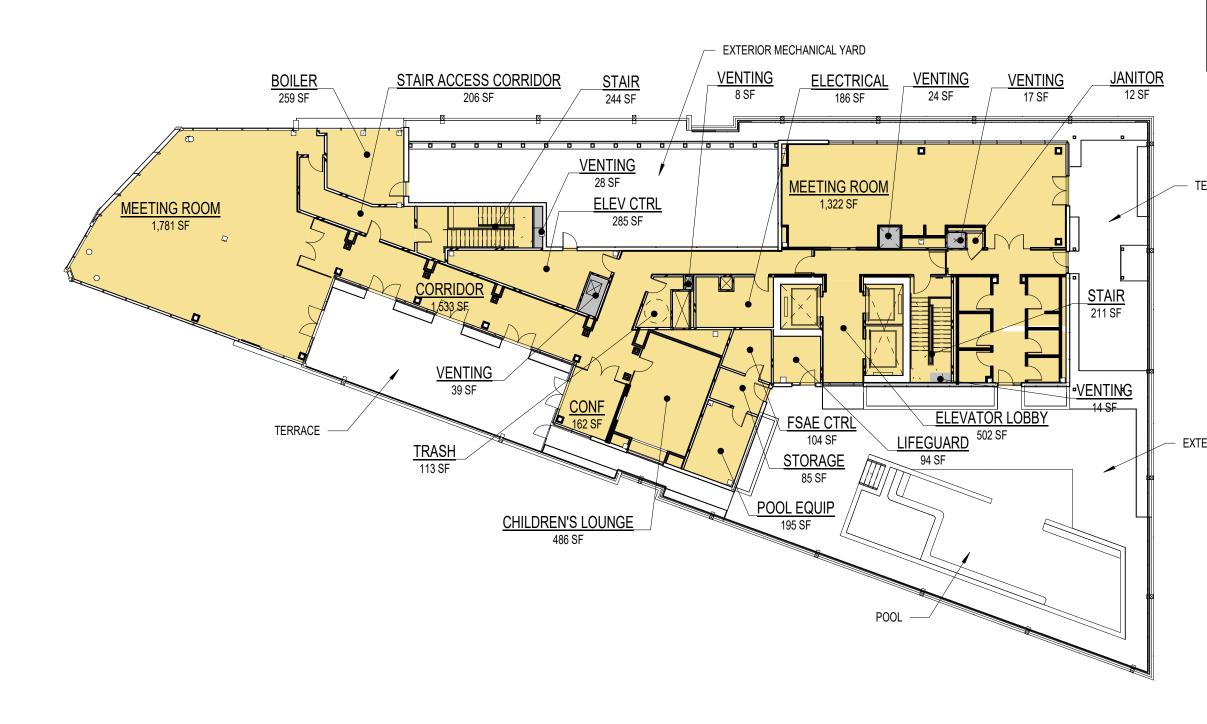




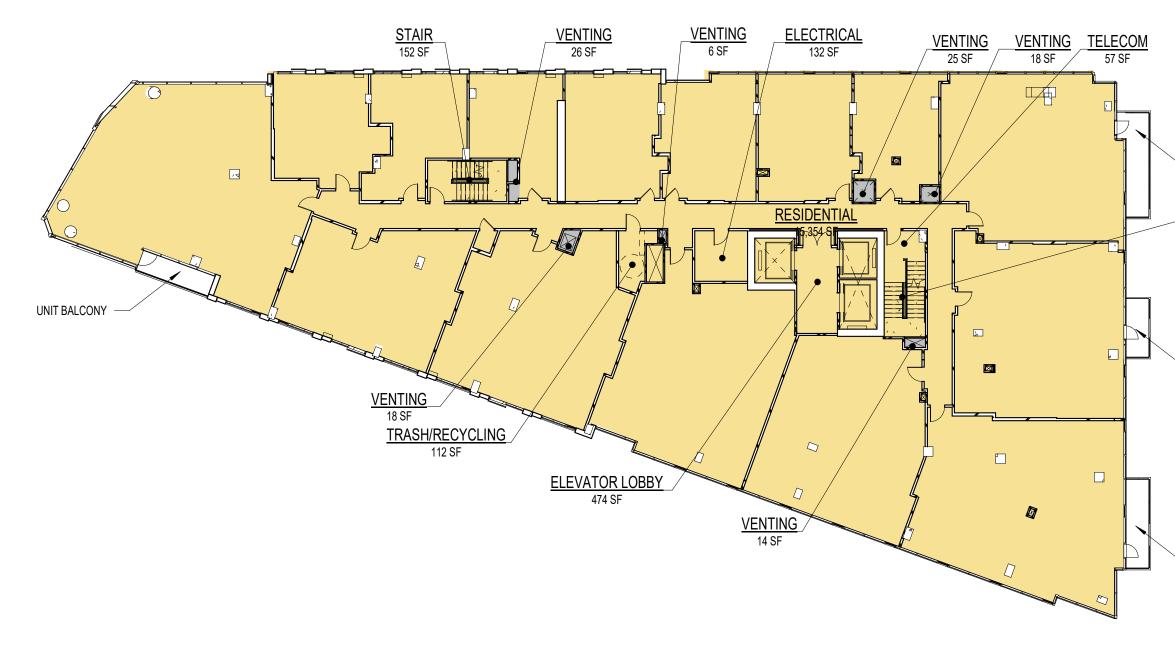


13	14	15	
GENERAL NOTES			
1. REFER TO G0.01 FOR TABUL	ATIONS .		
2. CORE ELEMENTS ARE SHOW	VN FOR REFERENCE AND ARE SUBJECT TO CHANG	E.	COOPER CARRY
HORIZONTAL SURFACES OF S	ANS FOLLOW ZONING AREA REQUIREMENTS WHIC EVERAL FLOORS OF THE BUILDING MEASURED TO T SS PARKING AREAS AND OTHER COUNTY DEFINED	THE EXTERIOR FACE OF THE	THE CENTER FOR CONNECTIVE ARCHITECTURE
4. FOR (SIM) FLOORS NOT SHO	WN, SEE SHEET G0.01 FOR GFA TOTALS.		
	N EACH FLOOR BASED ON WEST FACADE EXTERIO R TO SHEET G0.01 DENSITY CHART.	R OUTLINE ON EACH FLOOR. FOR	
	GFA AREAS - LEV	/FL PH	
	ТҮРЕ	AREA	
TERRACE	GFA EXCLUSION	8 SF	©2021 COOPER CARRY
	VENTING	28 SF	SCOPE DOCUMENTS
	VENTING	24 SF	The Contract Documents Issued for [Conceptual Design, Schematic Design, Design Development, Partial Construction Documents or Other
	VENTING VENTING	14 SF 39 SF	Issuance up to Issued for Construction] are intended to be at that level of development and as such, may be neither complete nor coordinated. The
	VENTING	17 SF	[Construction Manager, Contractor, Design/Builder] is responsible for complete and coordinated pricing [and execution] of the Work, and shall
		131 SF	include items necessary for the proper execution and completion of the Work, as shown, specified, reasonably inferred or required for a complete
	<b>RESIDENTIAL GFA</b>		Project. For Work of delegated designs; systems, assemblies, components and materials shall comply with national, state and local code
	BOILER	259 SF	shall inform the Owner and Architect, in timely fashion, of any discovered
KTERIOR POOL DECK	CHILDREN'S LOUNGE CONF	486 SF 162 SF	omissions, inconsistencies or errors in the Contract Documents.
	CORRIDOR	1,533 SF	
	ELECTRICAL	186 SF	ISSUANCES
	ELEV CTRL ELEVATOR LOBBY	285 SF 502 SF	No. Drawing Issue Description Date
	FSAE CTRL	104 SF	4.1 SUBMISSION         04.16.2021           4.1 SUBMISSION         06.11.2021
	JANITOR LIFEGUARD	12 SF 94 SF	4.1 SUBMISSION         02.07.2022           4.1 SUBMISSION         02.25.2022
	MEETING ROOM	1,781 SF	
	MEETING ROOM	1,322 SF	
	MEN'S LOCKER ROOM POOL EQUIP	223 SF 195 SF	
	STAIR	244 SF	
	STAIR STAIR ACCESS	211 SF 206 SF	
	CORRIDOR		ن ع
	STORAGE TRASH	85 SF 113 SF	
	WOMEN'S LOCKER	210 SF	
	ROOM	8,213 SF	
	GFA AREAS - LEV TYPE	ELS 16	
	GFA EXCLUSION		
<	VENTING	18 SF	
UNIT BALCONY	VENTING	14 SF	μ
STAIR 156 SF	VENTING VENTING	25 SF 26 SF	
100 01	VENTING	6 SF	
	VENTING	18 SF 106 SF	
UNIT BALCONY	RESIDENTIAL GFA ELECTRICAL ELEVATOR LOBBY RESIDENTIAL STAIR STAIR TELECOM TRASH/RECYCLING	132 SF 474 SF 15,354 SF 152 SF 156 SF 57 SF 112 SE	2025 CLARENDON BLVD 2025 CLARENDON BLVD
	I KAOH/KEUYULING	112 SF 16,436 SF	ARLINGTON, VA 22201
			υ <b>♦</b>
UNIT BALCONY			GREYSTAR
			GFA DIAGRAMS AND
			TABULATIONS
	LEGEND		œ
		I	STEVE SMITH 20200182
	GFA EXCLUSION		Principal-in-Charge Project No. NA/HL 07/30/2021
	GROSS PARKING	G AREA	Project Manager Date
	RESIDENTIAL G	Ā	MG Project Architect
	RETAIL GFA		SG Staff Architect 1 - G0.06

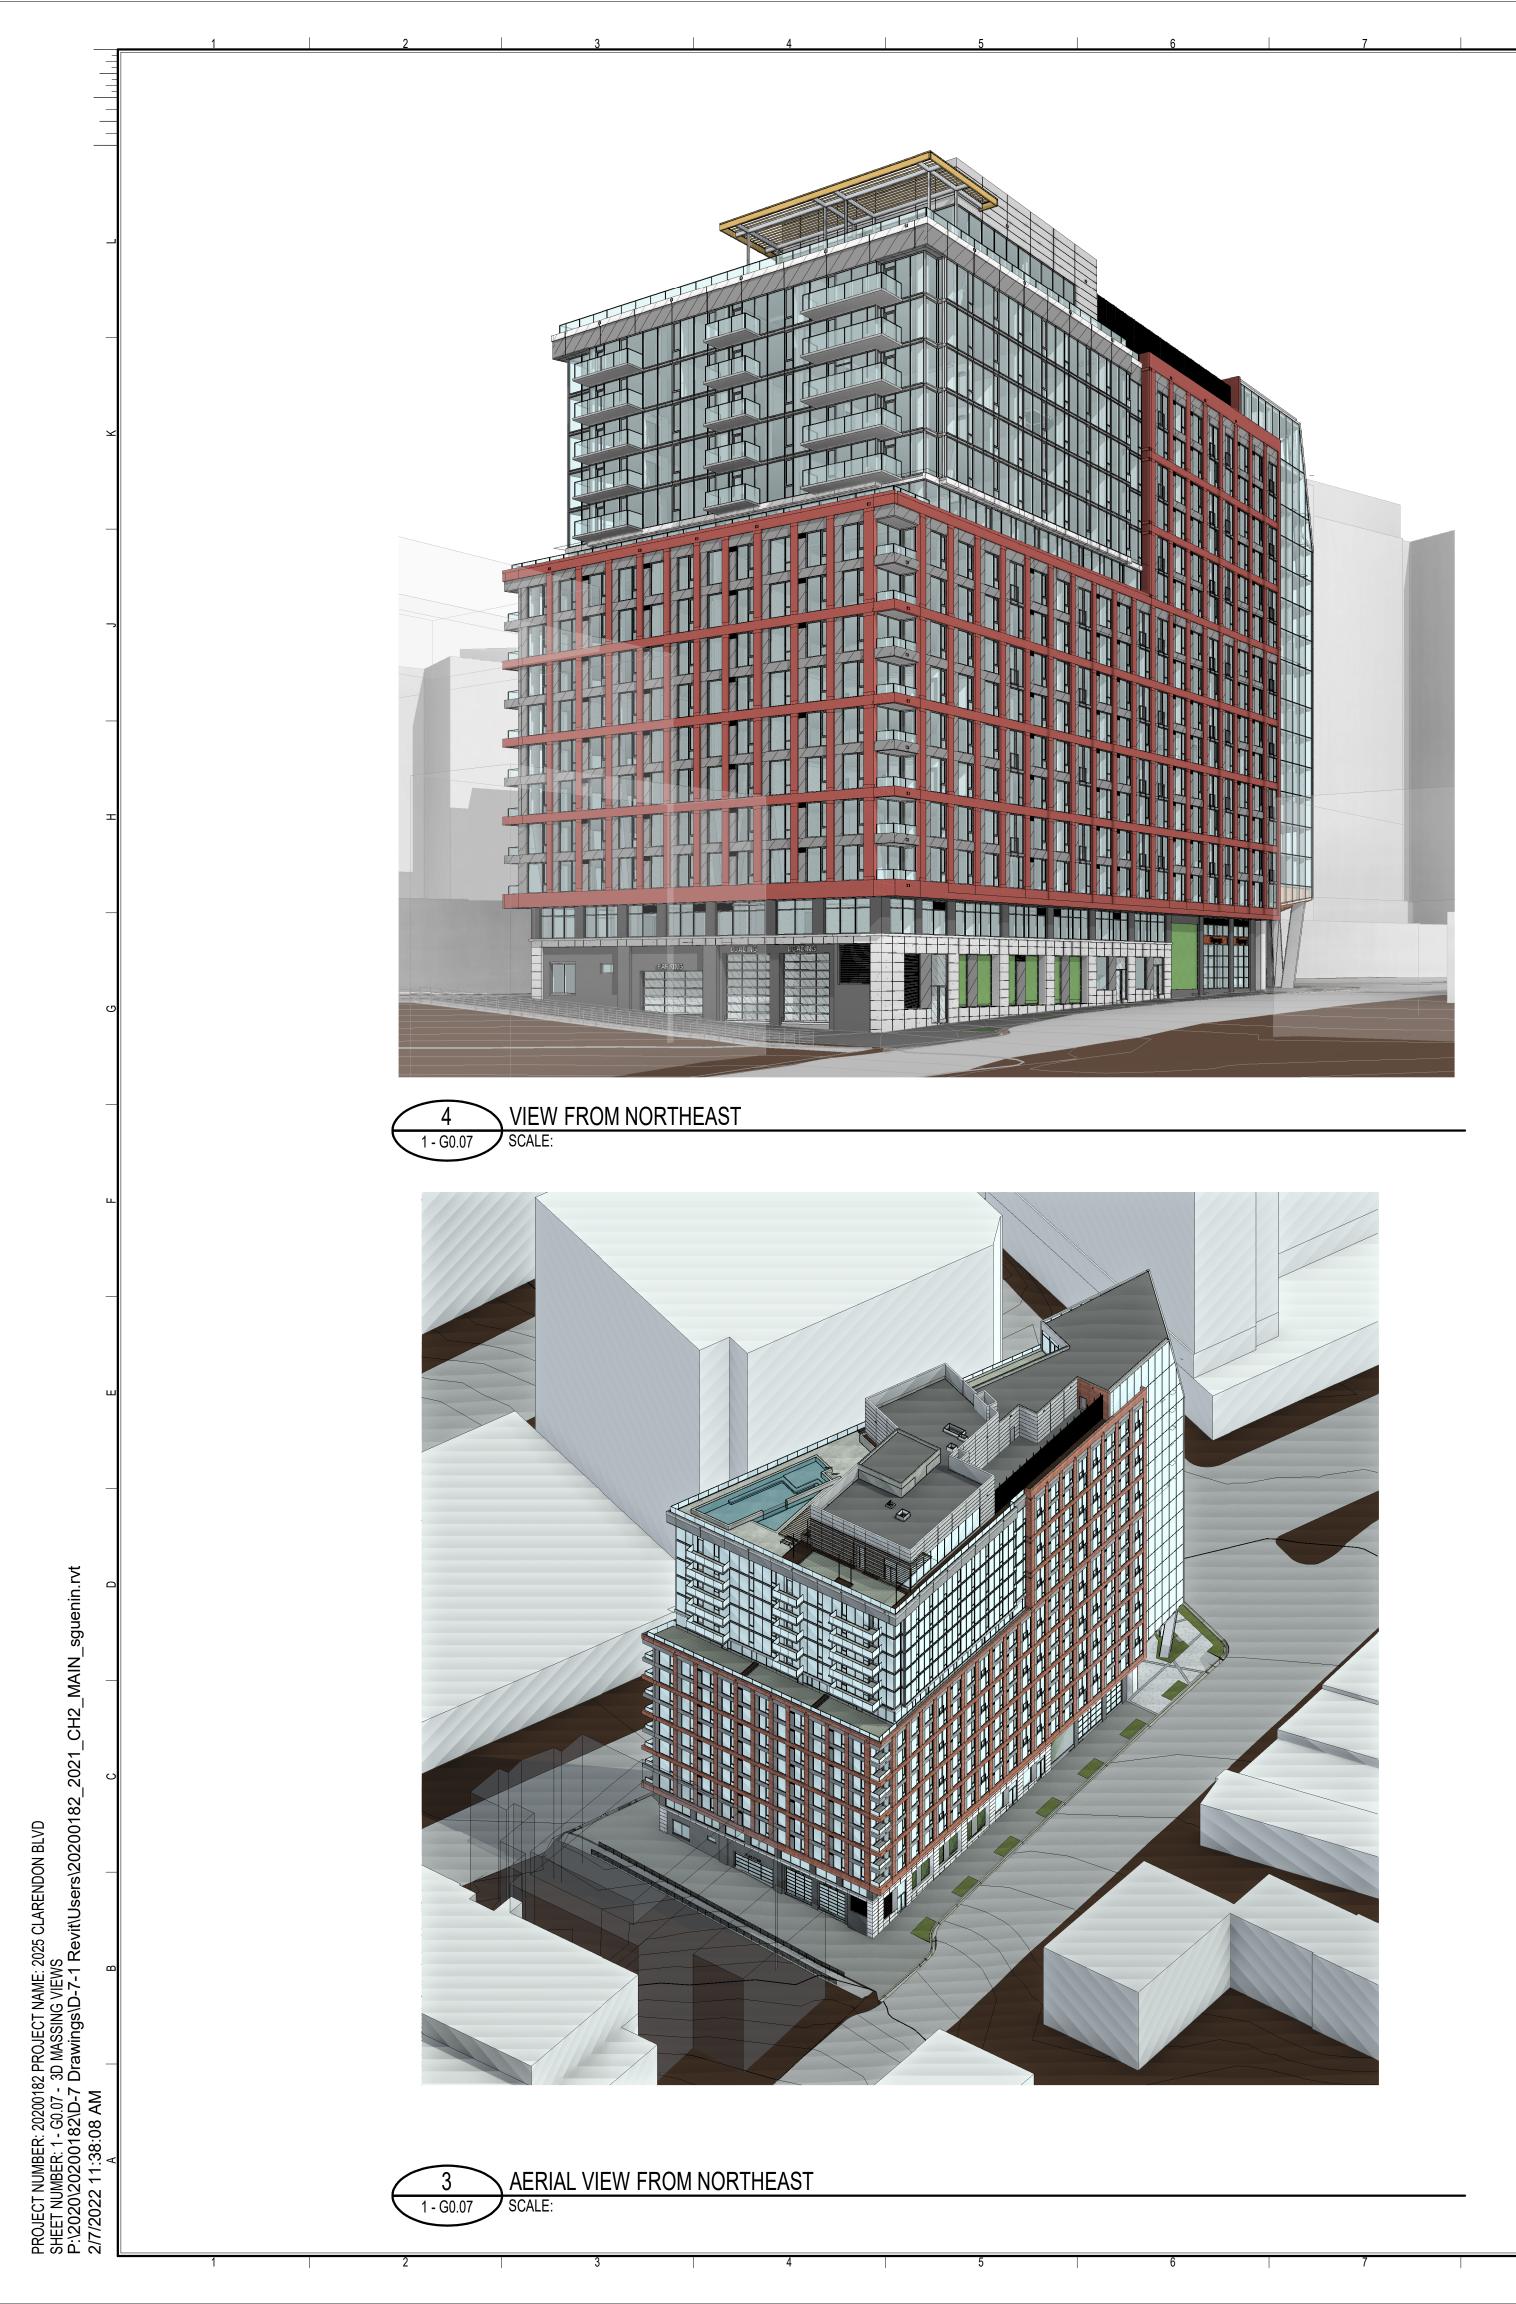


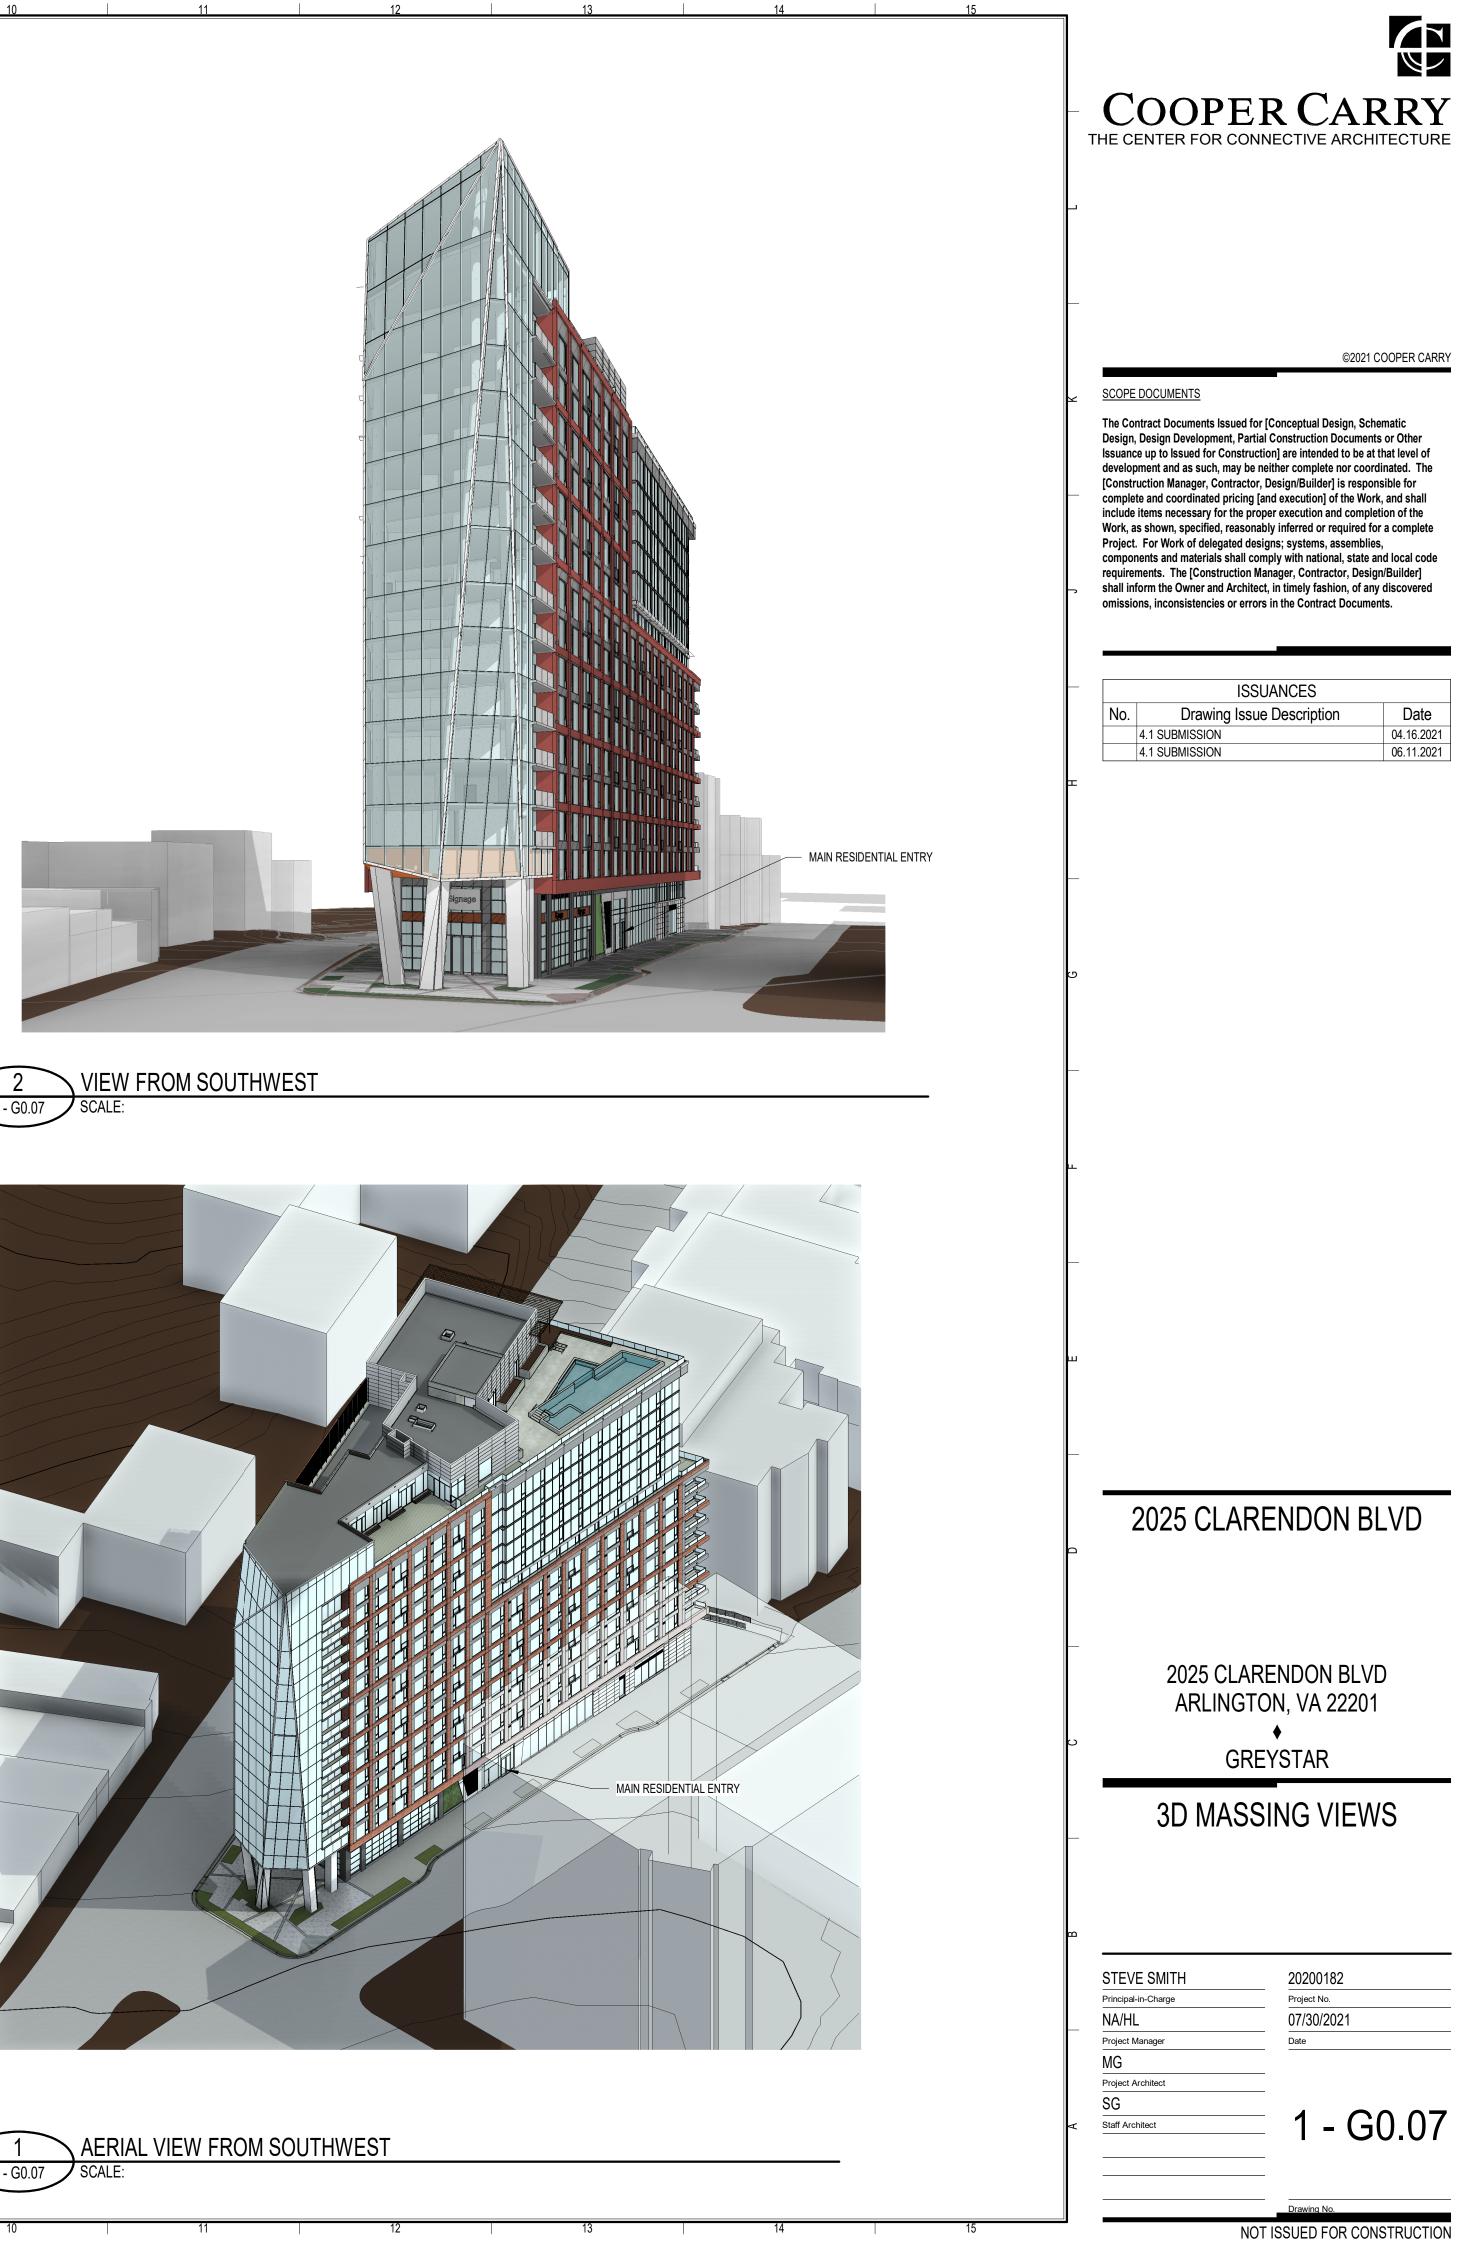





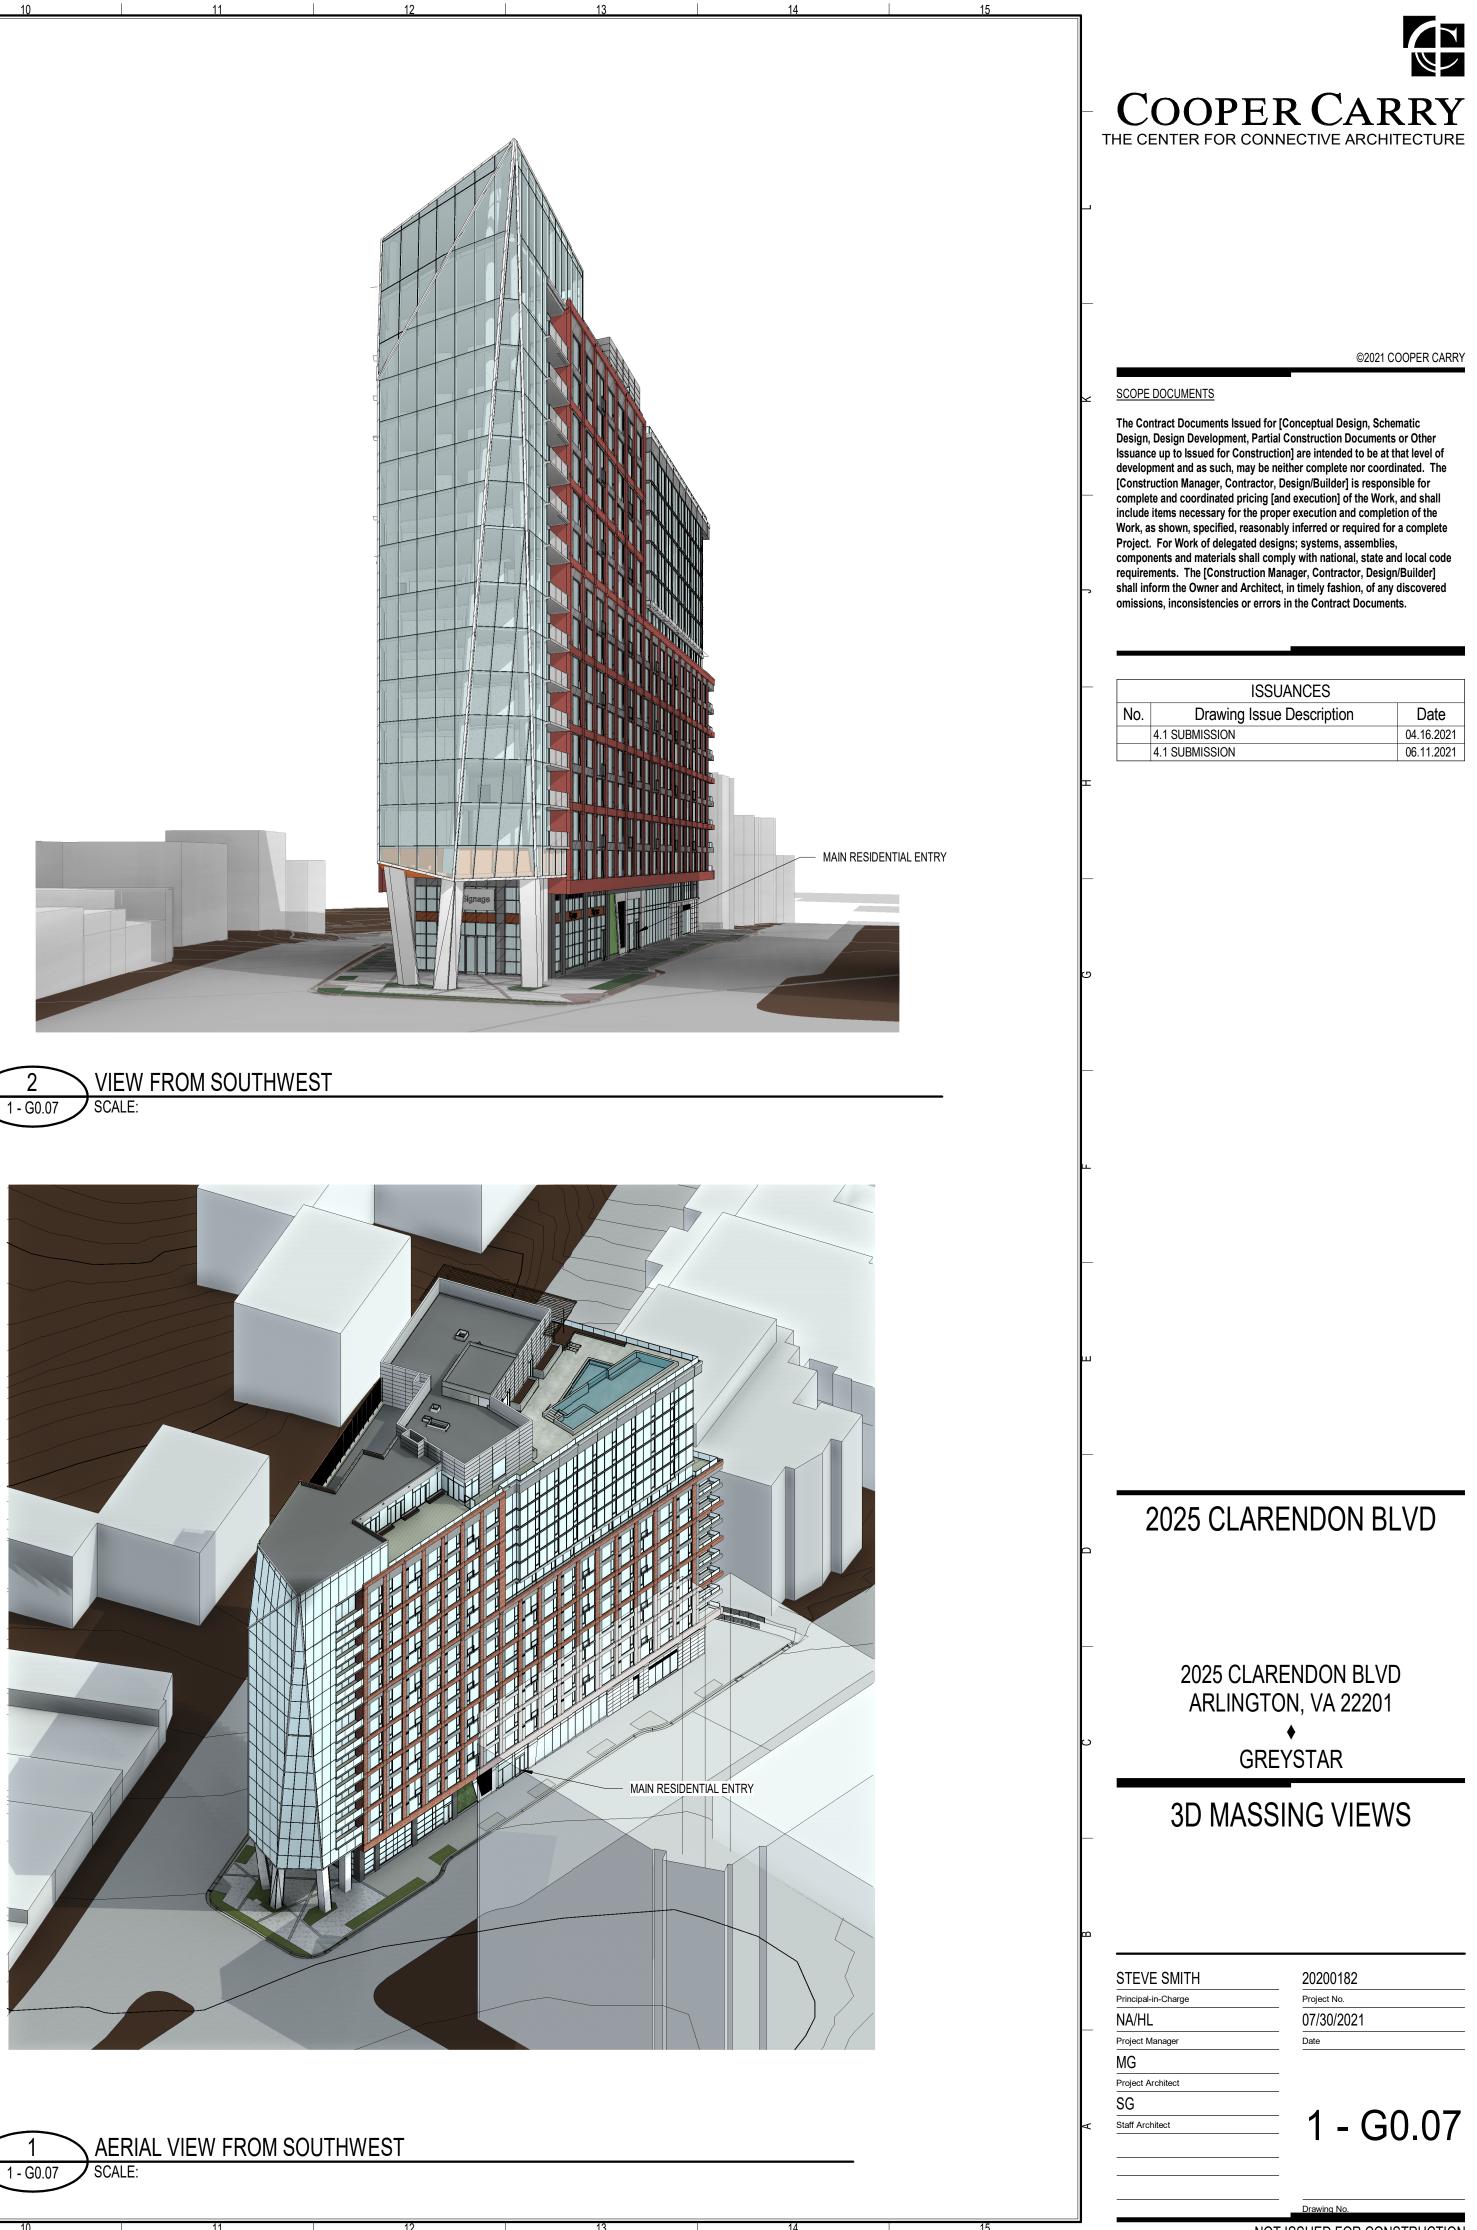




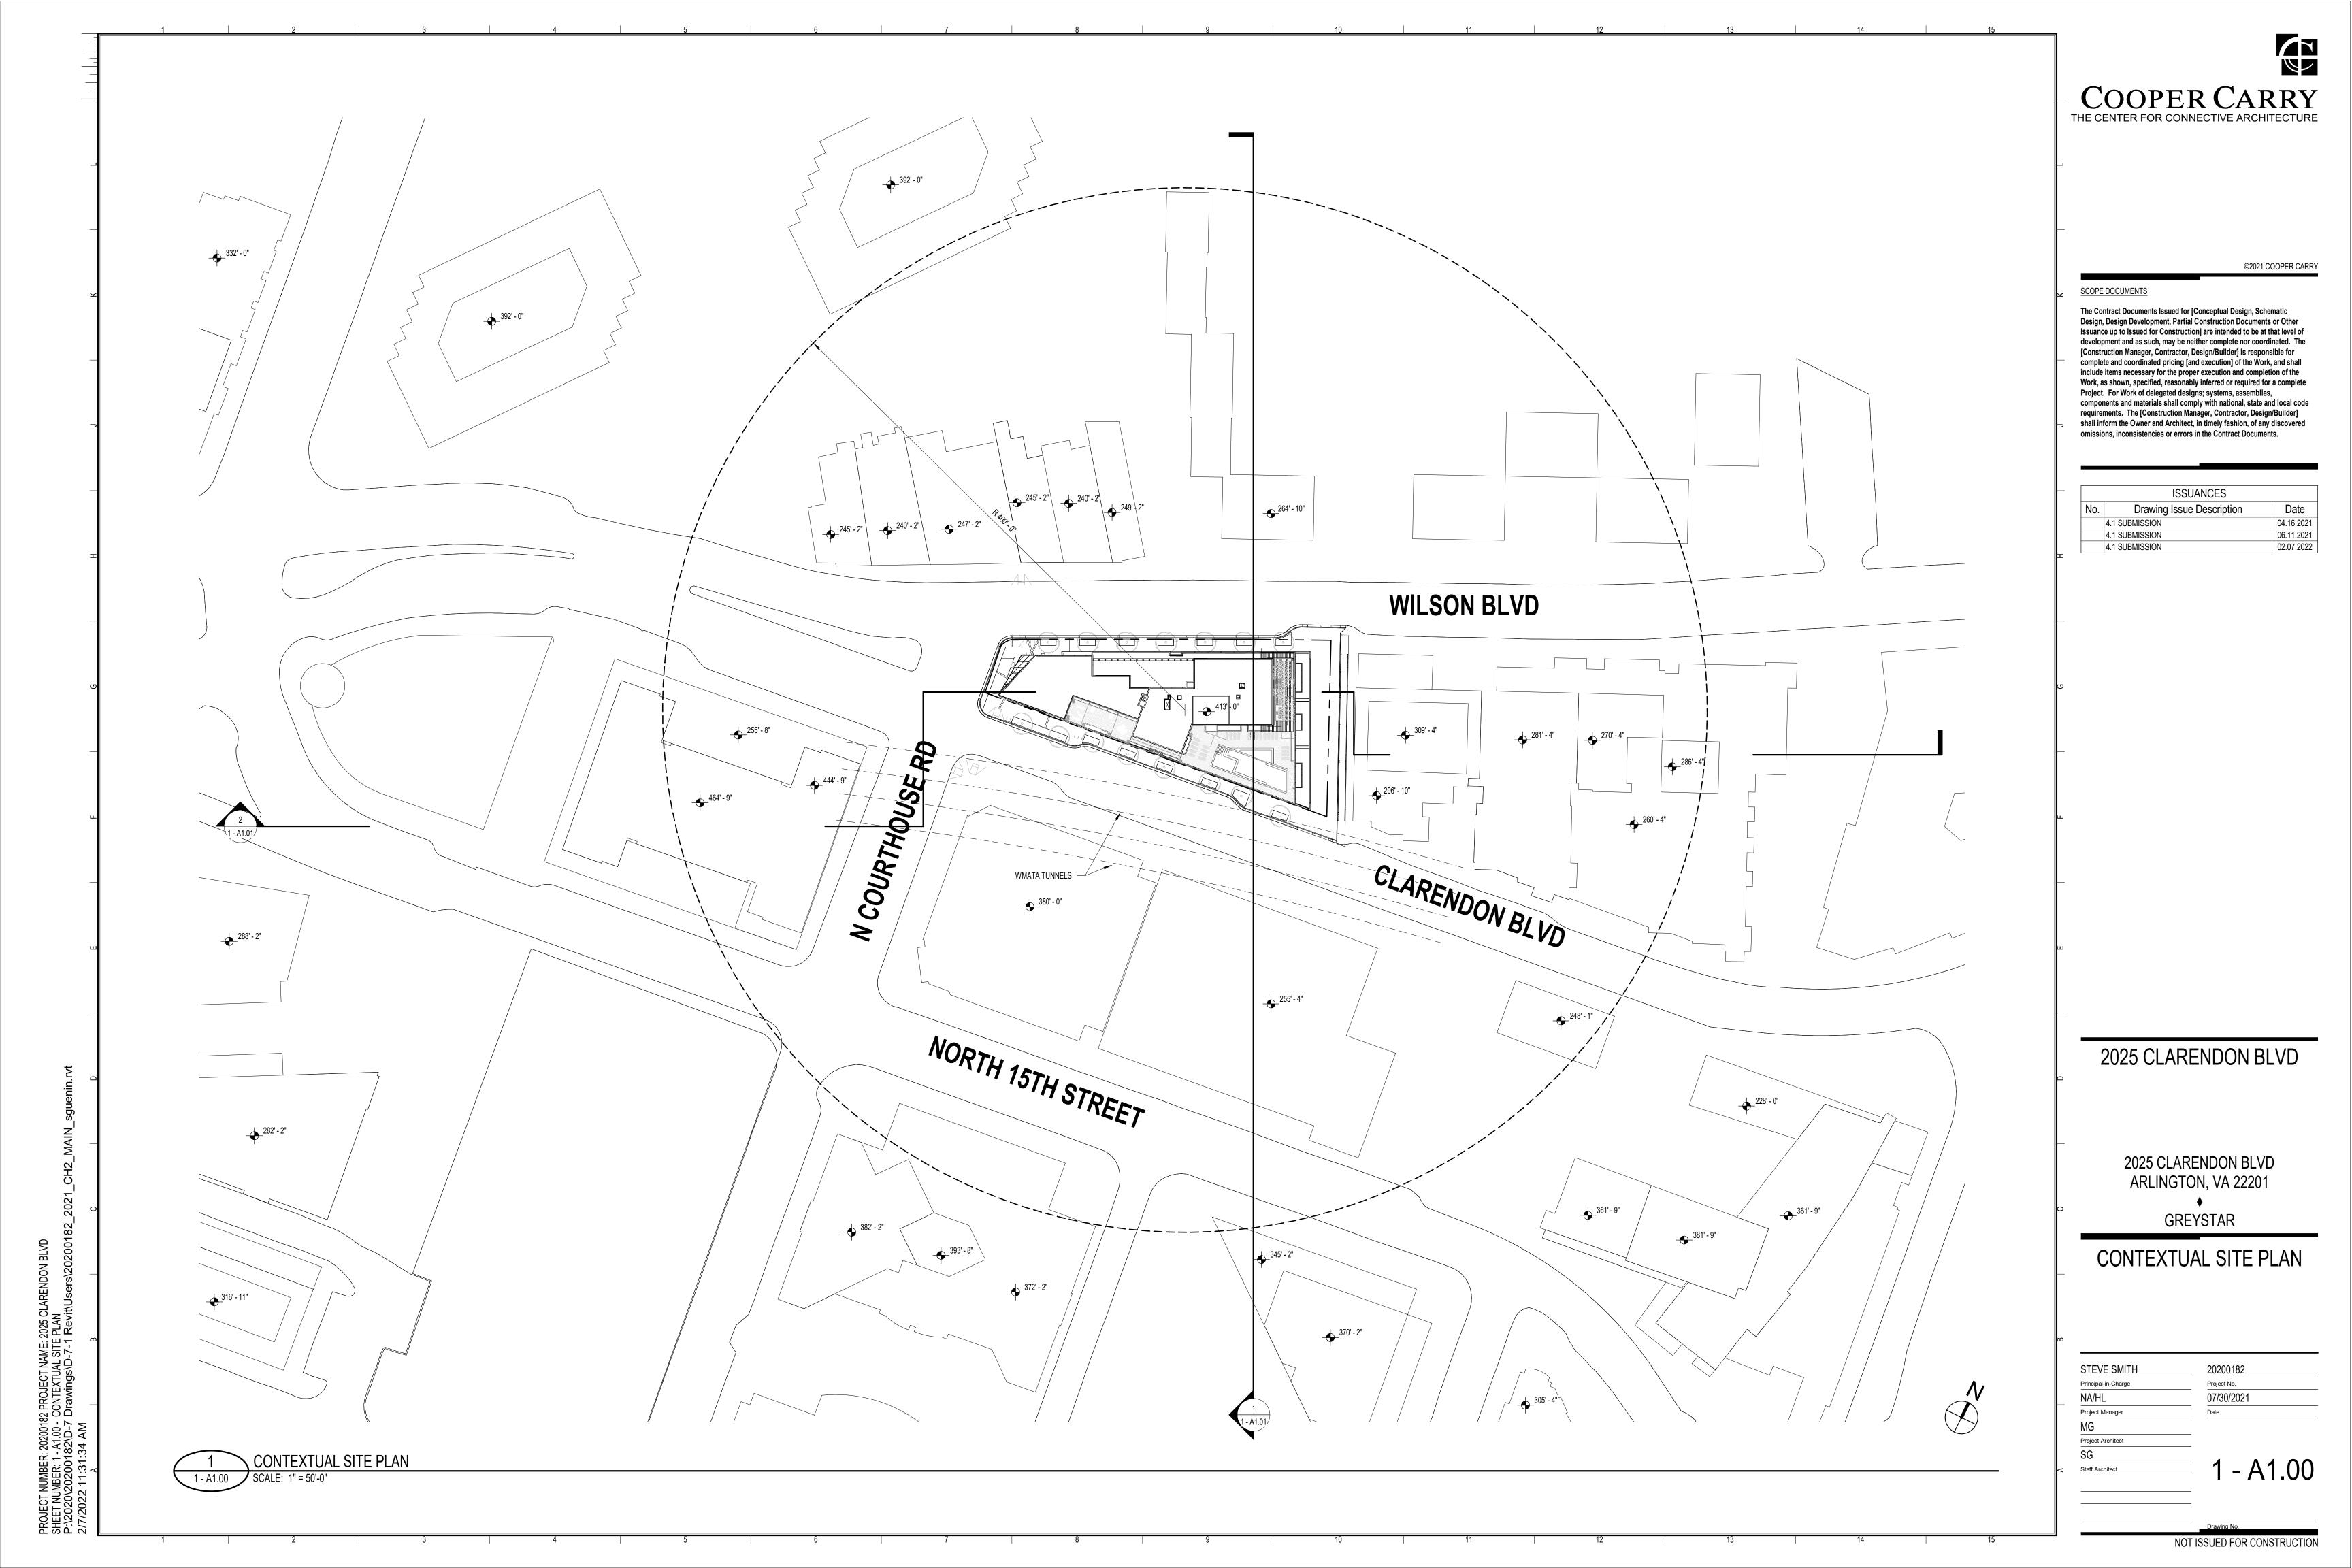

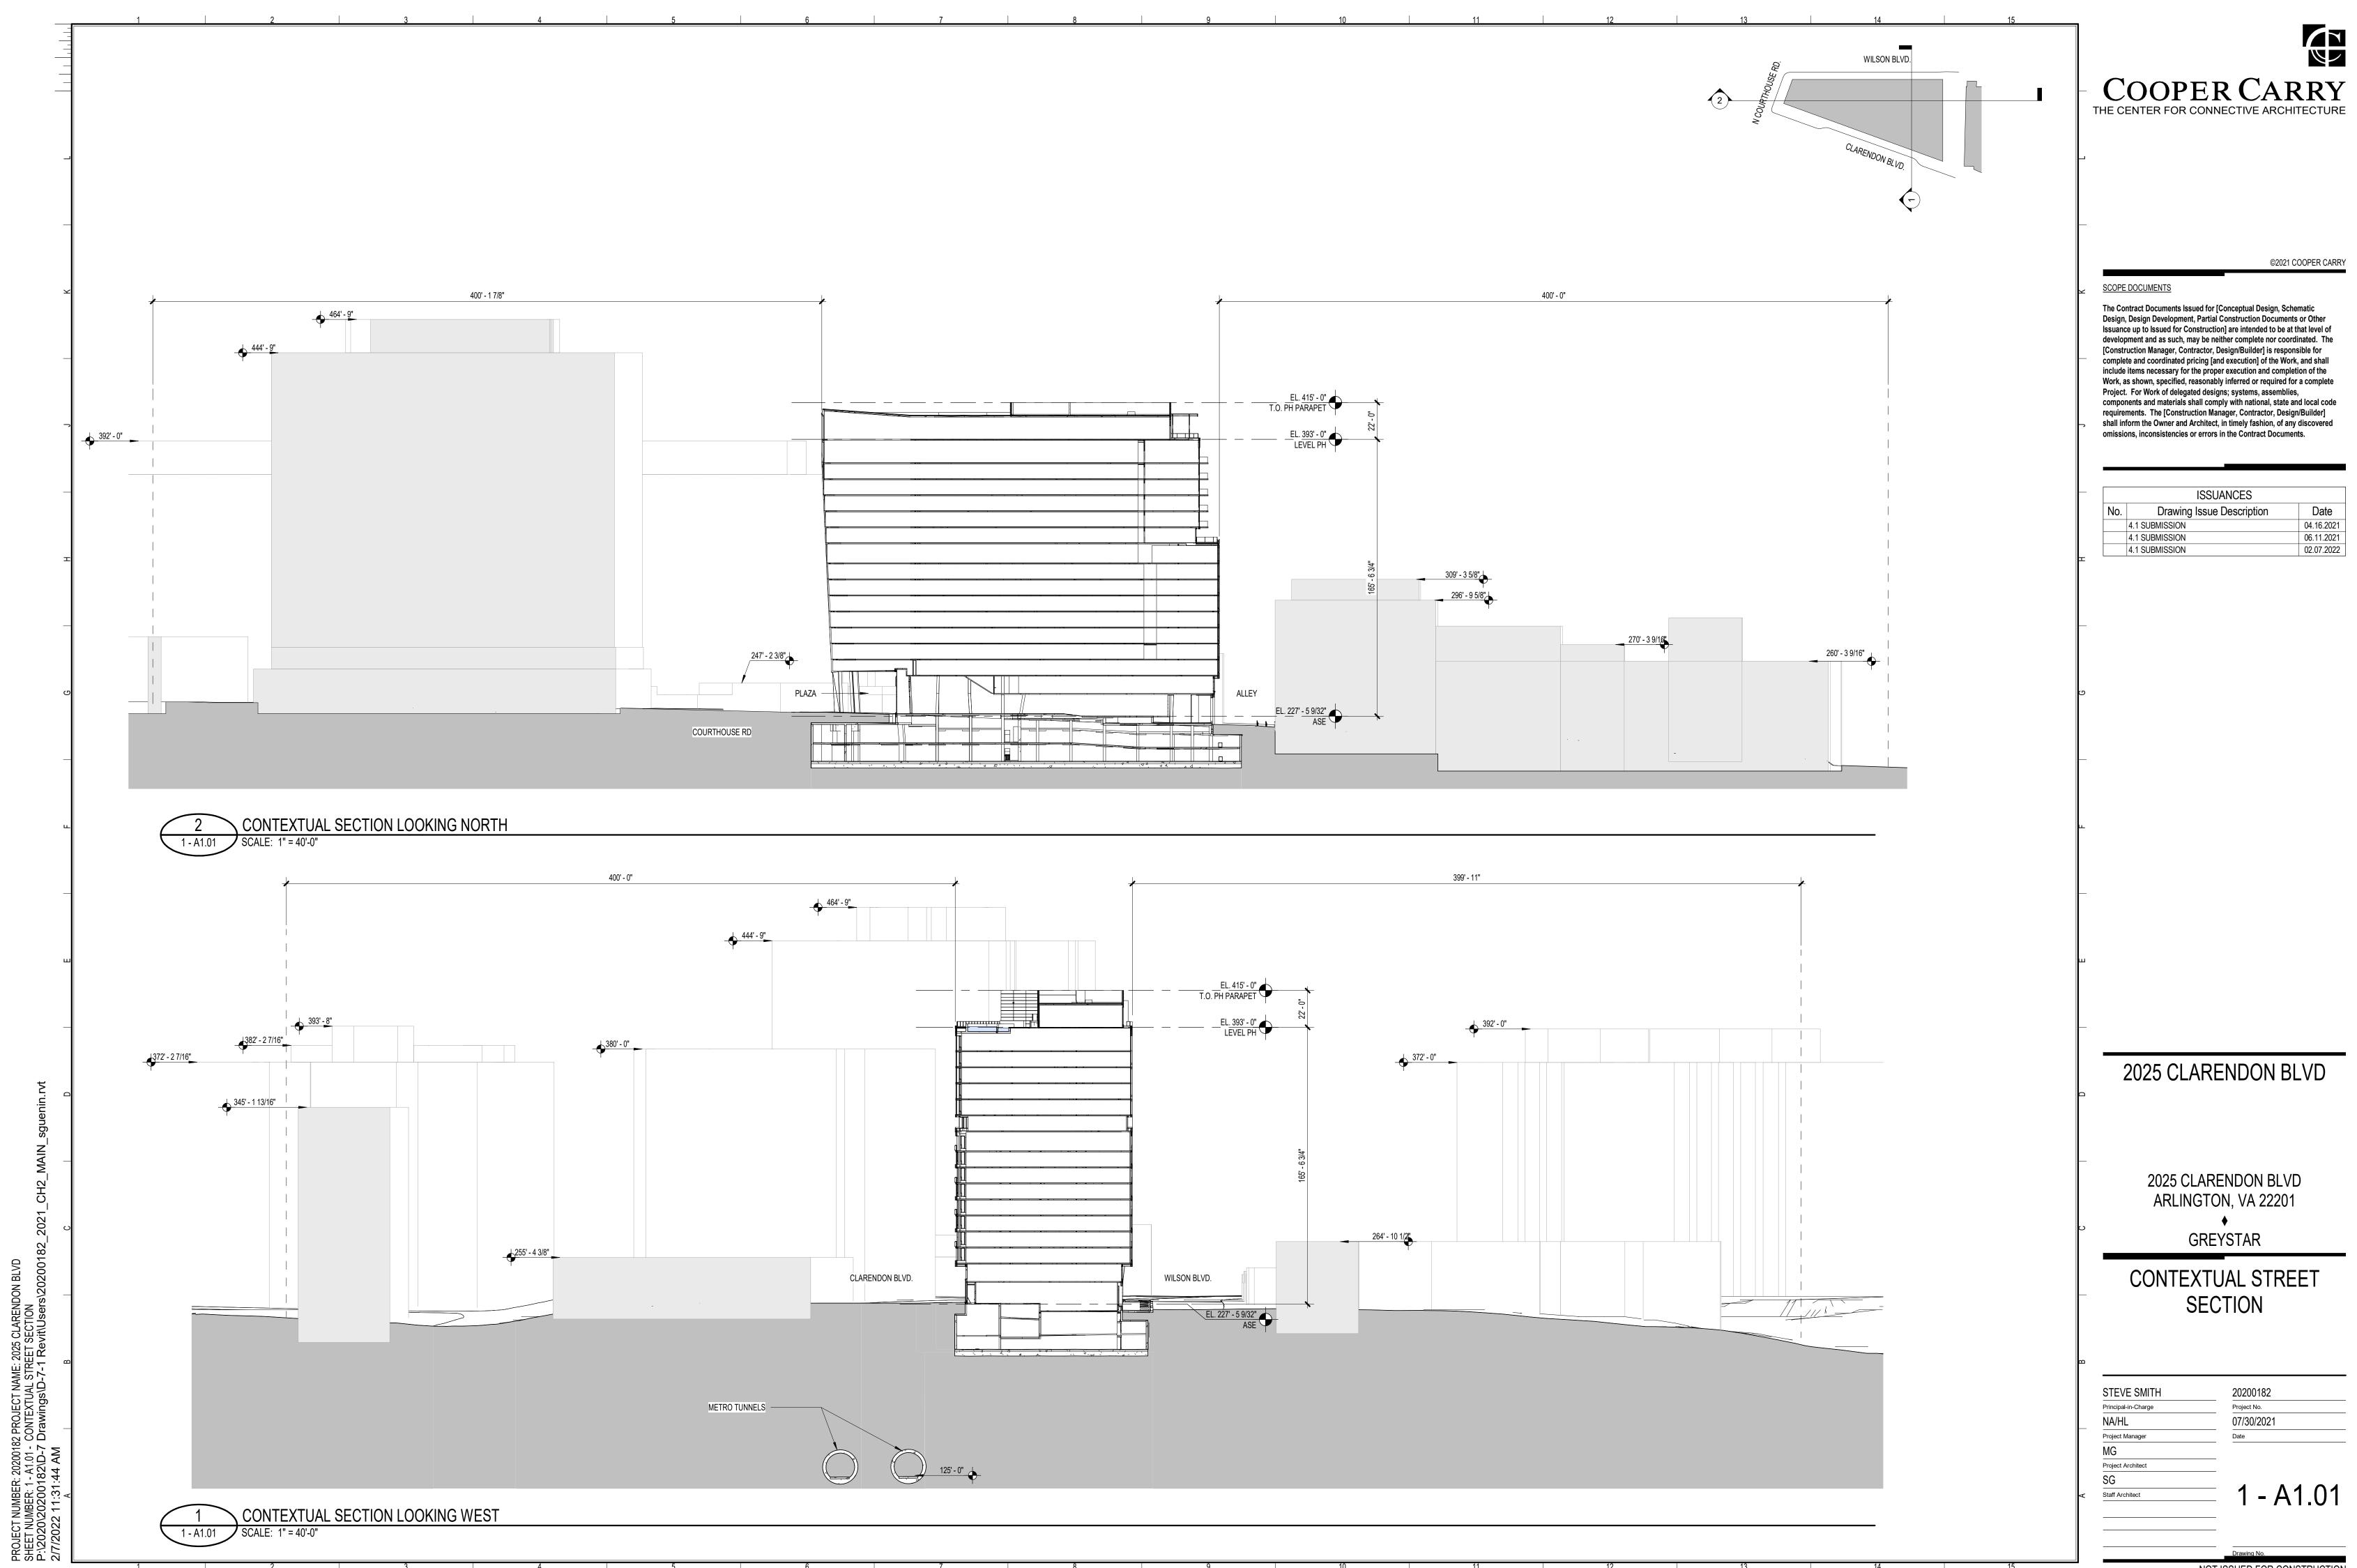


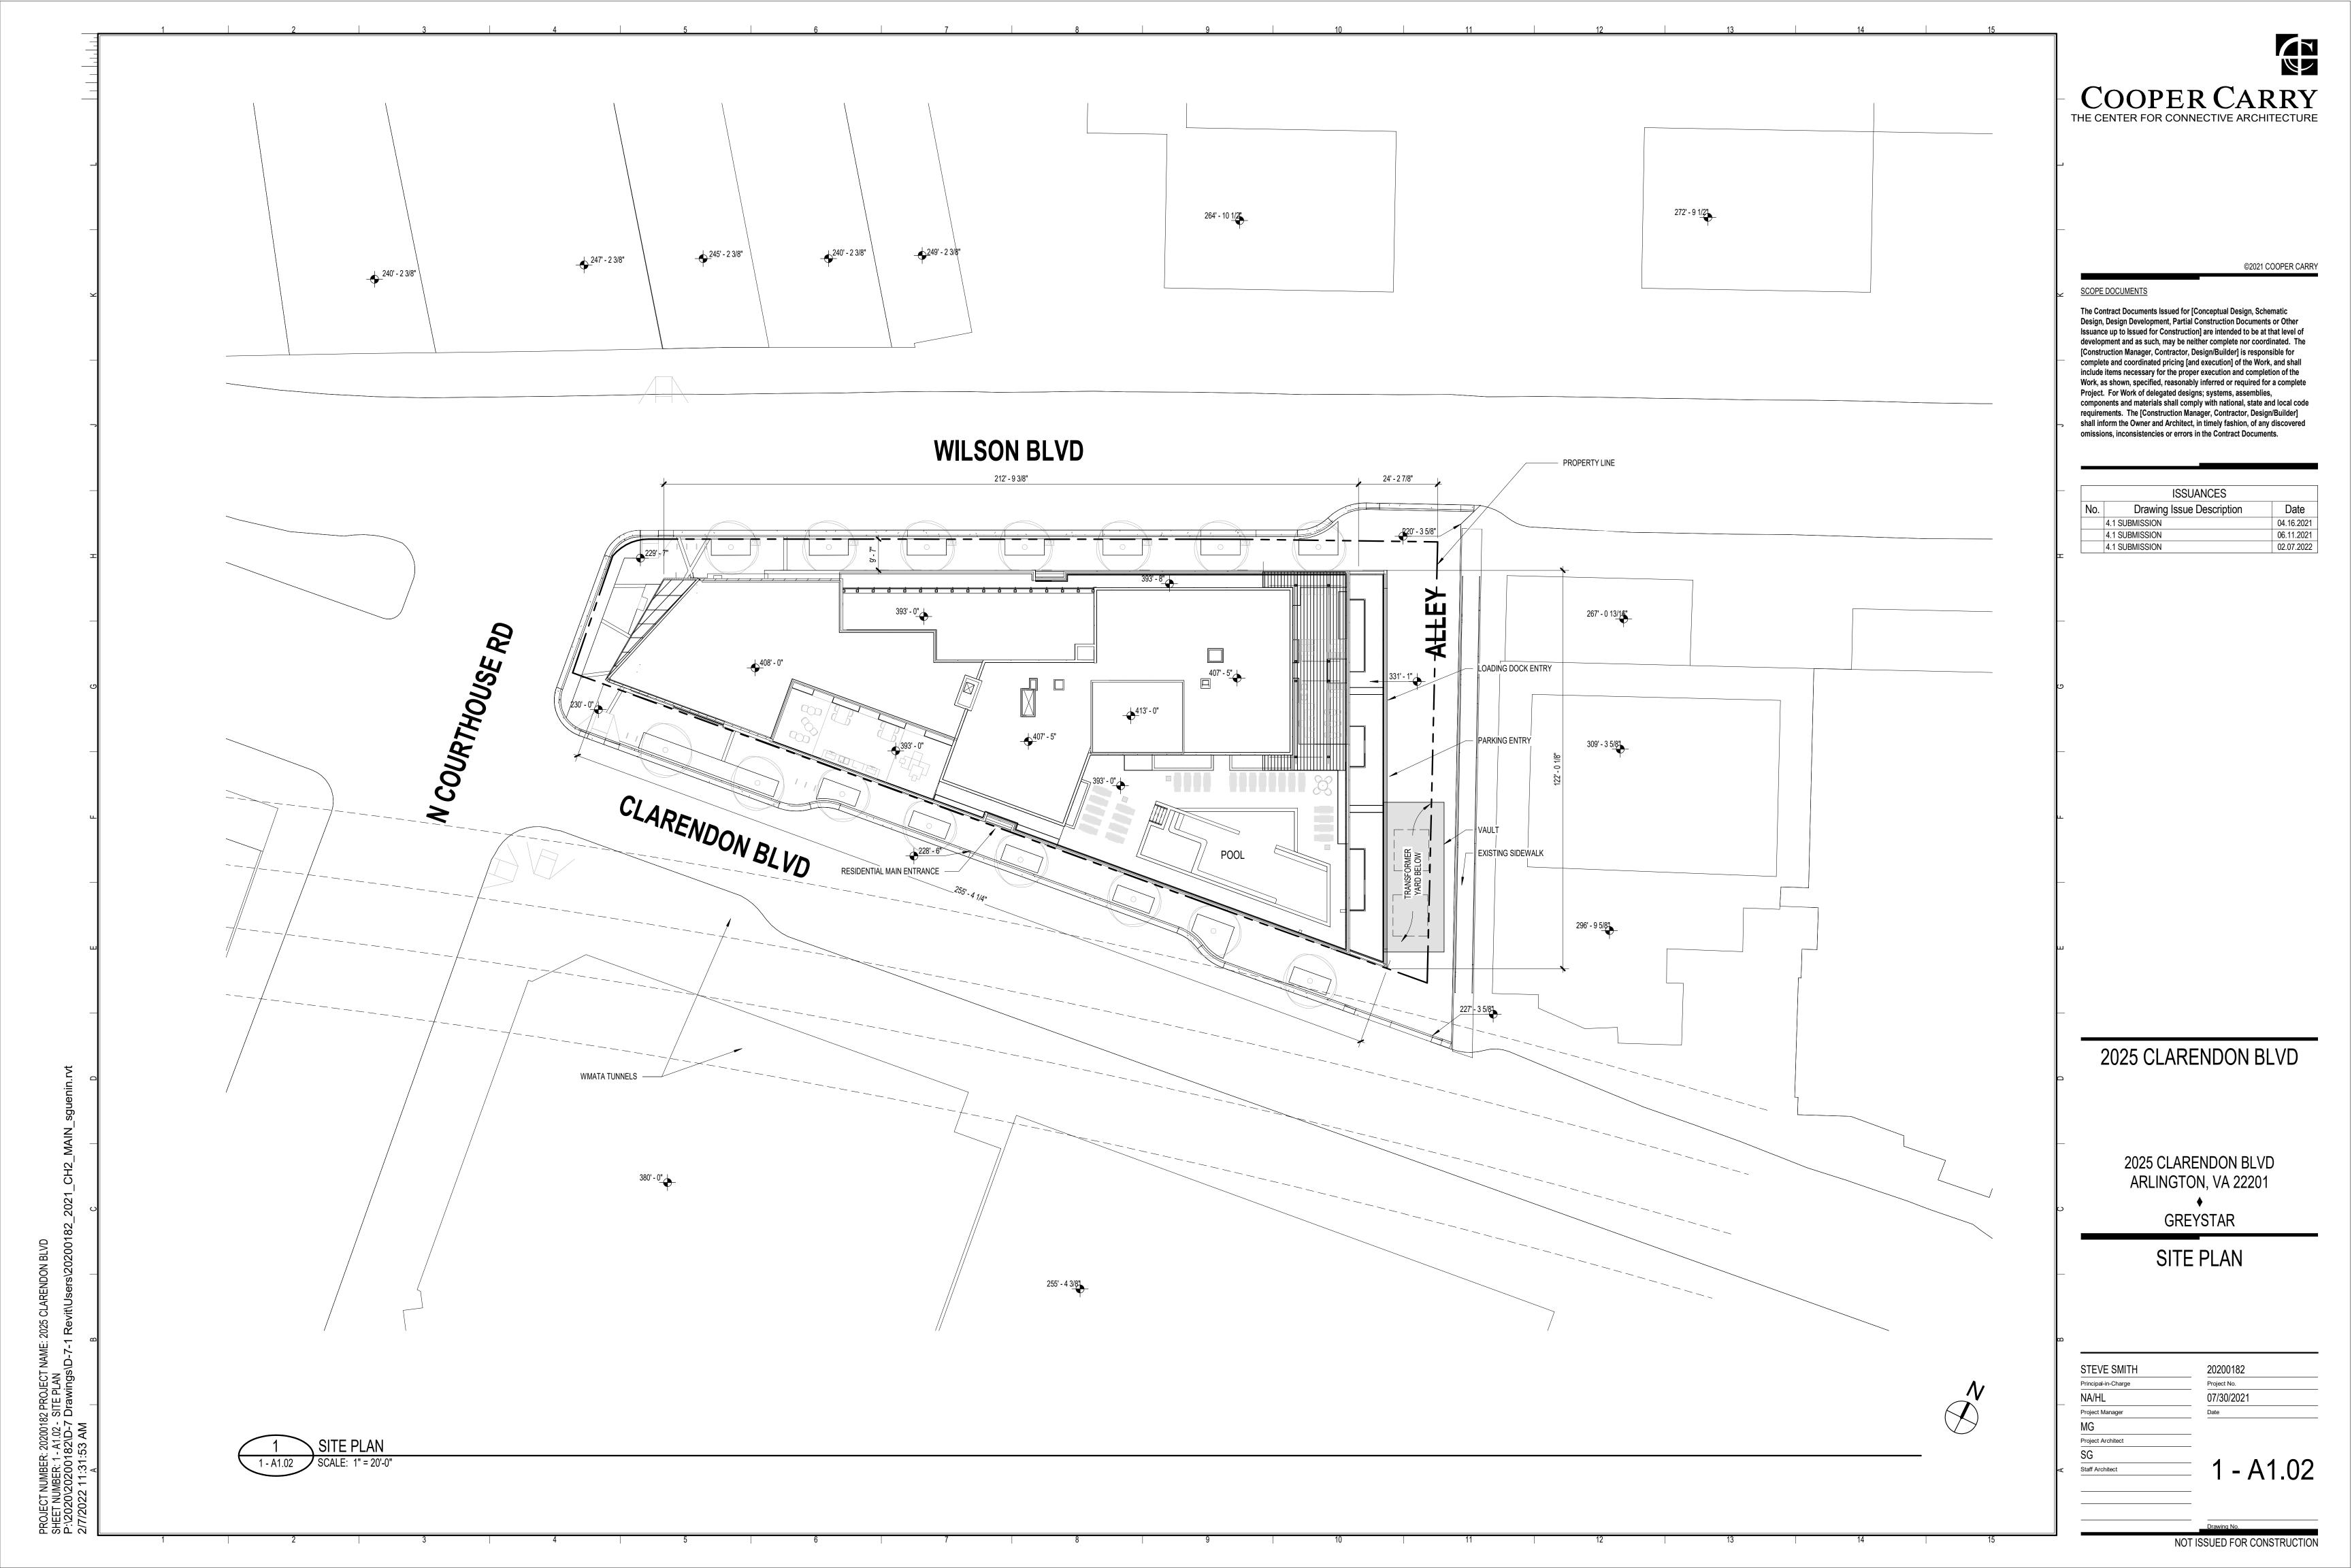

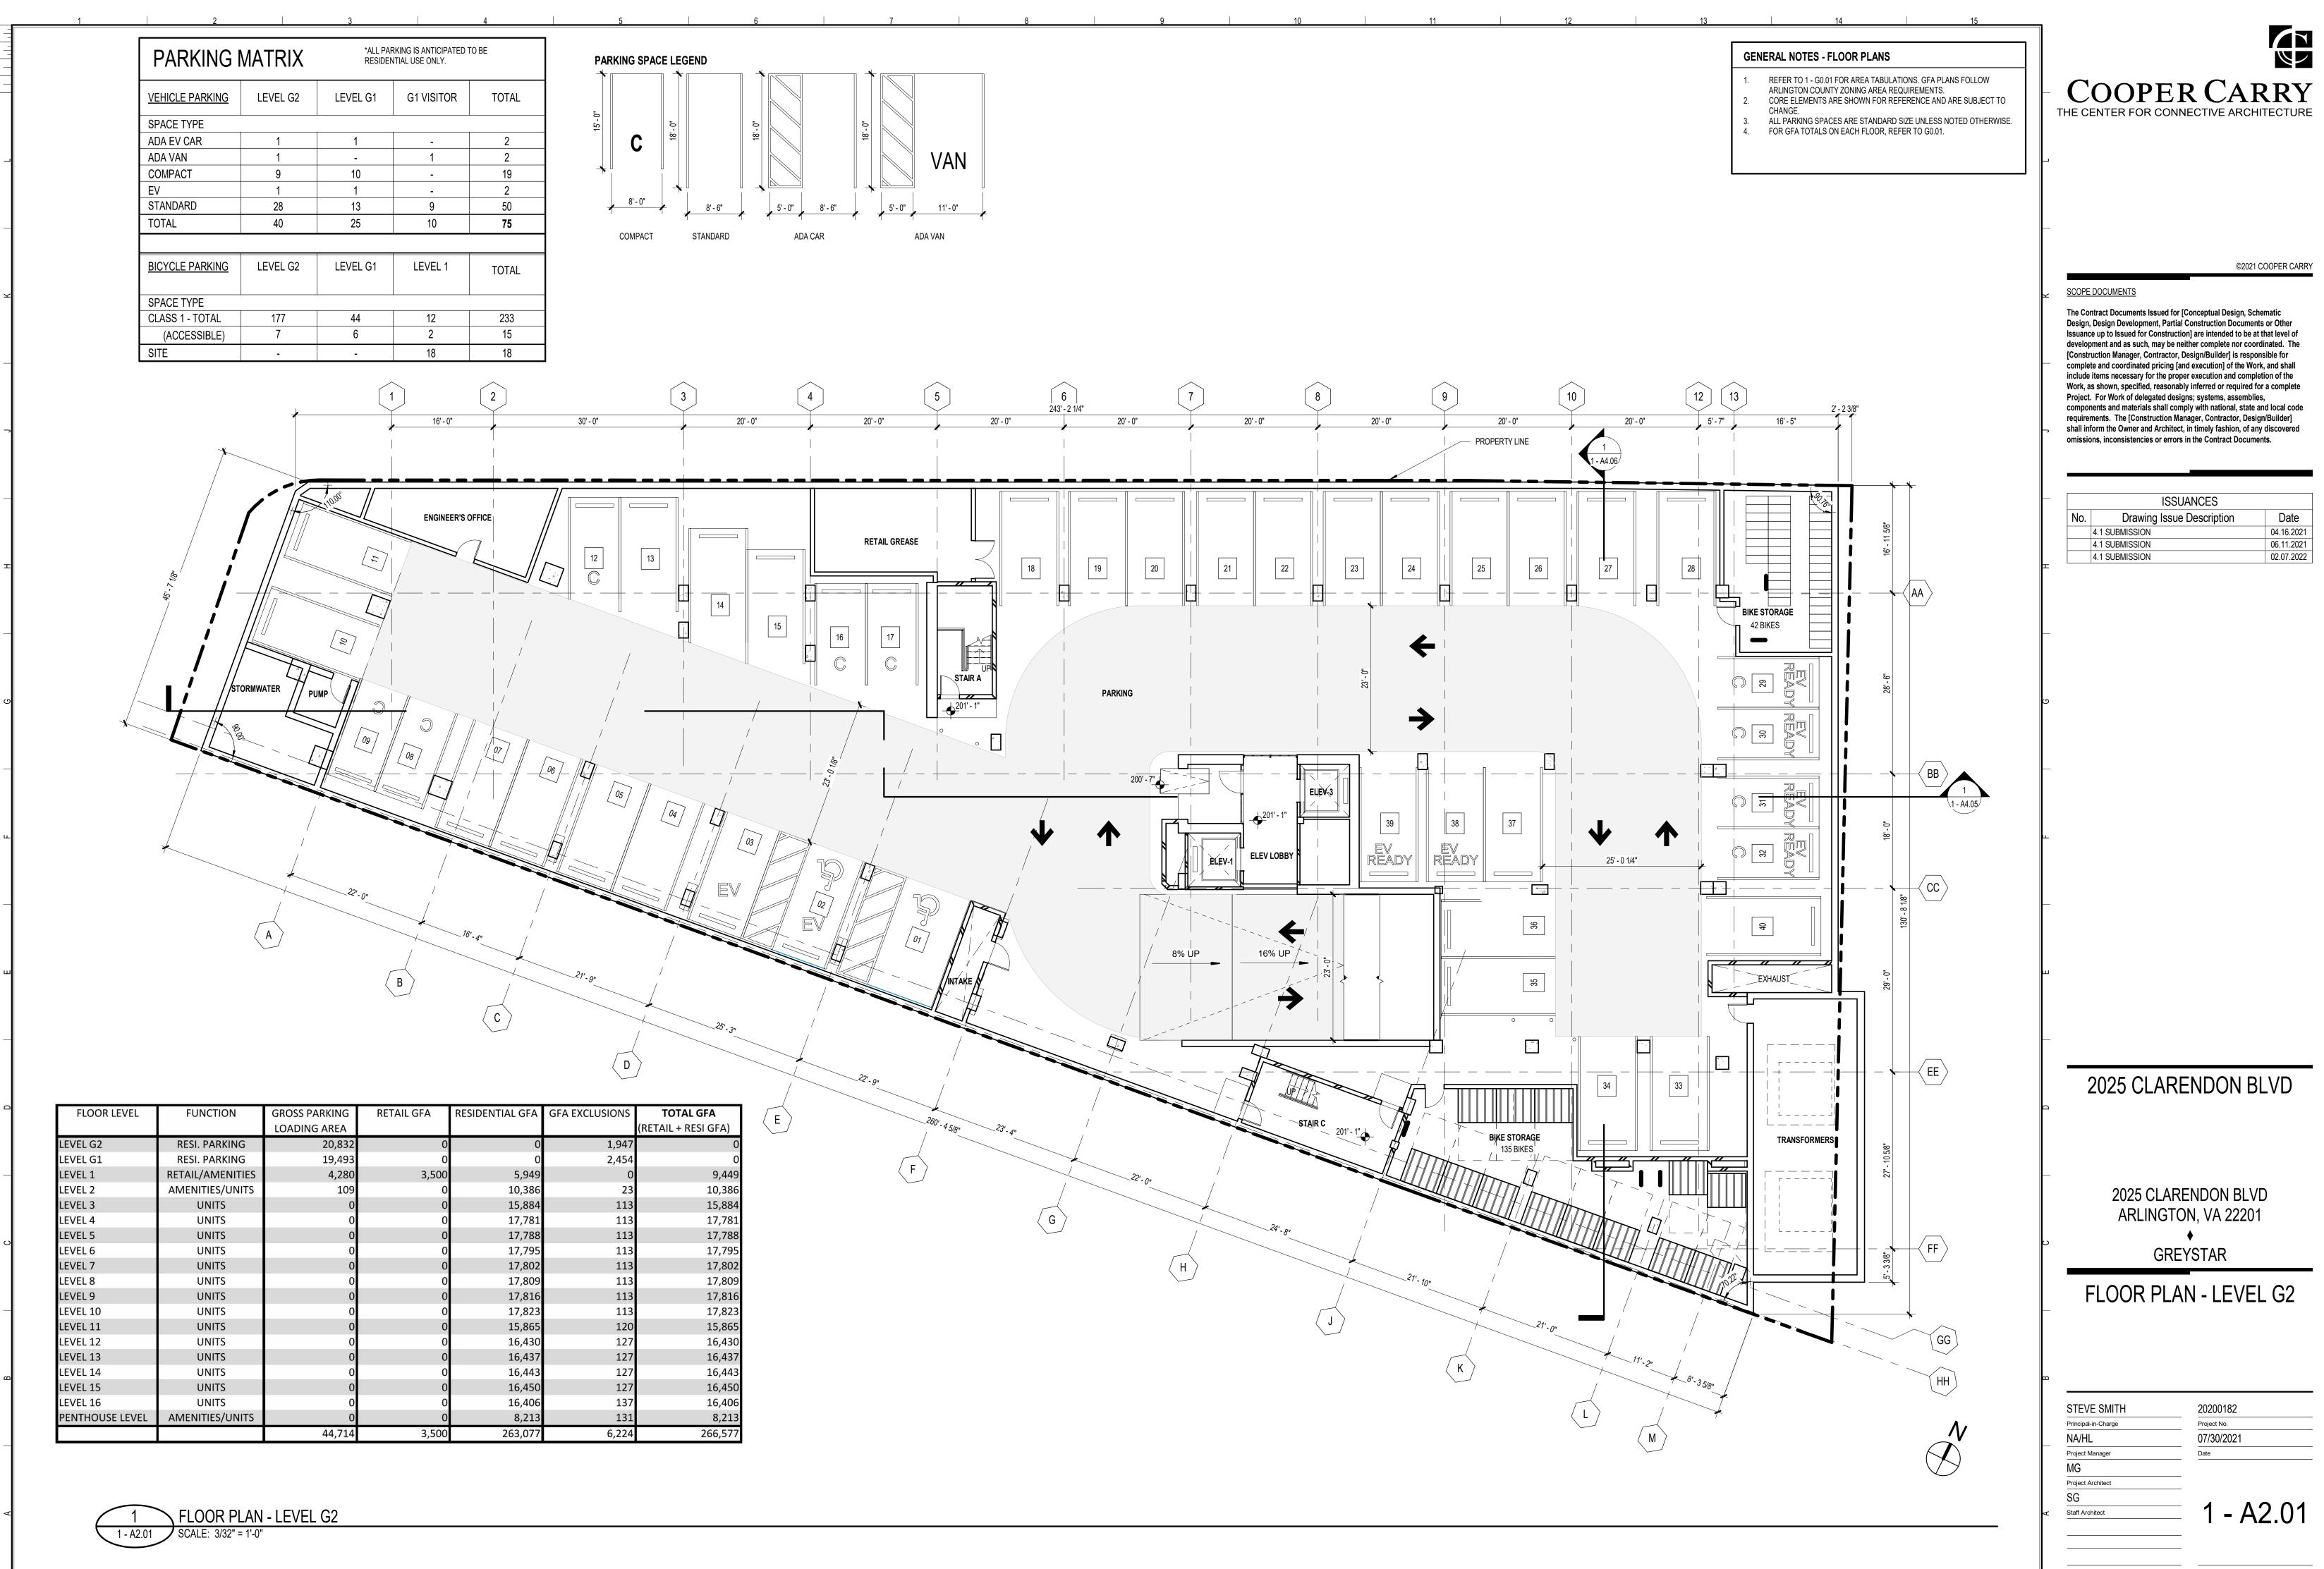


FLOOR LEVEL	FUNCTION	GROSS PARKING LOADING AREA	RETAIL GFA	RESIDENTIAL GFA	GFA EXCLUSIONS	<b>TOTAL GFA</b> (RETAIL + RESI GFA)
LEVEL G2	RESI. PARKING	20,832	0	0	1,947	0
LEVEL G1	RESI. PARKING	19,493	0	0	2,454	C
LEVEL 1	<b>RETAIL/AMENITIES</b>	4,280	3,500	5,949	0	9,449
LEVEL 2	AMENITIES/UNITS	109	0	10,386	23	10,386
LEVEL 3	UNITS	0	0	15,884	113	15,884
LEVEL 4	UNITS	0	0	17,781	113	17,781
LEVEL 5	UNITS	0	0	17,788	113	17,788
LEVEL 6	UNITS	0	0	17,795	113	17,795
LEVEL 7	UNITS	0	0	17,802	113	17,802
LEVEL 8	UNITS	0	0	17,809	113	17,809
LEVEL 9	UNITS	0	0	17,816	113	17,816
LEVEL 10	UNITS	0	0	17,823	113	17,823
LEVEL 11	UNITS	0	0	15,865	120	15,865
LEVEL 12	UNITS	0	0	16,430	127	16,430
LEVEL 13	UNITS	0	0	16,437	127	16,437
LEVEL 14	UNITS	0	0	16,443	127	16,443
LEVEL 15	UNITS	0	0	16,450	127	16,450
LEVEL 16	UNITS	0	0	16,406	137	16,406
PENTHOUSE LEVEL	AMENITIES/UNITS	0	0	8,213	131	8,213
		44,714	3,500	263,077	6,224	266,577


202 3ER: 20200182 PROJECT NAME: 2025 CL 3: 1 - A2.01 - FLOOR PLAN - LEVEL G2 dian02396\Documents\20200182 PROJECT NUMBER SHEET NUMBER: C:\Users\zandi 2/7/2022 3:38:5

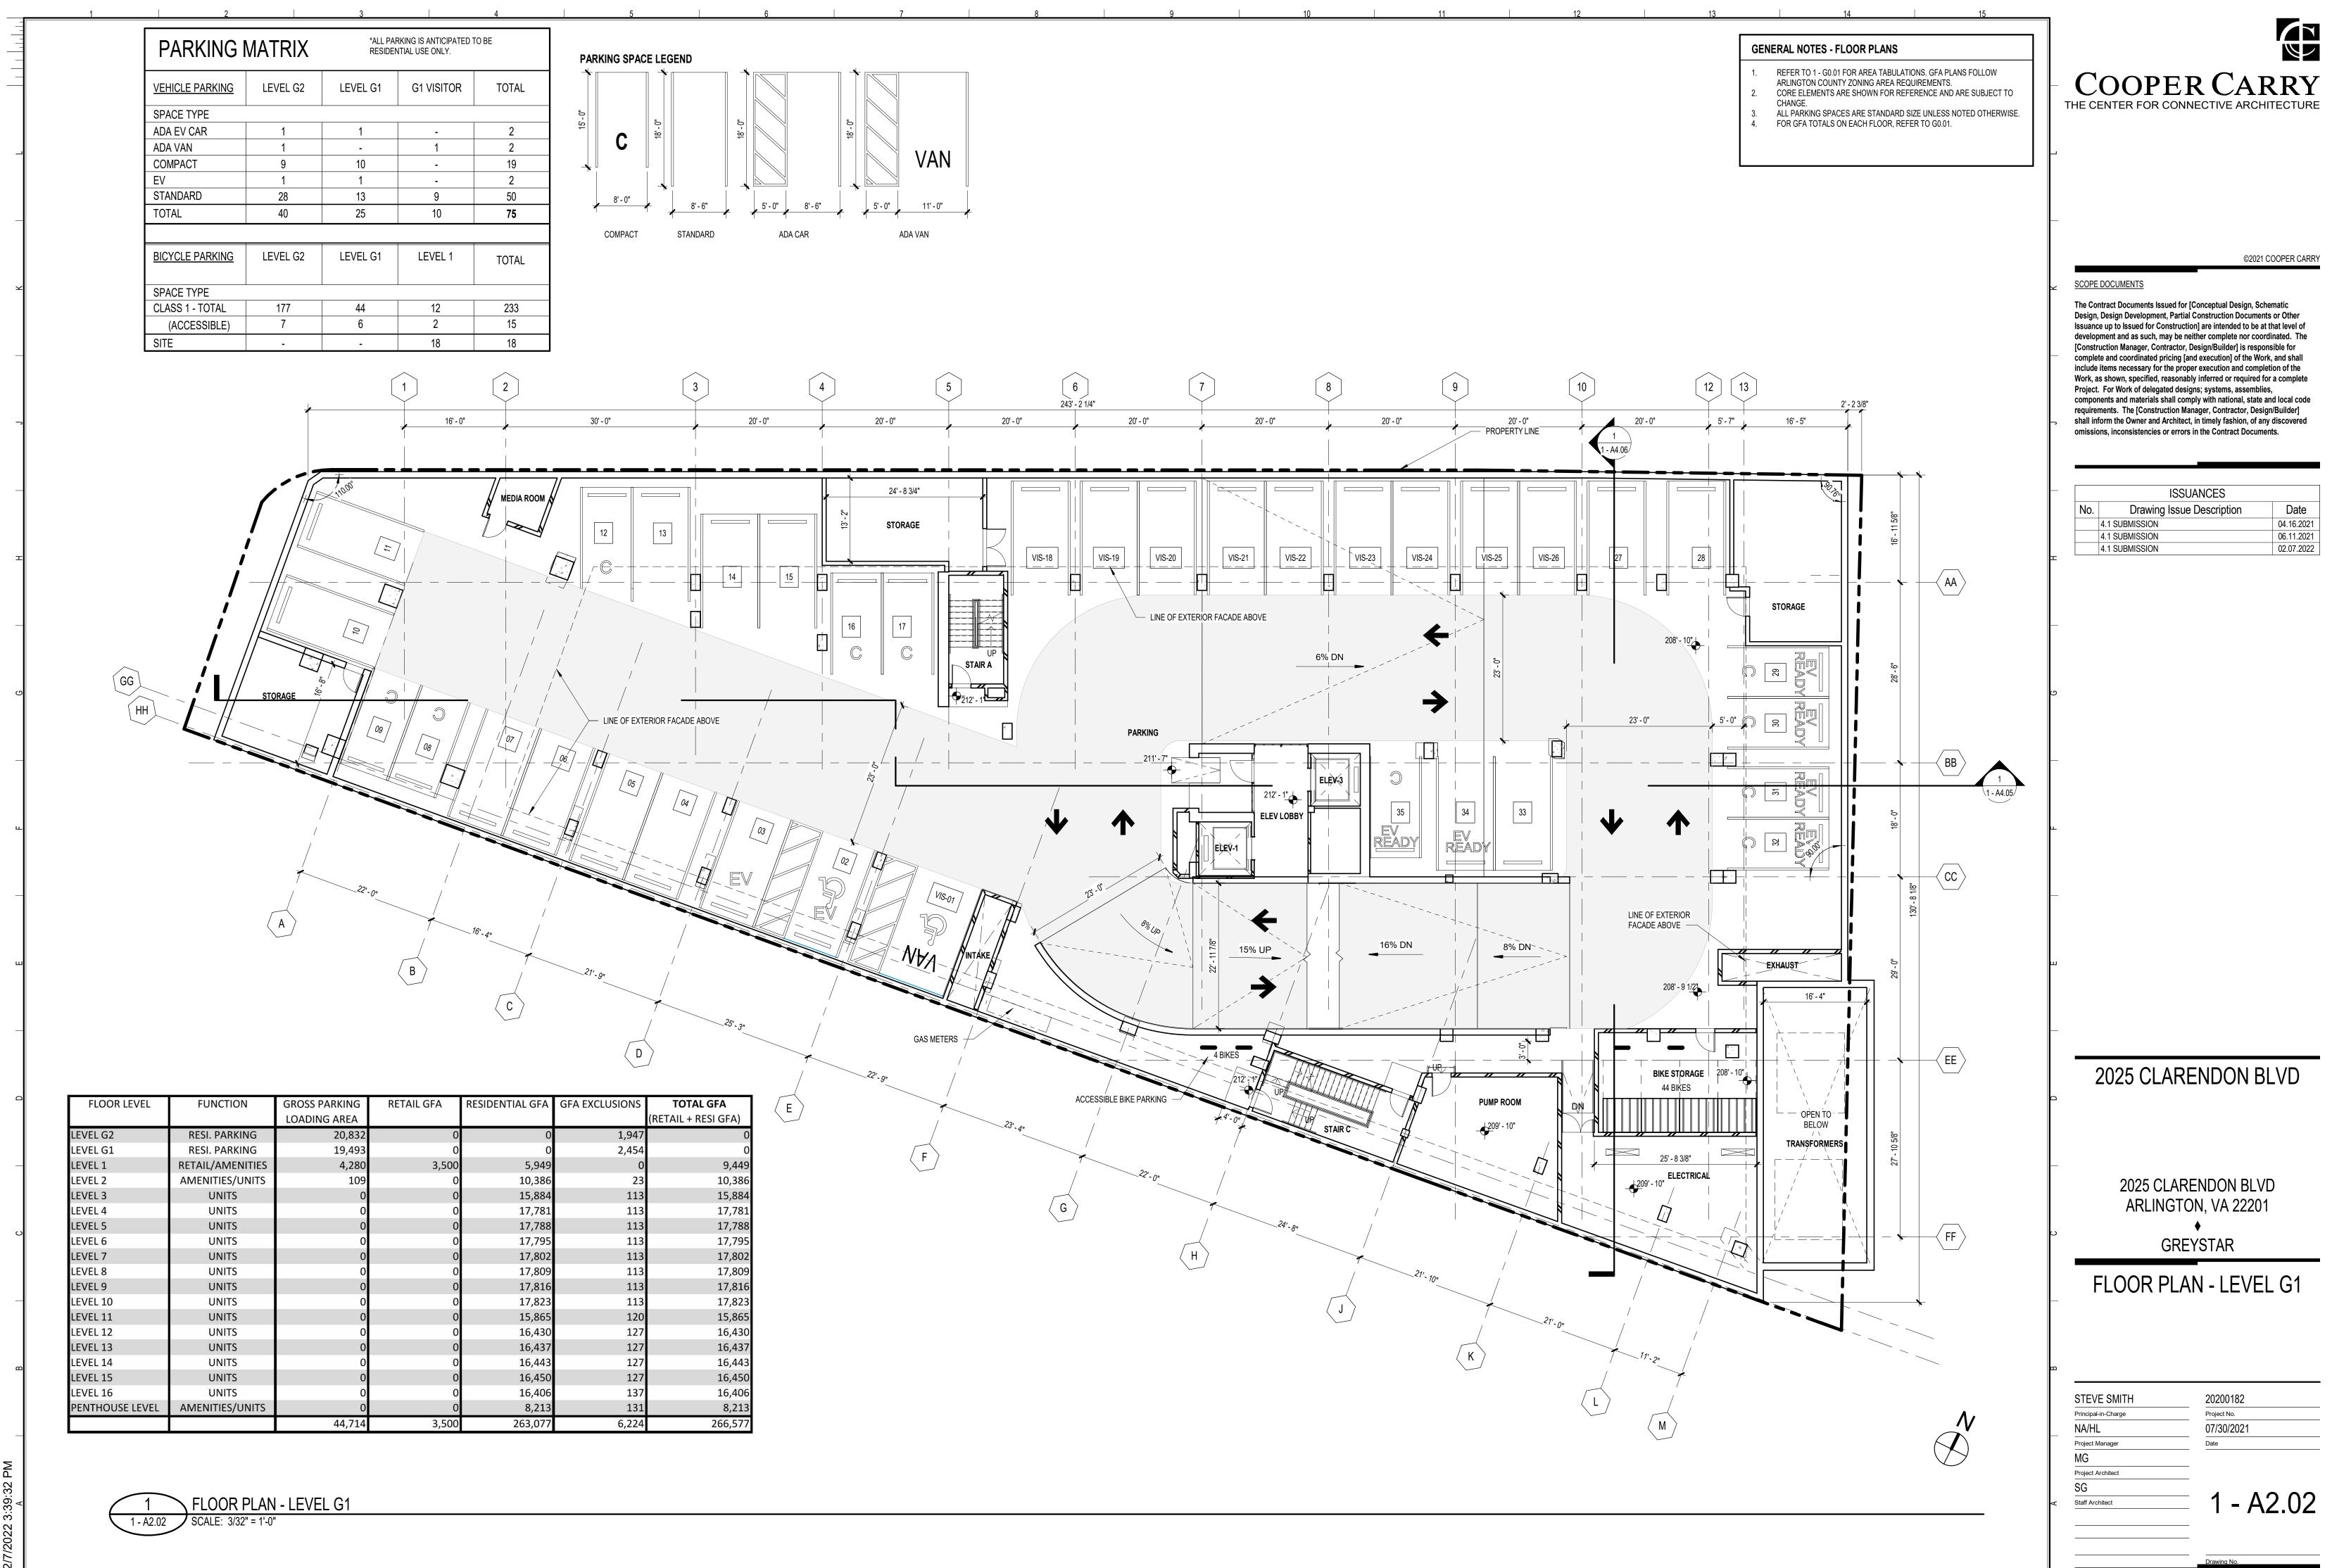



FLOOR LEVEL	FUNCTION	<b>GROSS PARKING</b>	<b>RETAIL GFA</b>	<b>RESIDENTIAL GFA</b>	GFA EXCLUSIONS	TOTAL GFA
		LOADING AREA				(RETAIL + RESI GFA)
LEVEL G2	RESI. PARKING	20,832	0	0	1,947	0
LEVEL G1	RESI. PARKING	19,493	0	0	2,454	0
LEVEL 1	<b>RETAIL/AMENITIES</b>	4,280	3,500	5,949	0	9,449
LEVEL 2	AMENITIES/UNITS	109	0	10,386	23	10,386
LEVEL 3	UNITS	0	0	15,884	113	15,884
LEVEL 4	UNITS	0	0	17,781	113	17,781
LEVEL 5	UNITS	0	0	17,788	113	17,788
LEVEL 6	UNITS	0	0	17,795	113	17,795
LEVEL 7	UNITS	0	0	17,802	113	17,802
LEVEL 8	UNITS	0	0	17,809	113	17,809
LEVEL 9	UNITS	0	0	17,816	113	17,816
LEVEL 10	UNITS	0	0	17,823	113	17,823
LEVEL 11	UNITS	0	0	15,865	120	15,865
LEVEL 12	UNITS	0	0	16,430	127	16,430
LEVEL 13	UNITS	0	0	16,437	127	16,437
LEVEL 14	UNITS	0	0	16,443	127	16,443
LEVEL 15	UNITS	0	0	16,450	127	16,450
LEVEL 16	UNITS	0	0	16,406	137	16,406
PENTHOUSE LEVEL	AMENITIES/UNITS	0	0	8,213	131	8,213
		44,714	3,500	263,077	6,224	266,577


 $\overline{\mathbf{c}}$ 202 :R: 20200182 PROJECT NAME: 2025 CLA 1 - A2.02 - FLOOR PLAN - LEVEL G1 ian02396\Documents\20200182 32 DM PROJECT NUMBEF SHEET NUMBER: 1 C:\Users\zandi; 2/7/2022 3:39:3

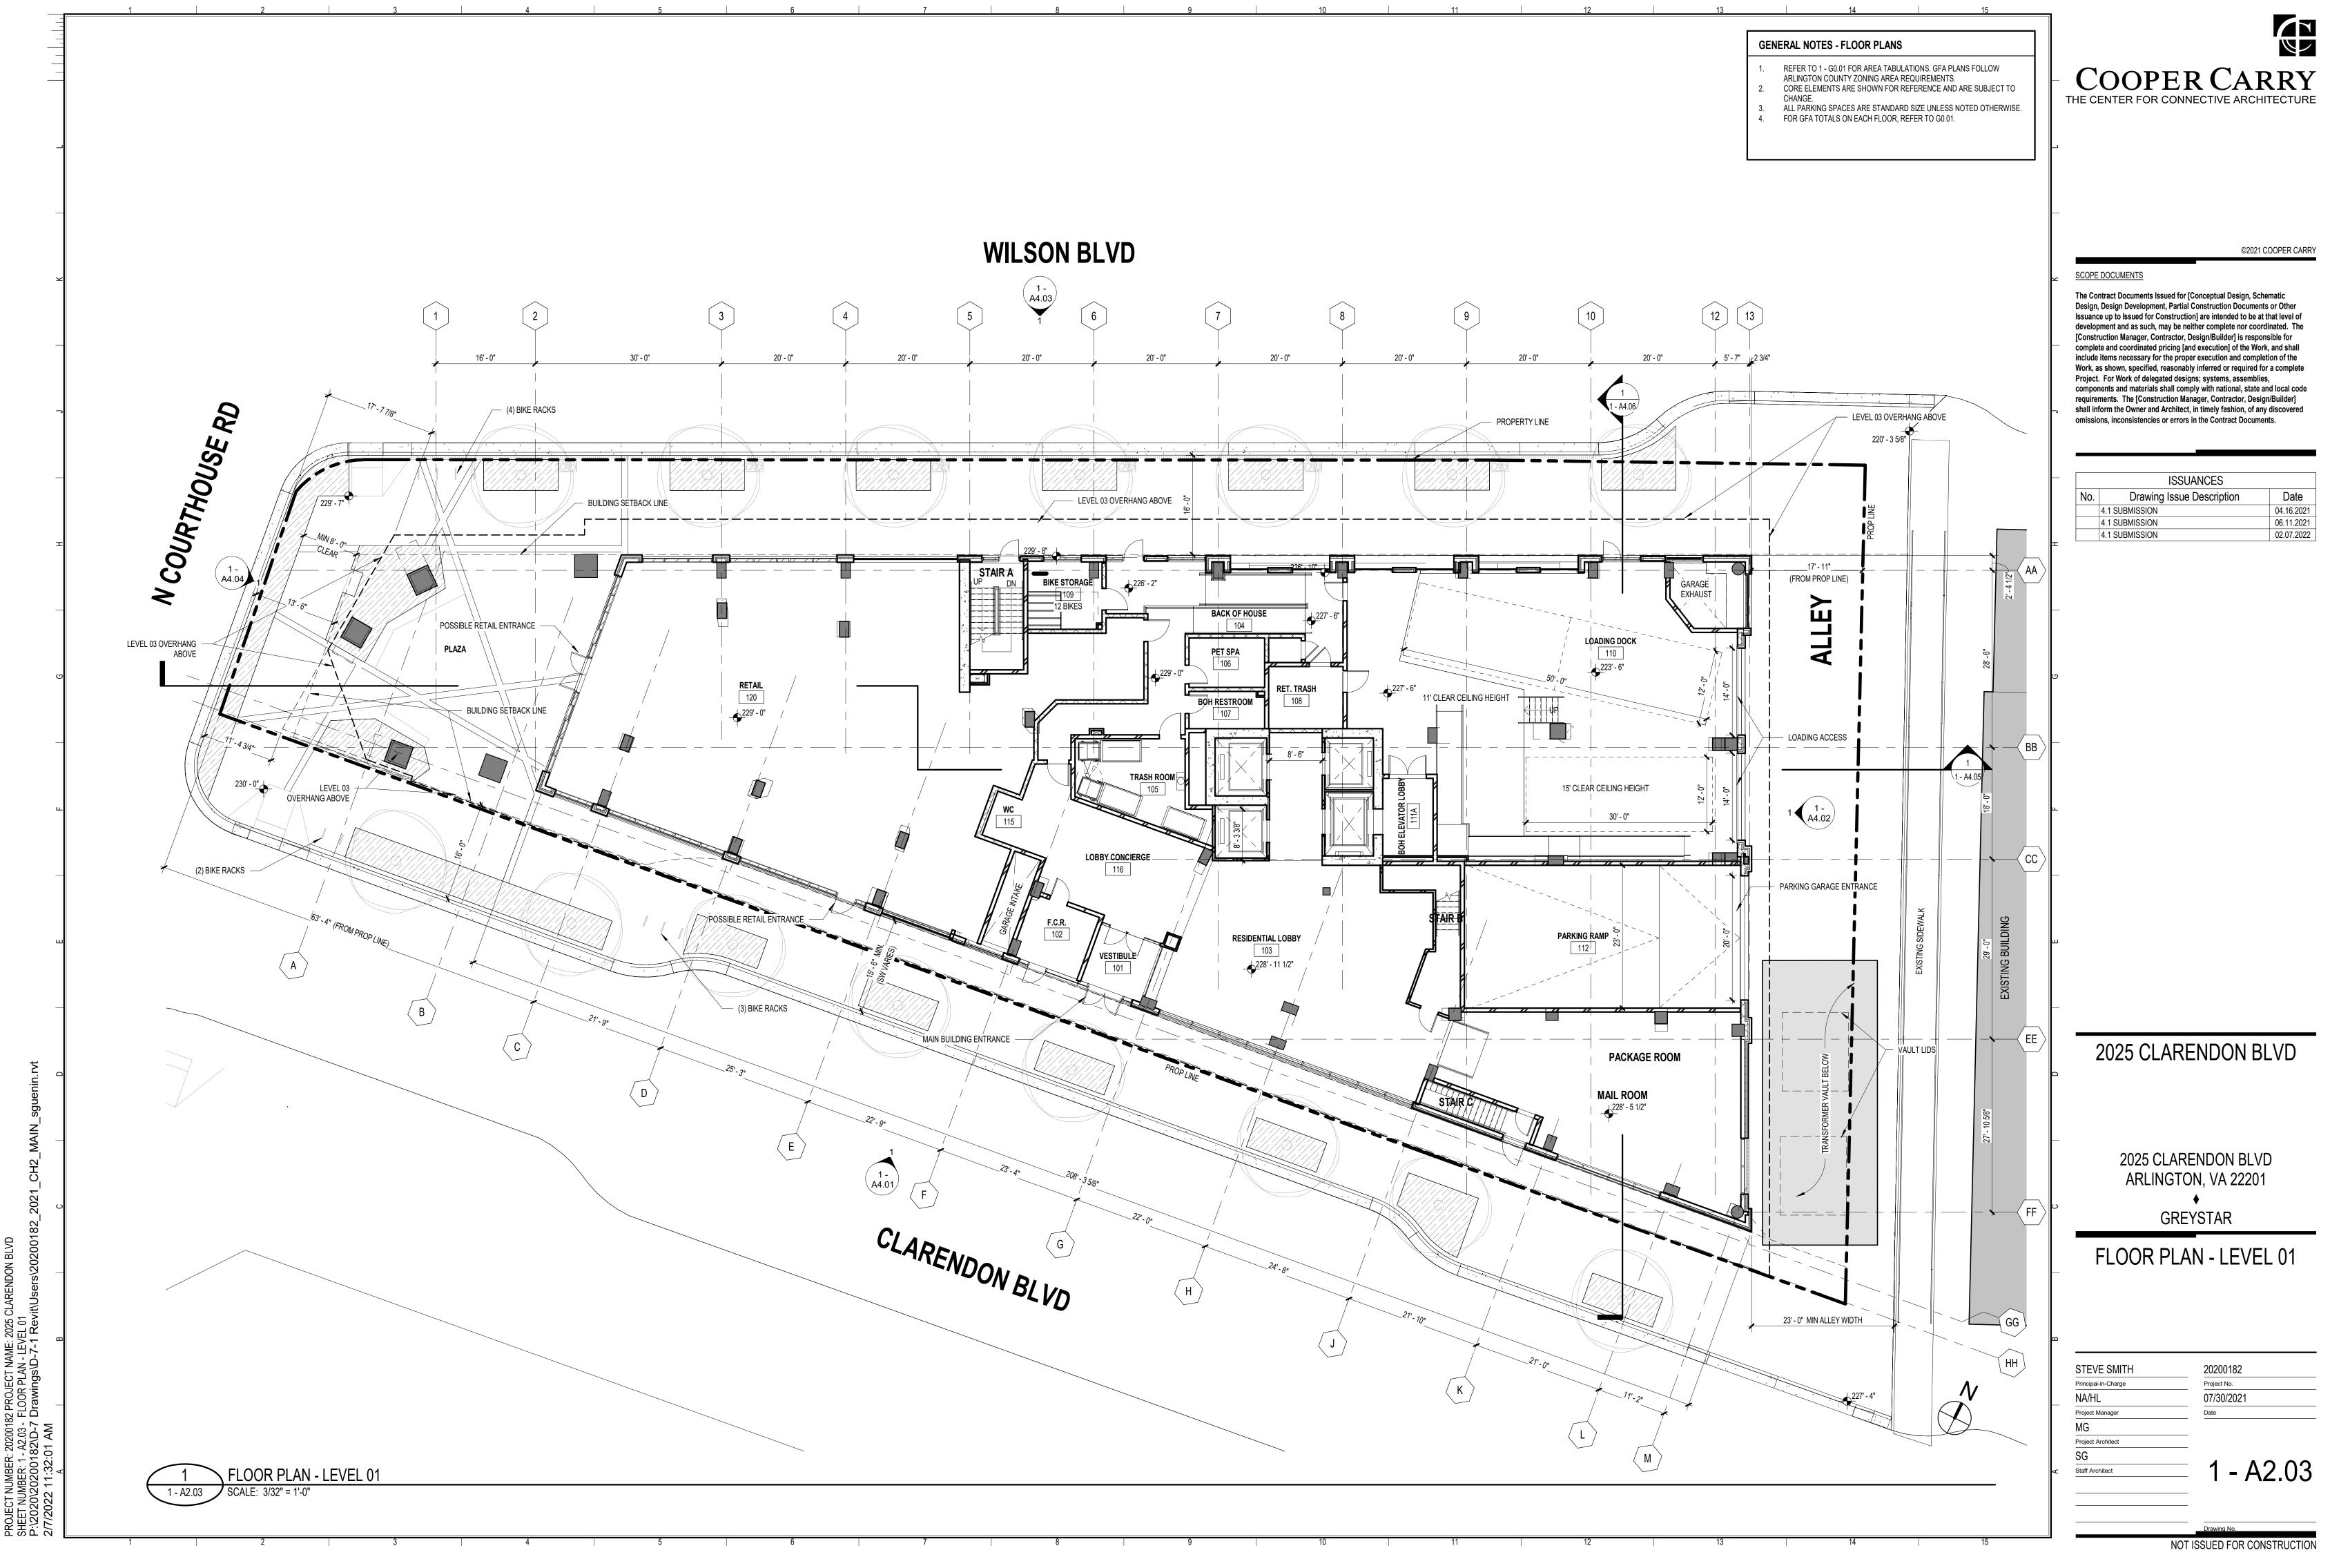


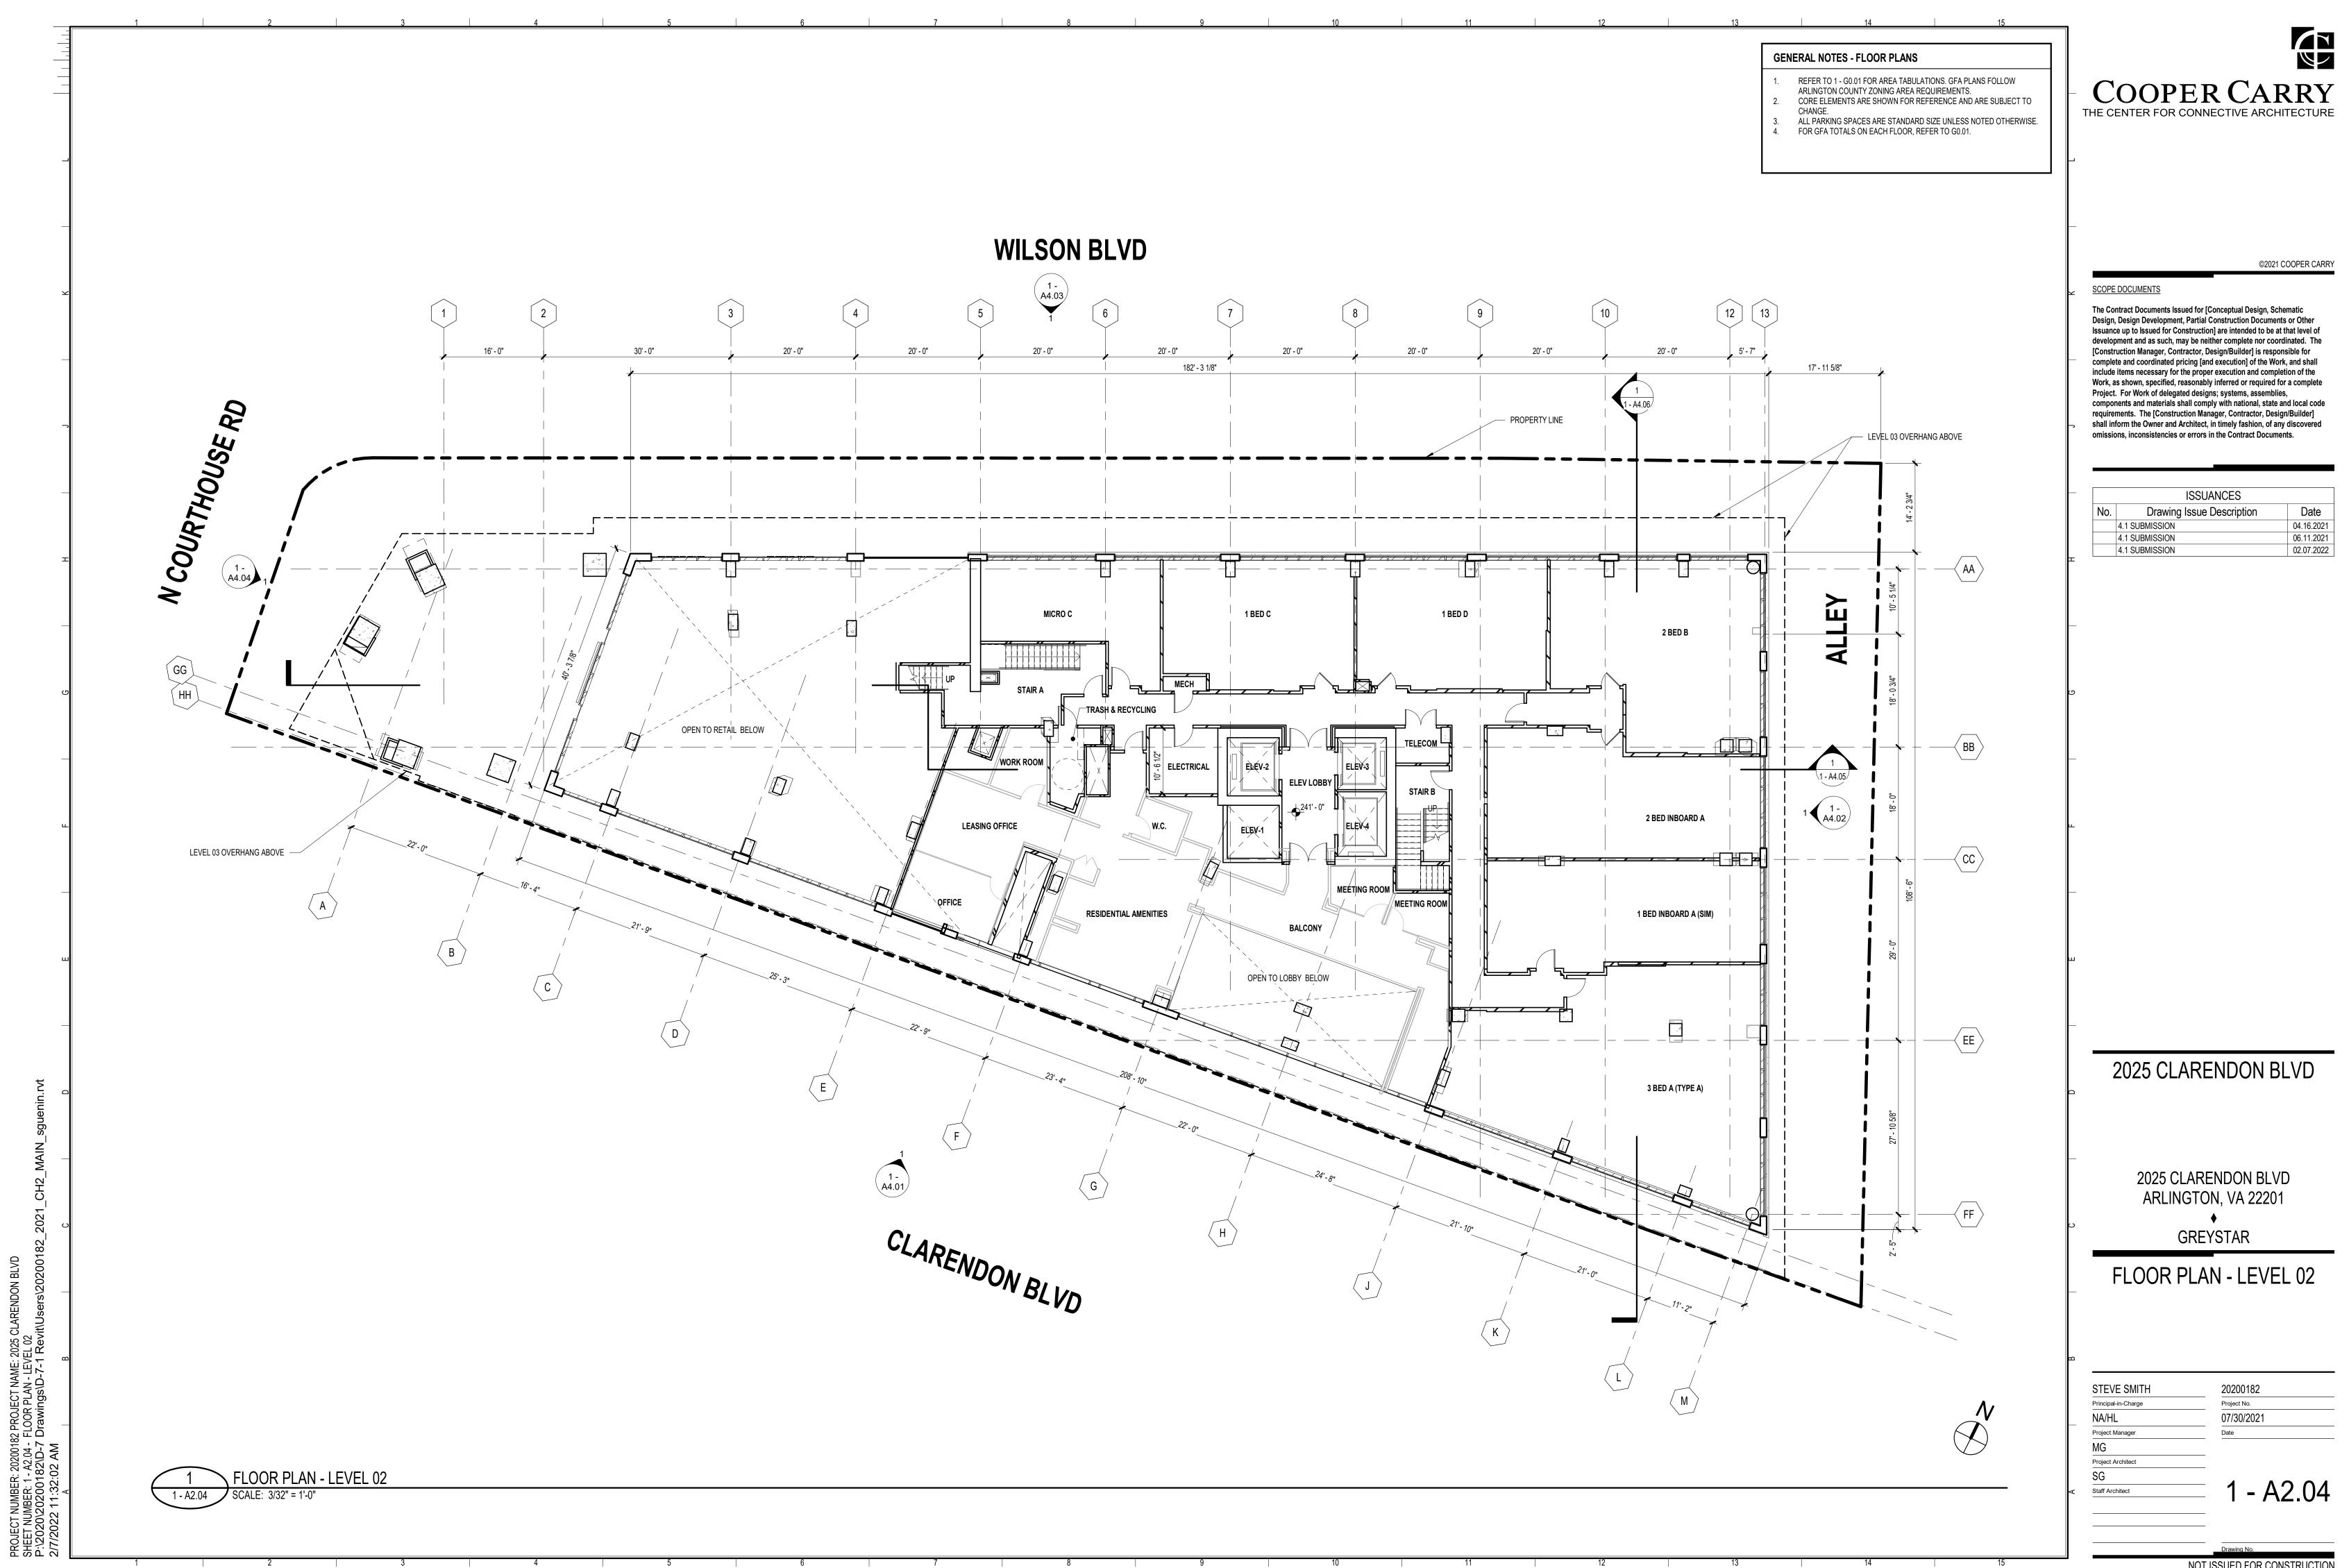


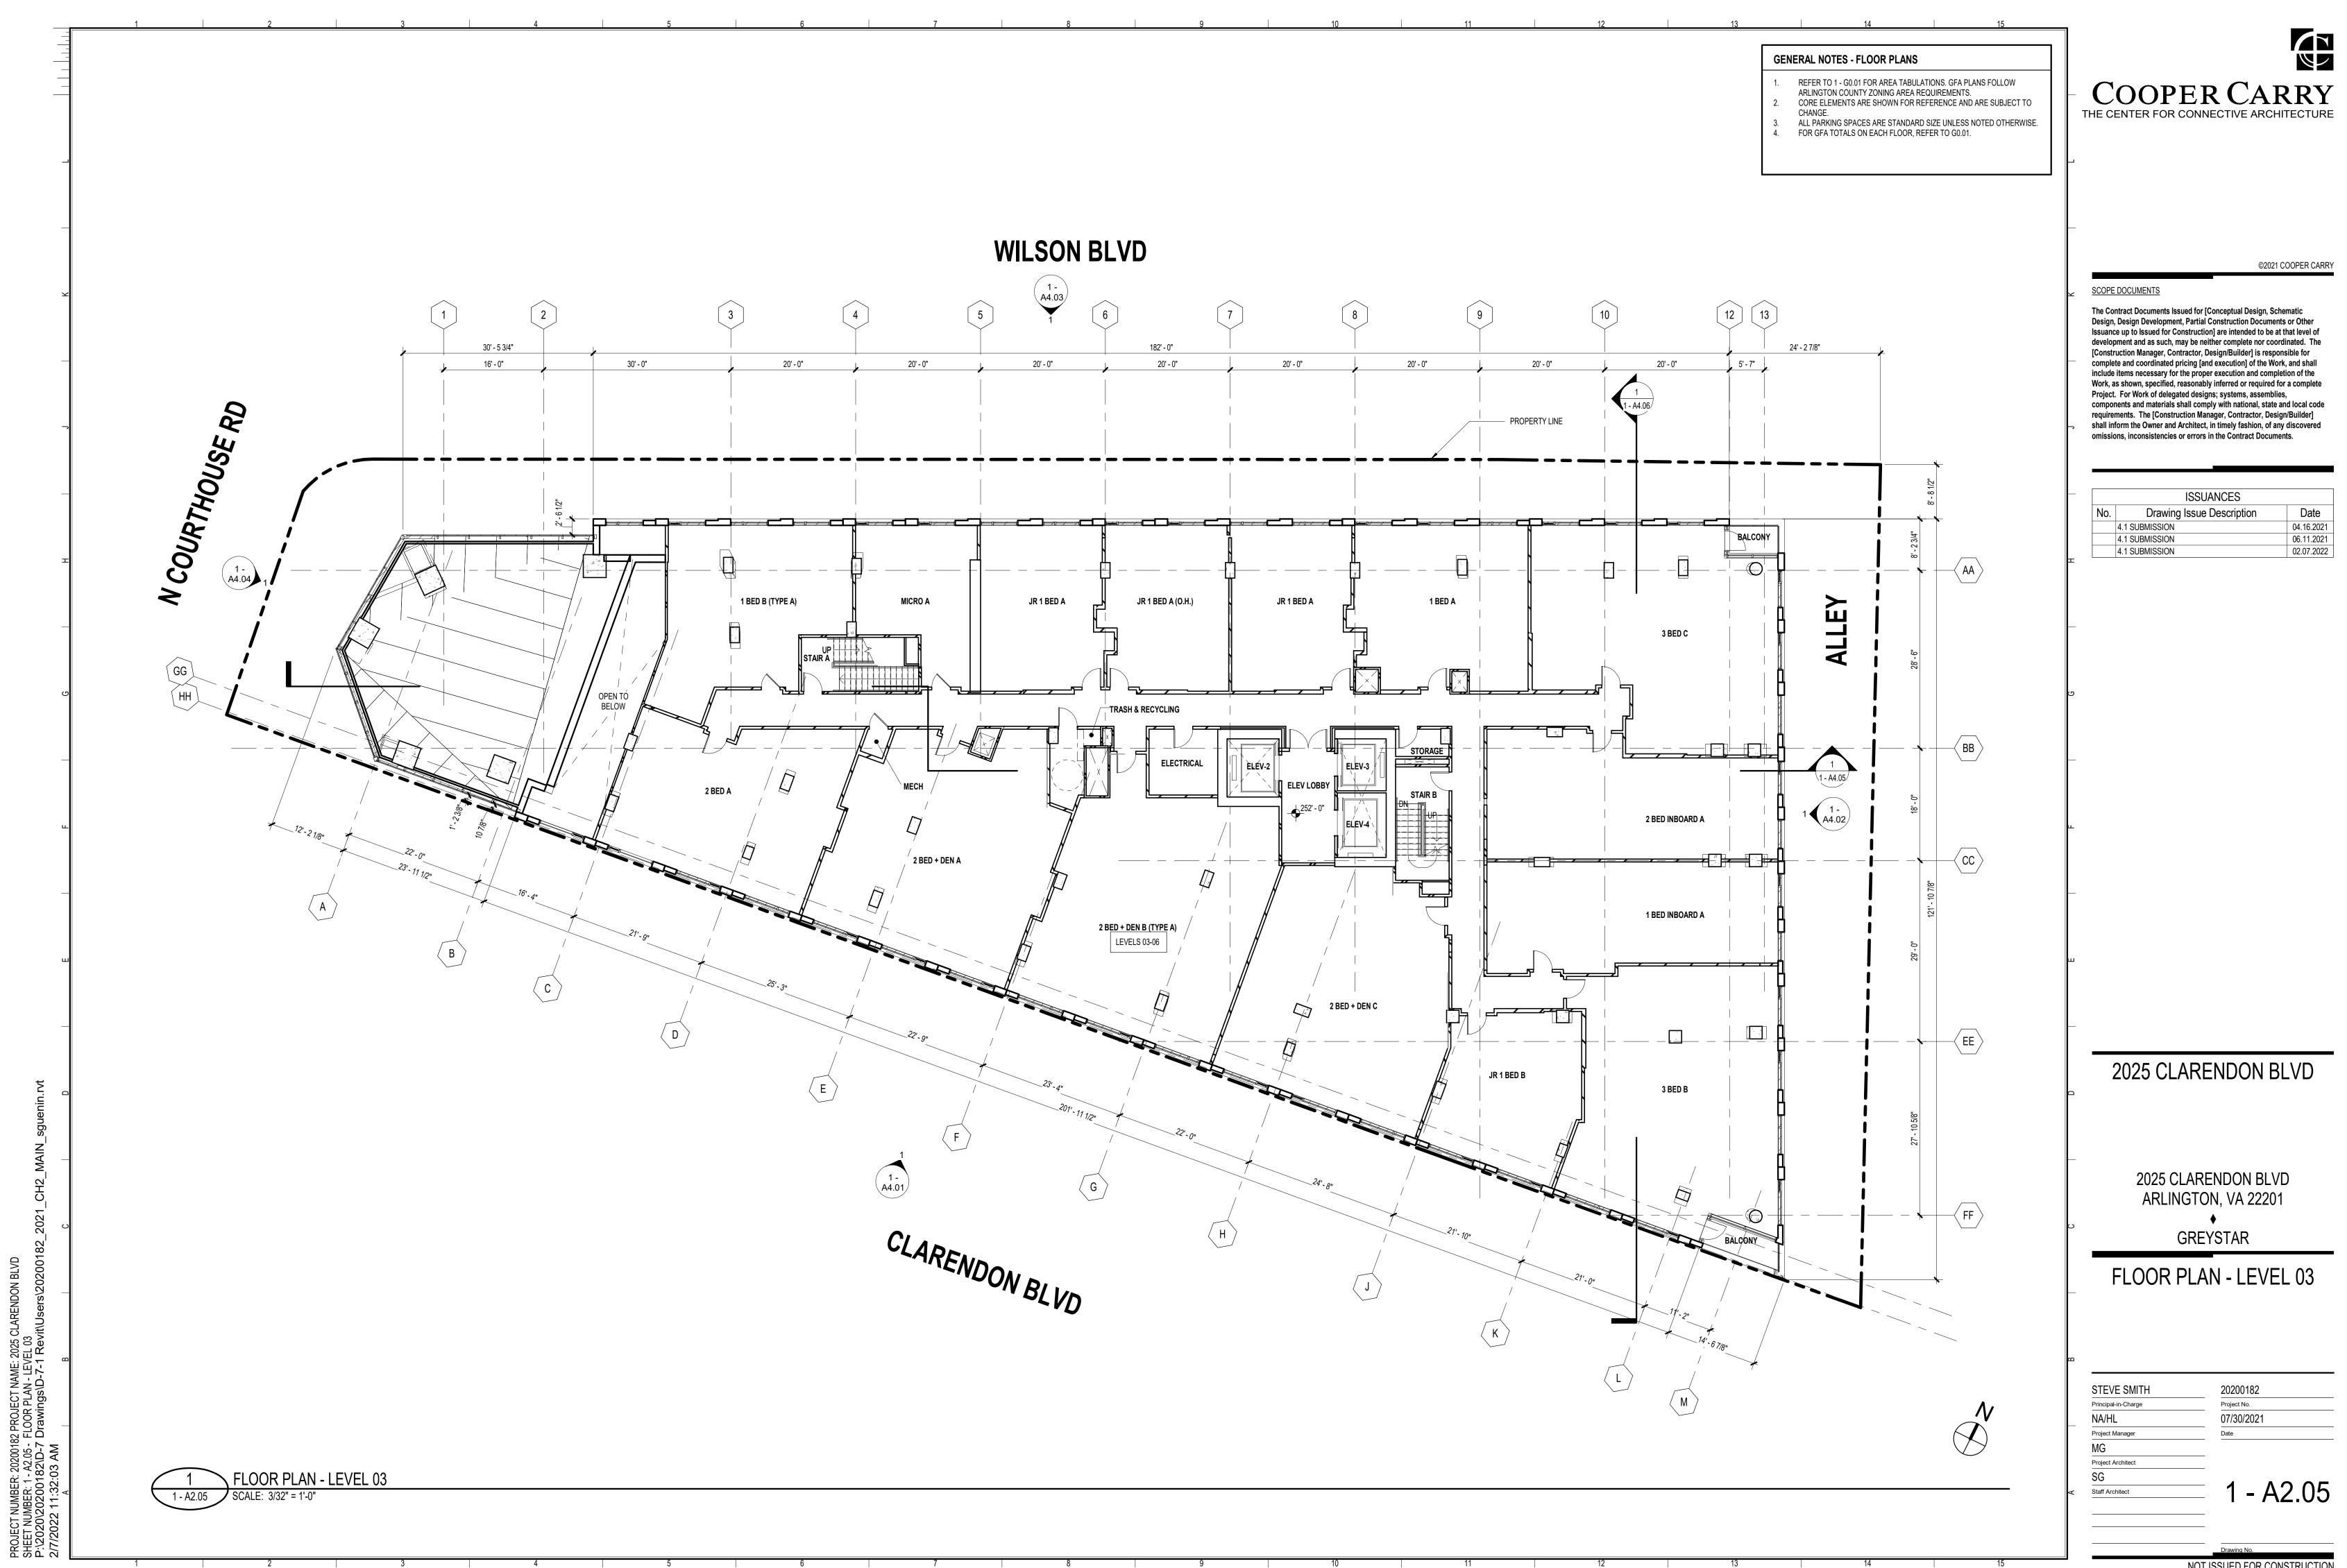


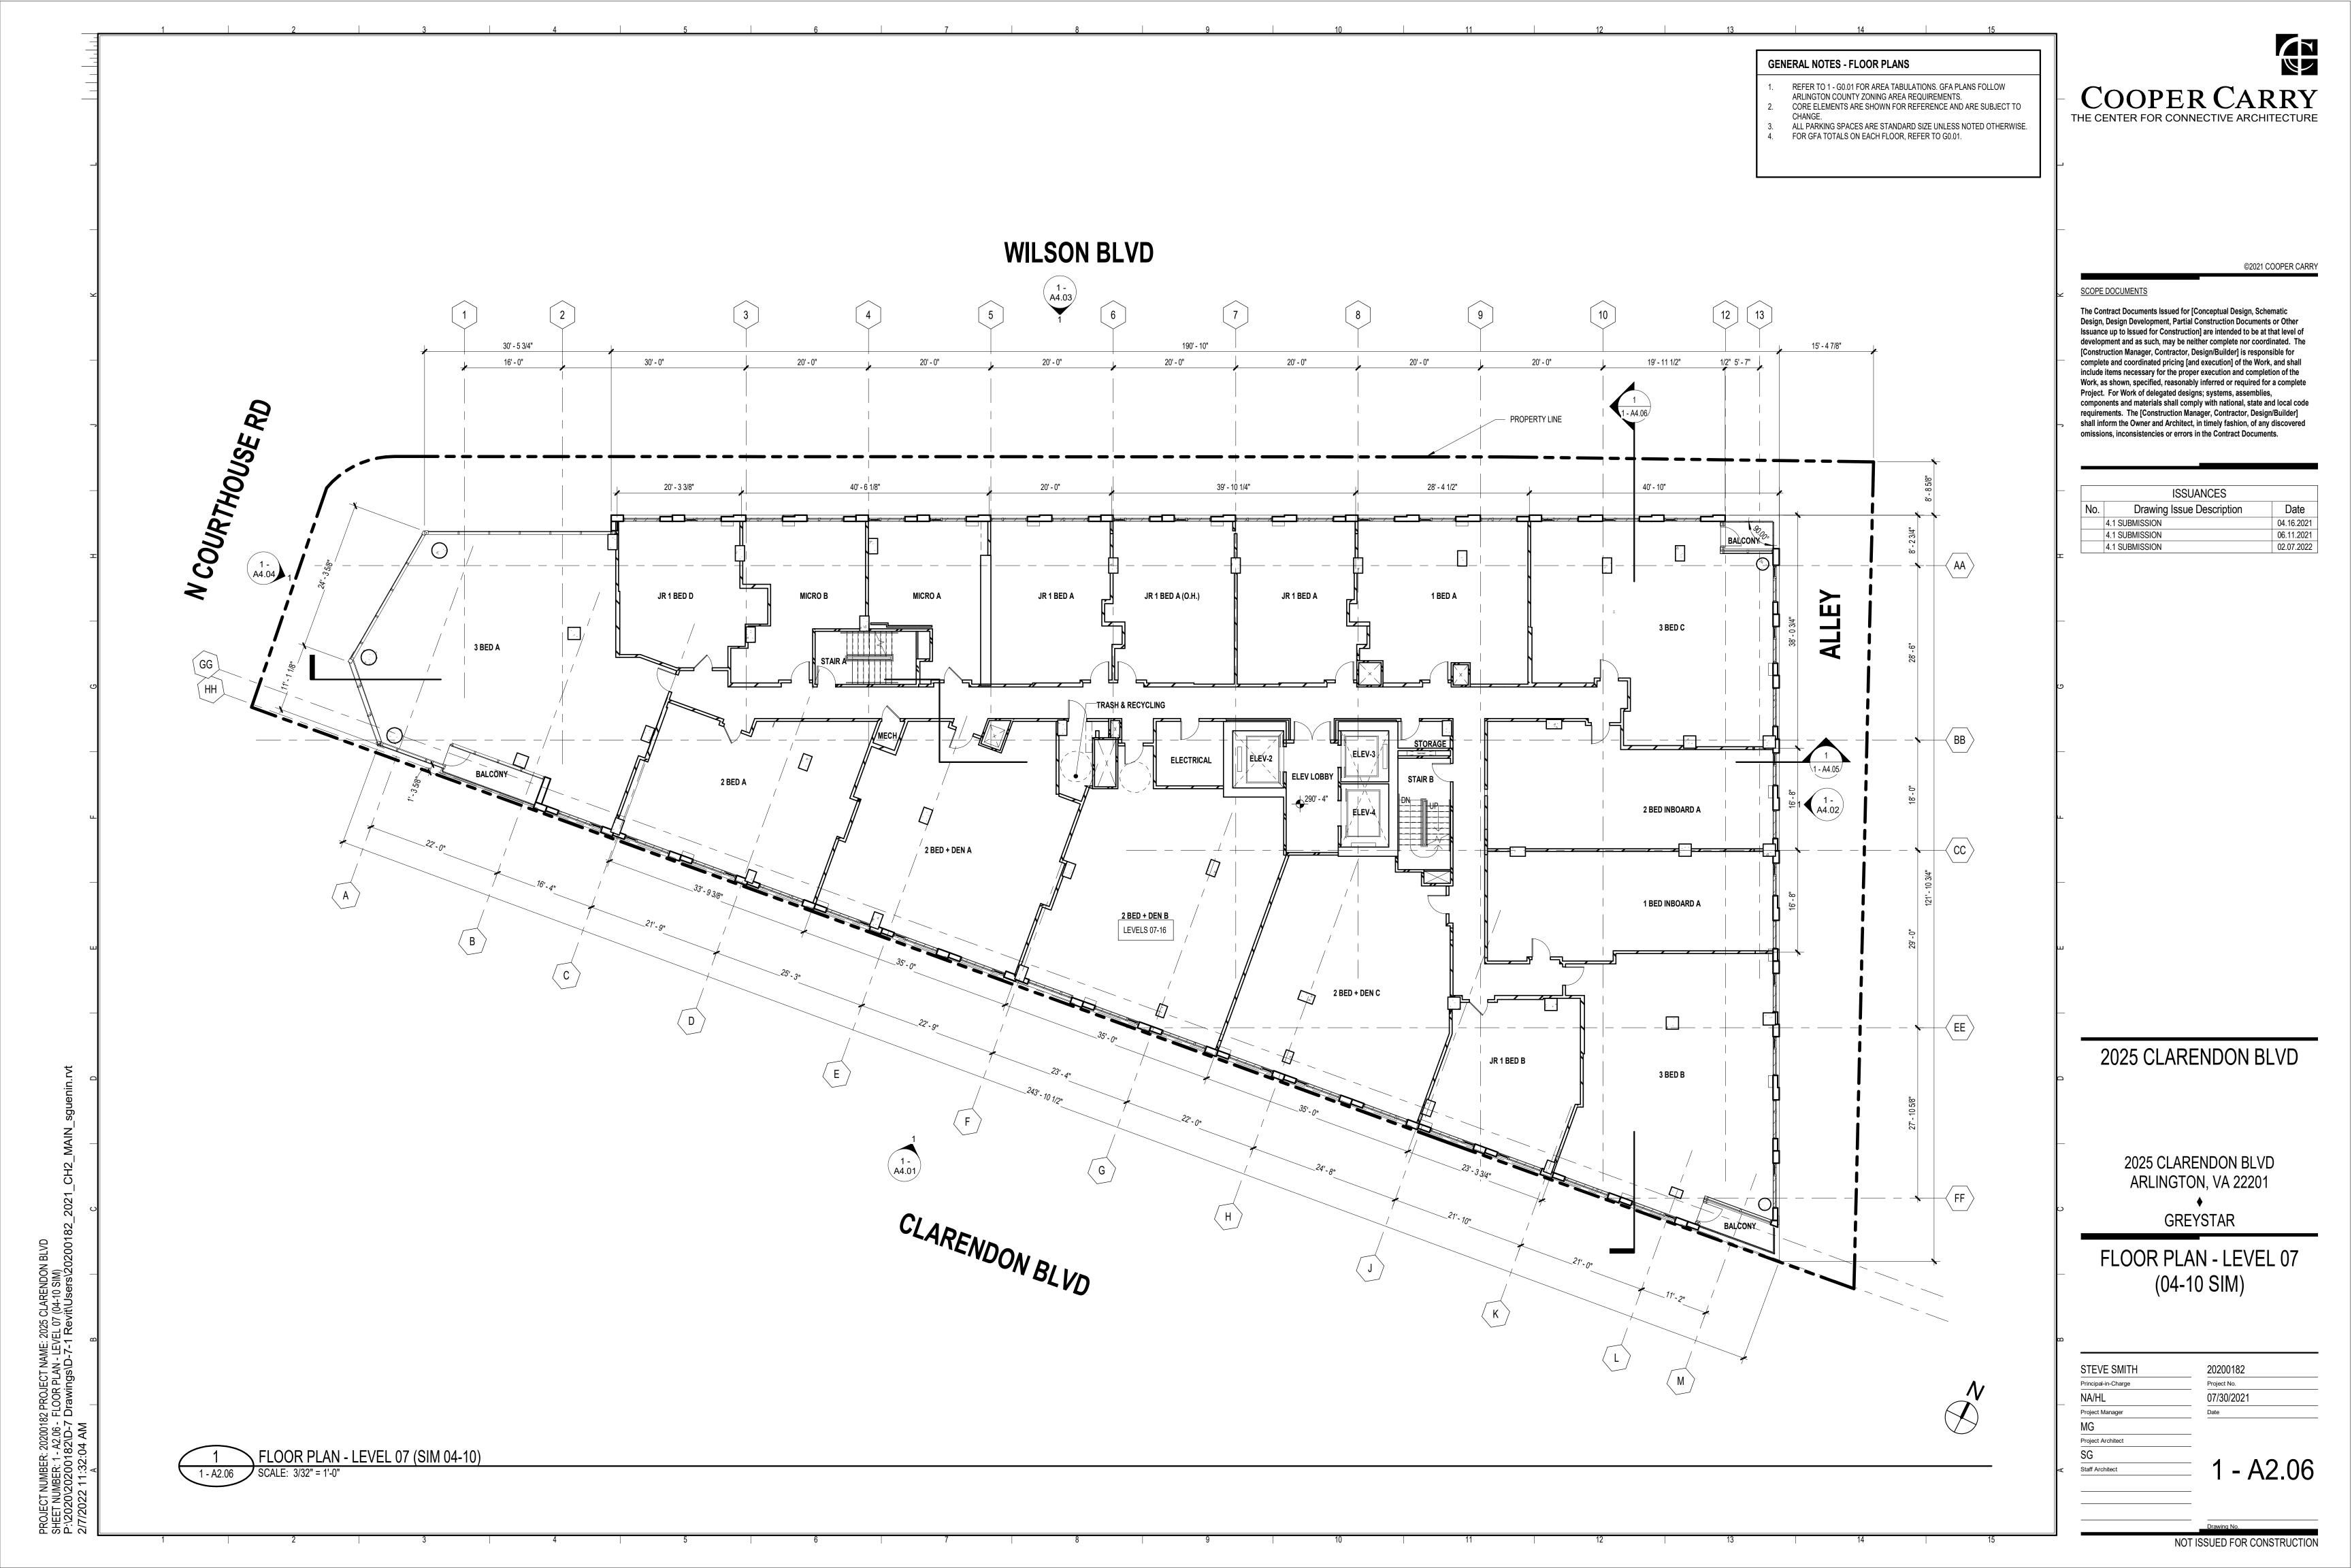


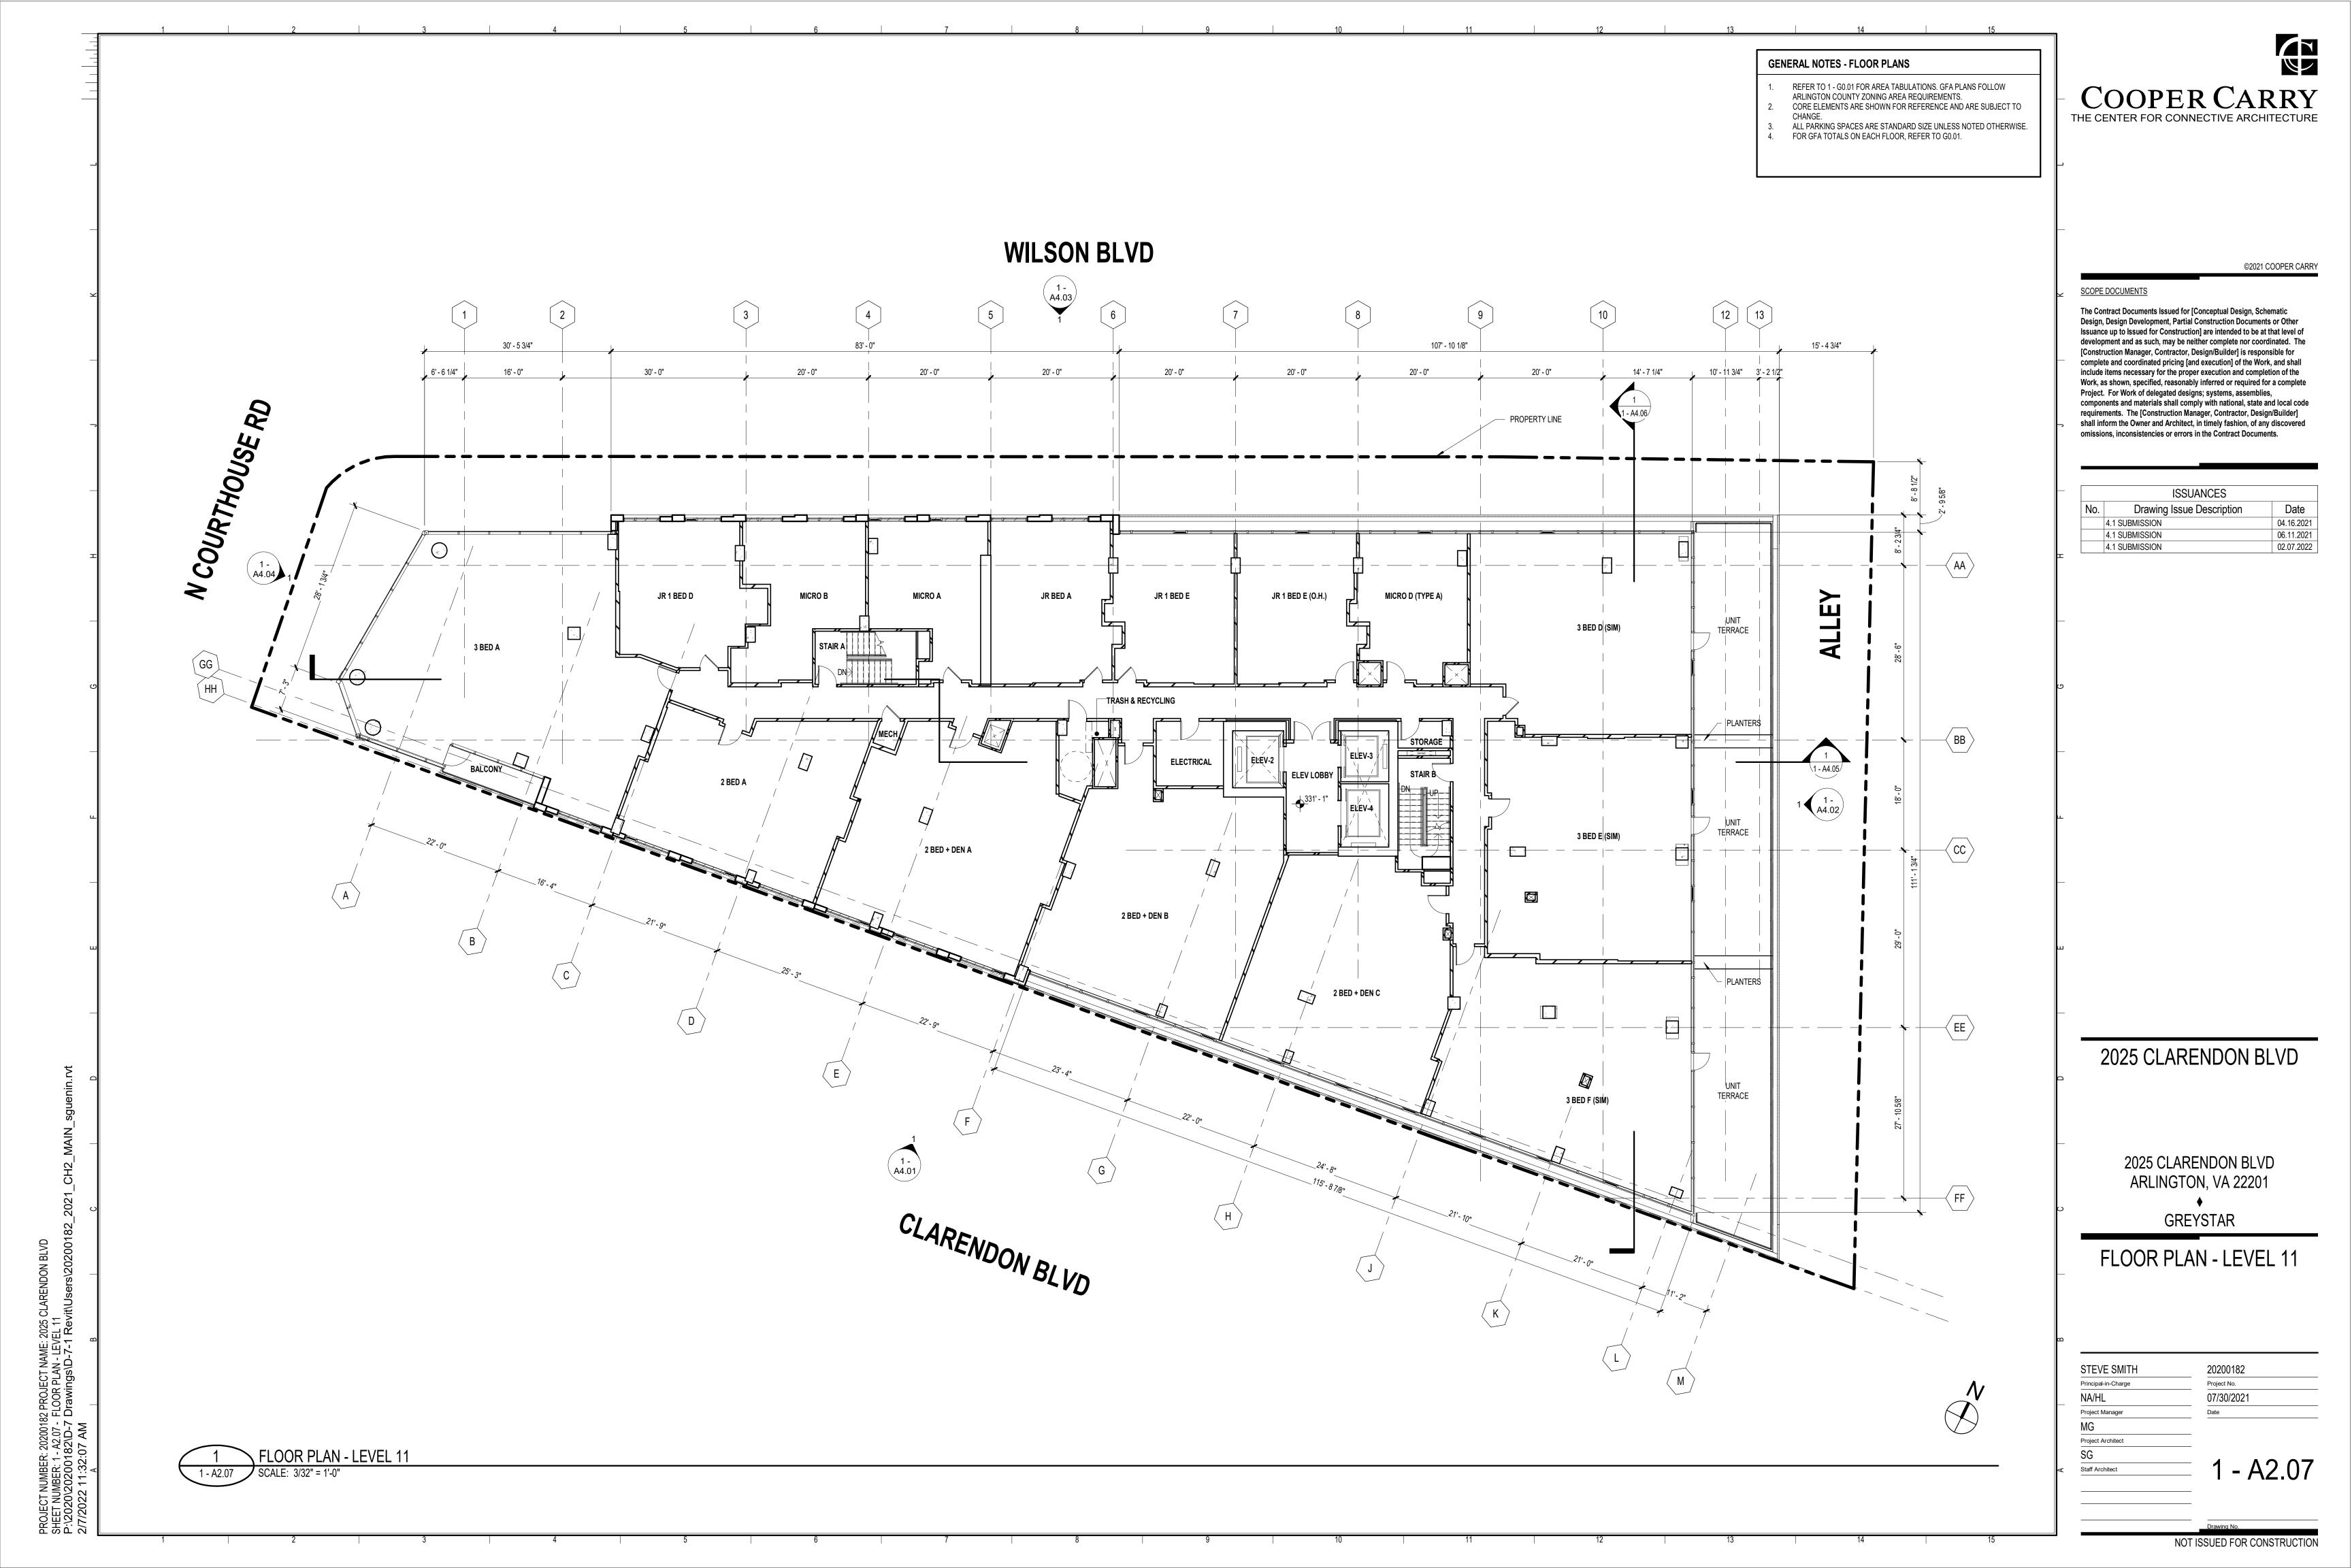


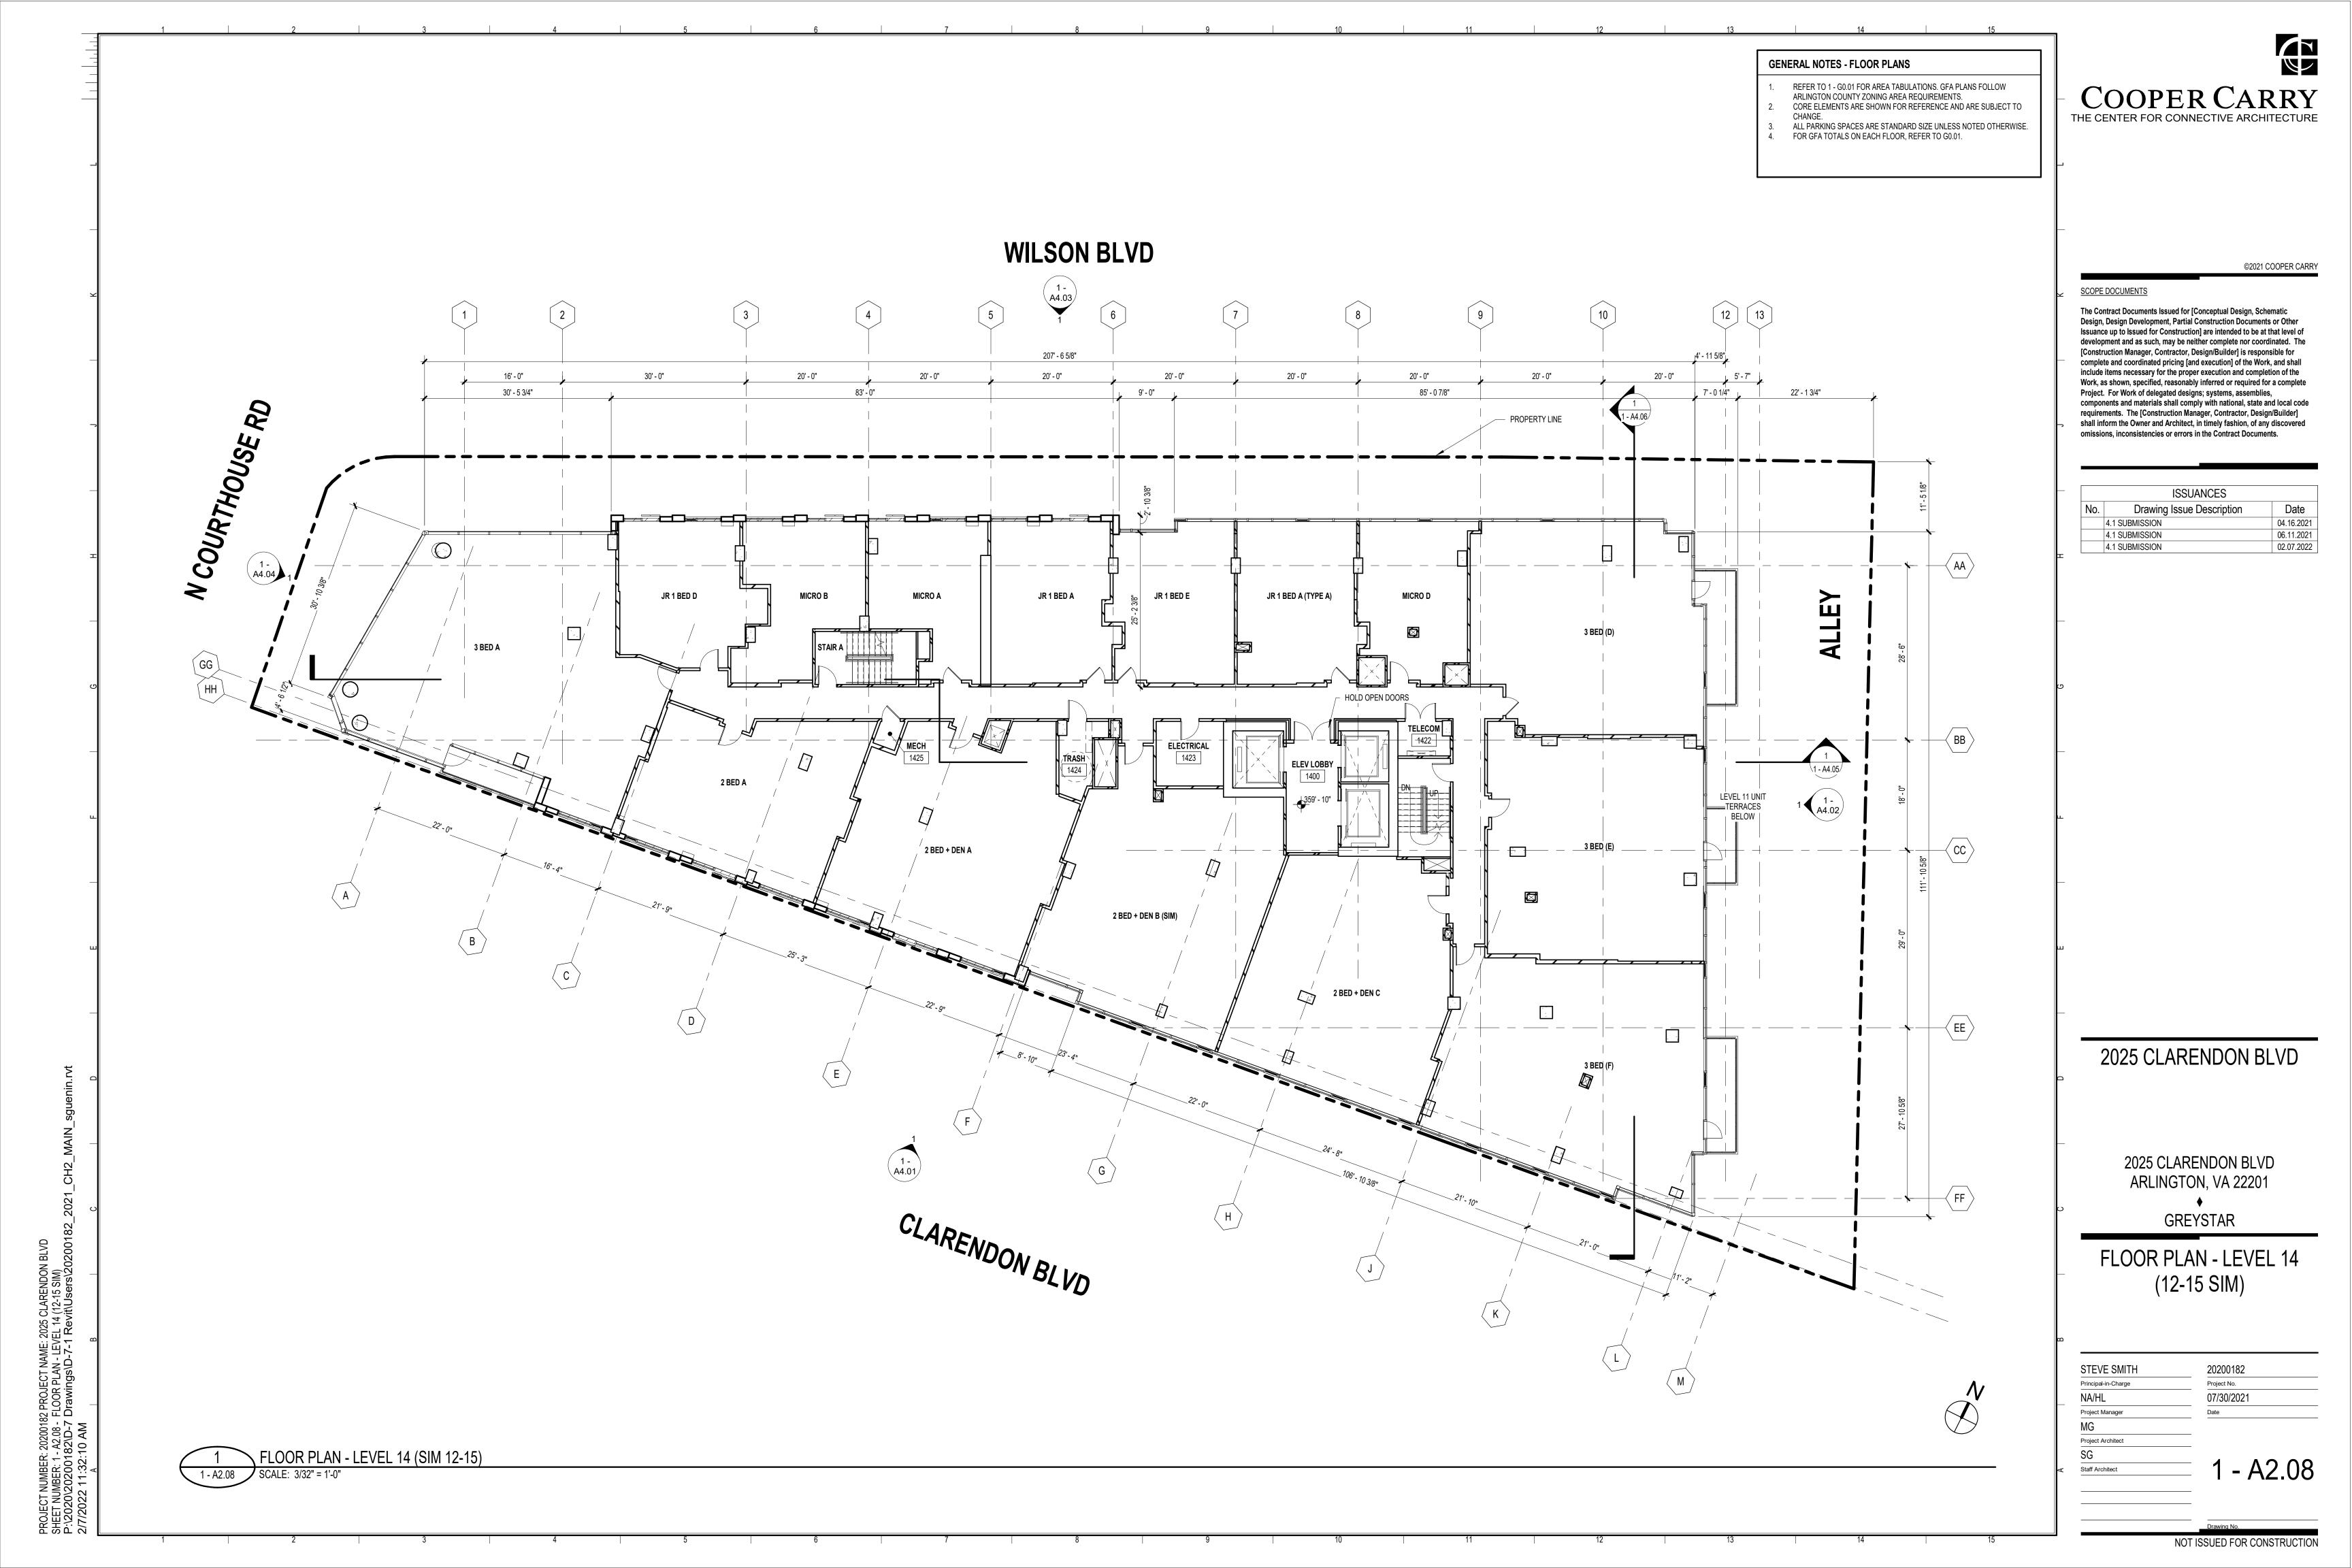

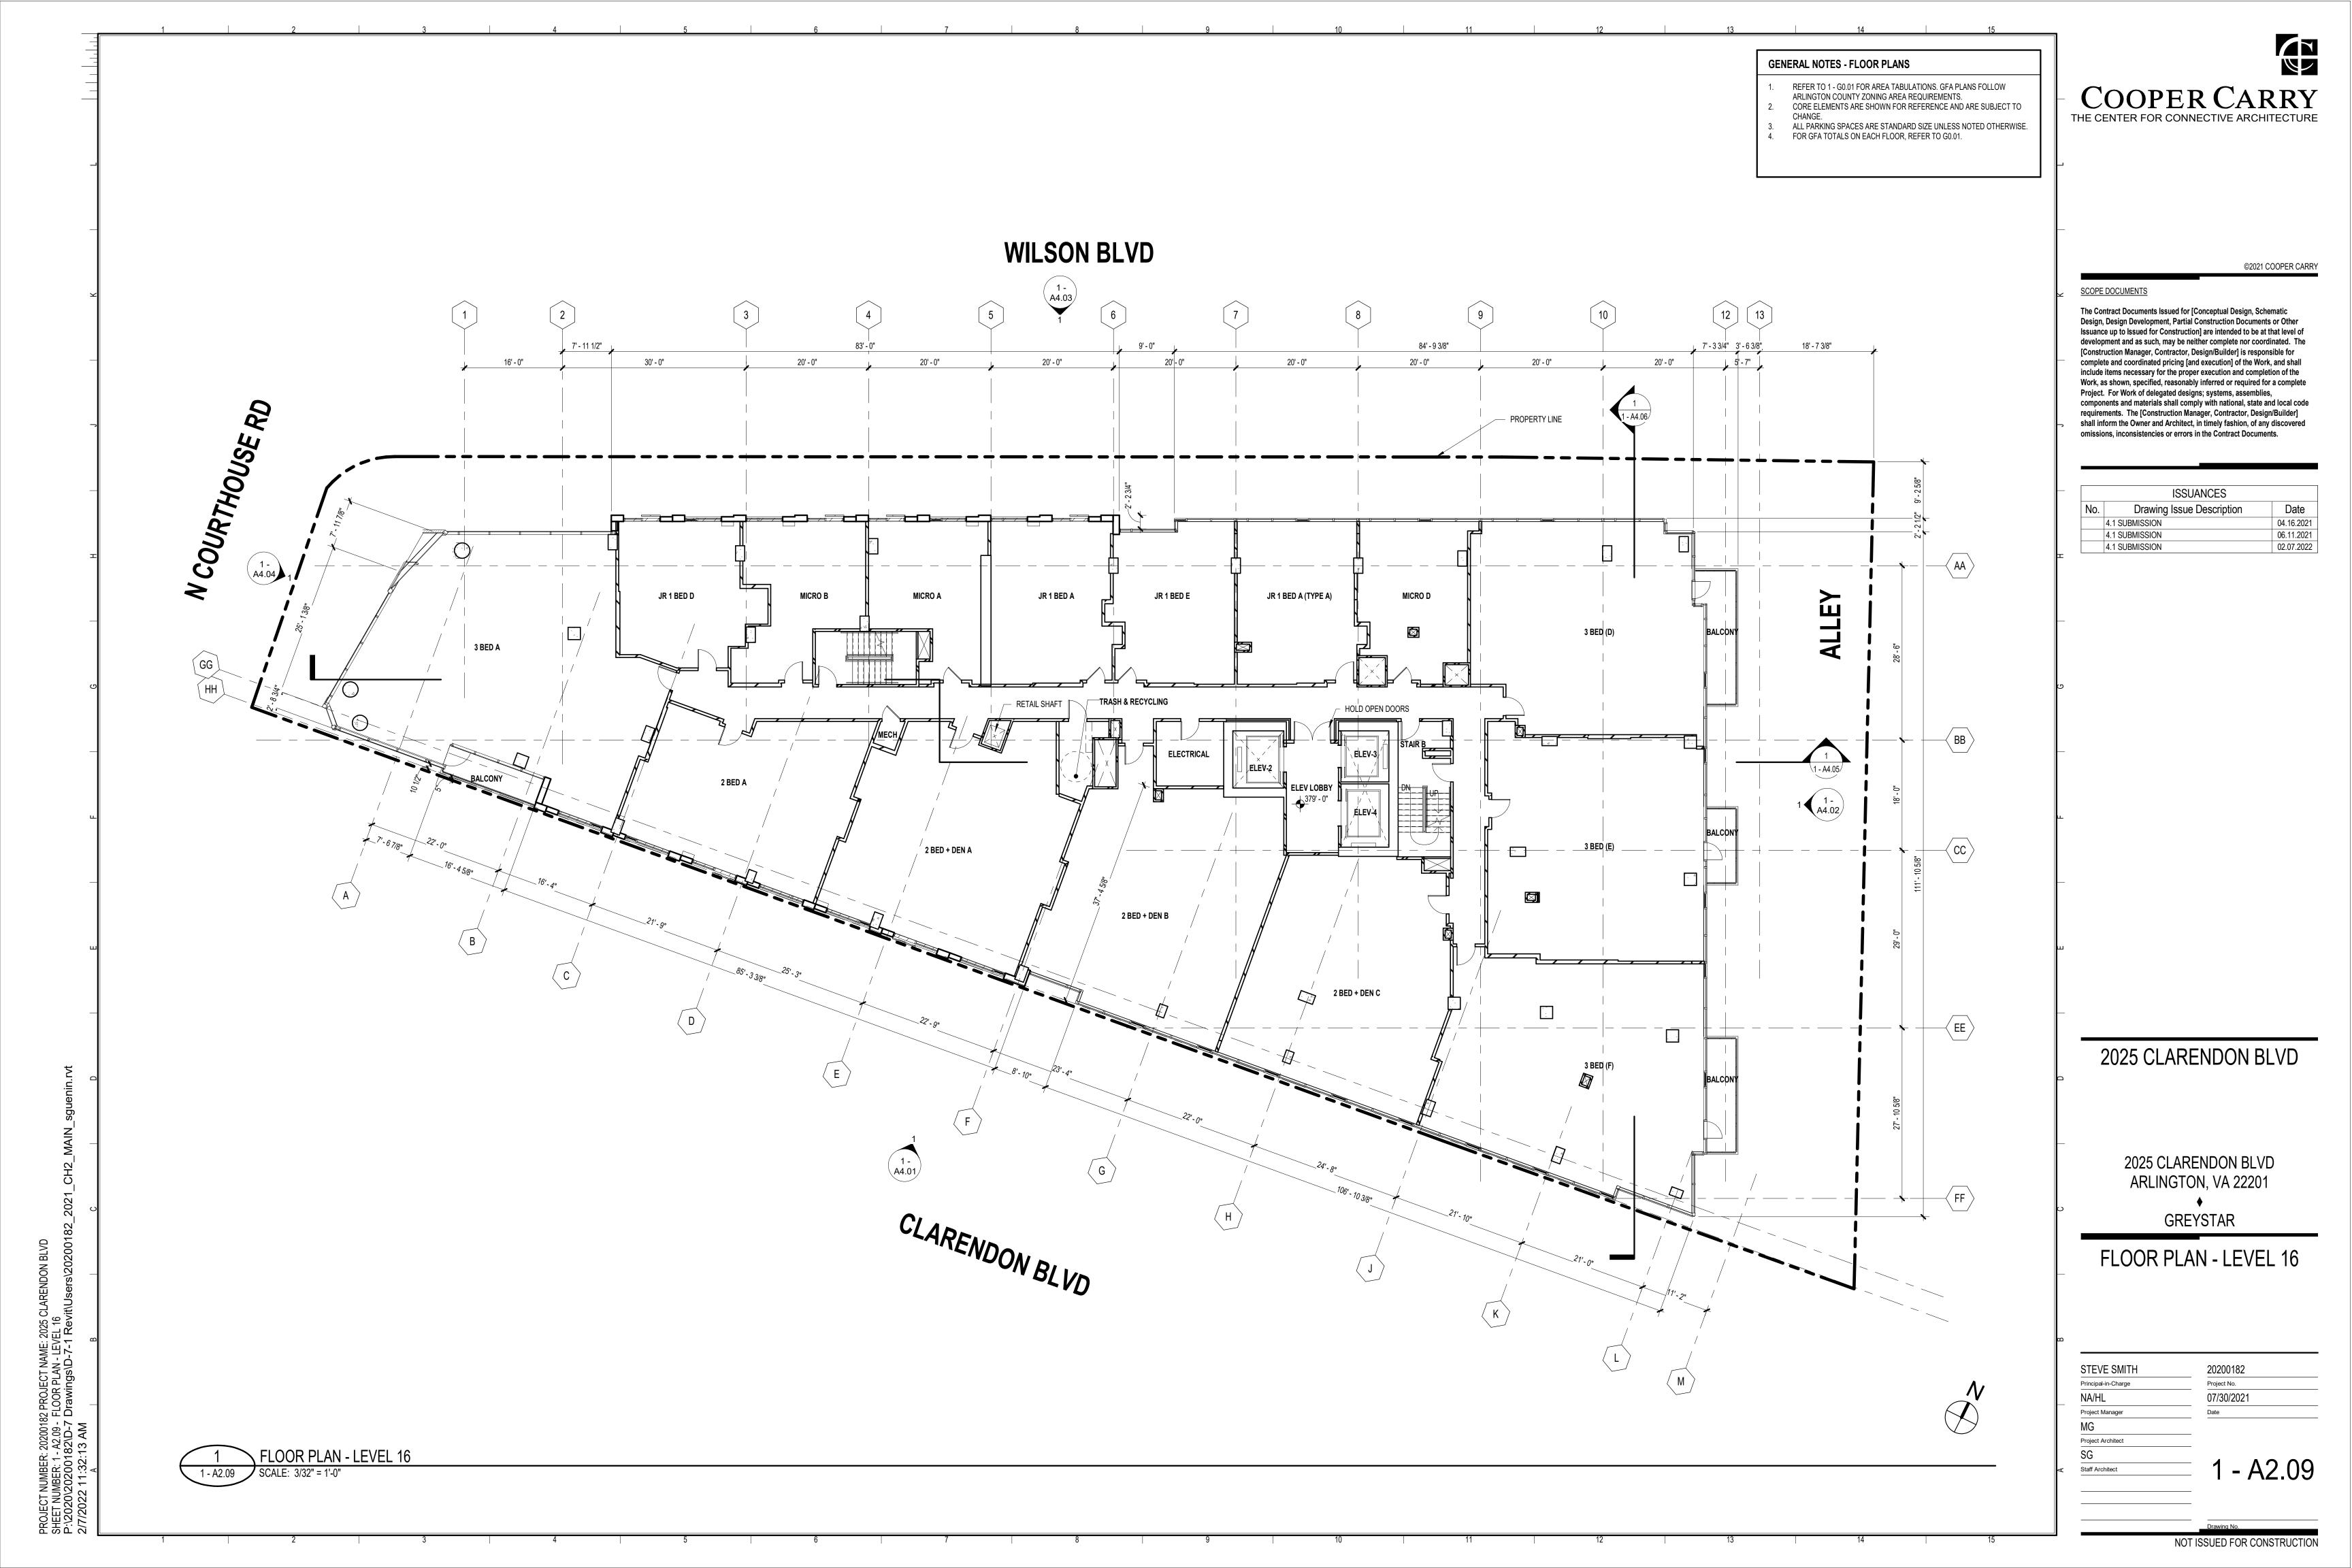

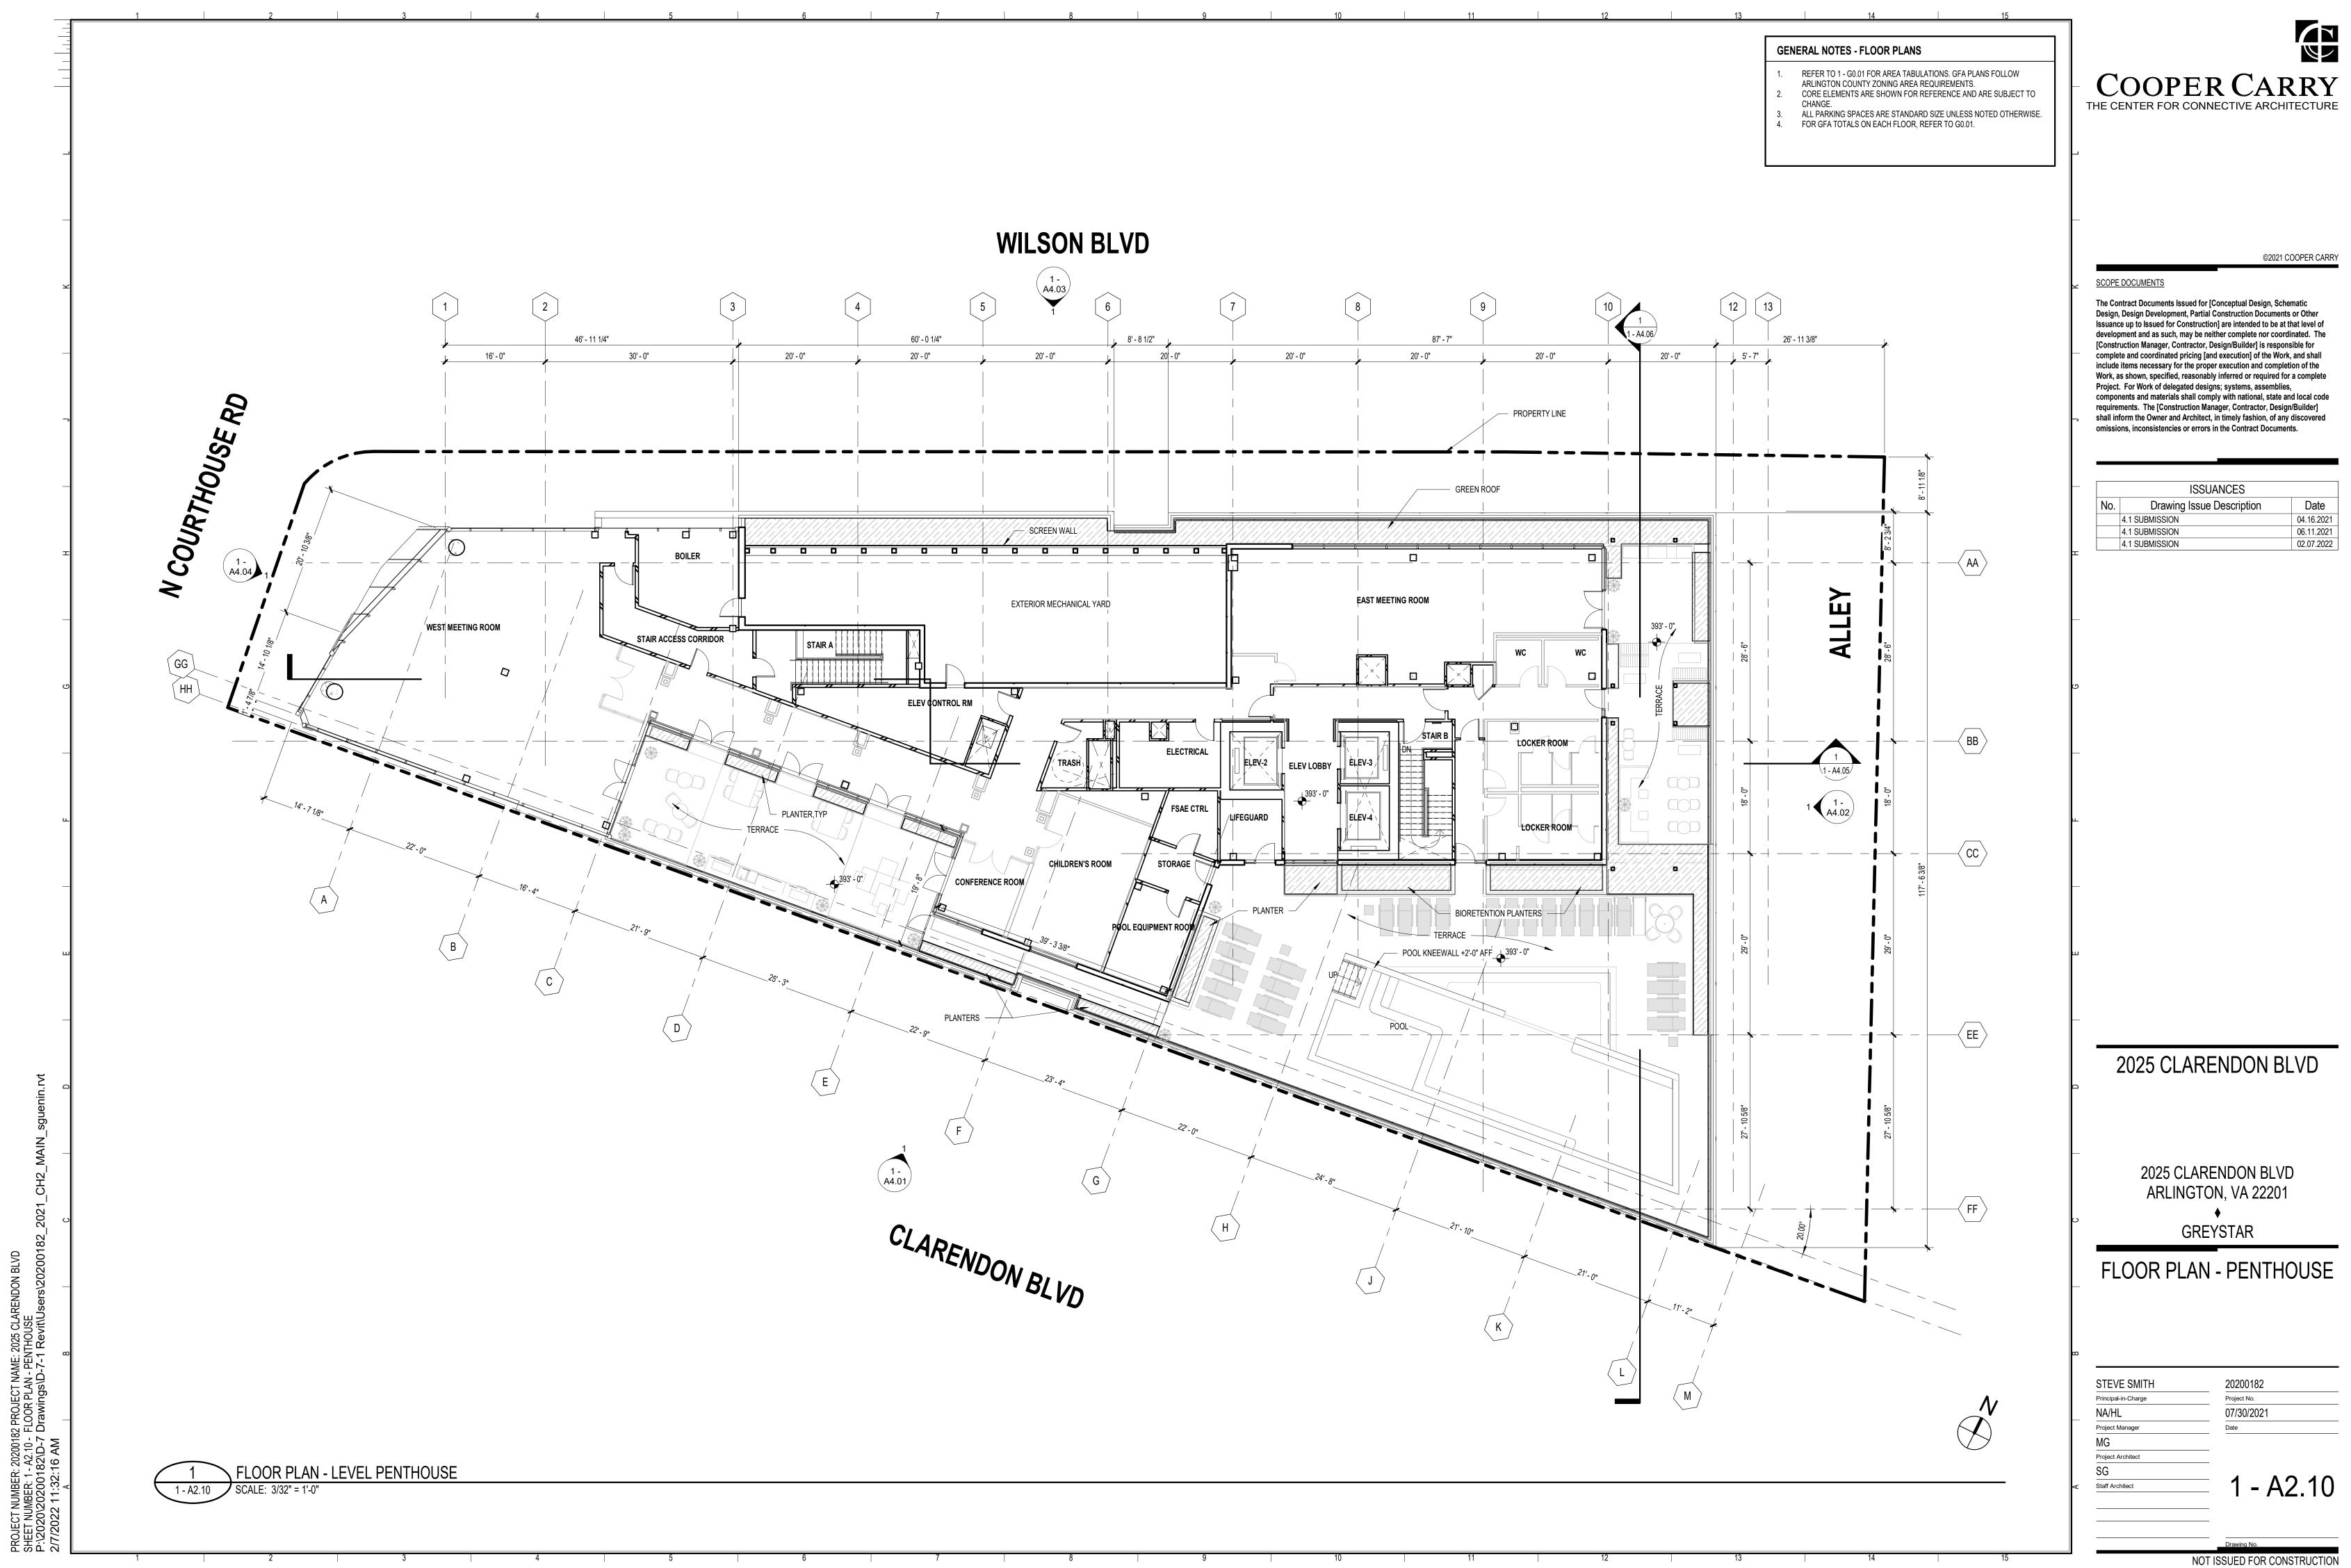

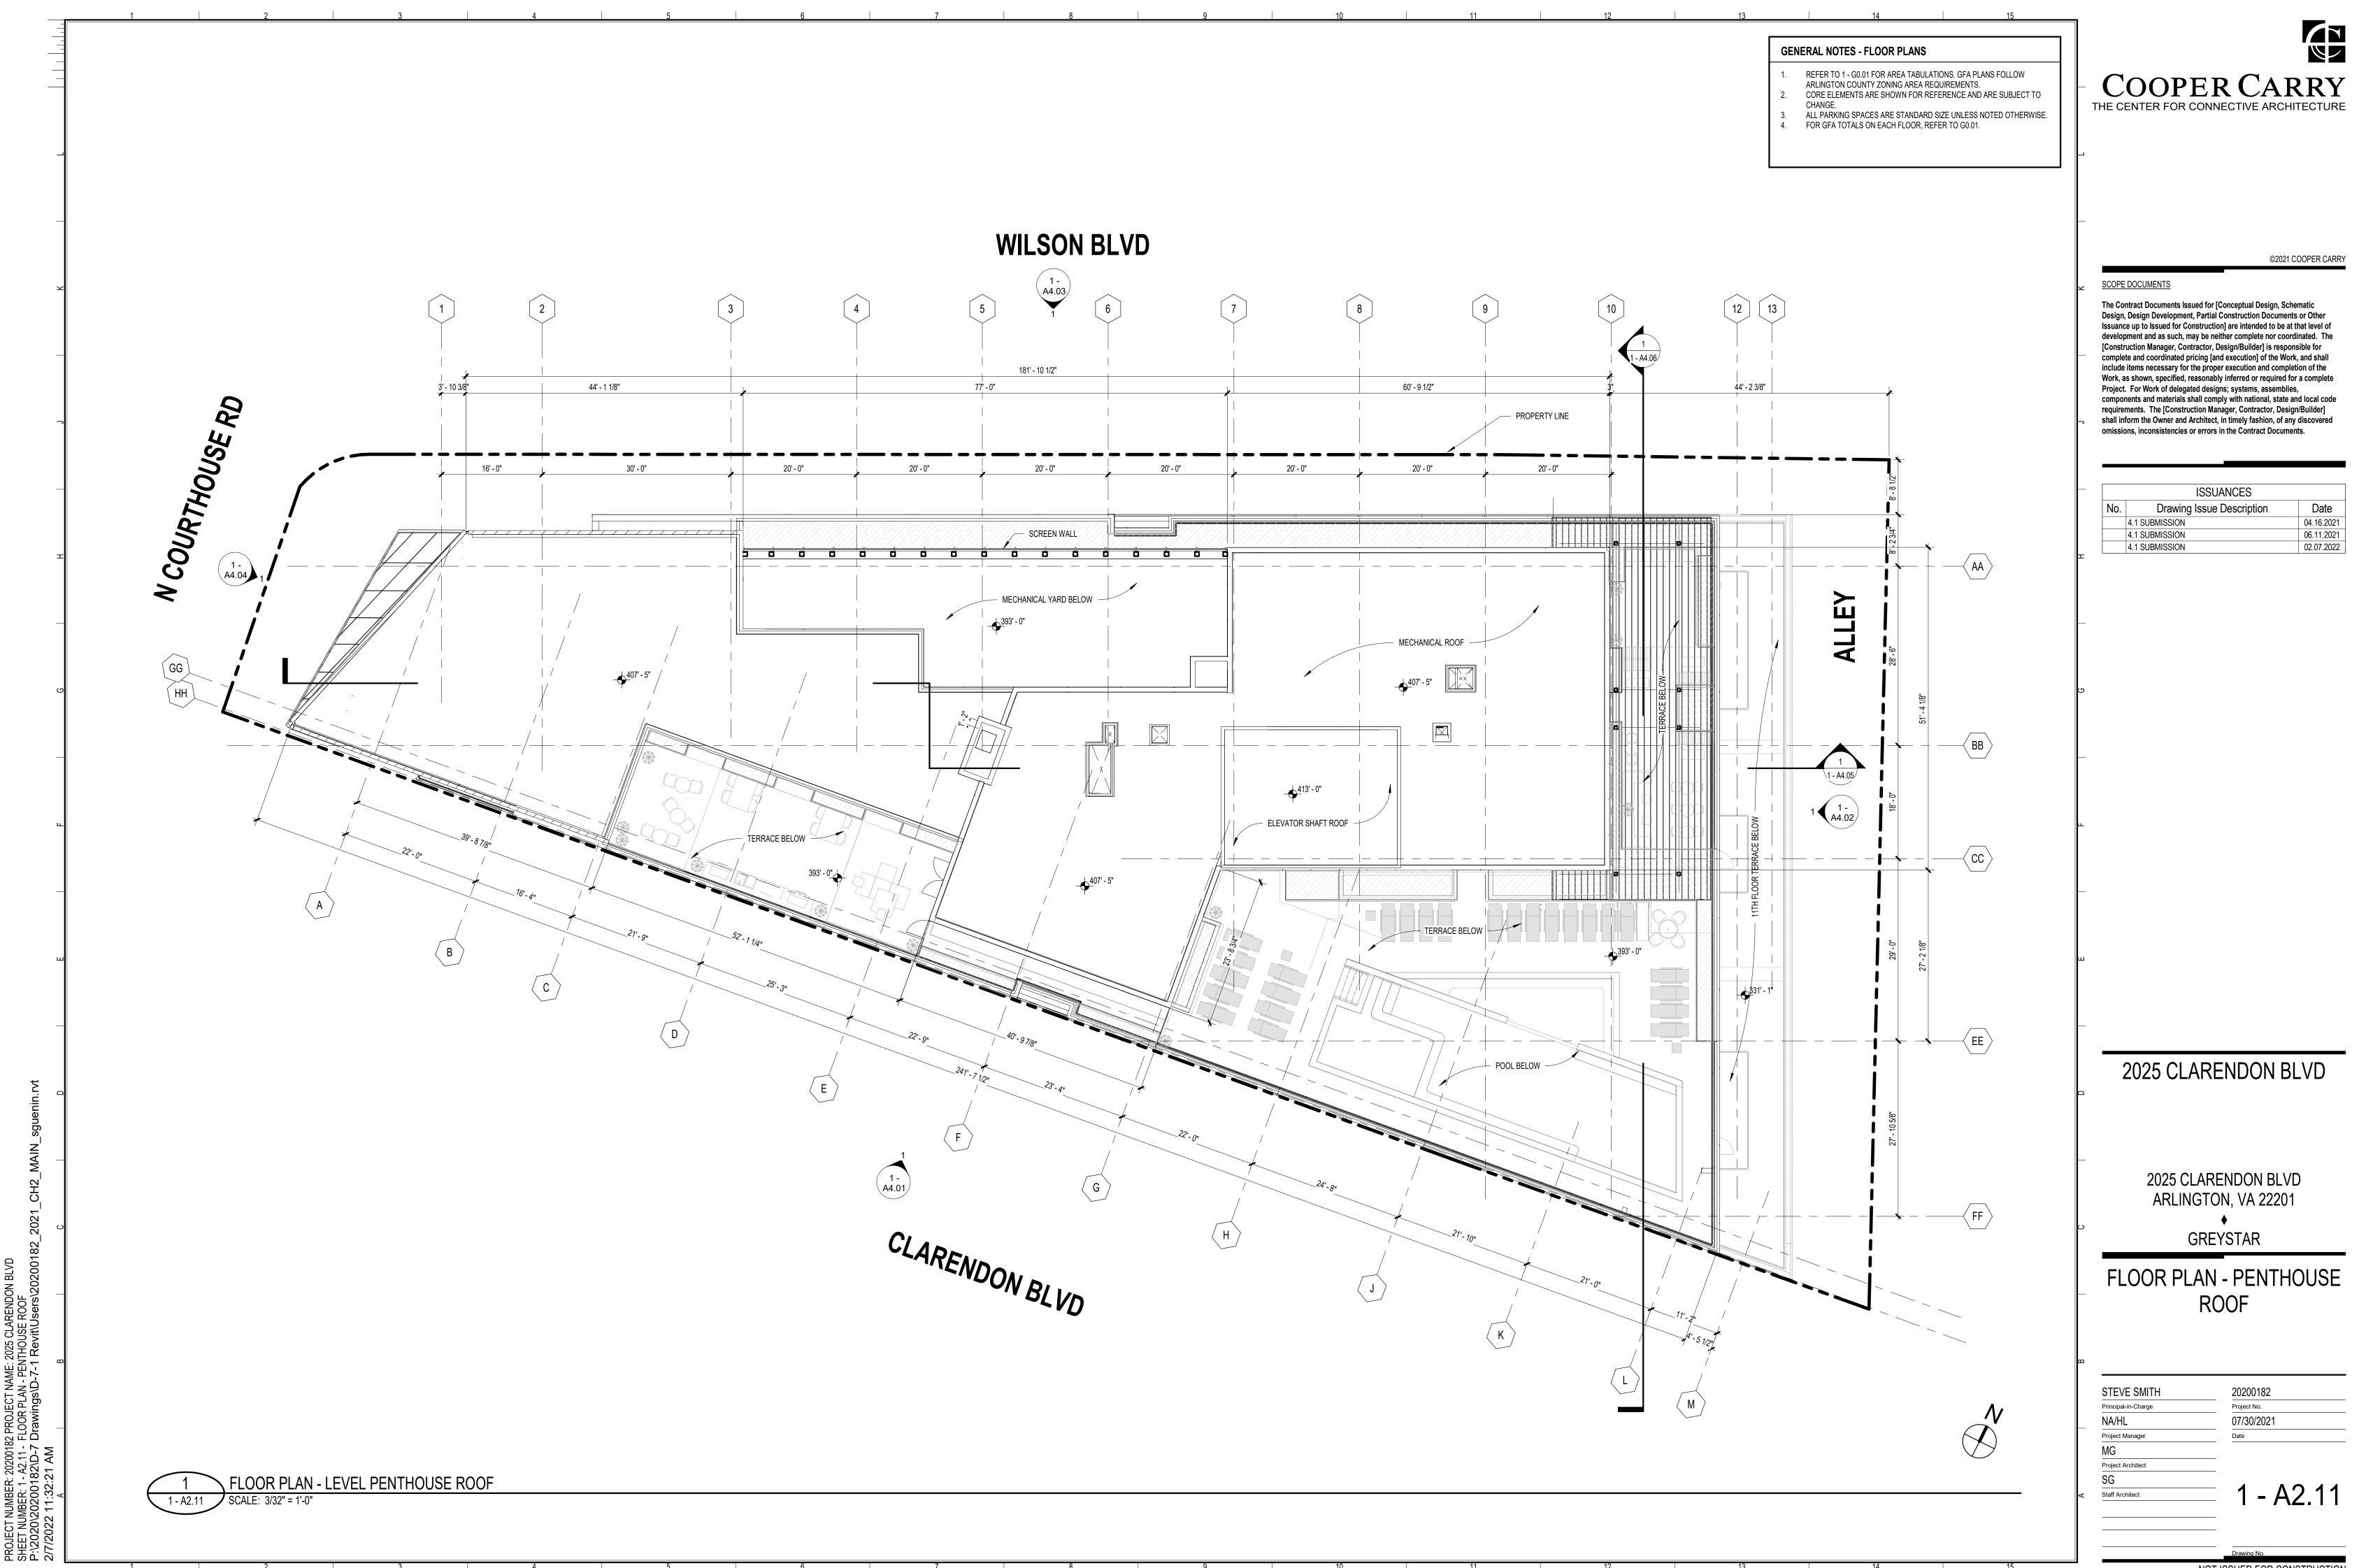

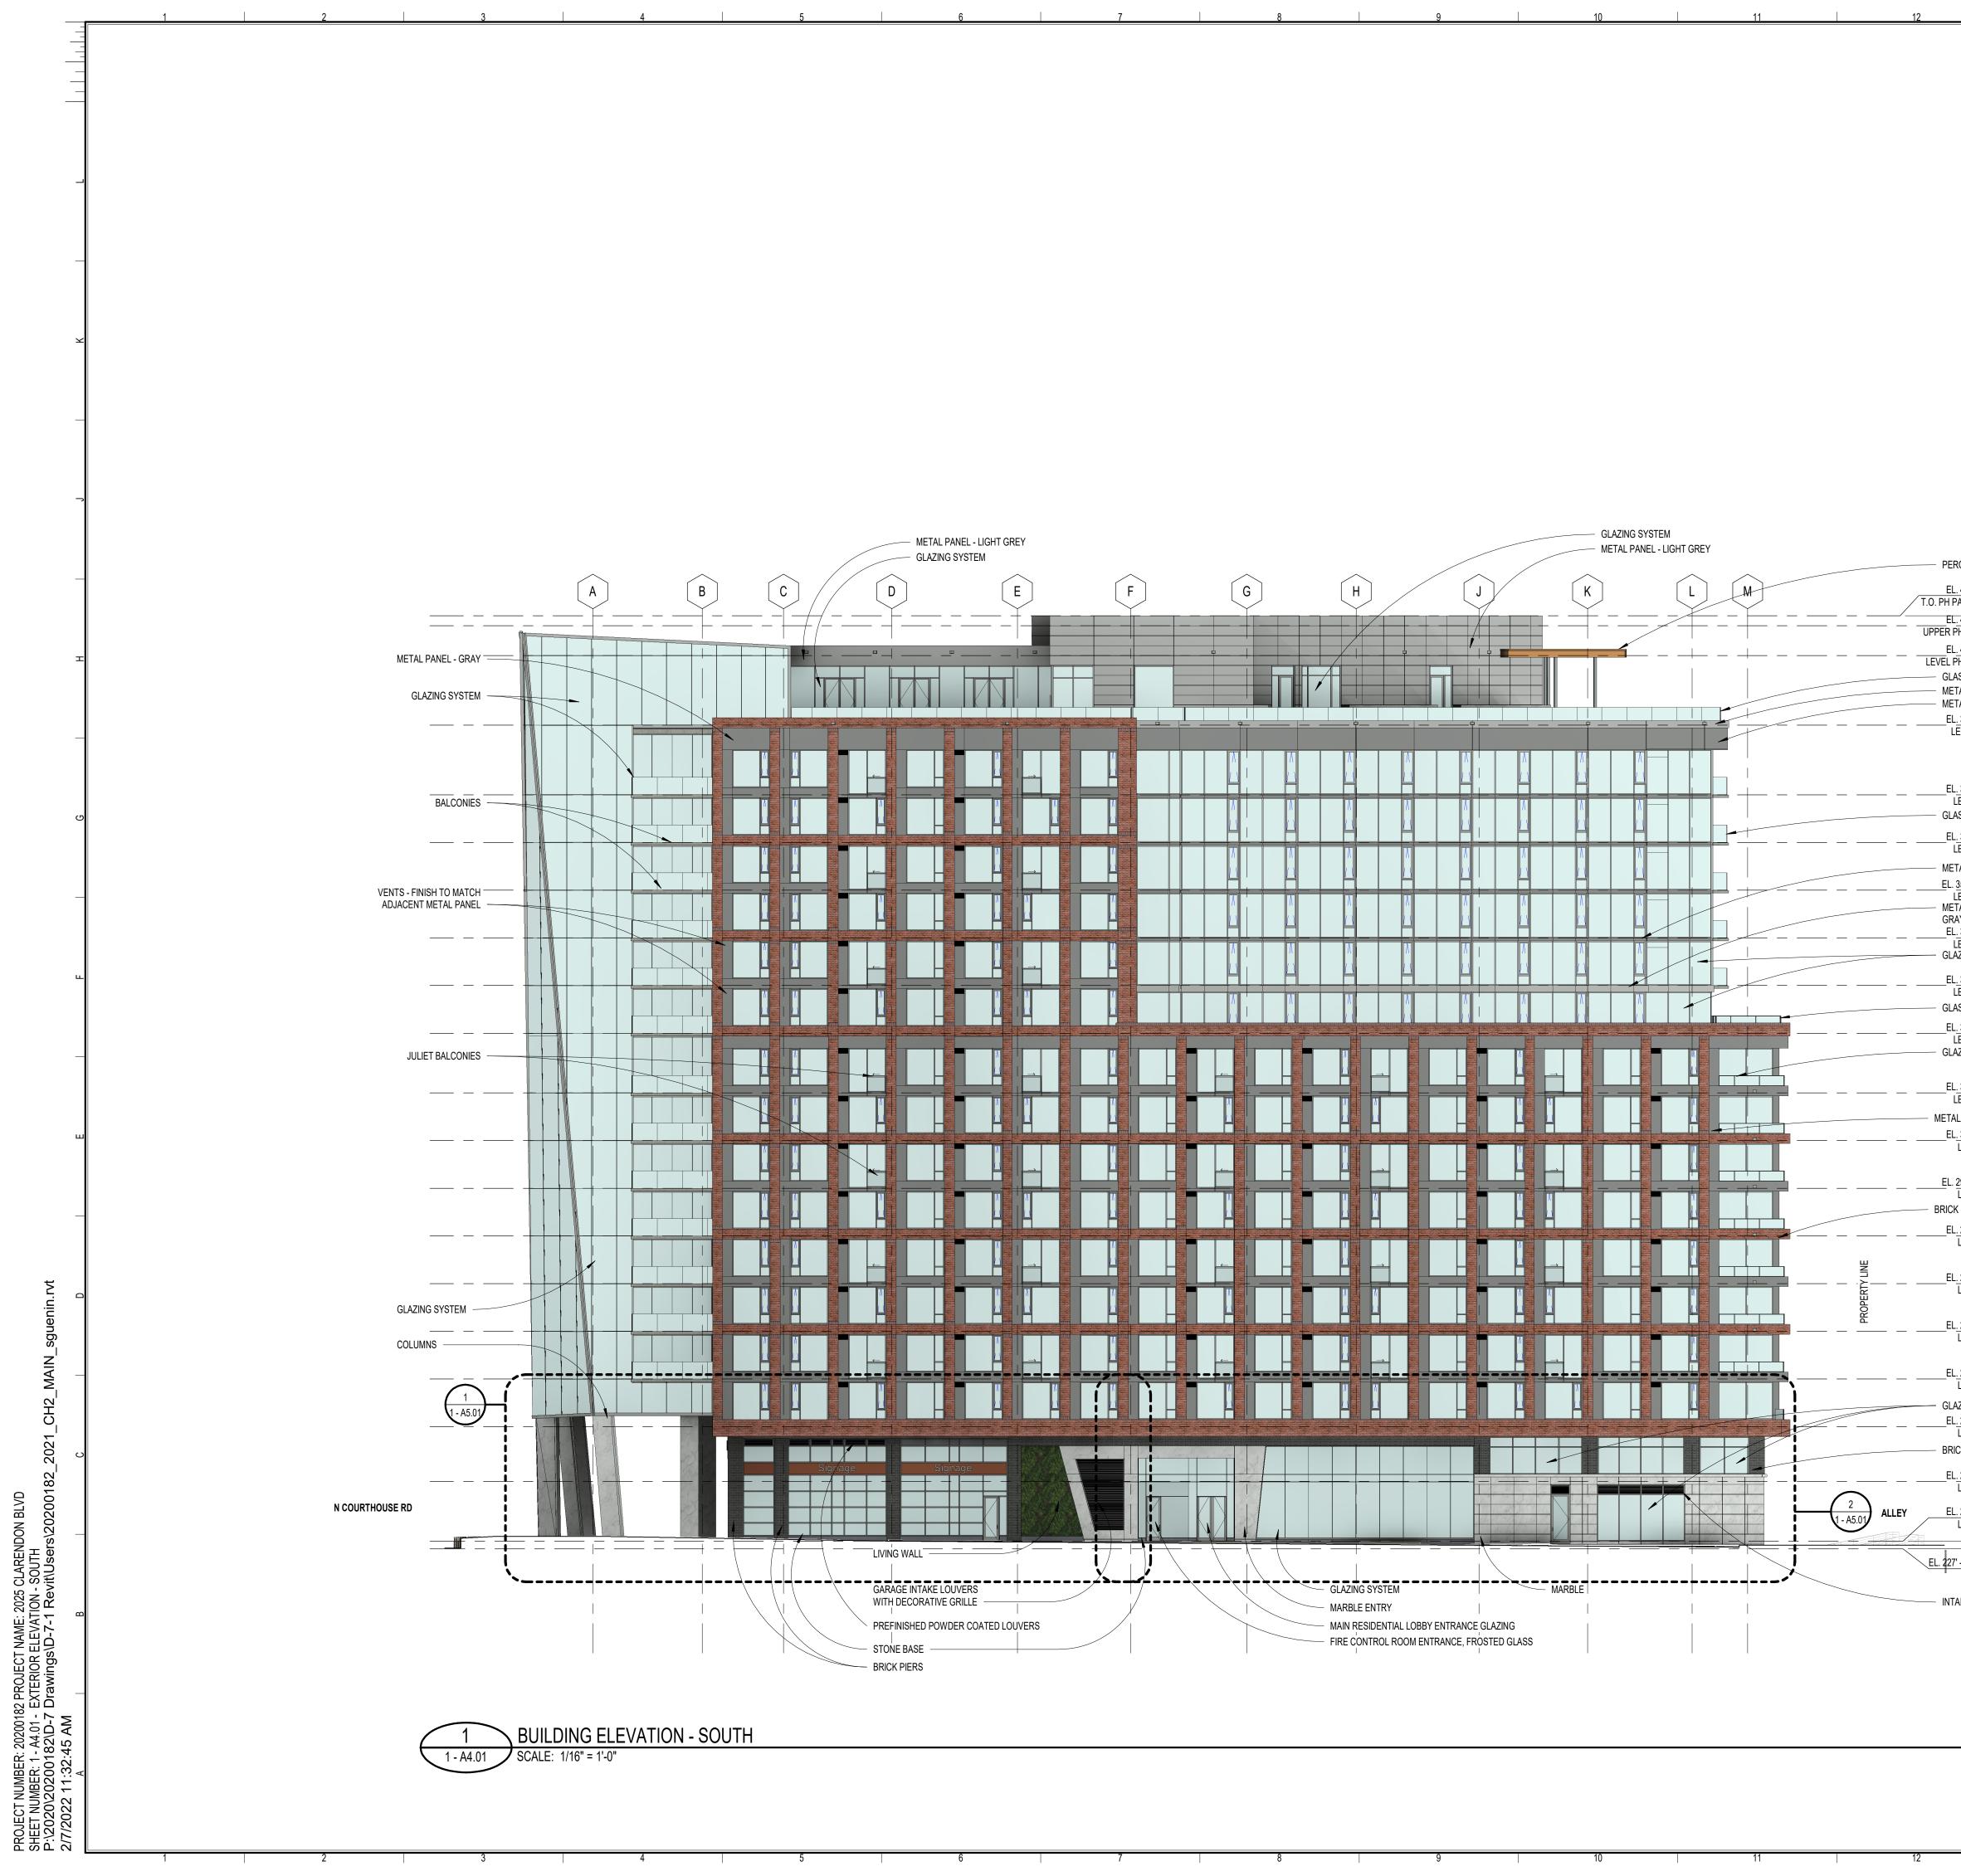

BLVD

	13		14		15	
ſ	VOID/SOLID CALC	ULATIONS - SOL	JTH ELEVATION			
ŀ		AREA TOTAL	VOID AREA	% VOID	% REQ'D	COOPER CARRY
ľ	FRONTAGE FROM 2' TO 10' HIGH	1,907 SF	1,399 SF	73%	50%	THE CENTER FOR CONNECTIVE ARCHITECTUR
L						
						©2021 COOPER CAR
						SCOPE DOCUMENTS The Contract Documents Issued for [Conceptual Design, Schematic
						Design, Design Development, Partial Construction Documents or Other Issuance up to Issued for Construction] are intended to be at that level of development and as such, may be neither complete nor coordinated. The
						[Construction Manager, Contractor, Design/Builder] is responsible for complete and coordinated pricing [and execution] of the Work, and shall include items necessary for the proper execution and completion of the
						Work, as shown, specified, reasonably inferred or required for a complete Project. For Work of delegated designs; systems, assemblies, components and materials shall comply with national, state and local code requirements. The [Construction Manager, Contractor, Design/Builder]
						shall inform the Owner and Architect, in timely fashion, of any discovered omissions, inconsistencies or errors in the Contract Documents.
PERGOLA, WOOD						
EL. 415' - 0"	2 <sup>.</sup> - 0 <sup>.</sup>					ISSUANCES No. Drawing Issue Description Date
EL. 413' - 0" ER PH ROOF						4.1 SUBMISSION         04.16.202           4.1 SUBMISSION         06.11.202
EL. 407' - 0" EL PH ROOF GLASS GUARDRAIL	(23'- M					
METAL PANEL - LIGHT METAL PANEL - GRAY EL. 393' - 0"	GRAY 14 - 0"					
LEVEL PH	50 -					_
_EL. 379' - 0" LEVEL 16	4					
GLASS GUARDRAIL _EL_369' - 5" LEVEL 15						ფ
METAL PANEL - GRAY	- <sup>-</sup> - <sup>-</sup>					
EL. 359' - 10" LEVEL 14 METAL PANEL - LIGHT GRAY						_
EL. 350' - 3" LEVEL 13 GLAZING SYSTEM						
EL. 340' - 8" LEVEL 12						ц.
GLASS GUARDRAIL _EL. 331' - 1" LEVEL 11	6					
GLAZING SYSTEM	12' - 0"					
_EL <u>. 319' - 1"</u> LEVEL 10 ETAL PANEL - DARK	9'- 7" 44"					
_EL. 309' - 6" LEVEL 9	1 7" 9'- 7" 165'- 6 3/4" BUILDING HEIGHT					ш
EL. 299' - 11" LEVEL 8						
RICK - RED BLEND _EL. 290' - 4" LEVEL 7	6,-1					
_EL280' - 9" LEVEL 6	6					2025 CLARENDON BLVD
	19					
_EL. 271' <u>- 2"</u> LEVEL 5						
_EL. 261' - 7" LEVEL 4 GLAZING SYSTEM	<u>الم</u>					2025 CLARENDON BLVD
_EL. 252' - 0" LEVEL 3						ARLINGTON, VA 22201
BRICK PIERS EL. 241' - 0" LEVEL 2	110"					GREYSTAR
LEVEL 2 EL. 229' - 0" LEVEL 1	, 12' - 0" -1' - 6 3/4"					EXTERIOR ELEVATION -
227' - 5 9/32"						SOUTH
ASE	H DECORATIVE GRILLE					
	_					
						STEVE SMITH20200182Principal-in-ChargeProject No.NA/HL07/30/2021
						Project Manager MG
						Project Architect SG 21 A A A A A
						<ul> <li>Staff Architect</li> <li>1 - A4.01</li> </ul>

2025 CLARENDON BLVD
2025 CLARENDON BLVD ARLINGTON, VA 22201 ♦
GREYSTAR
EXTERIOR ELEVATION - SOUTH
STEVE SMITH20200182Principal-in-ChargeProject No.NA/HL07/30/2021Project ManagerDate
MG Project Architect SG
staff Architect <b>1 - A4.01</b>

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PROJECT NUMBER: 20200182 PROJECT NAME: 2025 CLARENDON BLVD SHEET NUMBER: 1 - A4.02 - EXTERIOR ELEVATION - EAST	P:\2020\20200182\D-7 Drawings\D-7-1 Revit\Users\20200182_2021_CH2_MAIN_sguenin.rvt 2/7/2022 11:33:04 AM	A

BUILDING ELEVATION - EAST SCALE: 1/16" = 1'-0" 1 - A4.02

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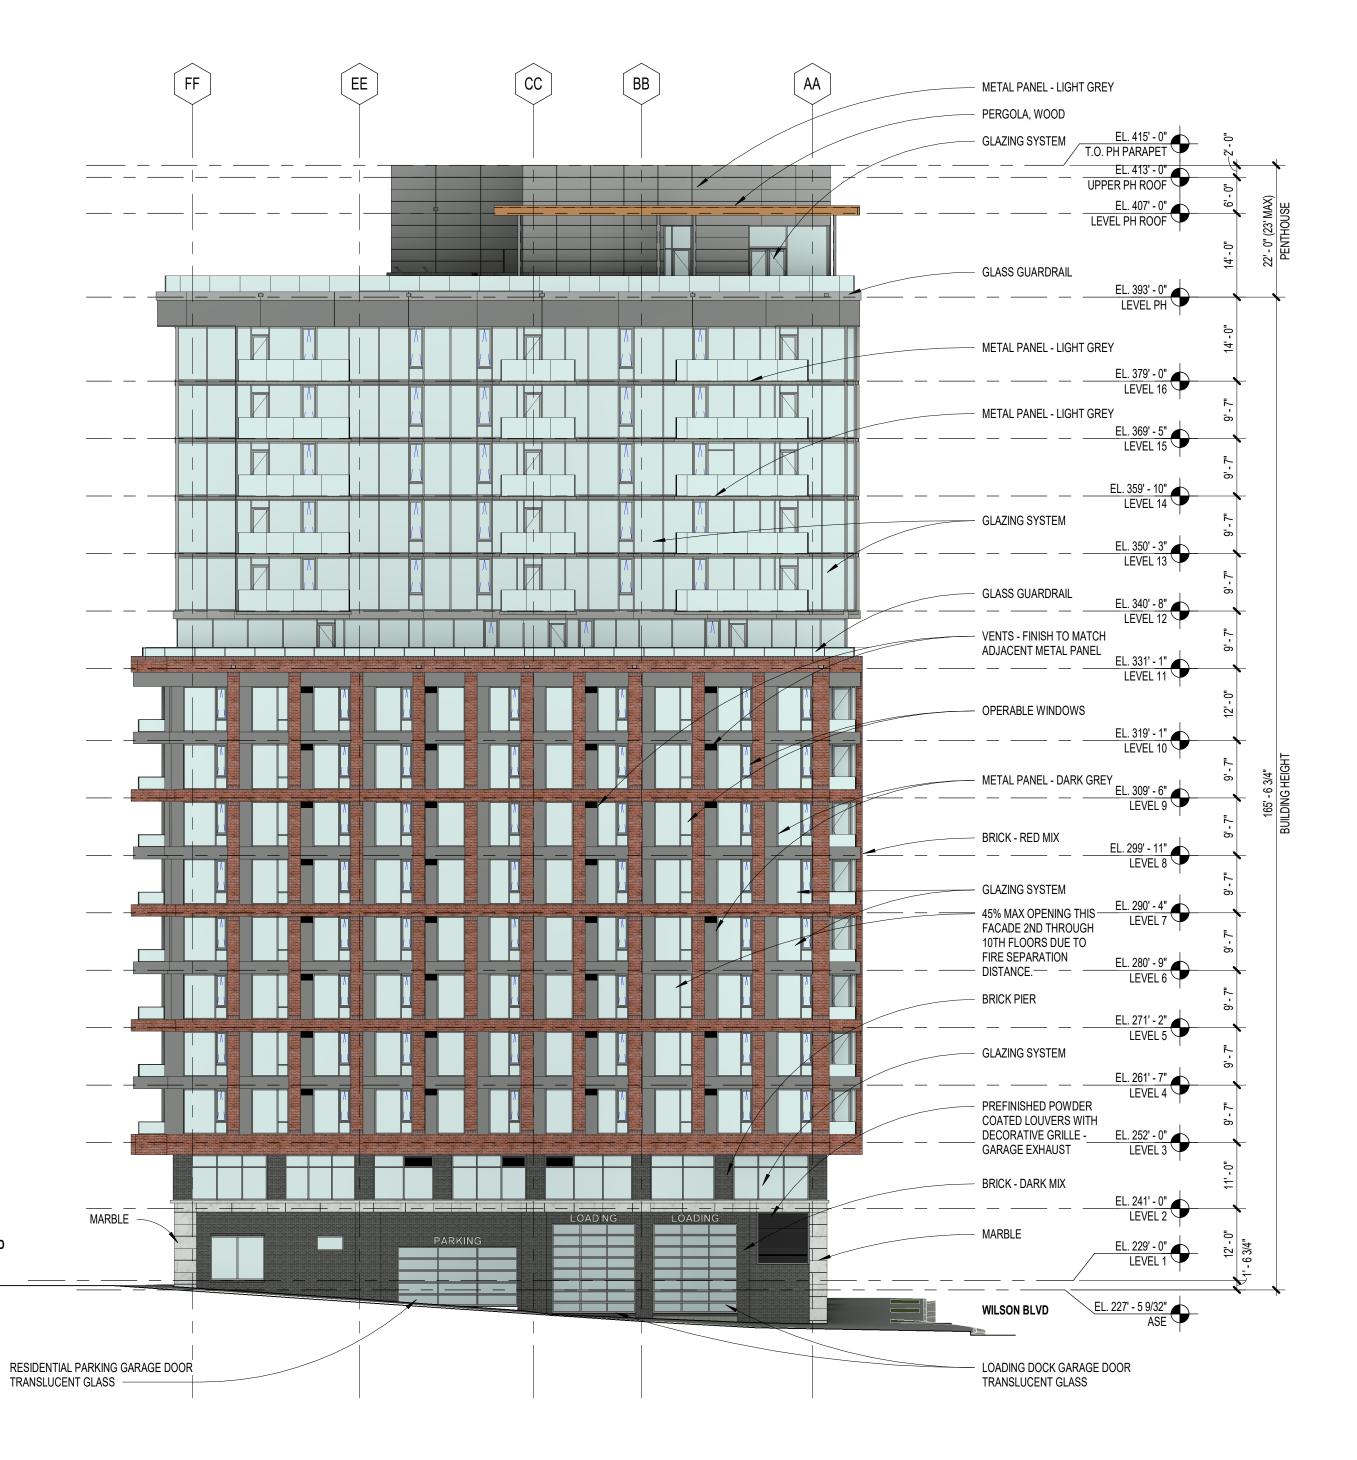
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CLARENDON BLVD

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15	COOPER CARRY THE CENTER FOR CONNECTIVE ARCHITECTURE
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- 8 -	STEVE SMITH       20200182         Principal-in-Charge       Project No.         NA/HL       Project Manager         Project Architect       Date         Staff Architect       1 - A44.022         Staff Architect       1 - A44.022



BLVD

2001

13		14		15	
VOID/SOLID CALCULATIONS - NORTH ELEVATION					
	AREA TOTAL	VOID AREA	% VOID	% REQ'D	
FRONTAGE FROM 2' TO 10' HIGH	1,737 SF	884 SF	51%	65%	



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#### SCOPE DOCUMENTS

The Contract Documents Issued for [Conceptual Design, Schematic Design, Design Development, Partial Construction Documents or Other Issuance up to Issued for Construction] are intended to be at that level of development and as such, may be neither complete nor coordinated. The [Construction Manager, Contractor, Design/Builder] is responsible for complete and coordinated pricing [and execution] of the Work, and shall include items necessary for the proper execution and completion of the

	ISSUANCES	
No.	Drawing Issue Descripti 4.1 SUBMISSION	on Date 04.16.20
	4.1 SUBMISSION 4.1 SUBMISSION	06.11.20
	2025 CLARENDC	ON BLVD
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STEV	2025 CLARENDON ARLINGTON, VA GREYSTAR EXTERIOR ELEV NORTH /E SMITH 20200 Project N	N BLVD 22201 X /ATION -
STEV Principz NA/H Project	2025 CLARENDON ARLINGTON, VA GREYSTAR EXTERIOR ELEV NORTH /E SMITH ↓ 20200 Project N	N BLVD 22201 X /ATION -
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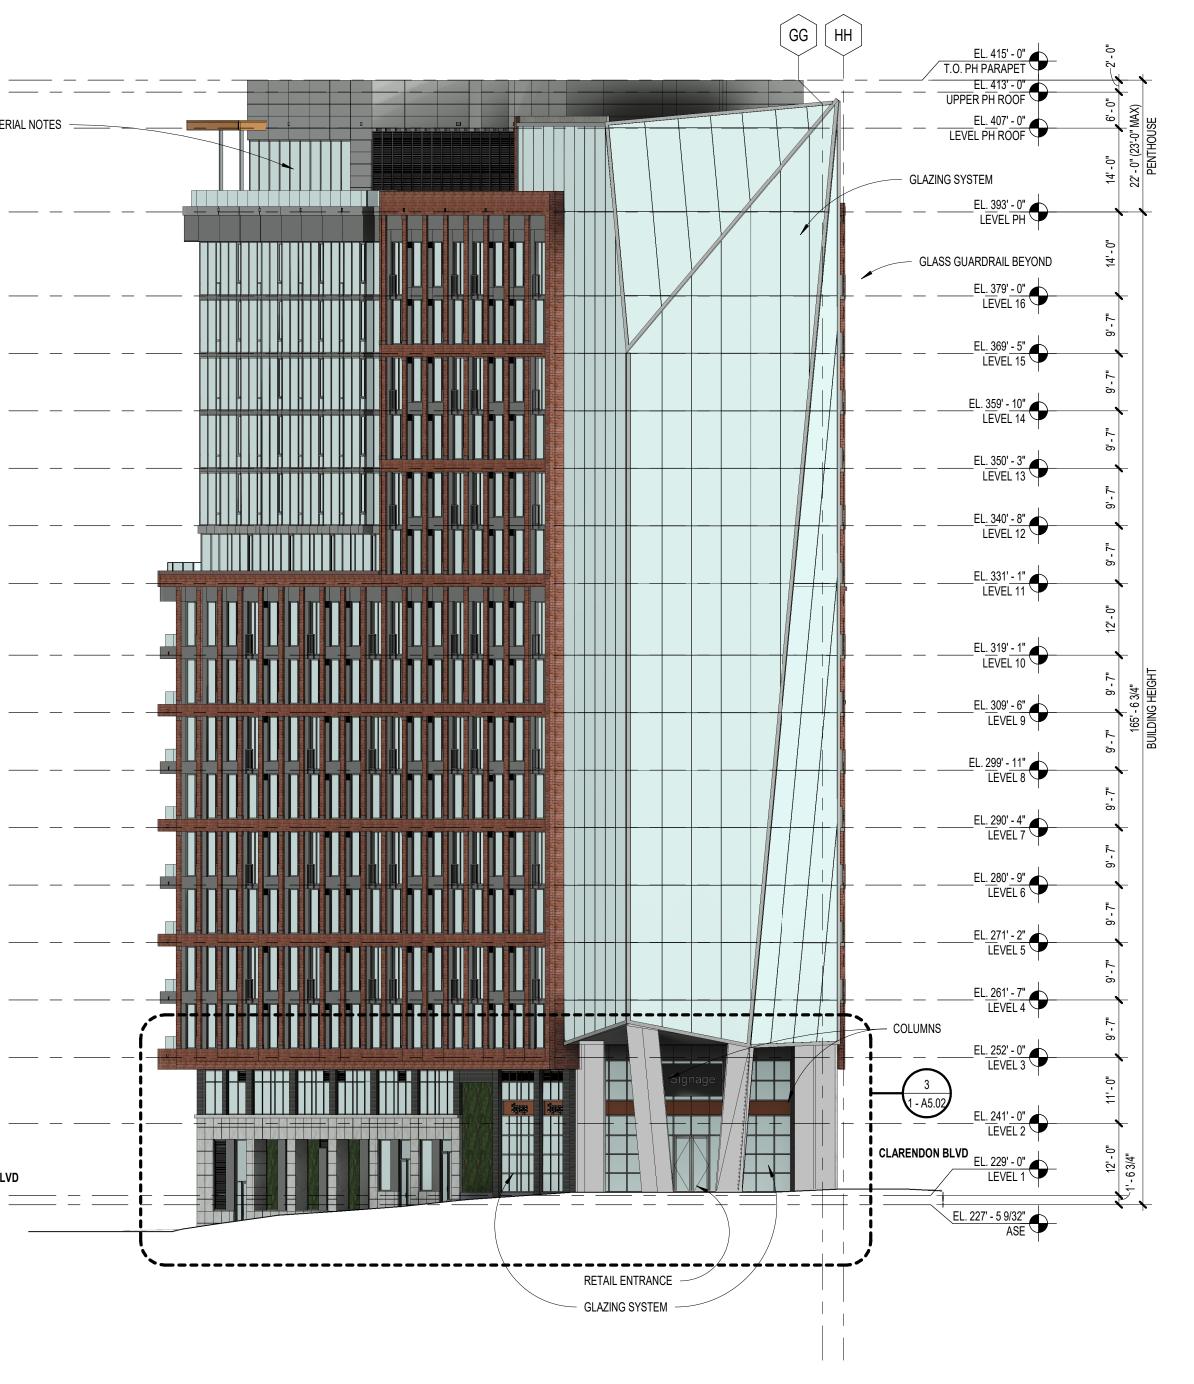
## \202001 BLVD PROJECT NUMBER: 20200182 PROJECT NAME: 2025 CLARENDON SHEET NUMBER: 1 - A4.04 - EXTERIOR ELEVATION - WEST P:\2020\20200182\D-7 Drawings\D-7-1 Revit\Users\20 2/7/2022 11:33:50 AM



WILSON BLVD \_\_\_\_\_

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REFER TO NORTH ELEVATION FOR MATERIAL NOTES



BUILDING ELEVATION - WEST

13		14		15		
VOID/SOLID CALCULATIONS - WEST ELEVATION						
	AREA TOTAL	VOID AREA	% VOID	% REQ'D		
FRONTAGE FROM 2' TO 10' HIGH	311 SF	250 SF	80%	65%		




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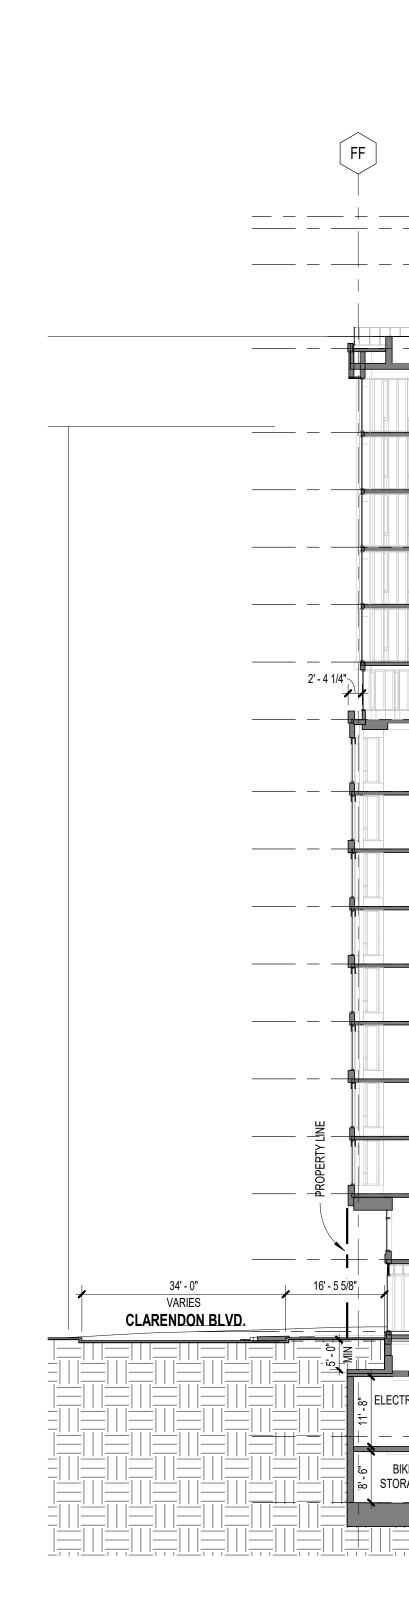
#### SCOPE DOCUMENTS

The Contract Documents Issued for [Conceptual Design, Schematic Design, Design Development, Partial Construction Documents or Other Issuance up to Issued for Construction] are intended to be at that level of development and as such, may be neither complete nor coordinated. The [Construction Manager, Contractor, Design/Builder] is responsible for complete and coordinated pricing [and execution] of the Work, and shall include items necessary for the proper execution and completion of the Work, as shown, specified, reasonably inferred or required for a complete Project. For Work of delegated designs; systems, assemblies, components and materials shall comply with national, state and local code requirements. The [Construction Manager, Contractor, Design/Builder] shall inform the Owner and Architect, in timely fashion, of any discovered omissions, inconsistencies or errors in the Contract Documents.

	ISS	UANCES	
No.		e Description	Date
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202	25 CLAR	ENDON	BLVD
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XTE	<b>KIOR EL</b>	EVATION	N - WES
STEVE SM		20200182	
Principal-in-Char	ge		
Project Manager		Date	
NG Project Architect		_	
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Staff Architect		_ 1 = /	44.04

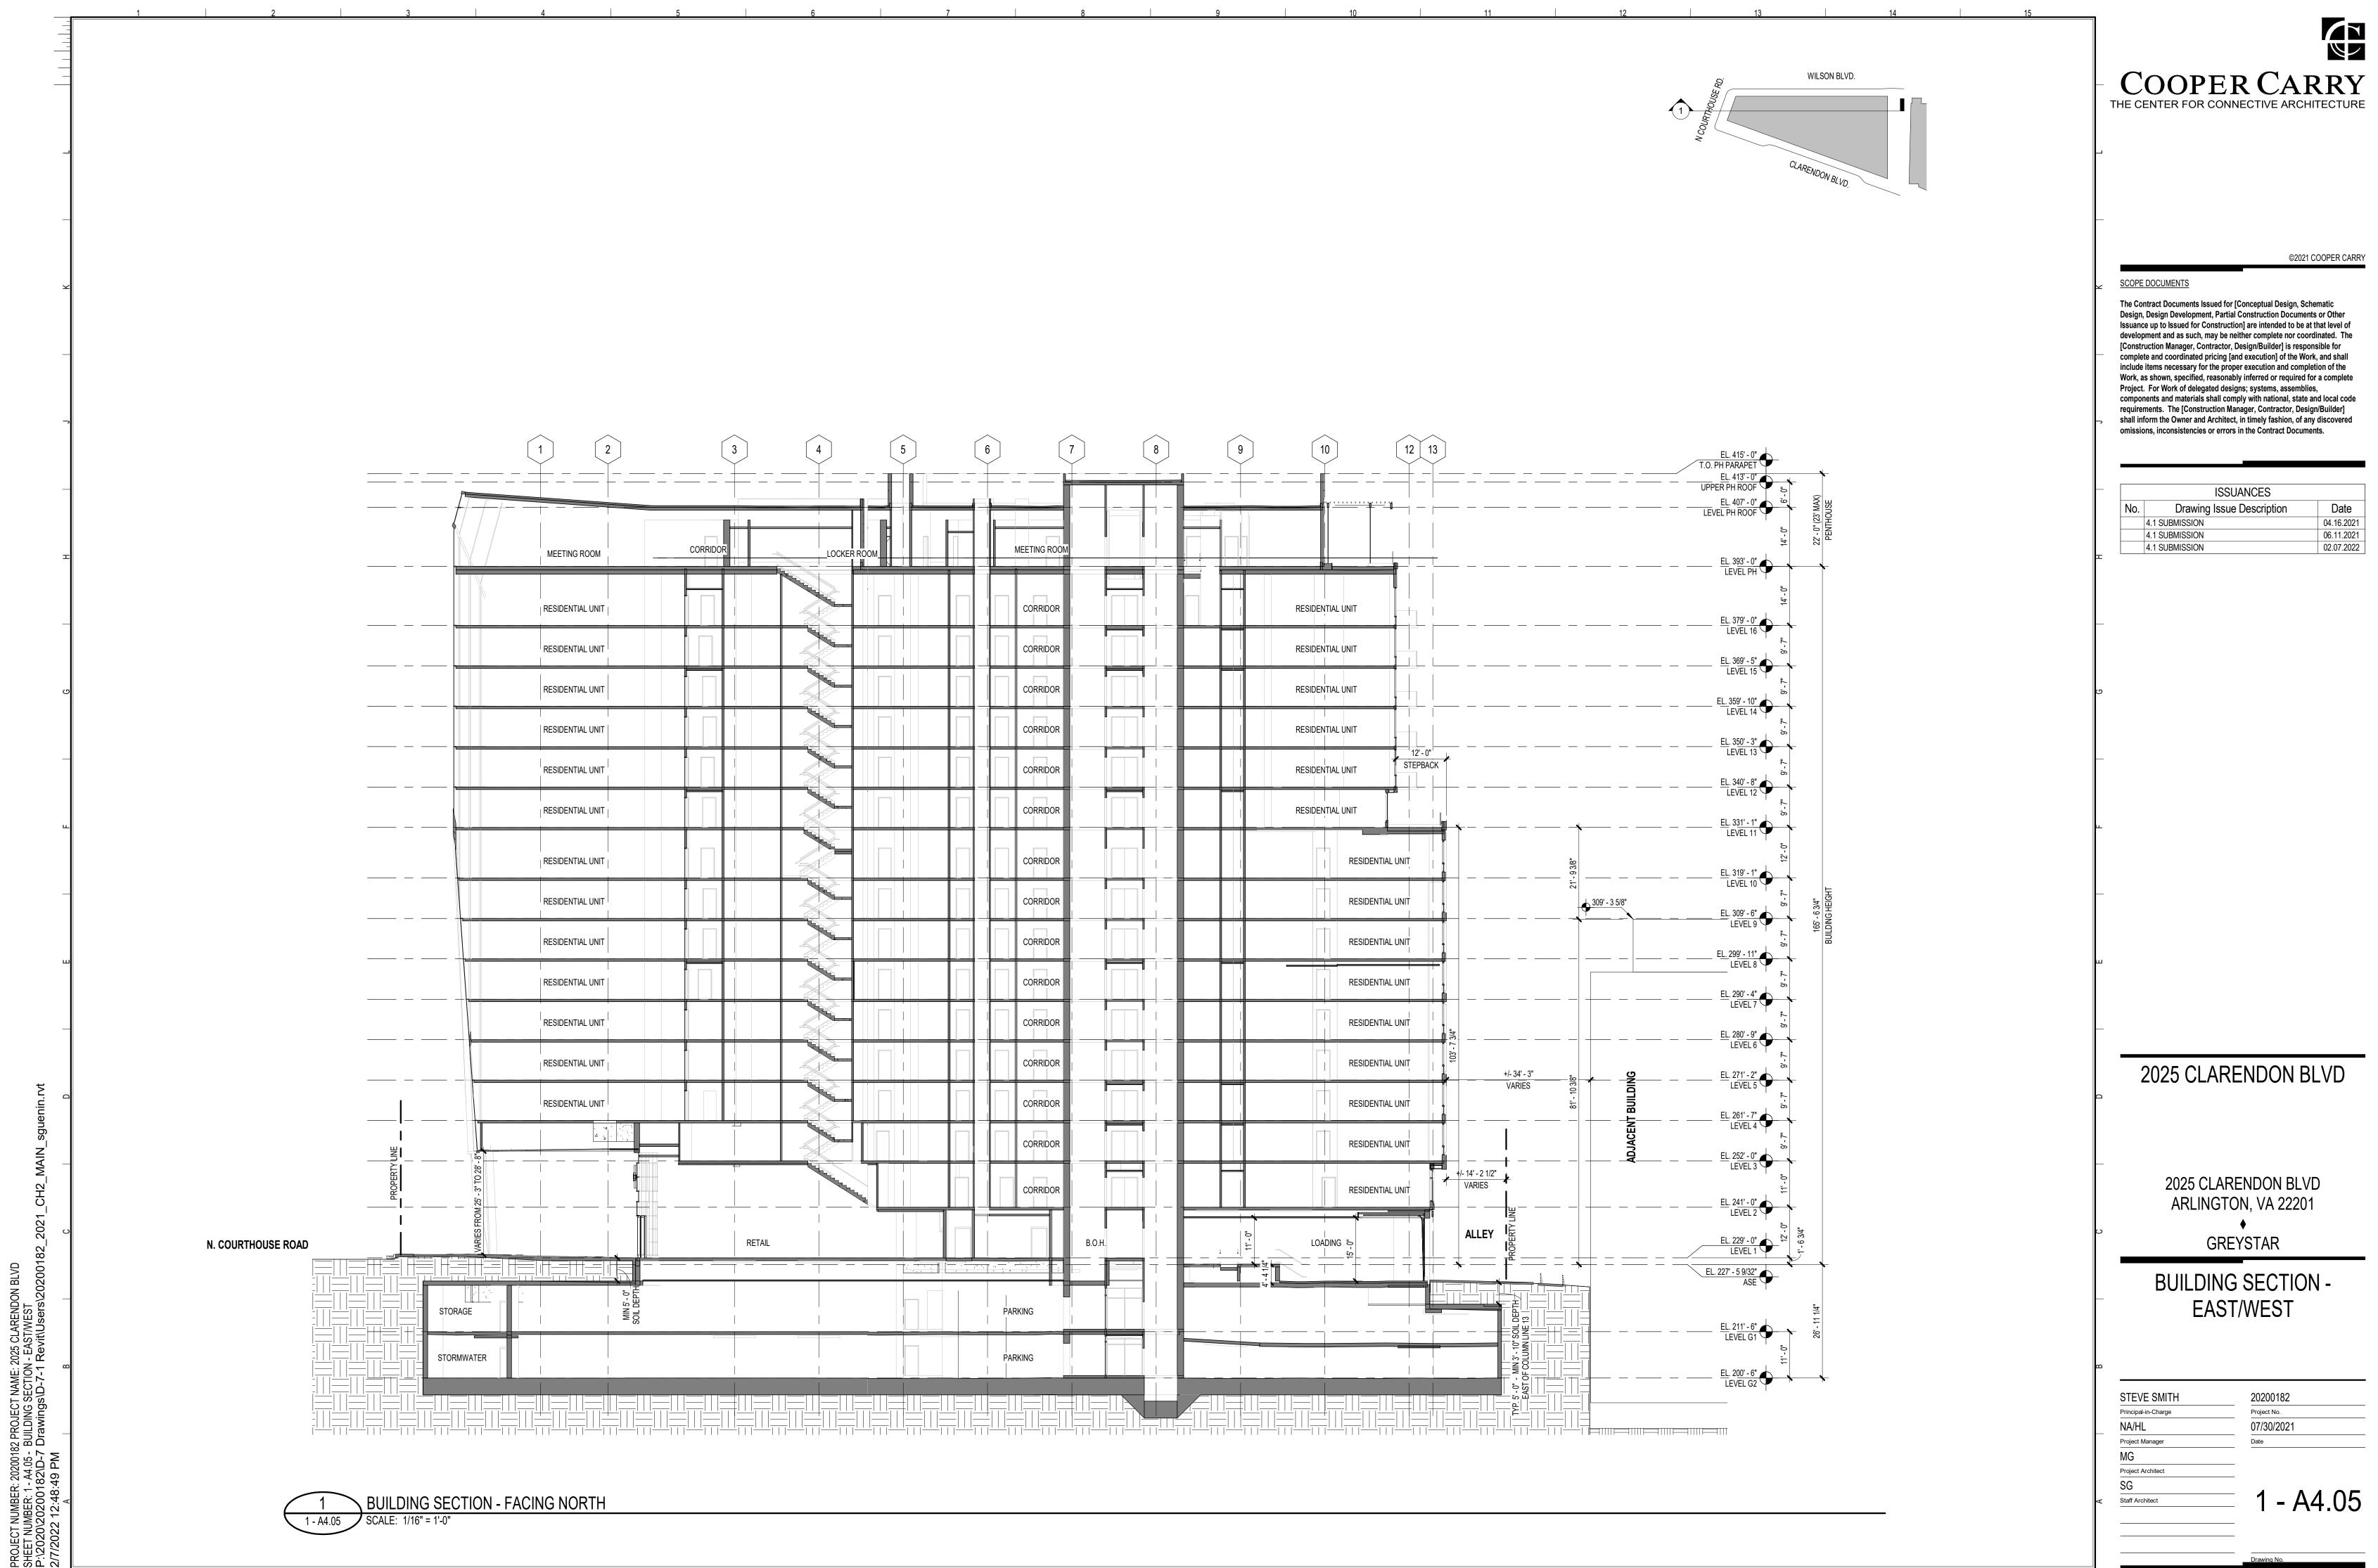


# N PROJECT NUMBER: 20200182 PROJECT NAME: 2025 CLARENDON BLVD SHEET NUMBER: 1 - A4.06 - BUILDING SECTION - NORTH/SOUTH P:\2020\20200182\D-7 Drawings\D-7-1 Revit\Users\20200182 2/7/2022 12:48:51 PM



BUILDING SECTION - FACING WEST SCALE: 1/16" = 1'-0" 1 - A4.06


EE		BB	A		
			 	EL. 413' - 0"	- Z' - 0"
				<u>EL. 407' - 0"</u> LEVEL PH ROOF	3' MAX)
				14' - 0"	22' - 0" (23' MAX)
				<u>EL. 393' - 0"</u> LEVEL PH	
	RESIDENTIAL UNIT	RESIDENTIAL UNIT		4	
RESIDENTIAL UNIT	RESIDENTIAL UNIT	RESIDENTIAL UNIT		<u>EL. 379' - 0"</u> LEVEL 16	-
RESIDENTIAL UNIT	RESIDENTIAL UNIT	I RESIDENTIAL UNIT		<u>EL. 369' - 5"</u> LEVEL 15	-
				<u>EL. 359' - 10"</u> LEVEL 14	-
		RESIDENTIAL UNIT		<u>EL. 350' - 3"</u>	-
			 	<u>EL. 340' - 8"</u>	-
RESIDENTIAL UNIT	RESIDENTIAL UNIT	RESIDENTIAL UNIT		<u>EL. 331' - 1"</u>	_
RESIDENTIAL UNIT	RESIDENTIAL UNIT RESIDENTIAL	UNIT RESIDENTIAL UNIT		12 - 0"	
RESIDENTIAL UNIT	RESIDENTIAL UNIT RESIDENTIAL	UNIT RESIDENTIAL UNIT		<u>EL</u> . <u>319' - 1"</u> LEVEL 10	- =.
				<u>EL. 309' - 6"</u>	165' - 6 3/4"
		UNIT RESIDENTIAL UNIT		<u>EL. 299' - 11"</u>	-
RESIDENTIAL UNIT	RESIDENTIAL UNIT RESIDENTIAL	UNIT RESIDENTIAL UNIT	 	<u>EL. 290' - 4"</u>	_
RESIDENTIAL UNIT	RESIDENTIAL UNIT RESIDENTIAL	UNIT RESIDENTIAL UNIT		EL. 280' - 9"	_
RESIDENTIAL UNIT	RESIDENTIAL UNIT RESIDENTIAL	UNIT RESIDENTIAL UNIT		6	
RESIDENTIAL UNIT	RESIDENTIAL UNIT RESIDENTIAL	UNIT RESIDENTIAL UNIT		<u>EL. 271' - 2"</u> LEVEL 5	-
	RESIDENTIAL UNIT RESIDENTIAL	UNIT		<u>EL</u> . 261' - 7" LEVEL 4	-
			9'-23/4"	<u>EL. 252' - 0"</u>	-
	RESIDENTIAL UNIT RESIDENTIAL	UNIT RESIDENTIAL UNIT		<u>EL</u> . 241' - 0" 	-
LÖBBY	RAMP		MIN. 16' - 0" +/- 44' - 0" VARIES VARIES		-1'-63/4"
				EL. 227' - 5 9/32" ASE	
	RAMP PARKI	NG RAMP		EL. 211' - 6"	11 1/4"
BIKE STORAGE PARKING				- <u>EL. 211' - 6"</u> LEVEL G1	26'
			PARKING       Harmonic       Harmonic	<u>EL</u> . 200' - 6" LEVEL G2	
			+-		


	13	14	15		
N COURTHOUSE RD.	WILSON BLVD.				COOPER CARRY THE CENTER FOR CONNECTIVE ARCHITECTURE
				Y	SCOPE DOCUMENTS The Contract Documents Issued for [Conceptual Design, Schematic Design, Design Development, Partial Construction Documents or Other Issuance up to Issued for Construction] are intended to be at that level of development and as such, may be neither complete nor coordinated. The [Construction Manager, Contractor, Design/Builder] is responsible for complete and coordinated pricing [and execution] of the Work, and shall include items necessary for the proper execution and completion of the Work, as shown, specified, reasonably inferred or required for a complete Project. For Work of delegated designs; systems, assemblies, components and materials shall comply with national, state and local code requirements. The [Construction Manager, Contractor, Design/Builder] shall inform the Owner and Architect, in timely fashion, of any discovered omissions, inconsistencies or errors in the Contract Documents.
				н Н	ISSUANCESNo.Drawing Issue Description4.1 SUBMISSION4.1 SUBMISSION02.07.2022
					2025 CLARENDON BLVD
				_ _	2025 CLARENDON BLVD ARLINGTON, VA 22201 GREYSTAR BUILDING SECTION - NORTH/SOUTH
_				B 	STEVE SMITH   Principal-in-Charge   NA/HL   Project Manager   MG   Project Architect   SG   Staff Architect   Staff Architect     Drawing No.

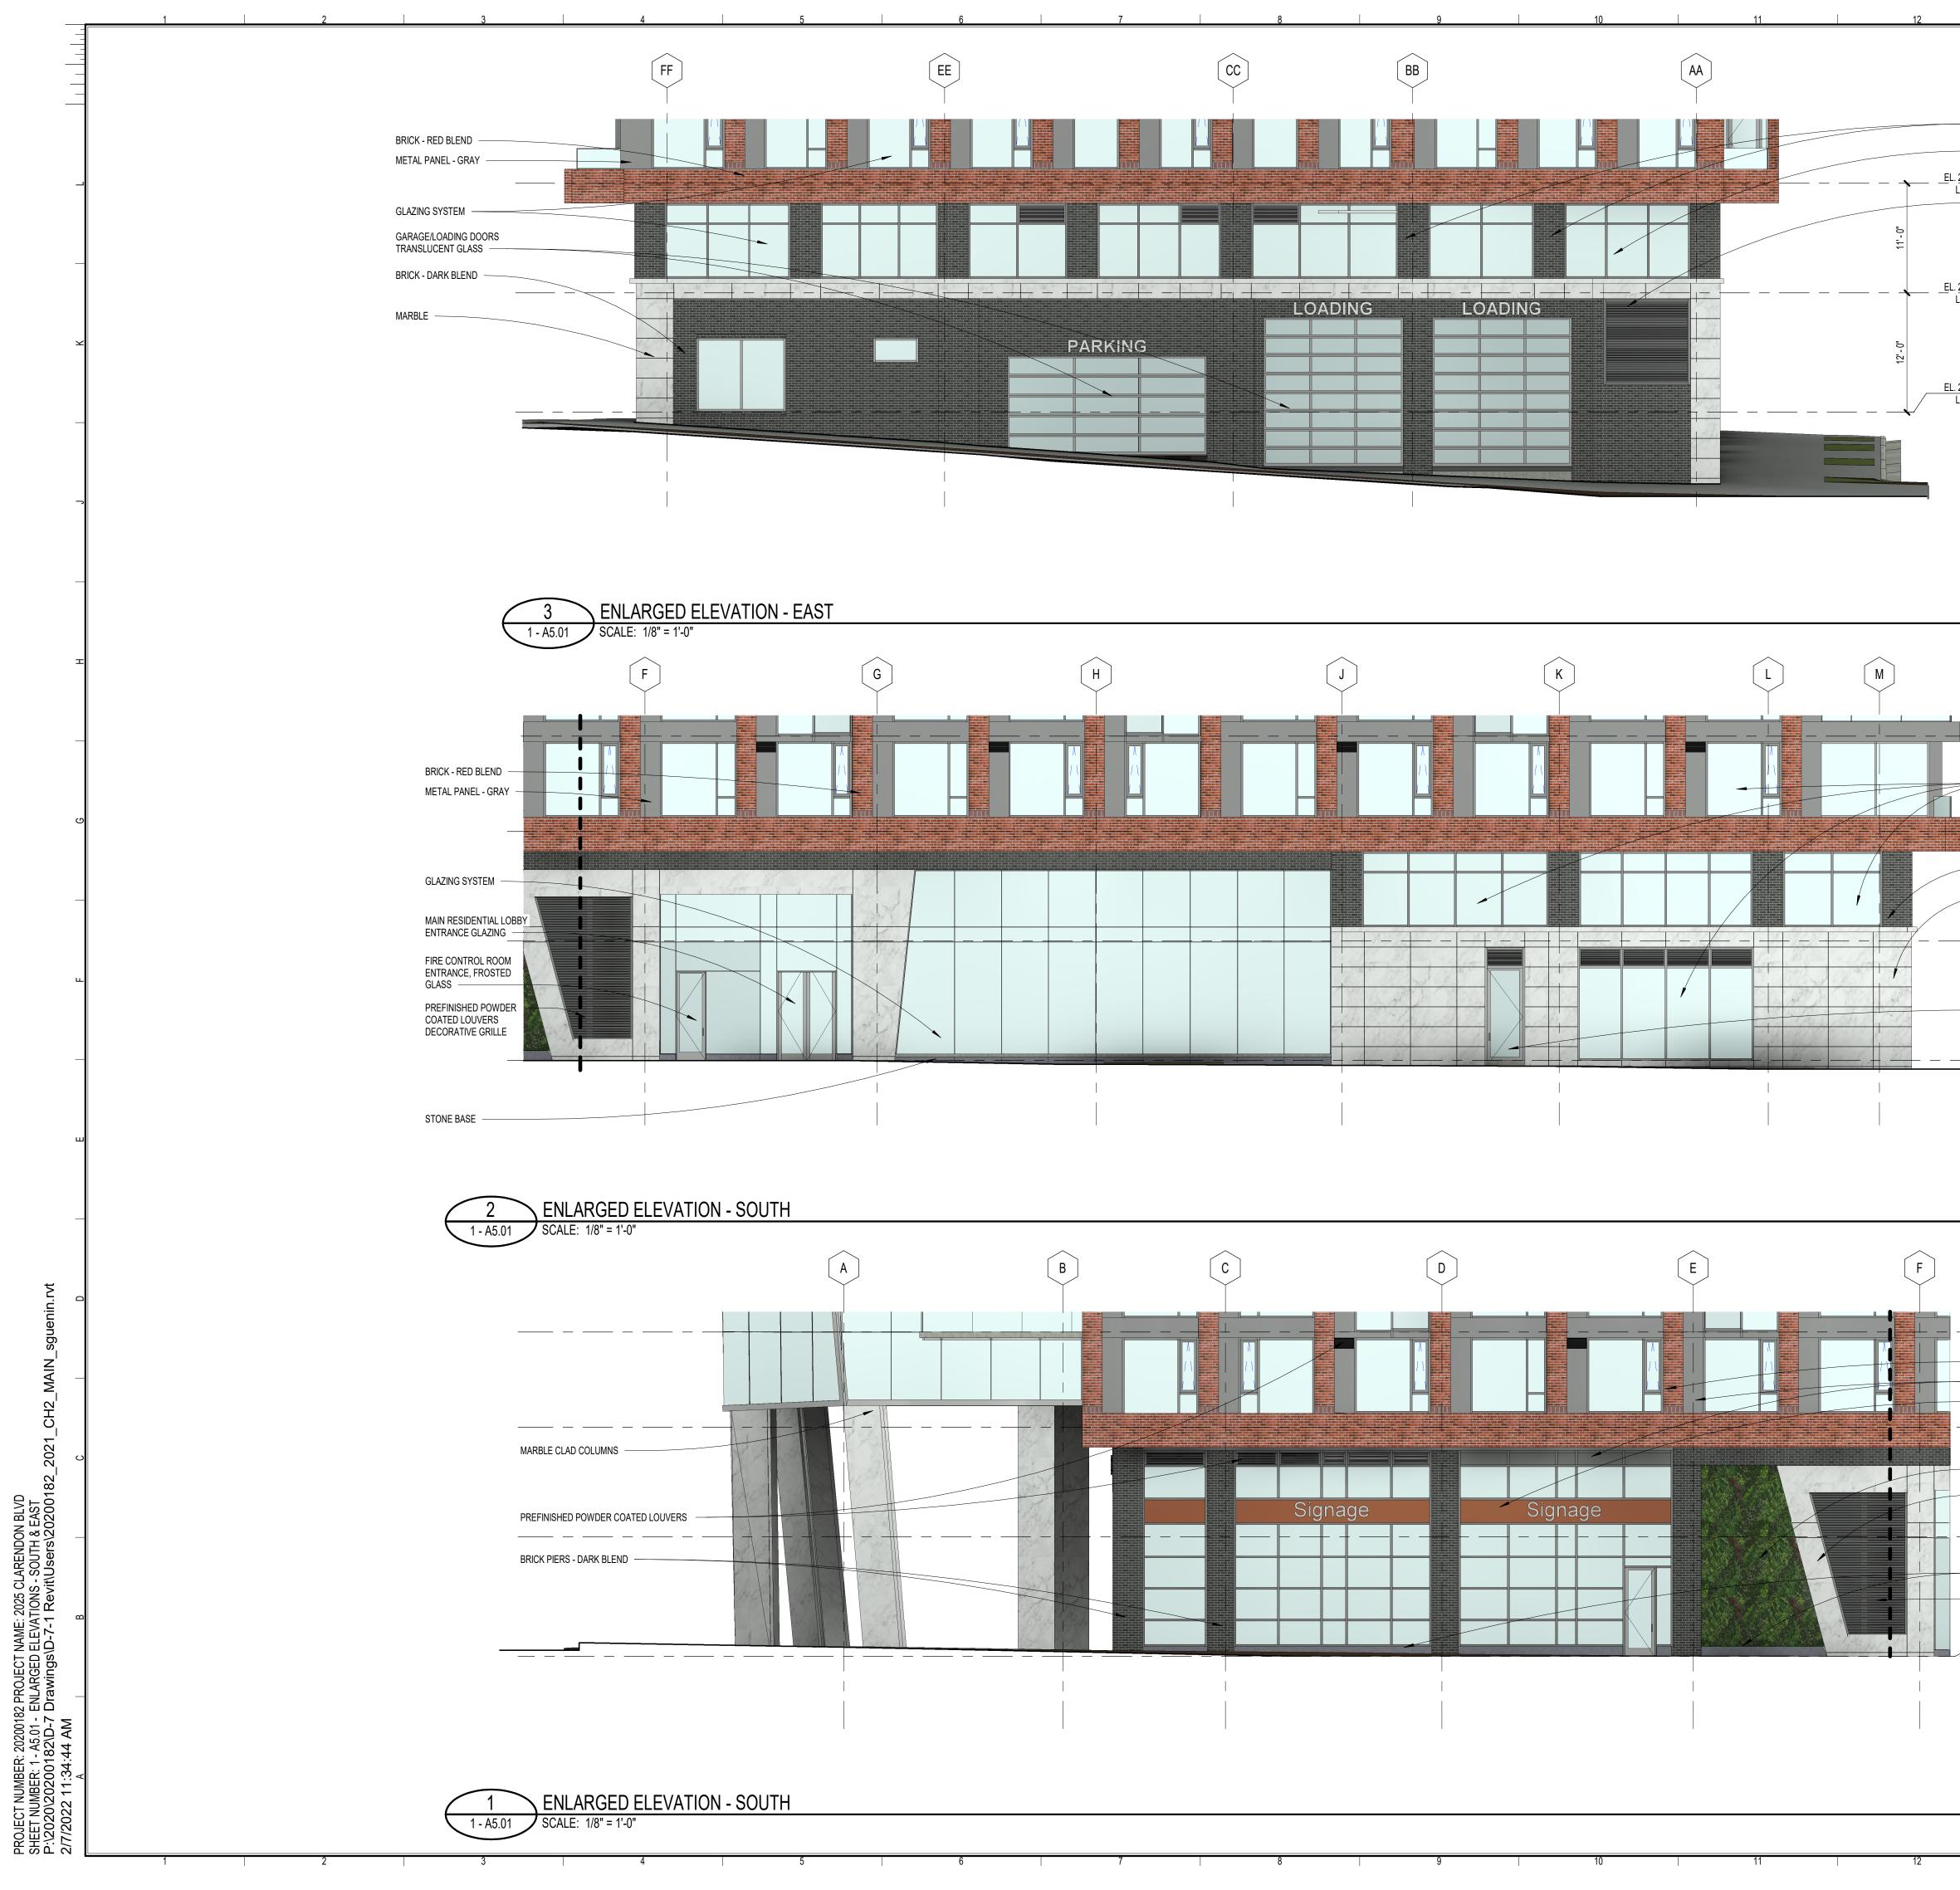


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			COOPER CARRY THE CENTER FOR CONNECTIVE ARCHITECTURE
252' - 0" LEVEL 3 PREFINISHED POWDER COATED LOUVERS WITH DECORATIVE GRILLE GARAGE EXHAUST			
<u>241' - 0"</u> LEVEL 2			©2021 COOPER CARRY
<u> 229' - 0"</u>			The Contract Documents Issued for [Conceptual Design, Schematic Design, Design Development, Partial Construction Documents or Other Issuance up to Issued for Construction] are intended to be at that level of development and as such, may be neither complete nor coordinated. The [Construction Manager, Contractor, Design/Builder] is responsible for complete and coordinated pricing [and execution] of the Work, and shall include items necessary for the proper execution and completion of the Work, as shown, specified, reasonably inferred or required for a complete Project. For Work of delegated designs; systems, assemblies, components and materials shall comply with national, state and local code requirements. The [Construction Manager, Contractor, Design/Builder] shall inform the Owner and Architect, in timely fashion, of any discovered omissions, inconsistencies or errors in the Contract Documents.
			ISSUANCES         No.       Drawing Issue Description       Date         4.1 SUBMISSION       04.16.2021         4.1 SUBMISSION       06.11.2021         4.1 SUBMISSION       02.07.2022
EL. <u>261' - 7"</u> LEVEL 4 GLAZING SYSTEM			
EL. 252' - 0" LEVEL 3 BRICK PIERS - DARK BLEND			ບ
EL. 241' - 0" LEVEL 2			— 
STAIR EXIT DOOR -			
			ш
			2025 CLARENDON BLVD
EL. 261' - 7" LEVEL 4 BRICK - RED BLEND METAL PANEL - GRAY	▼		2025 CLARENDON BLVD
LEVEL 3 LEVEL 3 — LIVING WALL	<b>~</b>		ARLINGTON, VA 22201
EL. 241' - 0" LEVEL 2 STONE BASE PREFINISHED POWDER COATED LOUVERS WITH DECORATIVE GRILLE - GARAGE EXHAUST	€-		SOUTH & EAST
EL. 229' - 0" LEVEL 1	~		STEVE SMITH     20200182       Principal-in-Charge     Project No.       NA/HL     07/30/2021       Project Manager     Date
			<ul> <li>Project Architect</li> <li>SG</li> <li>Staff Architect</li> <li>1 - A5.01</li> </ul>



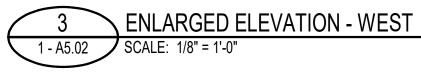

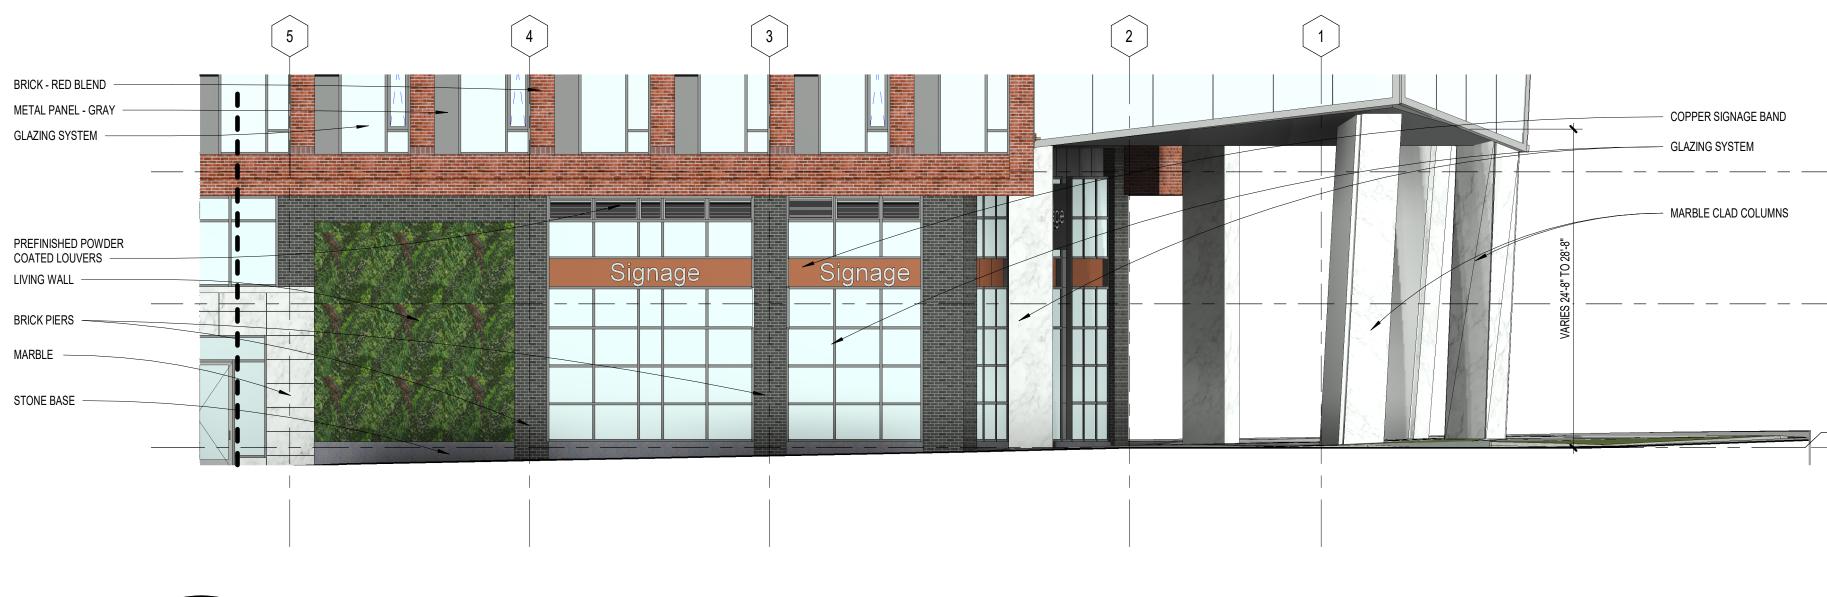

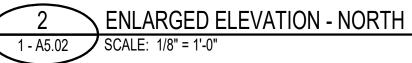



1 - A5.02 ENLARGED ELEVATION - NORTH SCALE: 1/8" = 1'-0"

PROJECT NUMBER: 20200182 PROJECT NAME: 2025 CLARENDON BLVD SHEET NUMBER: 1 - A5.02 - ENLARGED ELEVATIONS - NORTH & WEST P:\2020\20200182\D-7 Drawings\D-7-1 Revit\Users\20200182\_2021\_CH2\_MAIN\_sguenin.rvt 2/7/2022 11:35:30 AM

13 14 15	
	COOPER CARRY THE CENTER FOR CONNECTIVE ARCHITECTURE
EL. 252' - 0" LEVEL 3	
EL. 241'-0" LEVEL 2	©2021 COOPER CARRY
EL. 229'-0"	The Contract Documents Issued for [Conceptual Design, Schematic Design, Design Development, Partial Construction Documents or Other Issuance up to Issued for Construction] are intended to be at that level of development and as such, may be neither complete nor coordinated. The [Construction Manager, Contractor, Design/Builder] is responsible for complete and coordinated pricing [and execution] of the Work, and shall include items necessary for the proper execution and completion of the Work, as shown, specified, reasonably inferred or required for a complete Project. For Work of delegated designs; systems, assemblies, components and materials shall comply with national, state and local code requirements. The [Construction Manager, Contractor, Design/Builder] shall inform the Owner and Architect, in timely fashion, of any discovered ominational informs the Construction manager.
	omissions, inconsistencies or errors in the Contract Documents.
	No.         Drawing Issue Description         Date           4.1 SUBMISSION         04.16.2021           4.1 SUBMISSION         06.11.2021           4.1 SUBMISSION         02.07.2022
EL. 252' - 0"	
	o
EL. 241' - 0" LEVEL 2	
EL. 229' - 0" LEVEL 1	ц.
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	_
AZING SYSTEM ICK - RED BLEND	2025 CLARENDON BLVD
	2025 CLARENDON BLVD
-0" EL 2	ARLINGTON, VA 22201
-0" EL 1	ENLARGED ELEVATIONS - NORTH & WEST
	DS STEVE SMITH Principal-in-Charge Project No.
	NA/HL Project Manager MG Project Architect SG A A C A O
	<ul> <li>Staff Architect</li> <li>1 - A5.02</li> </ul>