4.1 SUBMISSION

2025 CLARENDON BOULEVARD

MIXED USE DEVELOPMENT

ARLINGTON, VA

DATE: 02.07.2022

SHEET INDEX

Sheet List Table						
Sheet Number	Sheet Title					
L000	COVER SHEET					
L001	GENERAL NOTES					
L002	GENERAL NOTES					
L101	MATERIAL PLANS					
L201	OPEN SPACE PLANS					
L401	HARDSCAPE DETAILS					
L402	HARDSCAPE DETAILS					
L403	HARDSCAPE DETAILS					
L501	PLANTING PLANS					
L502	PLANTING NOTES					
L503	PLANTING DETAILS					
L504	PLANTING DETAILS					

VICINITY MAP



PROJECT TEAM

OWNER/DEVELOPER

GREYSTAR 8405 GREENSBORO DR. SUITE 500 MCLEAN, VA, 22102 703.594.8022

LANDSCAPE ARCHITECT


LANDDESIGN 200 S. PEYTON STREET ALEXANDRIA, VA 22314 703.549.7784 CONTACT NAME: JESSE VAN WICK

ARCHITECT

COOPER CARRY 625 NORTH WASHINGTON ST, SUITE 200 ALEXANDRIA, VA, 22314 703.519.6152

CIVIL ENGINEER

BOWMAN CONSULTING 12355 SUNRISE VALLEY DR. SUITE 520 RESTON, VA, 20191 703.464.1000

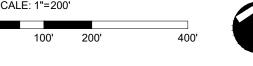

Landscape Plan Notes and Details

THESE DOCUMENTS ARE REFERENCED FROM "ARLINGTON COUNTY LANDSCAPE STANDARDS, DECEMBER 2017 EDITION"

LANDSCAPE AND PLANTING NOTES

- MATERIAL SHALL BE FURNISHED AND INSTALLED AS INDICATED ON PLANS, INCLUDING ALL LABOR, MATERIALS, PLANTS, EQUIPMENT, INCIDENTALS, AND CLEAN-UP.
- GRADING AND PLANTING OPERATIONS SHALL BE PERFORMED DURING PERIODS WHEN WEATHER AND SOIL CONDITIONS ARE SUITABLE, AND IN ACCORDANCE WITH ACCEPTED LOCAL PRACTICE AND STANDARDS. THE ACCEPTABLE PLANTING RANGE IS FROM MARCH-JUNE 15 AND SEPTEMBER-DECEMBER, FOR NON-TREE MATERIAL, AND OCTOBER – JUNE 15 FOR TREES. PLANTS SHALL NOT BE INSTALLED IN TOPSOIL THAT IS MUDDY OR FROZEN. CARE SHALL BE TAKEN TO PROVIDE PLANTS WITH ENOUGH WATER TO COMBAT HEAT STRESS DURING HOT/DRY WEATHER.
- ALL LAWN AND PLANTING AREAS SHALL BE GRADED TO A SMOOTH, EVEN, AND UNIFORM PLANE WITH NO ABRUPT CHANGE OF SURFACE UNLESS OTHERWISE DIRECTED BY THE LANDSCAPE ARCHITECT OR REPRESENTATIVE. SOIL AREAS ADJACENT TO BUILDINGS SHALL SLOPE AWAY FROM BUILDING. ALL PLANTING AREAS SHALL BE GRADED AND MAINTAINED TO ALLOW FREE FLOW OF SURFACE WATER, CONTRACTOR SHALL REPORT ANY SOIL OR DRAINAGE CONDITIONS CONSIDERED DETRIMENTAL TO GROWTH OF PLANT MATERIAL.
- 4. THE CONTRACTOR SHALL BE RESPONSIBLE FOR PLANTING AT CORRECT GRADES AND ALIGNMENT PER APPROVED. PLANS. NO TREES SHALL BE PLANTED LESS THAN TWO FEET FROM EXISTING STRUCTURES AND SIDEWALKS. LAYOUT OF PLANTS SHALL BE APPROVED BY LANDSCAPE ARCHITECT OR REPRESENTATIVE PRIOR TO INSTALLATION.
- 5. PLANTS SHALL BE TYPICAL OF THEIR SPECIES AND VARIETY, HAVE NORMAL GROWTH HABITS, WELL-DEVELOPED DENSELY FOLIATED BRANCHES, VIGOROUS ROOT SYSTEMS, AND BE FREE FROM DEFECTS AND INJURIES. QUALITY AND SIZE OF PLANTS, SPREAD OF ROOTS AND SIZE OF ROOTBALL SHALL BE IN ACCORDANCE WITH THE MOST RECENT VERSION OF ANSI "AMERICAN STANDARD FOR NURSERY STOCK" PUBLISHED BY THE AMERICAN ASSOCIATION OF NURSERYMEN, INC.
- ALL PLANT MATERIAL SHALL BE GUARANTEED BY THE INSTALLER TO BE IN VIGOROUS GROWING CONDITION. PROVISION SHALL BE MADE FOR A GROWTH GUARANTEE OF AT LEAST ONE YEAR FROM THE DATE OF ACCEPTANCE FOR ALL PLANT MATERIAL. REPLACEMENTS SHALL BE MADE AT THE BEGINNING OF THE FIRST SUCCEEDING PLANTING SEASON, ALL REPLACEMENTS SHALL HAVE A GUARANTEE EQUAL TO THAT STATED ABOVE.
- PLANT MATERIAL SHALL BE PLANTED ON THE DAY OF DELIVERY IF PRACTICAL. IF THIS IS NOT POSSIBLE, THE CONTRACTOR SHALL PROTECT STOCK NOT PLANTED, PLANTS SHALL NOT REMAIN UNPLANTED FOR LONGER THAN A THREE-DAY PERIOD AFTER DELIVERY. ANY PLANTS NOT INSTALLED DURING THIS PERIOD SHALL BE REJECTED, UNLESS OTHERWISE DIRECTED BY THE ARLINGTON COUNTY LANDSCAPE ARCHITECT OR REPRESENTATIVE.
- ALL INJURED ROOTS SHALL BE PRUNED USING ANSI A300 STANDARDS.
- CONTRACTOR SHALL PROVIDE 4 IN. MINIMUM THICK TOPSOIL LAYER IN ALL PLANTING AREAS, TOPSOIL SHALL BE FREE OF WEEDS, DEBRIS, ROCKS LARGER THAN 2 IN., WOOD, ROOTS, VEGETABLE MATTER, AND CLAY CLODS. CLEAN, FERTILE TOPSOIL PRESENT AT THE SITE, IF ANY, MAY BE USED TO SUPPLEMENT TOTAL AMOUNT REQUIRED.

ARLINGTON COUNTY LANDSCAPE STANDARDS REFERENCE GUIDE | PG. 35

Landscape Plan Notes and Details

County Standards Details

Certain Arlington County standard details must be shown on landscape and tree preservation plans, depending on the project. The standard details can be found on the webpages below:


Department of Parks and Recreation Design Standards

Department of Environmental Services Infrastructure Design Standards

Department of Environmental Servies Bicycle Parking Standards

What details are required will depend on the elements of each specific project, but typically, the most relevant details for tree preservation and landscape plans include:

- Tree Protection and Trimming Details
- Exterior Plants
- Horizontal Standards sidewalks, curb ramps, crosswalks, street lights
- Bicycle Parking

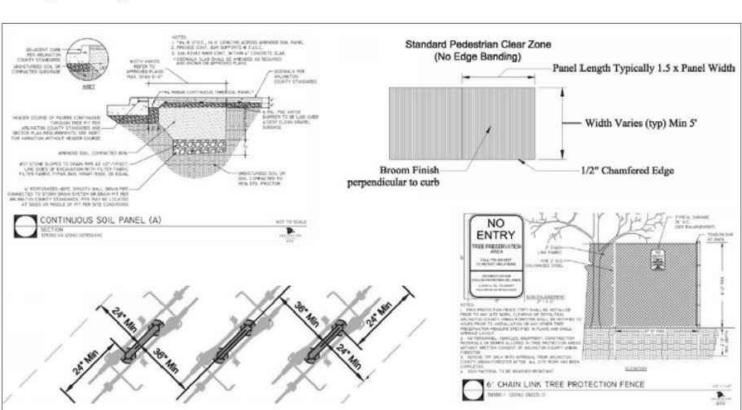

Examples of Arlington County Standard Details. See links above for actual details.

10. PLANTING PITS SHALL BE DUG PER COUNTY DETAILS, SET PLANTS PLUMB AND STRAIGHT, WITH ROOT FLARES SLIGHTLY ABOVE GRADE. DO NOT COVER THE ROOT FLARE WITH SOIL OR MULCH. BACKFILL PLANTING PITS WITH AMENDED TOPSOIL, AND THOROUGHLY WATER AND TAMP AS BACK-FILLING PROGRESSES. WATER AGAIN TO ACHIEVE SOIL SATURATION IMMEDIATELY FOLLOWING PLANTING.

Landscape Plan Notes and Details

- 11. PLANTS SHALL NOT BE BOUND WITH WIRE OR ROPE AT ANY TIME, SO AS NOT TO DAMAGE THE BARK OR BREAK BRANCHES. PLANTS SHALL BE HANDLED FROM THE BOTTOM OF THE ROOT BALL ONLY.
- 12. EACH TREE AND SHRUB SHALL BE PRUNED IN ACCORDANCE WITH ANSI A300: STANDARDS FOR TREE CARE PRACTICES, TO PRESERVE THE HEALTH AND APPEARANCE OF THE PLANT. PRUNING SHALL BE DONE WITH CLEAN, SHARP TOOLS.
- 13. TREES SHALL BE SUPPORTED AFTER PLANTING ONLY AS DIRECTED BY THE URBAN FORESTER. IF INSTALLED, THE LANDSCAPE CONTRACTOR SHALL REMOVE STAKING, GUYING AND TREE WRAP AT THE END OF THE ONE-YEAR MAINTENANCE AND WARRANTY PERIOD.
- 14. ALL PLANTING BEDS SHALL BE MULCHED WITH A 3 IN. LAYER OF WEED-FREE DOUBLE SHREDDED HARDWOOD BARK MULCH, OR OTHER EQUIVALENT AS APPROVED BY THE LANDSCAPE ARCHITECT OR REPRESENTATIVE. KEEP MULCH AWAY FROM TRUNKS OF TREES AND OTHER PLANT MATERIALS.
- NEW PLANTINGS AND TURF SHALL BE ADEQUATELY IRRIGATED OR WATERED THROUGHOUT ESTABLISHMENT.
- UPON COMPLETION OF ALL PLANTING AND BEFORE FINAL ACCEPTANCE, THE CONTRACTOR SHALL REMOVE ALL MATERIAL, EQUIPMENT AND DEBRIS. ALL PAVED AREAS SHALL BE BROOM-SWEPT AND LEFT IN A NEAT CONDITION.
- 17. URBAN FORESTER NOTIFICATION: THE DEVELOPER AGREES TO NOTIFY THE URBAN FORESTER AT LEAST 72 HOURS IN ADVANCE OF THE INSTALLATION OF DRAINAGE, SPECIAL SOIL EXPANSION EQUIPMENT, TREE PIT CREATION, AND SCHEDULED PLANTING OF ANY TREES IN THE PUBLIC RIGHT OF WAY, AND TO BE AVAILABLE AT THE TIME OF PLANTING TO MEET WITH DPR STAFF TO INSPECT THE PLANT MATERIAL, TREE PIT AND PLANTING TECHNIQUES. SOIL USED IN THE TREE PIT MUST MEET THE SPECIFICATIONS FOR STREET TREE PLANTING IN THE "STANDARDS FOR PLANTING AND PRESERVATION OF TREES ON SITE PLAN PROJECTS" AVAILABLE FROM THE URBAN FORESTER.

ARLINGTON COUNTY LANDSCAPE STANDARDS REFERENCE GUIDE | PG. 36

LANDSCAPE MAINTENANCE MANAGEMENT PROGRAM

A. ALL PLANTING AREAS, INCLUDING LAWNS, BUFFERS, AND PARKING LOTS, SHALL BE PERIODICALLY INSPECTED A MINIMUM OF ONCE PER MONTH. A FALL CLEAN-UP SHALL BE PERFORMED EACH YEAR. B. REMOVE ALL LITTER, DEBRIS AND WEEDS. C. MAINTAIN A MINIMUM OF A 2 INCH DEPTH OF ORGANIC HARDWOOD MULCH OR EQUIVALENT IN ALL PLANTING BEDS.

IRRIGATION:

A. KEEP NEW TURF MOIST UNTIL ALL SEED GERMINATES AND BECOMES AN ESTABLISHED STAND OF TURF. B, AUTOMATIC SPRINKLERS SHALL BE CLEANED OUT AND TURNED OFF IN THE FALL PRIOR TO THE FIRST FROST, AND TESTED WHEN TURNED ON IN THE SPRING.

C. EVALUATE SUCCESS OF IRRIGATION SYSTEM AND MODIFY AS NECESSARY.

- 3. PRUNING: ALL PRUNING SHALL BE DONE IN ACCORDANCE WITH ANSI PRUNING STANDARDS. REMOVAL OF DEAD, DISEASED, INSECT INFESTED OR WEAK WOOD SHALL TAKE PLACE WHEN APPROPRIATE FOR THE SPECIES. THE VIRGINIA TECH PRUNING CALENDAR SHALL BE USED FOR GUIDANCE ON APPROPRIATE TIMING. EXCESSIVE SHOOTS AND SUCKERS SHALL BE REMOVED.
- INSECT AND DISEASE CONTROL: THE CONTROL OF INSECTS AND DISEASE ASSOCIATED WITH ALL PLANTING AREAS SHALL BE A MAINTENANCE PRIORITY. ALL PLANTINGS, INCLUDING EXISTING MATURE TREES, SHALL BE PERIODICALLY INSPECTED FOR INSECT OR DISEASE INFESTATION. METHODS USED TO CONTROL INSECTS OR DISEASE MAY RANGE FROM SPRAYING AND PRUNING TO PLANT REMOVAL. SAFETY AND CONTROL SHALL BE OF PRIME CONCERN. TRAINED AND CERTIFIED PERSONNEL SHALL PERFORM THESE TASKS.

A. RENOVATION INCLUDES THE RESEEDING OR REPLANTING OF LANDSCAPE AREAS DAMAGED, DESTROYED OR FAILING DUE TO INSECTS, DISEASE, WEATHER OR PHYSICAL DAMAGE.

B. ALL LAWN AREAS WHERE SOIL HAS BEEN EXPOSED SHALL BE RENOVATED DURING THE NEXT PLANTING SEASON. PROPER HORTICULTURAL AND SOIL EROSION PREVENTION METHODS SHALL BE USED. IF SOIL EROSION HAS OCCURRED, THE AREA SHALL BE REPAIRED WITH A SEED MIXTURE COMPATIBLE WITH EXISTING SOIL.

C. ALL PLANTINGS WHICH ARE DAMAGED OR DESTROYED SHALL BE REPLACED DURING OR BEFORE THE NEXT GROWING SEASON.

D. CARE SHALL BE TAKEN TO AVOID DAMAGE TO ESTABLISHED TREE ROOTS DURING RENOVATION OF LANDSCAPE

SITE AMENITIES: BENCHES, PATHS, BICYCLE RACKS, TRASH RECEPTACLES, AND SIGNS SHALL BE INSPECTED AT LEAST TWICE A YEAR, ONCE IN SPRING AND ONCE IN AUTUMN, TO DETERMINE THEIR CONDITION. ANY DAMAGED, WORN, OR UNSAFE CONDITIONS SHALL BE RECTIFIED IMMEDIATELY.

PAVED SURFACES:

A. ALL PAVED SURFACES SHALL BE INSPECTED ON A MONTHLY-BASIS FOR TRASH, STAINS, DAMAGE, CRACKS, POT HOLES, AND OBSTRUCTIONS, AND RETURNED TO THEIR ORIGINAL CONDITIONS. ANY UNSAFE CONDITIONS, SUCH AS UNEVEN SURFACES OR TRIPPING HAZZARDS, SHALL BE RECTIFIED IMMEDIATELY.

ARLINGTON COUNTY LANDSCAPE STANDARDS REFERENCE GUIDE | PG. 37

703.549.7784 WWW.LANDDESIGN.COM

CONSTRUCTION

2025 CLARENDON BOULEVARD

GREYSTAR

2025 CLARENDON BOULEVARD

ARLINGTON, VA

2020194 REVISION / ISSUANCE DESCRIPTION 04/16/2021 4.1 SUBMISSION COUNTY MEETING 4.1 SUBMISSION 02/07/2022

> DESIGNED BY: MC/JVW DRAWN BY: JVW/LH CHECKED BY: JVW

HORZ: N/A

ORIGINAL SHEET SIZE: 24" X 36"

GENERAL NOTES


L001

ARLINGTON COUNTY LANDSCAPE STANDARDS REFERENCE GUIDE | PG. 38

ΔB	BREVIAT	TIONS			
4	AD ADJ	AREA DRAIN ADJACENT	L	L LT	LENGTH LIGHT
	AFG ALT ALUM	ABOVE FINISHED GRADE ALTERNATE ALUMINUM		LP	LOW POINT
	APPROX ARCH	APPROXIMATE ARCHITECT(URAL)	М	MAS MATL MAX	MASONRY MATERIAL MAXIMUM
	ВС	BOTTOM OF CURB		MECH MED	MECHANICAL MEDIUM
	BLDG BLKG	BUILDING BLOCKING		MFR MIN	MANUFACTURER MINIMUM
	BOC BOT	BACK OF CURB BOTTOM		MISC MTL	MISCELLANEOUS METAL
	BR BS	BOTTOM OF RAMP BOTTOM OF STAIR		IVIIL	IVIETAL
	BW	BOTTOM OF WALL	N	N	NORTH
				NIC NO	NOT IN CONTRACT NUMBER
	CEM CIP	CEMENT CAST IN PLACE		NOM NTS	NOMINAL NOT TO SCALE
	CJ CMU	CONTROL JOINT CONCRETE MASONRY UNIT			
	CO COL	CLEANOUT COLUMN	0	ОС	ON CENTER
	CONT	CONTINUOUS CONCRETE		OD OPNG	OUTSIDE DIAMETER OPENING
	CONC CU FT	CUBIC FEET		OPP	OPPOSITE
			Р	РВ	PLANT BED
	DD DE	DECK DRAIN DRAINAGE EASEMENT	i-	PERF	PERFORATED
	DE DI DIA	DRAINAGE EASEMENT DRAIN INLET DIAMETER		PNL PNT	PANEL PAINT(ED)
	DIAG DIM	DIAMETER DIAGONAL DIMENSION		PSI PT	POUNDS/SQUARE INCH PRESSURE TREATED
	DIM DN DS	DOWN DOWN SPOUT		POB POC	POINT OF BEGINNING POINT OF CURVATURE
	DWG(S)	DRAWING(S)		PROP	PROPOSED
	_	1	Q	QTY	QUANTITY
	E EA	EAST EACH			ı
	EJ EL	EXPANSION JOINT ELEVATION	R	RAD	RADIUS
	ELEC EOP	ELECTRIC(AL) EDGE OF PAVEMENT		REINF REQD	REINFORC(E), (ING) REQUIRED
	EQ EQUIP	EQUAL EQUIPMENT		REV R.O.W	REVISION RIGHT OF WAY
	ESMT EW	EASEMENT EACH WAY			
	EXP EXIST	EXPANSION EXISTING	S	S SB	SOUTH SETBACK
	EXT	EXTERIOR		SCHED SD	SCHEDUL(E), (ED) STORM DRAIN
	FAB	FABRIC		SF SIM	SQUARE FOOT, FEET SIMILAR
	FDC FG	FIRE DEPT. CONNECTION FINISHED GRADE		SQ SSMH	SQUARE SANITARY SEWER MANHOLE
	FH FIN	FIRE HYDRANT FINISH		STL SSTL	STEEL STAINLESS STEEL
	FOC FT	FACE OF CURB FOOT, FEET		STD SUSP	STANDARD SUSPENDED
	FTG	FOOTING		SW SYM	SIDEWALK SYMBOL
	GA	GAUGE		O	- C1MB02
	GAL GALV	GALLON GALVANIZED	Т	TBD	TO BE DETERMINED
	GC GV	GENERAL CONTRACTOR GATE VALVE		TC THK	TOP OF CURB THICK(NESS)
		I.		TR TS	TOP OF RAMP TOP OF STAIR
	HDW	HARDWARE		TW TYP	TOP OF WALL TYPICAL
	HDWD HORZ	HARDWOOD HORIZONTAL			
	HP HT	HIGH POINT HEIGHT	U	UE U.N.O	UTILITY EASEMENT UNLESS NOTED OTHERWISE
		word =			
	ID INCL	INSIDE DIAMETER INCLUDE	V	VERT VIF	VERTICAL VERIFY IN FIELD
	INSUL INT	INSULATION INTERIOR			
	INV	INVERT	W	W	WEST, WIDE, WIDTH
	JB	JUNCTION BOX		W/ W/O	WITH WITHOUT
	JT	JOINT		WD WL	WOOD WATER LINE
	KO	KNOCK OUT		WM WT	WATER METER WEIGHT WEIDED WIRE MESH
	NU	NINOCK OUT		WWM	WELDED WIRE MESH
	L	LENGTH			
	LT LP	LIGHT LOW POINT			
		EVIATIONS APPLY TO LANDDESIGN NOT CHITECTURAL AND OTHER ABBREVIATION			
	.,				



200 S. PEYTON STREET ALEXANDRIA, VA 22314 703.549.7784 WWW.LANDDESIGN.COM

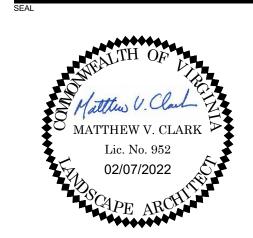

NOT FOR CONSTRUCTION

2025 CLARENDON BOULEVARD

GREYSTAR
2025 CLARENDON BOULEVARD

ARLINGTON, VA


LANDDE	SIGN PROJ.# 2020194								
REVISION / ISSUANCE									
NO.	DESCRIPTION	DATE							
_ 1	4.1 SUBMISSION	04/16/2021							
2	COUNTY MEETING	07/19/2021							
3	4.1 SUBMISSION	02/07/2022							

DESIGNED BY: MC/JVW DRAWN BY: JVW/LH

DRAWN BY: JVW/LH CHECKED BY: JVW

VERT: N/A HORZ: N/A

GENERAL NOTES

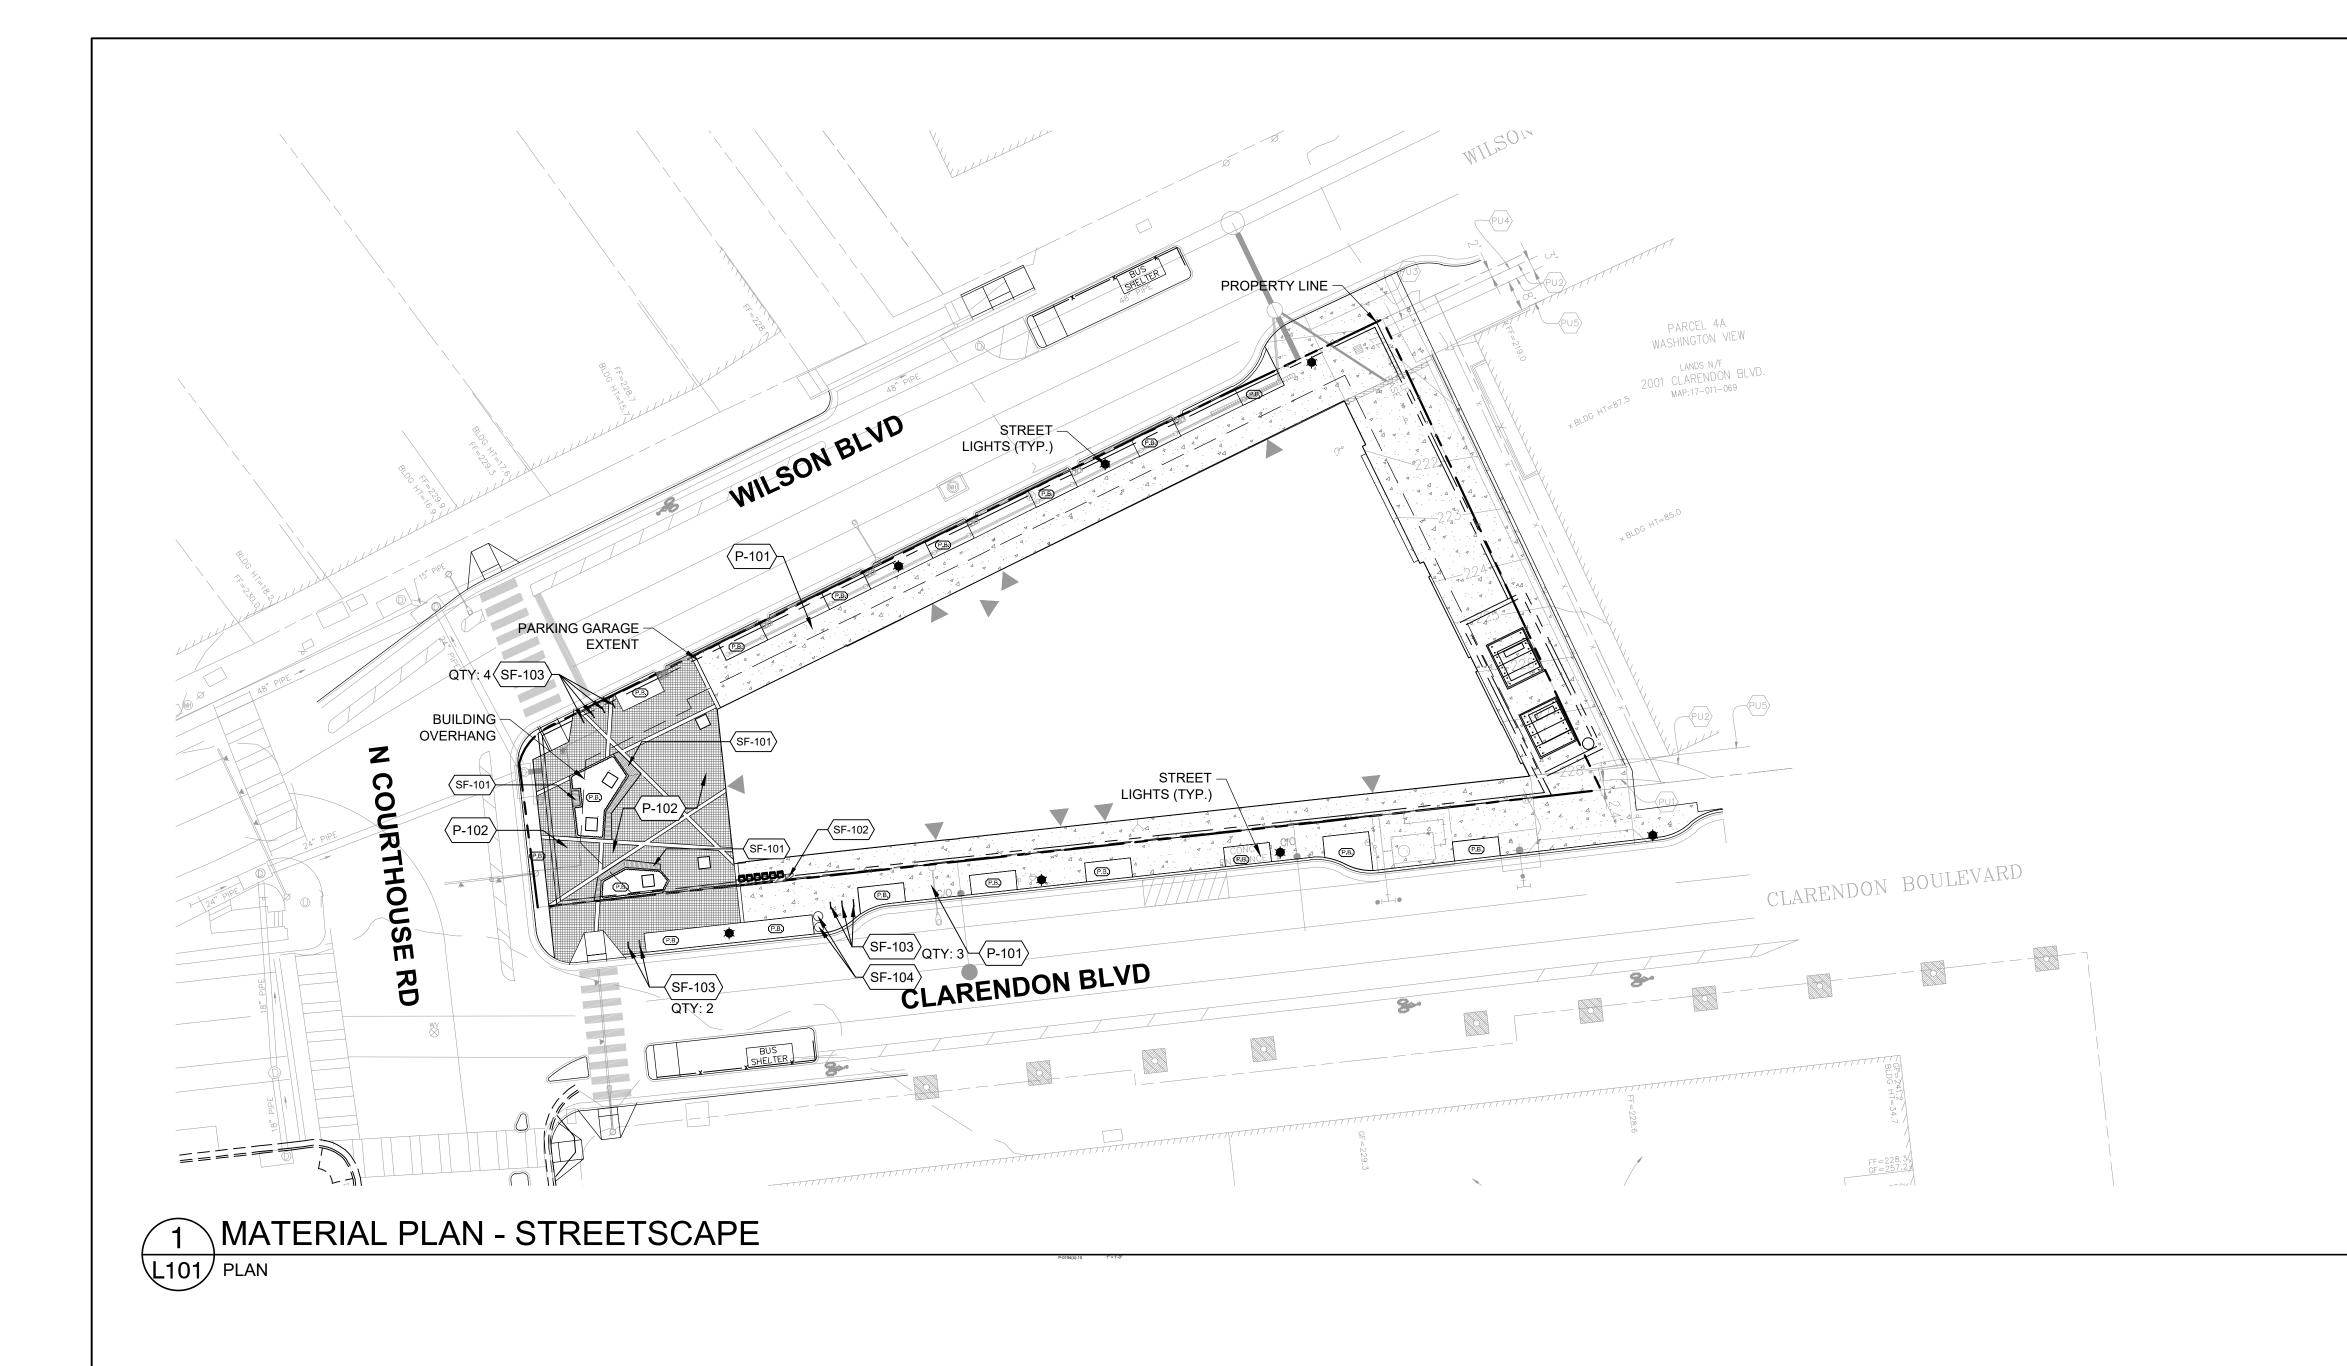

REFERENCE NOTES SCHEDULE

		_
SYMBOL	PAVING & CURBS DESCRIPTION	<u>DETAIL</u>
(P-101)	PEDESTRIAN CONCRETE	1/L401
\(\begin{pmatrix} P-102 \end{pmatrix}\)	ENHANCED PEDESTRIAN CONCRETE	2/L401
SYMBOL	FURNISHINGS DESCRIPTION	<u>DETAIL</u>
SF-101	BENCH	4/L401
SF-102	HIGH TOP RAIL	6/L401
⟨SF-103⟩	BIKE RACK	7/L401
⟨SE 404⟩	TRACILIAND DECYCLING DING	0/1 404

LandDesign.

200 S. PEYTON STREET ALEXANDRIA, VA 22314 703.549.7784 WWW.LANDDESIGN.COM

NOT FOR CONSTRUCTION

2025 CLARENDON BOULEVARD

GREYSTAR 2025 CLARENDON BOULEVARD

ARLINGTON, VA

REVISION / ISSUANCE DESCRIPTION 4.1 SUBMISSION COUNTY MEETING

4.1 SUBMISSION

DESIGNED BY: MC/JVW DRAWN BY: JVW/LH CHECKED BY: JVW

MATERIAL PLANS


L101

REFERENCE NOTES SCHEDULE

		COLLEGE
SYMBOL	FURNISHINGS DESCRIPTION	DETAIL
(F-201)	POOL FENCE	7/L402
SYMBOL	PAVING & CURBS DESCRIPTION	<u>DETAIL</u>
(P-201)	POOL DECK	1/L402
(P-202)	ENHANCED CONCRETE - TYPE 1	2/L402
(P-203)	ENHANCED CONCRETE - TYPE 2	2/L402
SYMBOL	FURNISHINGS DESCRIPTION	<u>DETAIL</u>
SF-201	OUTDOOR KITCHEN	5/L402
SF-202	LOUNGE SEATING	3/L402
SF-203	CANTILEVERED BENCH	8/L402
SF-204	DINING TABLE AND CHAIRS	8/L402
SF-205	POOL LIFT	7/L402
SF-206	POOL WATER FEATURE	1/L402
SF-207	MONUMENTAL SEATING	5/L401
SYMBOL	WALLS & STAIRS DESCRIPTION	<u>DETAIL</u>
(W-201)	RAISED PLANTER WALL	4/L402
\(\text{W-202}\)	METAL EDGE PLANTER	4/L402
NOTES:		

1:25


- 1. UTILITY INFORMATION SHOWN FOR REFERENCE ONLY. SEE CIVIL DRAWINGS FOR ALL UTILITY INFORMATION AND ASSESSMENT.
- 2. ALL HATCHES ARE FOR GRAPHIC REPRESENTATION ONLY. 3. ALL DRAWINGS ARE PROVIDED FOR INFORMATIONAL PURPOSES ONLY AND ARE SUBJECT TO CHANGE PER FINAL ARCHITECTURE, CIVIL AND SITE DESIGN.
- 4. MOVEABLE FURNITURE IS FOR ILLUSTRATIVE PURPOSES ONLY. FINAL SELECTION TO BE DONE BY TENANT.
- 5. DRAWINGS ARE NOT FOR CONSTRUCTION.

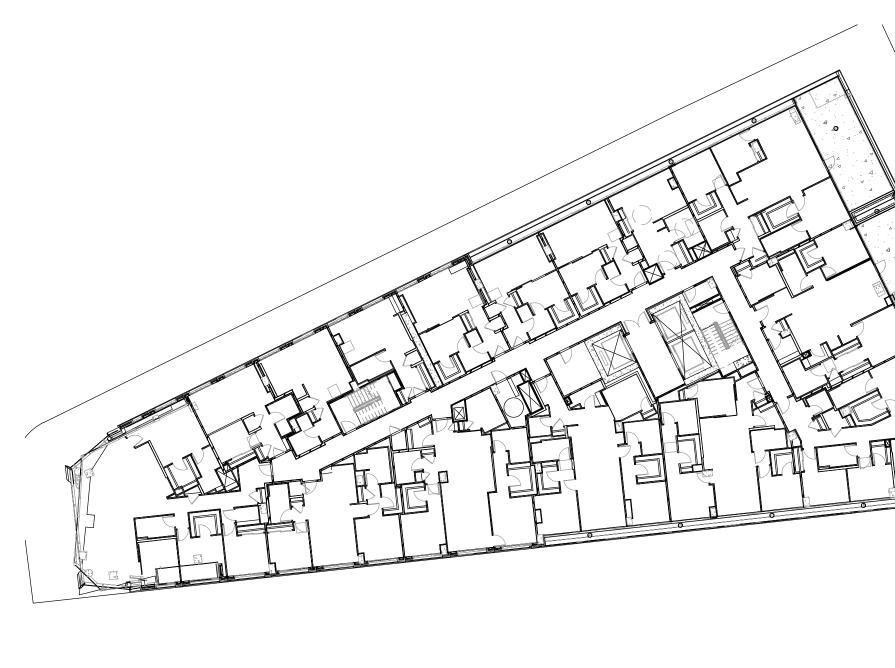

2 MATERIAL PLAN - ROOFTOP

3 MATERIAL PLAN - LEVEL 11

ORIGINAL SHEET SIZE: 24" X 36"

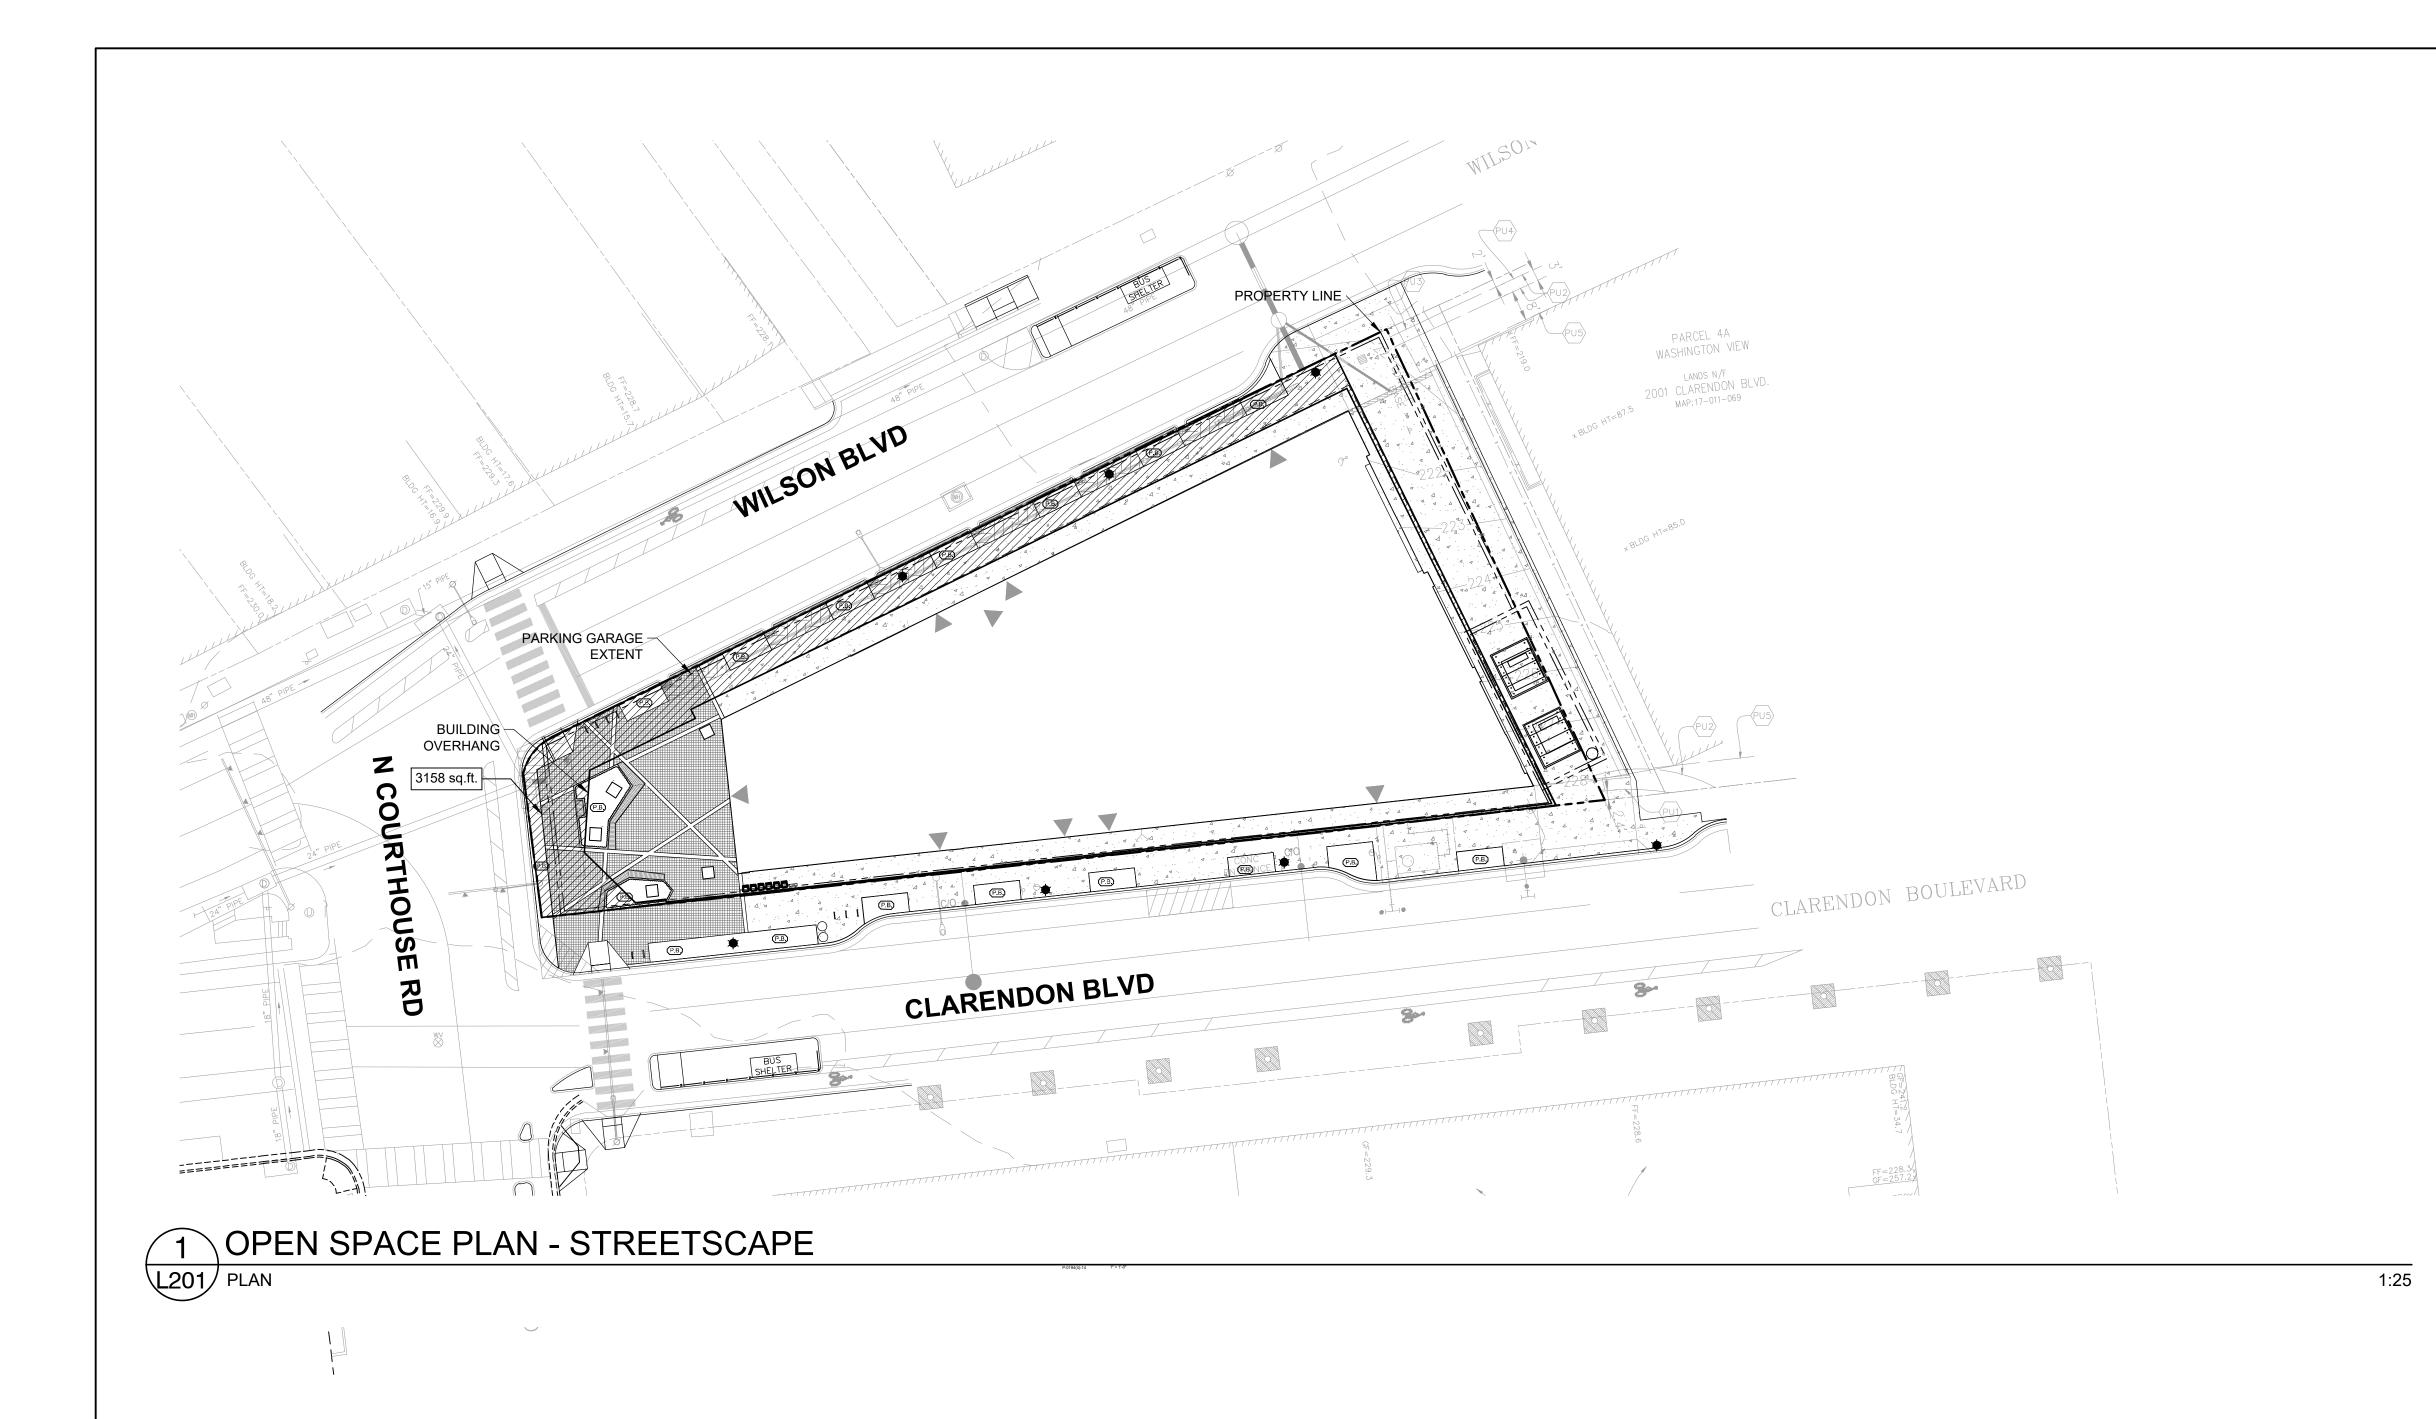


GROUND LEVEL OPEN SPACE

TAKEOFF: 3,158 SF

PENTHOUSE OPEN SPACE

TAKEOFF: 5,741 SF

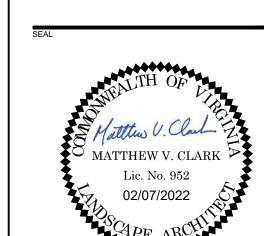

200 S. PEYTON STREET ALEXANDRIA, VA 22314 703.549.7784 WWW.LANDDESIGN.COM

NOT FOR CONSTRUCTION

2025 CLARENDON BOULEVARD

GREYSTAR 2025 CLARENDON BOULEVARD

ARLINGTON, VA

REVISION / ISSUANCE

DESCRIPTION 4.1 SUBMISSION **COUNTY MEETING** 4.1 SUBMISSION

DESIGNED BY: MC/JVW DRAWN BY: JVW/LH CHECKED BY: JVW

OPEN SPACE PLANS

L201

OPEN SPACE CALCULATIONS

OPEN SPACE PROVIDED - ON SITE

STREET LEVEL	3,158 SF +/-
ROOFTOP	5,741 SF +/-
TOTAL OPEN SPACE	8,899 SF
TOTAL SITE AREA	23,071 SF
PERCENTAGE OF TOTAL OPEN SPACE	38.57%

NOTE: ARLINGTON COUNTY, VA ZONING ORDINANCE PER CHAPTER 7.3.4 D - MINIMUM OF 10% OF THE TOTAL SITE AREA IS REQUIRED TO BE LANDSCAPED OPEN SPACE.

1:25

- 1. SEE CIVIL DRAWINGS FOR ALL UTILITY INFORMATION AND ASSESSMENT.
- 2. ALL DRAWINGS ARE PROVIDED FOR INFORMATIONAL PURPOSES ONLY AND ARE SUBJECT TO CHANGE PER FINAL ARCHITECTURE, CIVIL, AND SITE DESIGN.
- 3. DRAWINGS ARE NOT FOR CONSTRUCTION.

2 OPEN SPACE PLAN - ROOFTOP

L201 PLAN

2/4/2022 5:08 PM DAPHNE BRICE Z:\TEMPLATES\SHEETS\CD SHEETS\LA\SHEET-24X36.DWT








NTS

TRASH AND RECYCLING BINS L401 PICTORIAL



L401 PICTORIAL

PEDESTRIAN CONCRETE L401 PICTORIAL NTS

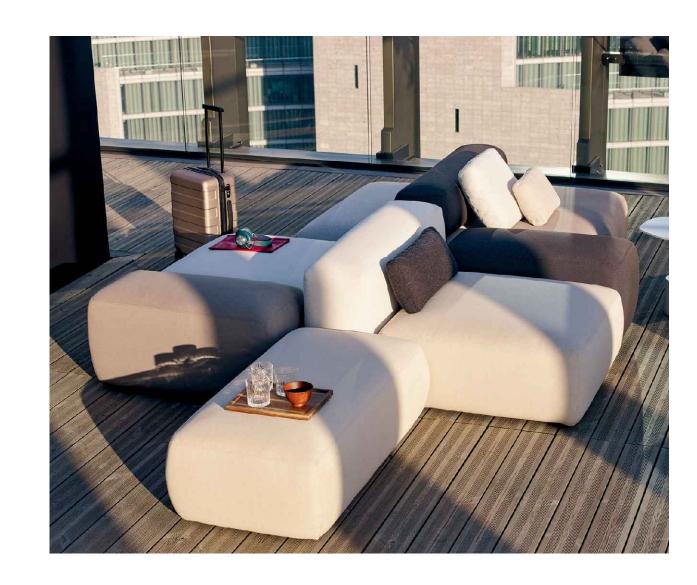

NOTES:



5 MONUMENTAL SEATING

6 HIGH TOP RAIL

R-8.3

NTS

2025 CLARENDON BOULEVARD

NOT FOR

CONSTRUCTION

2025 CLARENDON

BOULEVARD

GREYSTAR

2020194

REVISION / ISSUANCE

04/16/2021

02/07/2022

DESCRIPTION

4.1 SUBMISSION

COUNTY MEETING

4.1 SUBMISSION

LandDesign.

200 S. PEYTON STREET ALEXANDRIA, VA 22314 703.549.7784 WWW.LANDDESIGN.COM

BENCH

1, THIS TECHNICAL SPECIFICATION IS INCLUDED BY REFERENCE IN THE ARLINGTON COUNTY BICYCLE PARKING STANDARDS. BICYCLE RACKS SHALL BE OF AN ACCEPTED DESIGN THAT PROVIDES TWO POINTS OF CONTACT WITH A PARKED BICYCLE.
 INVERTED "U" RACKS AND OTHER DESIGNS CONSTRUCTED OF TUBING SHALL BE 2" NOM. (2.38" O.D.) SCH. 40 STEEL P.PE AS PER ASTM A53, OR 2" SQUARE SECTION 8 GAUGE AS PER ASTM A-500.

3. TOP OF INSTALLED BICYCLE RACKS SHALL BE MINIMUM 33" ABOVE FINISHED GRADE, 4. BICYCLE RACKS SHALL BE INSTALLED USING THE FOLLOWING OPTIONS ONLY:

- a. FLANGE-MOUNTED TO CURED CONCRETE
- b. IN-GROUND (ANCHORED IN NEW CONCRETE) c. MOUNTED ON RAILS MOUNTED TO CURED CONCRETE OR ASPHALT
- 5. IF MULTIPLE RACKS ARE INSTALLED, THEY SHALL BE UNIFORMLY ALIGNED, AND EVENLY SPACED. FOR LAYOUT PURPOSES, EACH BICYCLE RACK SHALL BE CENTERED IN A "DESIGN STALL" OF MINIMUM DIMENSION 36" X 72". 6. ACCEPTABLE MATERIALS AND COATINGS. PIPE (AND FLANGES, RAILS, ANCHOR PINS, SHIMS, AND FASTENERS, IF APPLICABLE) SHALL BE HOT-DIP GALVANIZED (HOG) AS PER ASTM A123 AND A304; OR STAINLESS STEEL AS PER ASTM A666 AND A2-0. BICYCLE RACKS MAY BE POWDER COATED OVER HDG AS PER ASTM D 7803, OR THERMOPLASTIC COATED AS APPROVED BY THE COUNTY. COATING MUST BE COMPLETE, I.E., DIPPED OR COMPLETELY POWDER COATED.

7. BICYCLE RACKS SHALL BE ANCHORED FIRMLY, AND INSTALLED VERTICAL (PLUMB) IN TWO PLANES. 8. NO COMPONENT OF THE INSTALLED BICYCLE RACK SHALL RESULT IN A TRIPPING HAZARD. 9. BICYCLE RACKS SHALL NOT BE MOUNTED DIRECTLY TO UNIT PAVERS ONLY.

10. FASTENERS WHEN USED SHALL: a. BE OF ACCEPTABLE MATERIAL AND COATING.

b. MEET ONE OF THE FOLLOWING REQUIREMENTS

TYPE	SPECIFICATION	MINIMUM SIZE	MINIMUM INSTALLATION DEPTH	ACCEPTABLE EMBEDMENT MATERIAL		
THREADED	ASME B18.18:2017	3/8"	AS NECESSARY	METAL TO METAL. TAMPER RESISTANT NUTS REQUIRED.		
FRICTION	A-A-1925a, ASTM E 488	3/8"	3"	CONCRETE		
MECHANICALLY EXPANDED	A-A-55614, ASTM E 488	3/8"	3.5"	CONCRETE		
ADHESIVE BONDED	ASTM C 881, ASTM E1512	3/8"	6"	CONCRETE, ASPHALT		

- c. BE ABLE TO PROVIDE FIRM, SECURE ANCHORING WITH A MAXIMUM OF ¼-INCH NON-TRIP HAZARD PROJECTION ABOVE FINISHED GRADE. d. BE THREADED OR DRIVEN ANCHORS. THREADED FASTENERS TO BE FIXED WITH TAMPER-RESISTANT NUTS AS APPROVED BY THE COUNTY.
 - GENERAL NOTES FOR BICYCLE RACK

NOTES: FLANGE MOUNTED INSTALLATION:

FLANGE MOUNTED RACKS SHALL BE INSTALLED ON EXISTING CURED CONCRETE. USE FLANGE RACKS WITH FASTENERS AS
SPECIFIED ABOVE. EXISTING CONCRETE SHALL CONFORM TO CONCRETE SIDEWALK STD., ARLINGTON COUNTY
CONSTRUCTION SPECIFICATION SECTION 02611, AND STD. DWG. R-2.0 (MIN. 4" THICKNESS).
 RACK LEGS SHALL BE WELDED TO FLANGES WITH COMPLETE SEAMLESS CONTINUOUS FILLET WELDS CONFORMING TO ASTM
A36, ASTM A312, AND AWS D1.1. SPORT, TACK, OR INTERMITTENT WELDING IS NOT ACCEPTABLE.
 FLANGES SHALL BE MINIMUM 3/8" THICK, WITH MINIMUM TWO ½" DIA. HOLES (TWO FASTENERS) PER FLANGE.
 FLANGE MOUNTED RACKS SHALL NOT BE BOLTED TO UNIT PAVERS.
 WHERE CONCRETE PAVERS OR FIRED CLAY BRICK ARE INSTALLED OVER CONTINUOUS CONCRETE SUB-BASE,
FLANGE-MOUNTED RACKS SHALL BE INSTALLED ON CONCRETE SUB-BASE. INSTALLATION MUST NOT COMPROMISE ANY
WATERPROOFING OF CONCRETE. (FOR EXAMPLE, INSTALLATION ABOVE UNDERGROUND PARKING STRUCTURE.)
 UNIT PAVERS SHALL BE INSTALLED IN ACCORDANCE WITH ARLINGTON COUNTY CONSTRUCTION SPECIFICATION SECTION
02612.

U.2012.
 Y. UNIT PAVERS SHALL BE NEATLY CUT AND FIT AROUND FLANGES, FASTENERS, AND LEGS OF RACK.
 LEGS OF FLANGE MOUNTED RACKS SHALL BE OF SUFFICIENT LENGTH TO PROVIDE MINIMUM ACCEPTABLE HEIGHT OF 33" ABOVE FINISH GRADE.

IN-GROUND RACK INSTALLATION:

1. LEGS OF IN-GROUND RACKS SHALL BE FITTED WITH ANCHOR PINS TO PREVENT LIFT-OUT. ANCHOR PINS SHALL BE: OF ACCEPTABLE MATERIAL. b. MIN. 3/8" DIAMETER WITH MIN. 3" CONCRETE ENCASEMENT,

 IN-GROUND RACKS SHALL BE INSTALLED AND FIRMLY ANCHORED IN NEW CONCRETE OF MINIMUM DIMENSIONS SHOWN, ANCHORED PORTIONS OF RACK SHALL HAVE MIN. 3" CONCRETE ENCASEMENT ON ALL SIDES.
 FOR RACK INSTALLATIONS ON SITES WITH CONCRETE AVERS OR FIRED CLAY BRICK INSTALLED OVER COMPACTED SCIL SUB-BASE AND SAND LEVELING COUNSE AS PER ARLINGTON COUNTY STANDARD SPECIFICATIONS SECTION 02612, AND STANDARD DWG. R-2.1, RACKS SHALL BE INSTALLED IN CONCRETE FOOTING OF DIMENSIONS SHOWN. 4. WHERE IN-GROUND RACKS ARE INSTALLED IN UNPAYED SOIL, OR SOD/GRASS/TURF, PROVIDE A SINGLE CONCRETE FOOTING OF DIMENSIONS SHOWN. PROVIDE A TAMPED GRAVEL PAD MIN. 4" THICKNESS, AND MIN. 36" X 72" CENTERED ON EACH INSTALLED RACK. 5. LEGS OF IN-GROUND RACKS SHALL BE OF SUFFICIENT LENGTH TO PROVIDE ANCHORING BELOW GRADE A MINIMUM OF 9" AND BE A MINIMUM HEIGHT OF 33" ABOVE FINISH GRADE.

INSTALLATION ON RAILS:

RAILS SHALL BE TYPE AISI C3 X 4.1 STEEL CHANNEL AS PER ASTM A36, HDG, OR POWDER COATED OVER HDG TO MATCH RACKS. RACKS.

3. INDIVIDUAL RACKS CAN BE WELDED TO RAILS. WELDS SHALL BE COMPLETE SEAMLESS CONTINUOUS FILLET WELDS CONFORMING TO ASTM A36, ASTM A312 AND AWS D1.1. SPOT, TACK, OR INTERMITTENT WELDING IS NOT ACCEPTABLE.

4. INDIVIDUAL RACKS CAN BE BOLTED TO RAILS.

5. IF RACKS ARE BOLTED TO RAILS, FASTENERS SHALL BE:

a. OF ACCEPTABLE MATERIAL.

MIN. 3/8" DIAMETER.

c. ABLE TO PROVIDE FIRM, SECURE ANCHORING WITH THREADED NUTS ON UNDERSIDE OF STEEL CHANNEL. d. FITTED WITH TAMPER- RESISTANT THREADED NUTS AS APPROVED BY THE COUNTY. RACKS ON RAILS MAY BE APPROVED FOR INSTALLATION ON FINISHED ASPHALT. IN SUCH CASES, A PERMANENTLY GROUTED, INTERNALLY THREADED ASPHALT ANCHOR AS APPROVED BY THE COUNTY SHALL BE USED TO PROVIDE ATTACHMENT.

SITE APPLICATION NOTES FOR BICYCLE RACK INSTALLATION ARLINGTON COUNTY, VIRGINIA DRAWING NO. A R L I N G T O N DEPARTMENT OF ENVIRONMENTAL SERVICES R-8.1

DIMENSION 36" X 72".

IF MULTIPLE RACKS ARE ANGLED OR SKEWED, CENTER-TO-CENTER SEPARATION BETWEEN PARALLEL RACKS MUST BE INCREASED TO MAINTAIN THE MINIMUM 36" X 72" CLEAR "STALL" AREA AT EACH RACK.

MINIMUM 24" CLEARANCE IS NEEDED FROM WALL OR OTHER OBSTRUCTIONS. SINGLE RACK SIDE BY SIDE RACKS AS ANGLE INCREASES, INCREASE SEPARATION BETWEEN ADJACENT RACKS TO MAINTAIN 36" 24" MIN. INCREASE AS NECESSARY TO ACCOMMODATE CARGO BICYCLES, PROJECT DEPENDENT. END TO END RACKS **BICYCLE RACK LAYOUT** REVISION & DATE ARLINGTON COUNTY, VIRGINIA DRAWING NO.

DEPARTMENT OF ENVIRONMENTAL SERVICES

1. FOR LAYOUT PURPOSES, EACH BICYCLE RACK SHALL BE CENTERED IN A "STALL" OF MINIMUM

CONCRETE No. 14 1 1 1 1 1 1 1 1 1 1 1 1 1 1 1 1 1 1	FASTENERS AS SPEC MINIMUM 2 PER FLAN 3/8" THICK FLANGE N	CIFIED, IGE
	ANGE MOUNT FLUSH PICAL INSTALLATION)	/-RACK
2 3/8"-8 GAUGE : BIKE RACK @ 36 FINISHED GRAD CONCRETE FOO	FOOTING FOOTING (PAVERS SHOWN)	24.700
<u>IN-G</u>	ROUND RACK INSTALLATION	
2 3/8" - 8 GAUGE STEEL TUBING BIKE RACK RACK SEAMLESSLY WELDED TO RAIL, OR BOLTED WITH 2 TAMPER RESISTANT FASTENERS PER FLANGE (MIN 4 PER RACK) C3 X 4.1 STEEL CHANNEL WITH APPROVED FINISH MIN ONE (1) 1/2" DIA. HOLE AT EACH CORNER OF	NAX. NIN WIN WIN WIN WIN WIN WIN WIN WIN WIN	3 1/2" MIN"
RACK/RAIL ASSEMBLY FOR ATTACHMENT TO SURFACE (MIN FOUR (4) TOTAL) INSTALLATION ON RAILS	FRICTION (MECHANICAL EXPANSION * MIN 3 1/2" FOR ADHESIVE BONDED AI MIN 6" FOR ADHESIVE BONDED ANCHO ANCHOR DETAIL	NCHOR IN CONCRETE. DR IN ASPHALT.
	,	
BICYCLE RACK	INSTALLATION	REVISION & DATE
	COUNTY, VIRGINIA	DRAWING NO.

NOTES: 1. SEE MATERIALS PLAN FOR LOCATION. 2. PICTORIAL PRESENTATION DOES NOT REFLECT FINAL PATTERN OR COLOR CHOICE.

3. OR APPROVED EQUAL.

VERT: N/A HORZ:

DESIGNED BY: MC/JVW

DRAWN BY: JVW/LH

CHECKED BY: JVW

HARDSCAPE DETAILS

L401 STANDARD DETAILS

2/4/2022 5:08 PM RDP G:\2020\2020194\CAD\DOCUMENTATION\ENTITLEMENTS\0194-DTL-HRDS.DWG ORIGINAL SHEET SIZE: 24" X 36"

R-8.2

A R L I N G TO N DEPARTMENT OF ENVIRONMENTAL SERVICES







2 ENHANCED CONCRETE - TYPE 1 & 2
L402 SECTION



3 LOUNGE SEATING
L402 SECTION

NTS







5 OUTDOOR KITCHEN
L402 SECTION

NTS

CHEN

NTS



6 DINING TABLE AND CHAIRS



7 POOL FENCE & LIFT L402 PICTORAL

NTS

NTS



8 CANTILEVERED BENCH
L402 PICTORAL



 SEE MATERIALS PLAN FOR LOCATION.
 PICTORIAL PRESENTATION DOES NOT REFLECT FINAL PATTERN OR COLOR CHOICE.
 OR APPROVED EQUAL.

MATTHEW V. CLARK

Lic. No. 952

02/07/2022

CAPE ARCHITECTE

200 S. PEYTON STREET ALEXANDRIA, VA 22314 703.549.7784 WWW.LANDDESIGN.COM

NOT FOR CONSTRUCTION

2025 CLARENDON BOULEVARD

GREYSTAR

2025 CLARENDON BOULEVARD

ANDDESI	GN PROJ.# 2020194					
REVISION / ISSUANCE						
NO.	DESCRIPTION	DATE				
1	4.1 SUBMISSION	04/16/2021				
2	COUNTY MEETING	07/19/2021				
3	4.1 SUBMISSION	02/07/2022				


DESIGNED BY: MC/JVW
DRAWN BY: JVW/LH
CHECKED BY: JVW


VERT: N/A

HARDSCAPE DETAILS

4 PLANTER WALLS

L402 PICTORAL

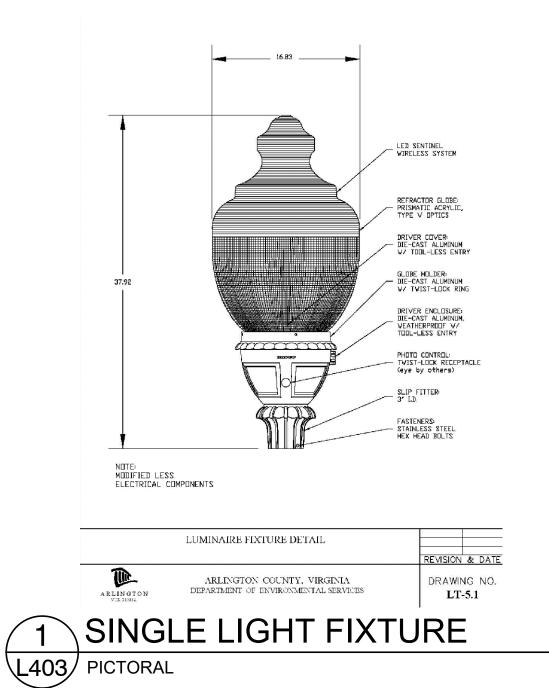

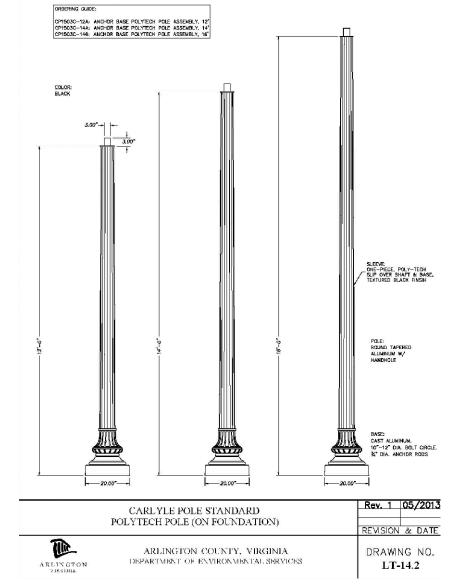

2 SINGLE LIGHT POST L403 PICTORAL

NOTE: 1. SEE DETAIL 2/L403FOR LIGHT POST DETAIL


NTS

NTS

LandDesign.

200 S. PEYTON STREET ALEXANDRIA, VA 22314 703.549.7784 WWW.LANDDESIGN.COM

KEY MAP

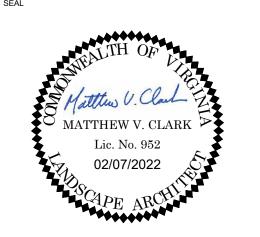

NOT FOR CONSTRUCTION

2025 CLARENDON BOULEVARD

GREYSTAR

2025 CLARENDON BOULEVARD

REVISION / ISSUANCE

NO. DESCRIPTION DATE

1 4.1 SUBMISSION 04/16/2021

2 COUNTY MEETING 07/19/2021

3 4.1 SUBMISSION 02/07/2022


DESIGNED BY: MC/JVW
DRAWN BY: JVW/LH
CHECKED BY: JVW


SCALE NORTH

VERT: N/A

SHEET TITLE

HARDSCAPE DETAILS

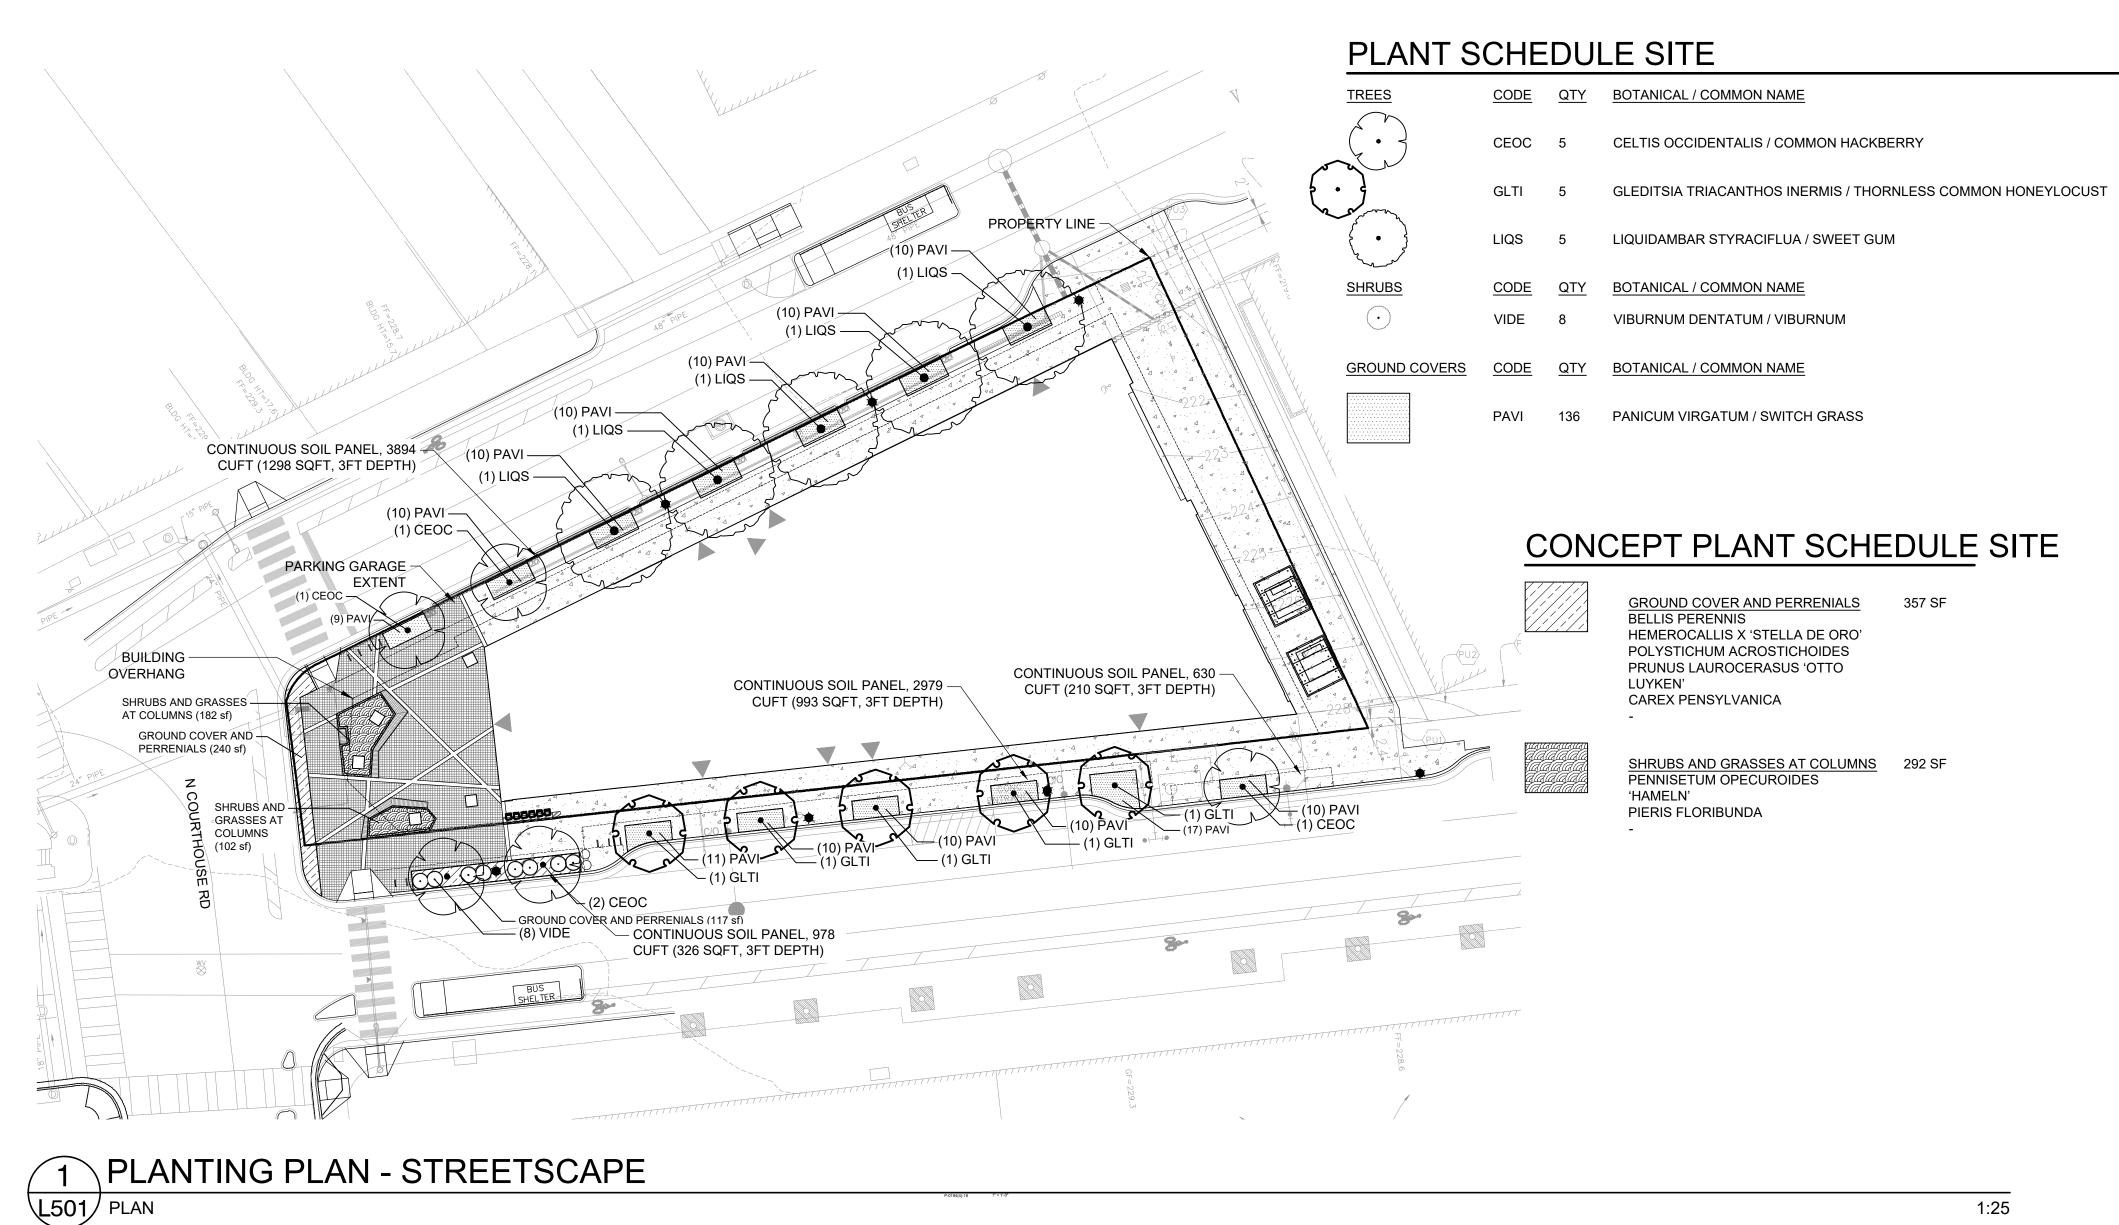

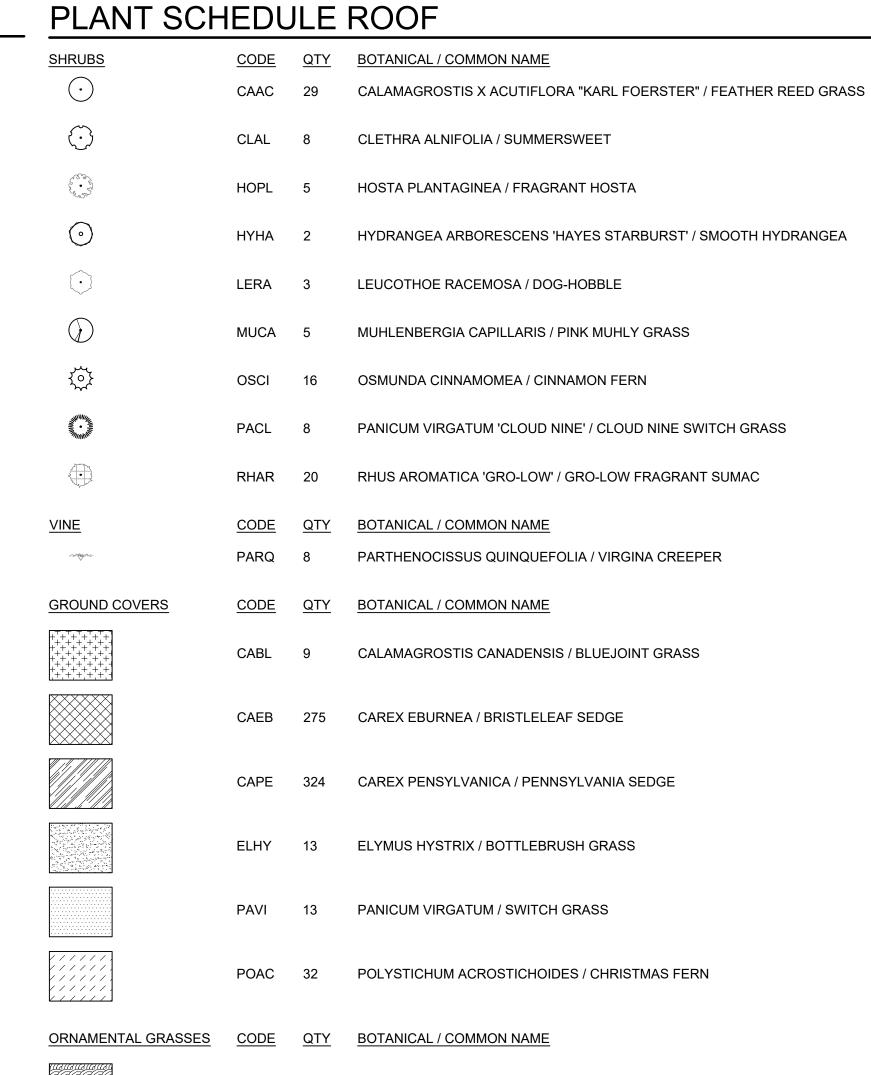


PLANT SCHEDULE LEVEL 11

CAST 8 CAREX STRICTA / TUSSOCK SEDGE

CODE QTY BOTANICAL / COMMON NAME PARTHENOCISSUS QUINQUEFOLIA / VIRGINA CREEPER QTY BOTANICAL / COMMON NAME

CAPE 302 CAREX PENSYLVANICA / PENNSYLVANIA SEDGE

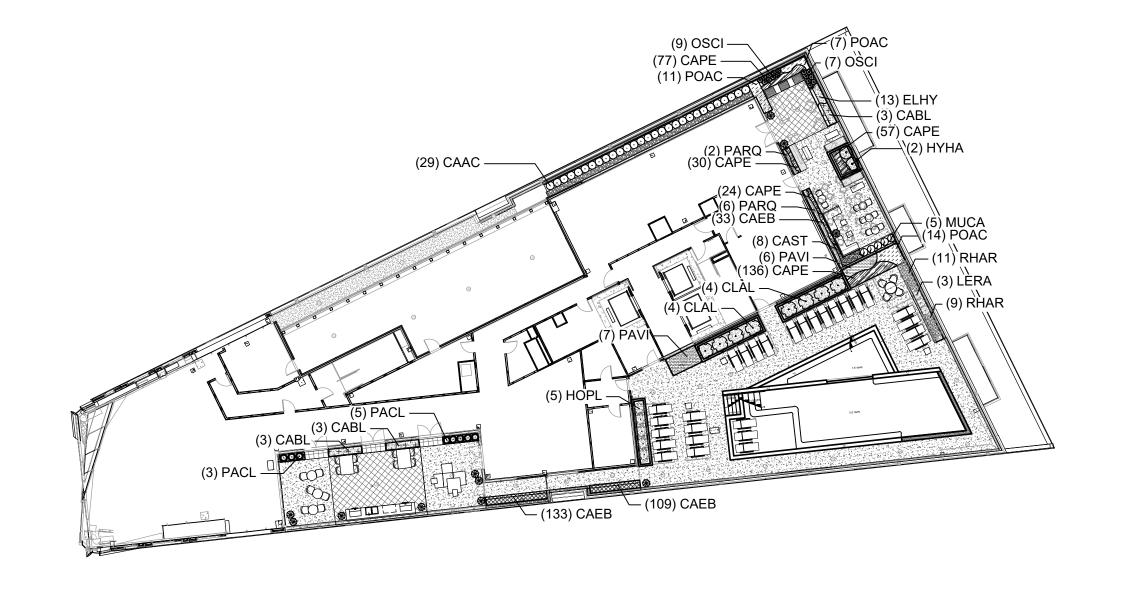

___ (6) PARQ

2 PLANTING PLAN - ROOFTOP L501 PLAN

3 PLANTING PLAN - LEVEL 11

1:25

1. IF STREET TREES DO NOT MEET MINIMUM SOIL REQUIREMENTS, SOIL EXPANSION TECHNOLOGIES WILL BE EXPLORED.

2. UTILITY INFORMATION SHOWN FOR REFERENCE ONLY. SEE CIVIL DRAWINGS FOR ALL UTILITY

INFORMATION AND ASSESSMENT.

ALL HATCHES ARE FOR GRAPHIC REPRESENTATION ONLY.

4. ALL DRAWINGS ARE PROVIDED FOR INFORMATIONAL PURPOSES ONLY AND ARE SUBJECT TO

CHANGE PER FINAL ARCHITECTURE, CIVIL AND SITE DESIGN. DRAWINGS ARE NOT FOR CONSTRUCTION.

ARLINGTON COUNTY GUIDELINES STATES THAT STREET TREES ALONG WILSON BLVD AND

CLARENDON BLVD ARE TO BE QUERCUS PHELLOS (WILLOW OAK). PER CONVERSATION WITH COUNTY STAFF, THESE TREES ARE BEING SUBSTITUTED WITH LIQUIDAMBAR STYRACIFLUA (AMERICAN SWEETGUM) DUE TO THEIR MORE COLUMNAR FORM THAT WILL BETTER FIT WITHIN THE CONSTRAINTS OF THE SITE.

DESIGNED BY: MC/JVW DRAWN BY: JVW/LH CHECKED BY: JVW PLANTING PLANS

ALEXANDRIA, VA 22314 703.549.7784 WWW.LANDDESIGN.COM

NOT FOR

CONSTRUCTION

2025 CLARENDON

BOULEVARD

GREYSTAR

2025 CLARENDON BOULEVARD

ARLINGTON, VA

REVISION / ISSUANCE

DESCRIPTION 4.1 SUBMISSION

COUNTY MEETING

4.1 SUBMISSION

L501

ORIGINAL SHEET SIZE: 24" X 36" 2/4/2022 5:09 PM DAPHNE BRICE Z:\TEMPLATES\SHEETS\CD SHEETS\LA\SHEET-24X36.DWT

TREE INVENTORY

2025 Clarendon Blvd, Arlington, VA
Date of site visit: March 3, 2021
Certified Arborist: Benjamin Hartmann MA-6213A

Tree #	Botanic Name	Common Name	Caliper (DBH) (inches)	Species Rating (0-100%)	Condition Rating (0-100%)	Total Rating	CRZ % Impact	Replacements Required	Preserve/ Remove
864	Cercis canadensis	Eastern Redbud	5.6	0.70	0.70	2.74	- 2	I I	REMOVE
865	Cercis canadensis	Eastern Redbud	3.2	0.70	0.65	1.46)	1	REMOVE
866	Cercis canadensis	Eastern Redbud	3.3	0.70	0.65	1.50	1 (4)	1	REMOVE
867	Liquidambar styraciflua	Sweetgum	12	0.70	0.70	5.88	0%	0	Preserve
868	Liquidambar styraciflua	Sweetgum	14	0.70	0.70	6.86	0%	0	Preserve
869	Quercus palustris	Pin Oak	16.6	0.70	0.30	3.49	0.751	1	REMOVE
870	Quercus phellos	Willow Oak	12.8	0.70	0.50	4.48	(2)	1	REMOVE
871	Quercus phellos	Willow Oak	15.4	0.70	0.60	6.47		2	REMOVE
872	Quercus phellos	Willow Oak	6.8	0.70	0.60	2.86		1	REMOVE
873	Quercus phellos	Willow Oak	9.6	0.70	0.50	3.36	ne:	1	REMOVE
874	Quercus phellos	Willow Oak	20.5	0.70	0.65	9.33	0%	0	Preserve
875	Quercus phellos	Willow Oak	17.6	0.70	0.60	7.39	0%	0	Preserve
878	Quercus phellos	Willow Oak	10.2	0.70	0.75	5.36	0%	0	Preserve
879	Quercus phellos	Willow Oak	5	0.70	0.75	2.63	0%	0	Preserve
880	Quercus phellos	Willow Oak	8	0.70	0.75	4.20	0%	0	Preserve
881	Quercus phellos	Willow Oak	11.7	0.70	0.75	6.14	0%	0	Preserve
882	Quercus phellos	Willow Oak	12.5	0.70	0.75	6.56	0%	0	Preserve
883	Quercus phellos	Willow Oak	12.4	0.70	0.75	6.51	0%	0	Preserve
884	Quercus phellos	Willow Oak	9	0.70	0.70	4.41	0%	0	Preserve
885	Quercus phellos	Willow Oak	9.7	0.70	0.75	5.09	0%	0	Preserve
886	Quercus phellos	Willow Oak	15.2	0.70	0.65	6.92	0%	0	Preserve
887	Quercus phellos	Willow Oak	13	0.70	0.75	6.83	0%	0	Preserve
888	Quercus phellos	Willow Oak	5	0.70	0.80	2.80	0%	0	Preserve
889	Quercus phellos	Willow Oak	13.2	0.70	0.75	6.93	0%	0	Preserve
890	Quercus phellos	Willow Oak	6.4	0.70	0.75	3.36	0%	0	Preserve
892	Quercus phellos	Willow Oak	3	0.70	0.75	1.58	0%	0	Preserve

TOTAL REPLACEMENTS 9

Notes:

- 1. All trees of 10" caliper or less shall be replaced at a minimum of a one-for-one basis.
- Condition Rating based on formula provided by the <u>Guide for Plant Appraisal</u> published by the ISA.
 Condition Rating: .8 I I 00 Excellent, .6 I .80 Good, .4 I .60 Fair, .2 I .40 Poor, .06-.20 Very Poor
- 3. Species Rating based on formula provided by the Guide for Plant Appraisal published by the ISA.
- 4. Neither the Project Arborist nor Bowman Consulting condone the implementing of any suggested preservation or removal techniques without the agreement/permission of the adjacent property owner.
- 5. All trees indicated are to be cleared from the site due to construction impacts.
- 6. All trees with a minimum 3" D.B.H. were inventoried and rated.
- 7. Any replacement trees that cannot be accommodated on site will be provided in a monetary amount: for every tree that cannot be planted on site, a contribution to the County's Tree Canopy Fund of at least \$2,400 per tree will be provided to the Tree Canopy Fund coordinated with Arlington County's Department of Parks, Recreation and Cultural Resources.

NOTE: TREE INVENTORY AND TREE CONDITION ANALYSIS PERFORMED BY BENJAMIN HARTMANN, ISA CERTIFIED ARBORIST MA-6213A ON 03/03/2021 AS SHOWN ON TREE PRESERVATION PLAN SHEET C13.0 BY BOWMAN ENGINEERING. SEE SHEET C13.0 FOR MORE INFORMATION.

9 TOTAL TREES PROVIDED TO MEET REPLACEMENTS

20-YEAR TREE CANOPY COVERAGE WORKSHEET PER CHESAPEAKE BAY PRESERVATION ORDINANCE								
KEY	TREE SPECIES	COMMON NAME	PLANTING SIZE HEIGHT (ft.)	CALIPER SIZE AT PLANTING (in.)	SPREAD AT PLANTING (ft.)	CANOPY SIZE	20 YEAR COVERAGE (sq. ft.)	SUBTOTAL COVERAGE (sq. ft.)
LIQS	LIQUIDAMBER STYRACIFLUA	SWEETGUM		3 1/2	5-7	MEDIUM	312.50	1,562.50
CEOC	CELTIS OCCIDENTALIS	COMMON HACKBERRY		3 1/2	5-7	LARGE	393.75	787.50
BENI	BETULA NIGRA	RIVER BIRCH		3 1/2	5-7	MEDIUM	218.75	0.00
					TOTAL TREE CA	ANOPY COVER	AGE PROVIDED	2,350.00
			MI	NIMUM TREE C	ANOPY COVER	RAGE REQUIRE	ED (SEE NOTE 1)	2,307
TOTAL SITE AREA							23,071	
PERCENT OF TREE CANOPY COVERAGE PROVIDED						10.2%		
PERCENTAGE TREE CANOPY COVERAGE REQUIRED (SEE NOTE 1)						10%		
	LIQS CEOC	KEY TREE SPECIES LIQS LIQUIDAMBER STYRACIFLUA CEOC CELTIS OCCIDENTALIS	KEY TREE SPECIES COMMON NAME LIQS LIQUIDAMBER SWEETGUM CEOC CELTIS COMMON HACKBERRY	KEY TREE SPECIES COMMON SIZE HEIGHT (ft.) LIQS LIQUIDAMBER STYRACIFLUA SWEETGUM CEOC CELTIS COMMON HACKBERRY BENI BETULA NIGRA RIVER BIRCH MII	KEY TREE SPECIES COMMON NAME SIZE HEIGHT (ft.) CALIPER SIZE AT PLANTING (in.) LIQS LIQUIDAMBER STYRACIFLUA SWEETGUM 3 1/2 CEOC CELTIS COMMON HACKBERRY 3 1/2 BENI BETULA NIGRA RIVER BIRCH 3 1/2 MINIMUM TREE COMMON HACKBERRY	KEY TREE SPECIES COMMON NAME SIZE HEIGHT (ft.) CALIPER SIZE AT PLANTING (in.) SPREAD AT PLANTING (in.) LIQS LIQUIDAMBER STYRACIFLUA SWEETGUM 3 1/2 5-7 CEOC CELTIS COMMON HACKBERRY 3 1/2 5-7 BENI BETULA NIGRA RIVER BIRCH 3 1/2 5-7 TOTAL TREE COMMON TREE CANOPY COVER	KEY TREE SPECIES COMMON NAME SIZE HEIGHT AT PLANTING (in.) CANOPY SIZE LIQS LIQUIDAMBER STYRACIFLUA SWEETGUM 3 1/2 5-7 MEDIUM CEOC CELTIS COMMON HACKBERRY 3 1/2 5-7 LARGE BENI BETULA NIGRA RIVER BIRCH 3 1/2 5-7 MEDIUM TOTAL TREE CANOPY COVERAGE REQUIRE MINIMUM TREE CANOPY COVERAGE REQUIRE	KEY TREE SPECIES COMMON NAME SIZE HEIGHT (ft.) CALIPER SIZE AT PLANTING (in.) CANOPY SIZE COVERAGE (sq. ft.) LIQS LIQUIDAMBER STYRACIFLUA SWEETGUM 3 1/2 5-7 MEDIUM 312.50 CEOC CELTIS COMMON HACKBERRY 3 1/2 5-7 LARGE 393.75 BENI BETULA NIGRA RIVER BIRCH 3 1/2 5-7 MEDIUM 218.75 TOTAL TREE CANOPY COVERAGE PROVIDED MINIMUM TREE CANOPY COVERAGE REQUIRED (SEE NOTE 1) TOTAL SITE AREA PERCENT OF TREE CANOPY COVERAGE PROVIDED

NOTES:

 ARLINGTON COUNTY CODE PER CHAPTER 61 CHESAPEAKE BAY PRESERVATION ORDINANCE MINIMUM TREE CANOPY REQUIREMENTS 61-10.C.1.a.: MINIMUM LOT COVERAGE OF TREE CANOPY IS TEN PERCENT (10%). 200 S. PEYTON STREET
ALEXANDRIA, VA 22314
703.549.7784
WWW.LANDDESIGN.COM

MATTHEW V. CLARK

Lic. No. 952

02/07/2022

NOT FOR CONSTRUCTION

2025 CLARENDON BOULEVARD

GREYSTAR

2025 CLARENDON BOULEVARD


ARLINGTON, VA


DESIGNED BY: MC/JVW DRAWN BY: JVW/LH CHECKED BY: JVW


VERT: N/A HORZ: N/A


ICCT TITL C

PLANTING NOTES

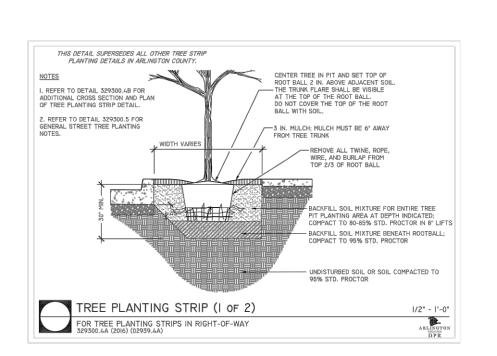

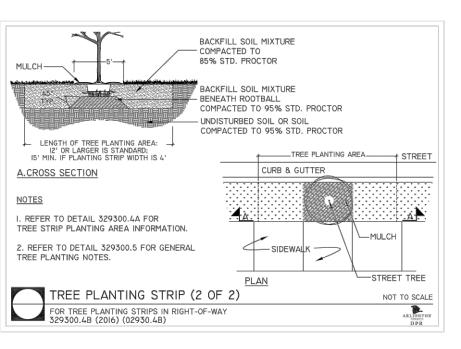

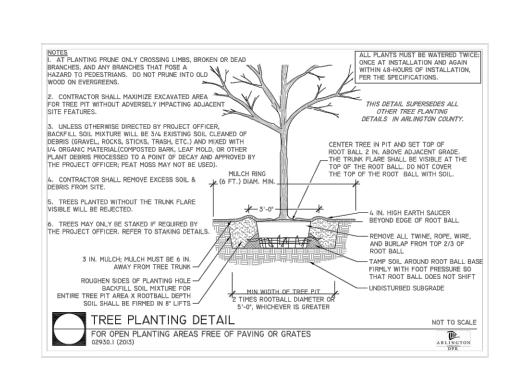

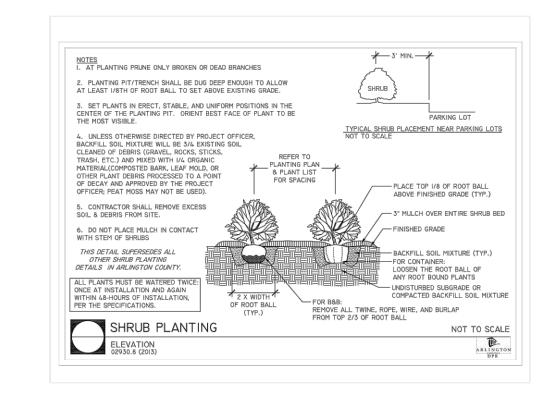

ALEXANDRIA, VA 22314 703.549.7784 WWW.LANDDESIGN.COM

1. SEE MATERIALS PLANS FOR LOCATION. 2. PLANTING DETAIL PER ARLINGTON, VA DPR

1. SEE MATERIALS PLANS FOR LOCATION.

3. OR APPROVED EQUAL.

2. PLANTING DETAIL PER ARLINGTON, VA DPR

3. OR APPROVED EQUAL.

SEE MATERIALS PLANS FOR LOCATION. 2. PLANTING DETAIL PER ARLINGTON, VA DPR 3. OR APPROVED EQUAL.



L503 SECTION

TREE PLANTING

3 SHRUB PLANTING

NOTES:

1. *#4. @ 12"O.C., IN 6' LENGTHS ACROSS AMENDED SOIL PANEL

2. PROVIDE CONT. BAR SUPPORTS @ 3"±0.C.


3. 6x6 #2x#2 WWH CONT. WITHIN 4" CONCRETE SLAB

* SIDEWALK SLAB SHALL BE AMENDED AS REQUIRED

AND SHOWN ON APPROVED PLANS. #4 REBAR CONTINUOUS THRU SOIL PANE AMENDED SOIL, COMPACTED 85%-#57 STONE SLOPED TO DRAIN PIPE AT I/2"-I"/FOOT; — LINE SIDES OF EXCAVATION WITH FILTER FABRIC FILTER FABRIC-TYPAR 360I, MIRAFI 500X, OR EQUAL

CONTINUOUS SOIL PANEL (A)


2/4/2022 5:09 PM DAPHNE BRICE Z:\TEMPLATES\SHEETS\CD SHEETS\LA\SHEET-24X36.DWT

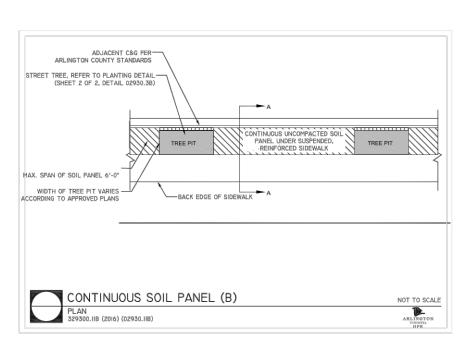


1. SEE MATERIALS PLANS FOR LOCATION.

3. OR APPROVED EQUAL.

2. PLANTING DETAIL PER ARLINGTON, VA DPR

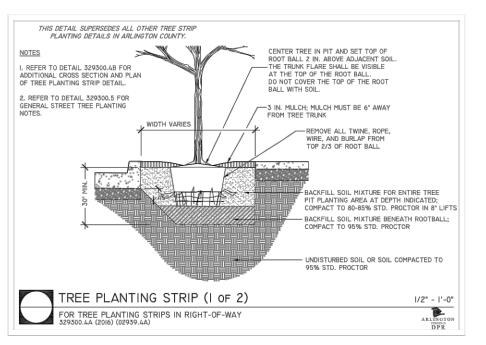


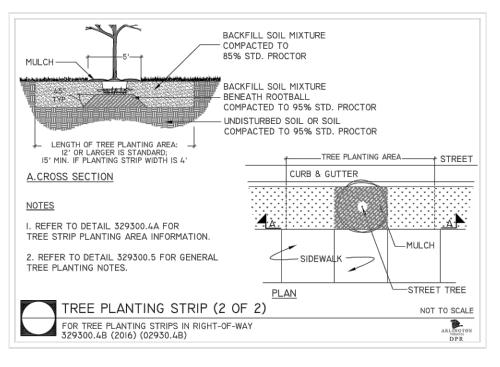

1. SEE MATERIALS PLANS FOR LOCATION

3. OR APPROVED EQUAL.

PLANTING DETAIL PER ARLINGTON, VA DPR

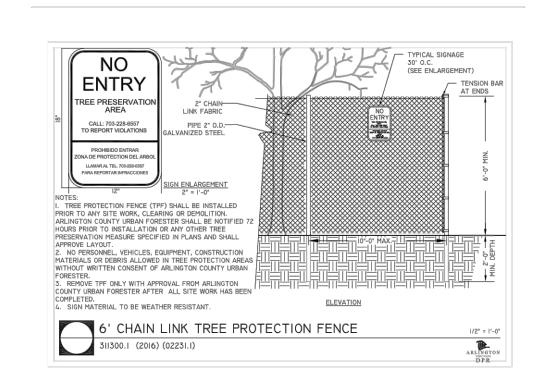

NOT FOR CONSTRUCTION

MATTHEW V. CLARK

Lic. No. 952

02/07/2022

2025 CLARENDON BOULEVARD

GREYSTAR

2025 CLARENDON BOULEVARD

2020194

REVISION / ISSUANCE

DESCRIPTION

4.1 SUBMISSION

COUNTY MEETING

4.1 SUBMISSION

4 STRUCTURAL CELL SYSTEM

5 TREE PLANTING STRIP

6 PROTECTION FENCE


1. SEE MATERIALS PLANS FOR LOCATION.

3. OR APPROVED EQUAL.

2. PLANTING DETAIL PER ARLINGTON, VA DPR

ARLINGTON, VA

SET SHRUB WITH 2" OF ROOT BALL ABOVE GRADE - 3" MULCH LAYER TYP, THROUGHOUT ALL PLANTER AREAS LOOSEN ALL CONTAINER BOUND & GIRDLED ROOTS LIGHT WEIGHT PLANTING MEDIA STRUCTURAL SLAB FOR REF ONLY

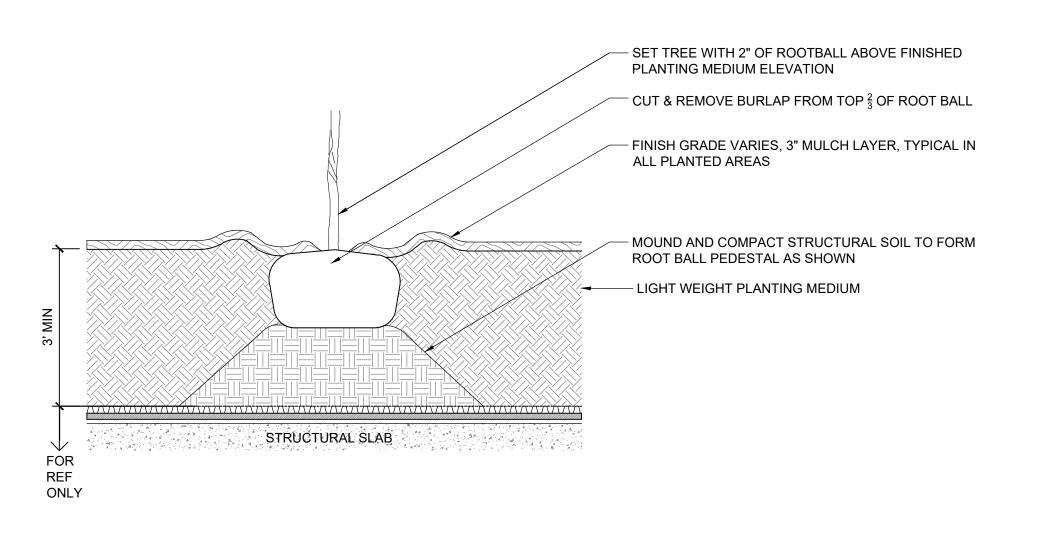

THESE DOCUMENTS ARE REFERENCED FROM "ARLINGTON COUNTY DESIGN

SHRUB PLANTING ON STRUCTURE

L503 / SECTION 1" = 1'-0" XREF

8 TREE PLANTING ON STRUCTURE L503 / SECTION

3/8" = 1'-0" XREF

STANDARDS, DPR"

HORZ: N/A

PLANTING DETAILS


DESIGNED BY: MC/JVW

DRAWN BY: JVW/LH

CHECKED BY: JVW

L503

ORIGINAL SHEET SIZE: 24" X 36"

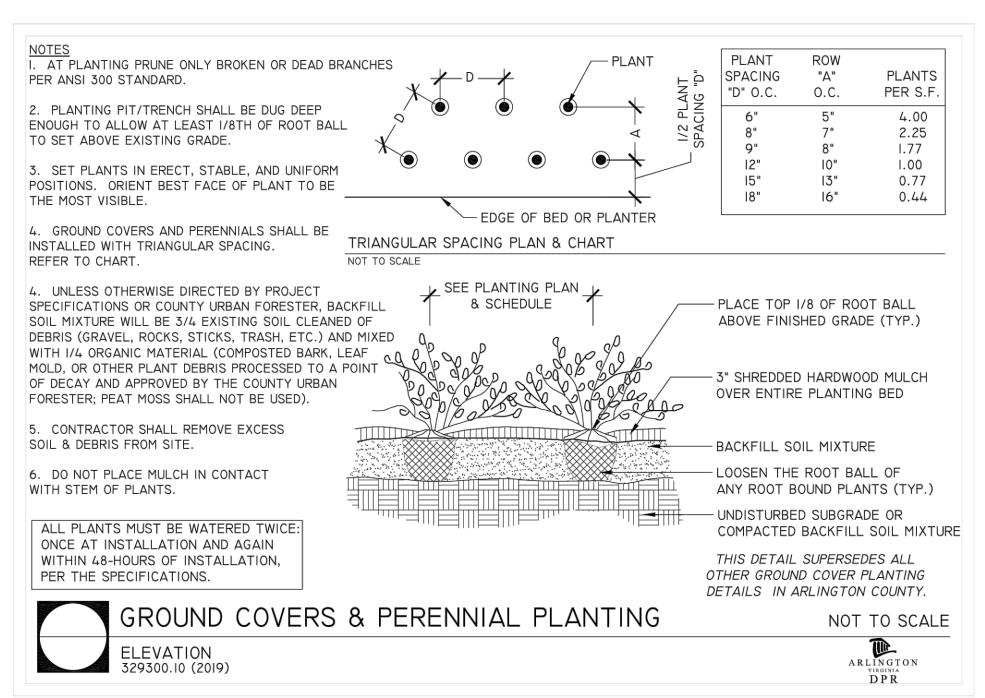

1 GROUND COVER AND PERENNIAL PLANTING

L504 SECTION

NTS



200 S. PEYTON STREET ALEXANDRIA, VA 22314 703.549.7784 WWW.LANDDESIGN.COM

EY MAP

MATTHEW V. CLARK

Lic. No. 952
02/07/2022

NOT FOR CONSTRUCTION

2025 CLARENDON BOULEVARD

GREYSTAR

2025 CLARENDON BOULEVARD

ARLINGTON, VA

DESIGNED BY: MC/JVW DRAWN BY: JVW/LH CHECKED BY: JVW

VERT: N/A HORZ: AS NOTED

EET TITLE

PLANTING DETAILS