



PIPS CALLOWS ROAD, SUITE NO VICTINA VIRGOLIA 22182 703-821-2045



KETTLER

1751-700 MUHACLE ERIVE MELEAN YINGHRA

CRYSTAL CITY RESIDENTIAL

4.1 SITE PLAN

ARLINGTON COUNTY, VIRGINIA


REVISIONS


No. Description 4/13/12 Date


CONCEPTUAL LANDSCAPE PLAN LEVEL 12


Project Number 1" = 20" Drawn By: 642 Checked By: 3/7/V2 Date: Sheet No. L102


NOTES
1. REFER TO L411 412 FOR PLANT SCHEDULE DETAILS. AND NOTES. 0 10 20

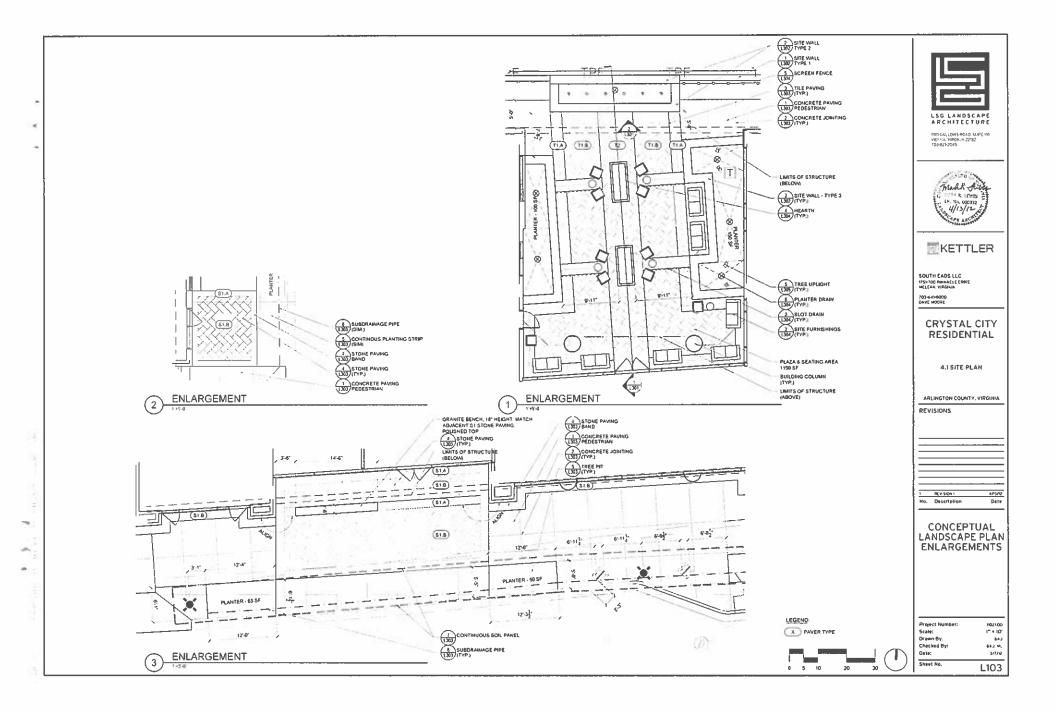


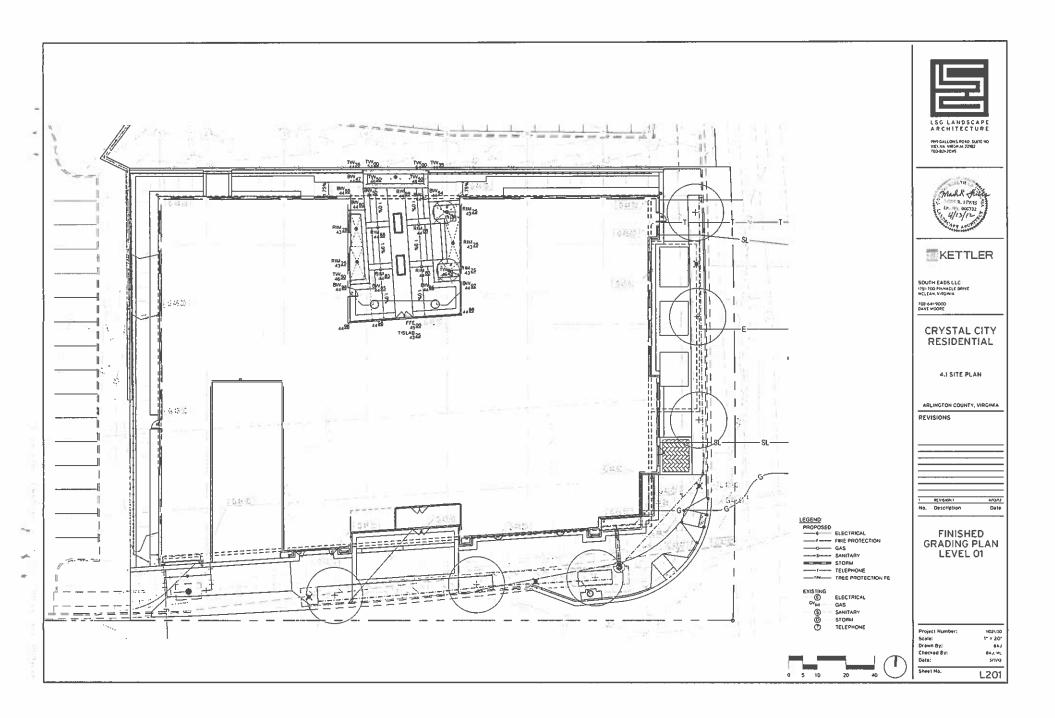


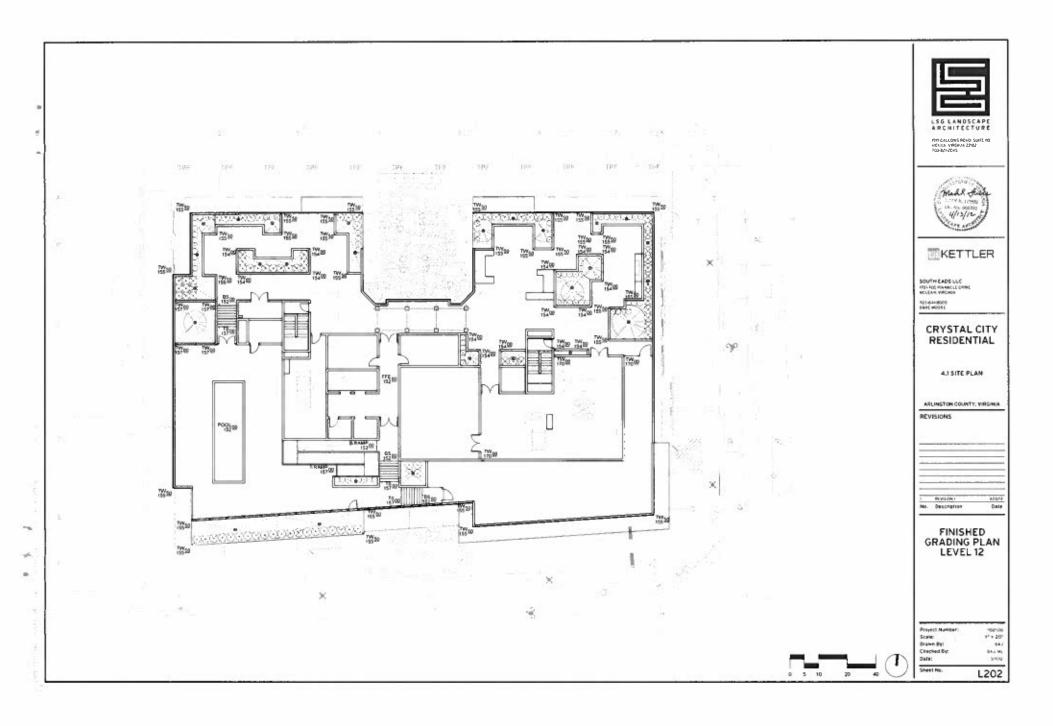

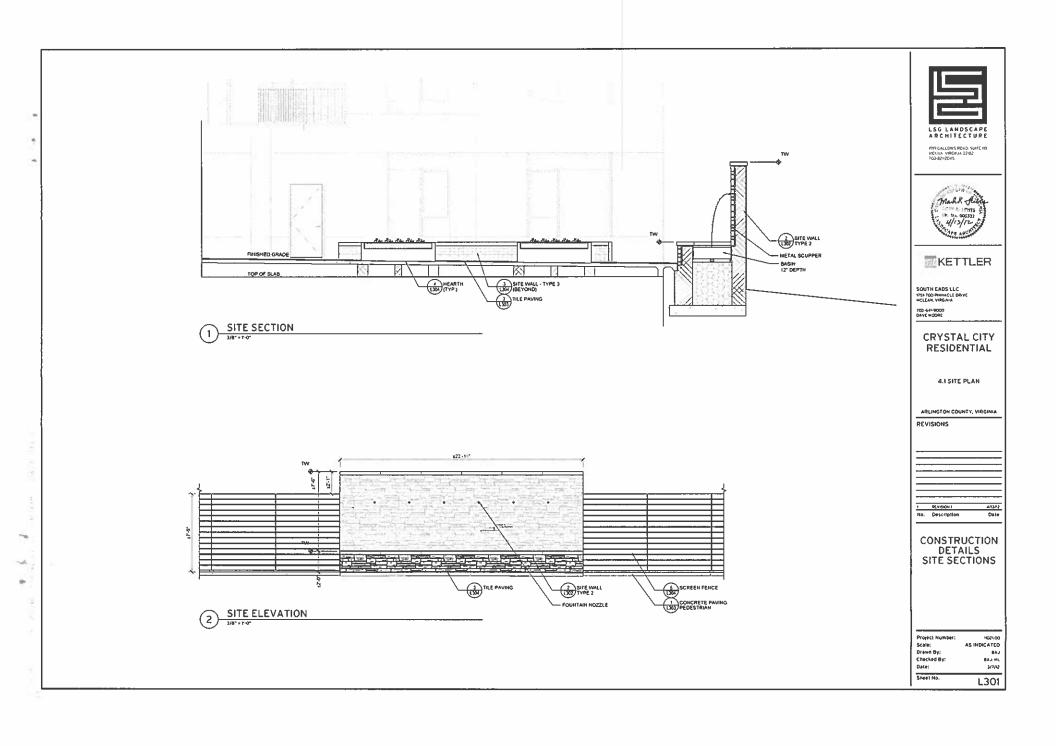

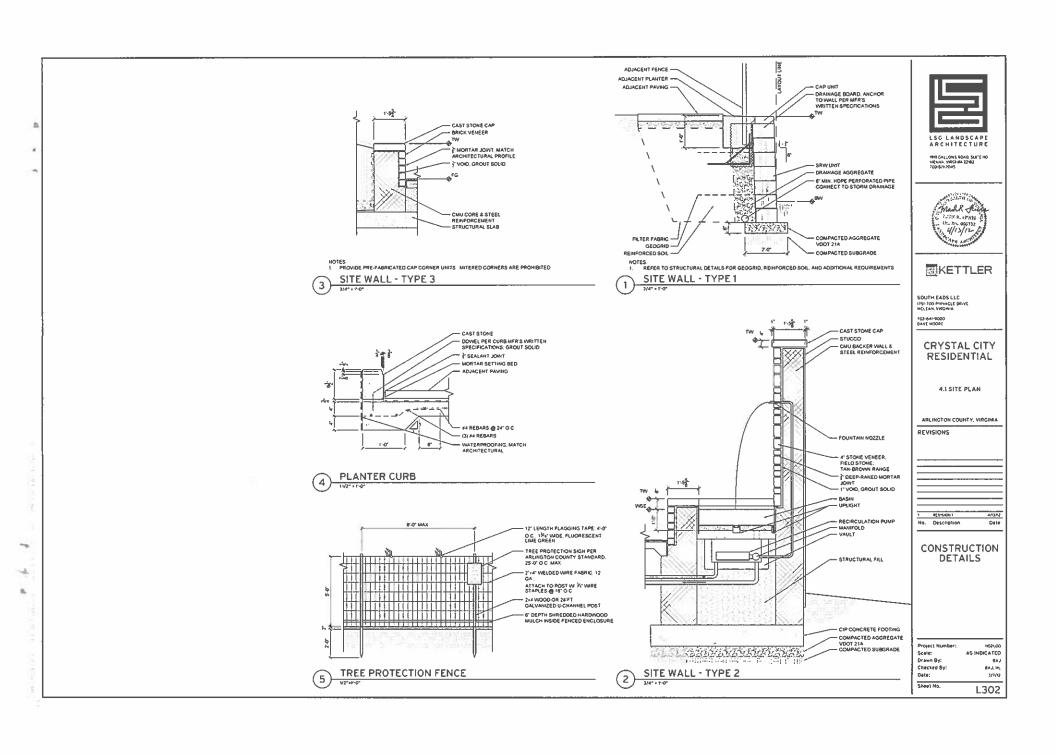

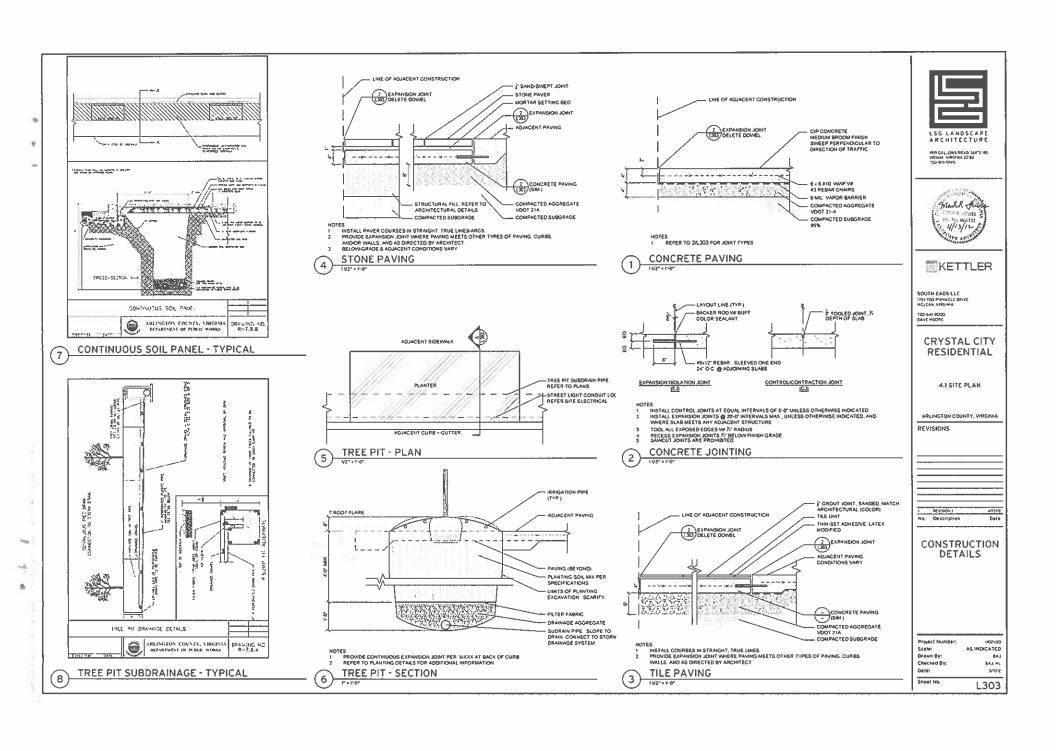

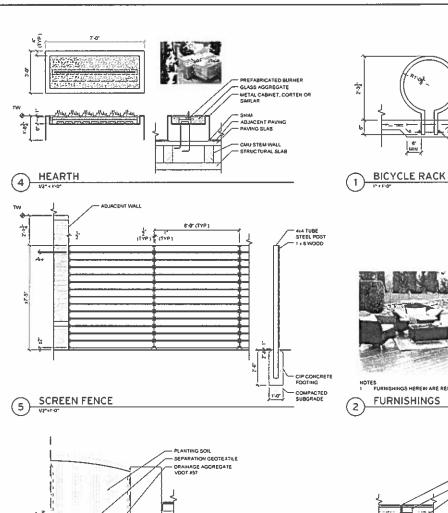

STRUCTURAL SLAB

TOPPING SLAB


NOTES

1 VERIFY POSITIVE DRAINAGE TO ALL PARTS OF ALL PLANTERS INSTALL TOPPING SLAB AND ADDITIONAL SLAB DRAINS AS NECESSARY

PLANTER DRAIN


3/4" = 1.0"

- WATERPROOFING, PROTECTION BOARD, DRAINAGE BOARD, REFER TO ARCHITECTURAL DETAILS - SLAB DRAIN PER MEP; CAST IRON BEEHIVE GRATE

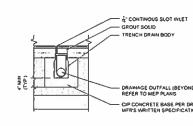

SET SLOT & TRENCH RIM ELEVATIONS CONSTANT, ‡ BELOW ADJACENT FG.
TRENCH INVERT TO SLOPE WIN 05% TOWARD DRAINAGE
PROVIDE;* SEALANT JOINT BETWEEN SLOT & ADJACENT PAVING AND WALLS

(3)

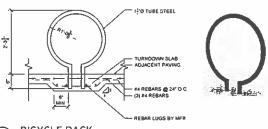



FURNISHINGS



Project Number AS INDICATED Scale: Drawn By: Checked By: 9AJ, MU 2/7/12

LSG LANDSCAPE ARCHITECTURE

A STATE OF

Mark Killy 1000 K. 18018 8

KETTLER

CRYSTAL CITY RESIDENTIAL

4.1 SITE PLAN

ARLINGTON COUNTY, VIRGINIA

4/13/12

Date

SOUTH EADS LLC 1751-700 PIRHACLE DRIVE MCLEAN, VIRSINIA

700-641-9000 DAVE MOORE

REVISIONS

40 VISION I

No. Description


CONSTRUCTION DETAILS

Sheet No. L304

DRAMAGE OUTFALL (BEYOND) REFER TO MEP PLANS CIP CONCRETE BASE PER DRAIN BODY MFR'S WRITTEN SPECIFICATIONS

Date:

SLOT DRAIN 1, = 1,-0,

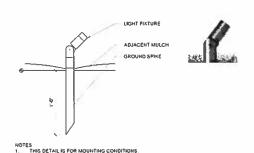

THIS DETAIL IS FOR MOUNTING CONDITIONS.
REFER TO SITE ELECTRICAL PLANSSPECIFICATIONS.
PROVIDE TRANSFORMERS AND FLUSH IN-GROUND BOXES AS INDICATED AND AT LOCATIONS INDICATED.

UPLIGHT

1-1/2" + 1'-0"

(5)

D

Se.

UPLIGHT

(6)

ENVIRONMENTS

PRODUCT SCHEDULE


301-470-3282

ITÉM MANUFACTURER MODEL StZE FINISH COLOR PAVING SIA.STONE CHARLES LUCK STONE 18" v XXX NOMINA ABSOLUTE CENTER STERLING GRANITE WATER JET SI.B. STONE 12" v 24" NOMINAL VIRGINIA, 703-675-5267 12" v 12" NOMINAL TLA - TILE DAY PROVENZA STONE G-STONE MINIMAL NATURALE TI B . TILE 12" x 24" NOMINAL DAY SOURCE 202-265-5900 NIGHT T2 - TILE 12" x 24" NOMINAL SITE FURNISHING BENCH BICYCLE RACK BARBARA NOLAH INC., POWDERCOAT BLACK TRASH RECEPTACLE PLANTER SITE LIGHTING REQUIREMENTS ARE SUBJECT TO CHANGE, REVIEW WITH COUNTY STREETLIGHT STANDARDS MGR. REFER TO CUT SHEETS: 1-4/L305 STREET LIGHT POWDERÇOAT PRIOR TO PURCHASE AND PRIOR TO INSTALLATION. W REMOTE OSET BEGA: LIGHTING AR-LED-RM-a22-WFL-R TRANSFORMERS AS


POWDERCOAT

BLACK


INDICATED, 18" POWERPIPE

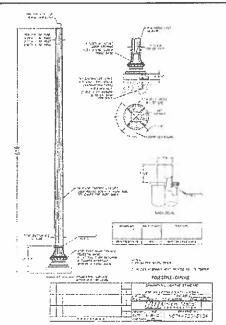

STREET LIGHT - POLE

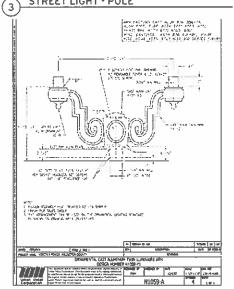

STREET LIGHT - TWIN ARM (4)

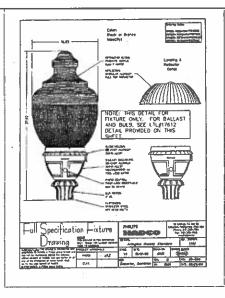

NOTES.

1. REFER TO DETAILS 2-4-1,205 FOR ADDITIONAL REQUIREMENTS,

2. COUNTY REQUIREMENTS ARE SUBJECT TO CHANGE. REVIEW WITH COUNTY PRIOR TO PURCHASE AND PRIOR TO INSTALLATION.

STREET LIGHT - HEAD



REPLANSIFICATION AND LIGHT CHOICE CLASSIFICATION APPROPRIES. THE PARTY OF THE P



	LUX DIST	KHIC DOV	
TIME!	Drivey m. 4 side	CONTRO	10fa1
NOTE:	1071.06	MIN	251144
Marie .	1971.99	M1570	bha
107444	1645 T*	73140	447931

AN IMPROVED A LIMB AT MARKET AND PROPERTY OF A STREET AND A STREET AND

STREET LIGHT - FIXTURE (2)





KETTLER

SOUTH EADS LLC 1751-700 PRNACLE OPINE WCLEAN, VIPCINIA

763-641-9000 CAVE MODRE

CRYSTAL CITY RESIDENTIAL

4.1 SITE PLAN

ARLINGTON COUNTY, VIRGINIA


REVISIONS


9EV SION 1 No. Description Date


CONSTRUCTION DETAILS

Project Number Scale: AS INDICATED Orawn By: 843 EAJ UL Date: Sheet No.


3/1/12 L305

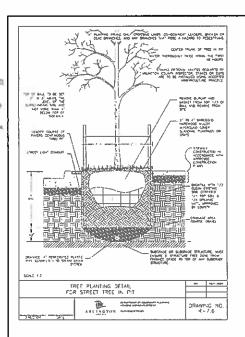

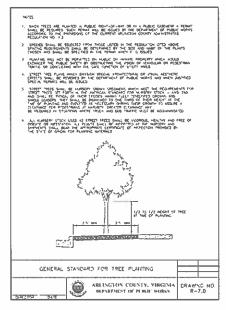

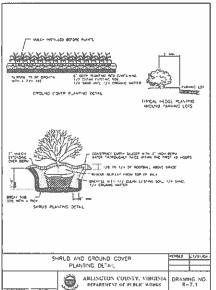

D

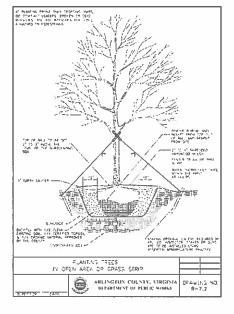

KEY	QTY	BOTANICAL NAME	COMMON NAME	SIZE	TYPE	SPACING	REMARKS
ELECTIONS OF S	PECIES AND	CULTIVARS MAY INCLUDE BUT NOT	BE LIMITED TO, THOSE PROVIDED BE	LOW.			
UNOPY TREES							
	Τ	Patanus aconitolia	LONDON PLANE TREE		846	AS HIDICATED	
(+)		Umus perviole Bosque	BOŞOVE ELVI	CAFINE B			
		Zehova sarrasa 'Graen Vașe'	GREEN VASE ZELKOVA				
RNAMENTAL TRE	ĘS						
		Comus house	KOUSA DOGWOOD		946	AS MADICATED	
(J)		Lagerstroem-a-indica	CRAPE LIVERTLE	10 - 12"			
		Magnote i soutengime	SAUCER MAGNOLIA				
-Aues							
		fer = meserveae	CHINA GIRL HOLLY		CON1.	24 - 30" O C.	
⊗⊙		Nandris domestica	HEAVENAY BAMBOO	24 - 30"			
		Prunus leurocerasus	CHERRY LAUREL	7			
ROUND COVERS:	PEREMANAL	5					
1 11		Coloneaster denimen "Coral Beeuty"	CORAL BEAUTY COTONEASTER		CONT.	12" O.C.	1
/_//		Linope muscen 'Big Blue'	BIG BLUE LILYTURF	1 GAL.	CONT.		

NOTES 1. ALL PLANTS ARE TO BE HEALTHY, FULL BALANCED AND EXCEPTIONALLY HEAVY,

PLANT SCHEDULE



999 CALLOWS MOAD, SUITE NO VIELNA VIRGOLIA 22182 703-821-2045



KETTLER

SOUTH EADS LLC 1751-700 PINNACLE DRIVE MCLEAN, VIRGINIA

CRYSTAL CITY RESIDENTIAL

4.1 SITE PLAN

ARLINGTON COUNTY, VIRGINIA

REVISIONS

I REVISION I 4/13/12 No. Description Date

PLANT DETAILS AND PLANT SCHEDULE

Project Number AS INDICATED Drawn By-Checked By: BAL WL Date: 3/7/12 Sheet No.

L411

LANDSCAPE MAINTENANCE MANAGEMENT PROGRAM

A ALL PLANTING AREAS, INCLUDING LAWNS, BUFFERS, AND PARKING LOTS, SHALL BE PERIODICALLY INSPECTED A MINIMUM OF ONCE PER MONTH, EVERY TWO (2) WEEKS DURING THE GROWING SEASON, OR AFTER EACH MOWING SESSION A FAIL CLEAN-UP SHALL BE PERFORMED EACH YEAR. REMOVE ALL LITTER, DEBRIS AND WEEDS: MAINTAIN A MIRIMUM OF A 2-INCH DEPTH OF ORGANIC HARDWOOD MULCH OR

EQUAL IN ALL PLANTING BEDS

IRRIGATION

ALTOMATIC SPRINKLERS SHALL BE CLEANED OUT AND TURNED OFF IN THE B EVALUATE SUCCESS OF IRRIGATION SYSTEM AND MODIFY AS NECESSARY

NEW TURF, KEEP MOIST UNTIL ALL SEED GERMINATES AND BECOMES AN ESTABLISHED STAND OF TURE

ESTABLISTICUSTRIU OF FURF EXISTING TURF DURING DRY PERIODS, WATER TWICE A WEEK FOR 20 MINUTES AT A TIME, OR SET IRRIGATION FOR COVERAGE OF 1-2 INCHES OF WATER PER WEEK

SEASONAL FLOWERS

SEASOMAN FLOWER BEDS SHALL SE PERIODICALLY MULCHED AID THE SOIL A ANNIVAL FLOWER BEDS SHALL SE PERIODICALLY MULCHED AID THE SOIL AMEADED ANNIVALLY NEW PLANTINGS SHALL BE PROVIDED IN MAY OF EACH YEAR DURING THE GROWING SEASON ALL BEDS SHALL RECEIVE PERIODIC INSPECTIONS PER NOTE, IRRIGATION AND WEEDING TO MAINTAIN A NEAT

A LAWN AREAS SHALL NOT EXCEED A HEIGHT OF 4 INCHES, APPROXIMATELY 12-15 MOWINGS PER YEAR WILL BE REDUIRED

FERTILIZER AND SOIL AMENDMENTS SHOULD BE ADDED A NECESSAR' AND/OR ON A SEASONAL BASIS, FERTILIZER IS OPTIMALLY APPLIED TO LAWN AND TURP AREA THREE TIMES PER SEASON TIMEND, PRODUCTION AND RATE OF APPLICATION SHALL BE ADJUSTED ACCORDING TO WEATHER AND TO HORTICULTURAL AND SOIL TEST CONDITIONS FOR EACH SPECIFIC SITE FERTILIZER SHALL BE APPLIED BY ACCEPTED METHODS ONLY SAFETY SHALL BE OF PRIME CONSIDERATION CARE SHALL BE TAKEN NOT TO APPLY FERTILIZER

OF PRIME CONSIDERATION CARE SHALL BE TAKEN NOT TO APPLY FERTILIZEN WHICH THE GROUND IS WET!

C. SOM AMENDMENTS SUCH AS LIME, GYPSUM OR PEAT MOSS MAY BE TO BE ADDED TO THE SOILS OF LAWNS, TURF OR PLANTING AREAS PERIODICALLY THE NEED FOR SUCH SOIL AMENDMENTS SHALL BE ANALYZED DURING THE PERIODIC

INSPECTIONS AND IN CONJUNCTION WITH SOIL TESTS.

INSPECTIONS AND INCOMUNICTION WITH SUR. TESTS

SOIL AMERICAN SECTION OF BASED UPON SOIL TEST RESULTS

APPLY A 3-1-2 (21-7-14 10-4-5 OR 24-4-8) 50% ORGANIC FERTILIZER TWICE A
YEAR BETWEEN MARCH 15 TO APRIL 15 AND SEPTEMBER 7 TO OCTOBER 1 TWO ADDITIONAL APPLICATIONS MAY BE APPLIED IN MAY AND NOVEMBER, IF NECESSARY, DO NOT APPLY FERTILIZER OR SOIL AMERIOMENTS WHILE TURF IS BITHER WET OR UNDER EXTREME STRESS. IN WINDY CONDITIONS, OR WHEN CHILDREN ARE PRESENT.

REMOVAL OF DEAD DISEASED, INSECT INFESTED OR WEAK WOOD SHALL TAKE PLACE IN THE DORMANT SEASON OR AFTER FLOWERING EXCESSIVE

TAGE PLACE IN THE DOMMANT SEASON ON AN LEY FLOWERING EXCESSIVE SHOOTS AND SUCKERS SHALL USE REMOVED B. SHRUB MATERIAL USED AS A SCREEN SHALL BE PRUNED AS A MASS TO ENHANCE THER NATURAL FORM C. ROOT PRUNING OF TREES ADJACENT TO CURBS OR SIDEWALKS SHALL

OCCUR DURING PERIODIC INSPECTIONS WITH KNOWLEDGE OF MOST RECENT PRUNING NO MORE THAN 1/3 OF POOT SYSTEM SHALL BE PRUNED DURING A

INSECT AND DISEASE CONTROL

THE CONTROL OF INSECTS AND DISEASE ASSOCIATED WITH ALL PLANTING A THE CONTROL OF INSCETS AND DISEASE ASSOCIATED WITH ALL PLANTING AREAS SHALL AWAYS BE AMANTEMANCE PRODUCTIVE ALL PLANTING. SECULOMS EXISTING MATURE TREES. SHALL BE PERIODICALLY MISPECTED FOR HISECT OR DISEASE INFESTATION METHODO SUTUZED TO CONTROL HISECTS OR DISEASE MAY RANGE PROM SPRAYING AND PUNINES TO PLANTINE BURYAN, WHATEVER METHOD SITUATION AND CONTROL SHALL BE OF PRIME CONCERN METHOD SITUATION. TRAINED AND CERTIFIED PERSONNEL SHALL PERFORM THESE TASKS

RENOVATION
A RENOVATION INCLUDES THE RESEEDING OR REPLANTING OF LANDSCAPE
AREAS DAMAGED, DESTROYED OR FAILING QUE TO INSECTS, DISEASE, WEATHER

B LAWN ALL AREAS WHERE SOIL HAS BEEN EXPOSED SHALL BE RENOVATED DURING THE NEXT PLANTING SEASON PROPER HORTICUI TURAL AND SOIL EROSION PREVENTION METHODS SHALL BE UTILIZED IF SOIL EROSION HAS COURTED. THE AREA SHALL BE REPAIRED WITH A SEED MIXTURE COMPATIBLE TO EXISTING SOIL AND EXISTING PLANTINGS SHALL BE UTILIZED.

C PLANTINGS ALL PLANTINGS WHICH ARE DAMAGED OR DESTROYED SHALL BE REPLACED DURING THE NEXT GROWING SEASON A FAILING, DAMAGED OR DESTROYED LANDSCAPE SCREEN OR BUFFER MUST BE RENOVATED OR REPLACED WITHIN A REASONABLE PERIOD OF TIME. BUT NOT TO EXCEED THE SUBSECUENT ROWING SEASON

VIII SITE AMENITIES

BENCHES PATHS BICYCLE RACKS TRASH RECEPTACLES AND SIGNS SHALL BE INSPECTED AT LEAST TWICE A YEAR, ONCE IN MARCH AND ONCE IN AUGUST, TO DETERMINE THEIR CONDITION ANY DAMAGED, WORN OR UNSAFE CONDITIONS SHALL BE RECTIFIED IMMEDIATELY

IX

PAVED SURFACES A ALL PAVED SURFACES CONCRETE SIDEWALKS, ASPHALT PAVELIENT AND

OECORATIVE PAVEMENT SHALL BE INSPECTED ON A REGULAR BASIS ALL SUCH SURFACES SHALL BE INSPECTED AT LEAST TO NCE PER WONTH B TRASH, STANS ANDOR OBSTRUCTIONS SHALL BE REMOVED IMMEDIATELY PAVEMENT SHALL BE INSPECTED FOR DAMAGE, CRACKS, AND/OR POT HOLES, AND RETURNED TO THEIR ORIGINAL CONDITIONS

C SHOW SHALL BE REMOVED DURING AND FOLLOWING EVERY STORM SIDEWALKS AND PARKING AREAS SHALL BE KEPT CLEAR OF ICE AND SNOW **DURING BUSINESS HOURS**

PLANTING NOTES

PLANT MATERIAL SHALL BE FURNISHED AND INSTALLED AS INDICATED, INCLUDING ALL LABOR MATERIALS, PLANTS, EQUIPMENT INCIDENTALS, AND CLEAN-UP

II THE CONTRACTOR SHALL BE RESPONSIBLE FOR PLANTING AT CORRECT GRADES AND ALIGNMENT LAYOUT IS TO BE APPROVED BY OWNERS' REPRESENTATIVE PRIOR TO INSTALLATION

PLANTS SHALL BE TYPICAL OF THEIR SPECIES AND VARIETY HAVE NORMAL GROWTH HABITS WELL DEVELOPED DENSELY FOLIATED BRANCHES AND VIGOROUS ROOT SYSTEMS, AND BE FREE FROM DEFECTS AND INJURIES

CONTRACTOR SHALL REPORT ANY SOIL OR DRAINAGE CONDITIONS CONSIDERED DETRIMENTAL TO GROWTH OF PLANT MATERIAL

V. ALL PLANT MATERIAL SMALL BE GUARANTEED BY THE CONTRACTOR TO 8E IN VIGOROUS GROWING CONDITION PROVISION SMALL BE MADE FOR A GROWTH GUARANTEE OF AT LEAST ONE YEAR FROM THE DATE OF ACCEPTANCE FOR TREES AND SMEDS REPLACEMENTS SMALL BE MADE AT THE REGINNING OF THE FIRST SUCCEEDING PLANTING SEASON ALL REPLACEMENTS SHALL HAVE A GUARANTEE EQUAL TO THAT STATED ABOVE

PLANT MATERIAL SHALL BE PLANTED ON THE DAY OF DELIVERY IF WHEN PRACTICAL IN EVENT THAT THIS IS NOT POSSIBLE, THE CONTRACTOR SHALL PROTECT STOCK NOT PLANTED PLANTS SHALL NOT REMAIN UNPLANTED FOR LONGER THAN A THREE-DAY PERIOD AFTER DELIVERY ANY PLANTS NOT INSTALLED DURING THIS PERIOD SHALL BE REJECTED. UNLESS OWNER AND CONTRACTOR PROVIDE OTHERWISE BY WRITTEN AGREEMENT

QUALITY AND SIZE OF PLANTS, SPREAD OF ROOTS, AND SIZE OF ROOT BALL SHALL BE IN ACCORDANCE WITH THE MOST RECENT VERSION OF ANSI 280 "AMERICAN STANDARD FOR NURSERY STOCK! PURLISHED BY THE AMERICAN ASSOCIATION OF NURSERVIAEN INC.

VIN ALL PLANTS SHALL BE PLANTED IN AMENDED TOP SOIL THAT IS THOROUGHLY WATERED AND TAMPED AS BACK-FILLING PROGRESSES. PLANTING MIX IS TO BE AS SHOWN ON PLANTING DETAILS. LARGE PLANTING AREAS TO INCORPORATE FERTILIZER AND SOIL CONDITIONERS AS STATED IN PLANTING SPECIFICATIONS

IX PLANTS SHALL NOT BE BOUND WITH WIRE OR ROPE AT ANY TRIE SO AS TO DAMAGE THE BARK OR BREAK BRANCHES PLANTS SHALL BE HANDLED FORM THE BOTTOM OF THE ROOT BALL ONLY

PLANTING OPERATIONS SHALL BE PERFORMED DURING PERIODS WITHIN THE PLANTING SEASON WHEN WEATHER AND SOIL CONDITIONS ARE SUITABLE AND IN ACCORDANCE WITH ACCEPTED LOCAL PRACTICE PLANTS SHALL HOT BE INSTALLED IN TOP SOIL THAT IS NIA AUDDLY OF IN FROZEN CONDITIONS ALL PLANT MATERIAL, SHALL BE SPRAYED WITH YALL-PRUF OR EQUAL AS PER MANUFACTURERS INSTRUCTIONS

NO PLANT, EXCEPT GROUNDCOVERS, SHALL BE PLANTED LESS THAN TWO FEET FROM EXISTING

SET ALL PLANTS PLUMB AND STRAIGHT, SET AT SUCH LEVEL THAT A NORMAL OR NATURAL HIP TO THE GROUND IF THE PLANT WITH THE GROUND SURFACE WILL BE ESTABLISHED LOCATE THE PLANT IN THE CENTER OF THE PIT XIII ALL INJURED ROOTS SHALL BE PRUNED TO MAKE LOCATE THE PLANT IN THE CENTER OF THE PIT AM ALL MOVES MODIS STRAIL BE PROVIDED TO MAKE CLEAM ENDS BEFORE PLANTING UTILIZING CLEAN SHARP TOOLS IT IS ADVISABLE TO PRIVE APPROXIMATELY TO OF THE CROWN'TH OF LARGE TREES; IT CALIPER AND GREATERS BY THE REMOVAL OF SUPERFLUOUS BRAILLES THOSE WHICH CROSS THOSE WHICH RUM PARALLE, ETC. MAIN LEADER OF TREES SHALL NOT BE CUT BACK. LONG SIDE BRAILCHES SHALL BE SHORTENED.

XIV EACH TREE AND SHRUB SHALL BE PRUNED IN ACCORDANCE WITH STANDARD HORTICULTURAL PRACTICE TO PRESERVE THE NATURAL CHARACTER OF PLANT PRUMING SHALL BE DONE WITH CLEAN

TREES SHALL BE SUPPORTED MIMEDIATELY AFTER PLANTING ALL TREES & AND GREATER IN CALIPER SMALL BE GUYED SMALLER TREES SHALL BE STAKED GUYING WIRES AND STAKES SHALL BE INSTALLED AS INDICATED THE LANDSCAPE CONTRACTOR SHALL REMOVE STAKING. GUYING AND TREE WRAP AT THE END OF ONE YEAR MAINTENANCE AND GUARANTEE PERIOD

KVI ALL PLANTING BEDS SHALL BE MULCHED WITH 3" LAYER OF DOUBLE SHREDGED HARDWOOD BARK MULCH

XVII. NEW PLANTING AREAS AND SOO SHALL BE ADECNATELY IRRIGATED OR WATERED TO ESTABLISH THE PROPOSED PLANTS AND LAWN

XVIII ALL PLANTS SHOWAN ON THE APPROVED LANDSCAPE PLAN SHALL BE INSTALLED DISPECTED AND APPROVED BY THE DEPARTMENT OF COMMUNITY PLAINING, MOUSING AND DEVELOMENTS.

LANGGARE ARCHITECTUP.ANNER OR HIGHER REPRESENTATION STREET THESE SHALL BE INSTALLED.

HISPECTED AND APPROVED BY DEPARTMENT OF PARKS, RECREATION, AND CULTURAL RESOURCES.

HISPECTED AND APPROVED BY DEPARTMENT OF PARKS, RECREATION, AND CULTURAL RESOURCES.

LIBBAR FORESTET THE LANDEGAP ARCHITECT! ANNER SHALL TAKE INTO ACCOUNT SEASONAL.

CONSIDERATIONS IN THIS RECARD TREES, SHRUBS, VINES AND GROUNDCOVER AS REQUIRED BY OR

SECONATED WITH A SUBCONSIDER OF SITE CLAIM APPROVED BY THE CHANING ANT HORPITES SHALL BE INSTALLED DURING THE FOLLOWING PLANTING SEASONS

March 15 TO December 15 PLANTS

LANNIS Much 15 TO June 15
September 15 TO December 01
THE FOLLOWING TREE VARIETIES SHALL NOT BE PLANTED DURING THE FALL PLANTING SEASON DUE TO THE HAZARDS ASSOCIATED WATH PLANTING THESE TREES IN THIS SEASON ACER RUBRUM POPULUS SPP

BETULA SPP PRUNUS SPP CARPINUS SPP PYRUS SPP CRATECUS SPP Uliebuild abe OUERCUS SPP KOELREUTERIA PANICULATA SALIX SPP LIQUIDAMBAR STYRACIFLUA TILIA TOMENTOSA LIRIODENDRON TULIPIFERA

ZELKOWA

PLATANIAS ACERIFOLIA PLANTING INSTALLED IN CONFLICT WITH THIS REQUIREMENT MUST RECEIVE WRITTEN APPROVAL OF THE LANGSCAPE ARCHITECTS PANIED PRICE TO PLATING FAILURE TO COMPY NATH THESE REQUIREMENTS WILL REQUIRE THE REMOVAL OF THE PLATING IN OUESTION THIS REQUIREMENT DOES NOT A PROVIDED THE REMOVAL OF THE PLATING SPECIFICALLY FOR SOIL STABILIZATION PURPOSES PLANTINGS ASSOCIATED WITH ANY LOT GIVEN A CERTIFICATE OF OCCUPANCY OUTSIDE THESE PERDOS SHALL BE PROVIDED DURING THE PREVIOUS OF MEXT APPROPRIATE SEASON

XIX. ALL DISTURBED AREAS SHALL BE TREATED WITH 4" TOP SOIL AND SEEDED IN ACCORDANCE WITH PERMANENT STABILIZATION METHODS INDICATED ON SOIL EROSION AND SEDMENT CONTROL SHEET

SCOPE OF YORK. THIS WORK SHALL CONSIST OF CLEARING AND SOIL PREPARATION, FINSH GRADING, PLANTING AND DRAMAGE, INCLUDING ALL LABOR MATERIALS TOOLS EQUIPMENT AND ANY OTHER APPLIETEMANCES NECESSARY FOR THE COMPLETION OF THIS PROJECT.

CHIDAR WORK ANDW MORTAGINAN JAN STAND HER TON JUANS DINTINAND PLANTING SHALL WAS BEEN UNTRUBLE BEEN UNTRUBLED FOR WORK AROUND 2) ANTING AREAS IS COMPLETE AND APPROVED.

PLANTS, ALL PLANTS SHALL BE HEALTHY, OF NORMAL GROWTH, WELL-ROOTED, AND FREE FROM DISEASE AND BISECTS.

TOPON, ORGANIC TOPON SHALL BE FREE OF DEBRIS, ROCKS LARGER THAN 21,1500D, ROOTS, VEGETABLE MATTER AND CLAY CLODS.
LIGHTON MULCH SHALL BE DOUBLE-SHREDDED HARDWOOD BARK.

FERTRIZER AND CONDITIONERS

ORGANIC FERTILIZER SHALL BE PROCESSED SEWER SLUDGE WITH MININUL CONTENT OF 1% INTROGEN AND 2% PHOSPHORIC ACID, FOUAL TO ZUMUHOSTM

ANTIFOCIALIS.

B. ORGANG FERTILIER AND SOIL CONDITIONER SHALL BE "GRO-POWER" OR EQUAL AND ORGANIC BASE MATERIALS COMPRISED OF DECCAPOISED ANIALL AND YEELFALE WATER AND COMPOSITED TO SUPPORT BUTERIAL CUI, TURBS CONTRANGS NO POUL TRY, ANNIAL OR MARANI VRISTE GUARANTEED ANIALYSIS IS-61—INTROGRAM, PROSENTE ST, POTASHA IS, SOIL ANUAL AND ANIAL CADIS.

GENERAL WORK PROCEDURES. LANDSCAPE WORK SHALL RE ACCORDING TO THE WORKHAM INF STANDARDS ESTABLISHED FOR LANDSCAPE CONSTRUCTION.

WEEDING: BEFORE AND DURING PRELIMINARY GRADING AND FINISH GRADING ALL WEEDS AND GRASSES SHALL BE DUG OUT BY THE ROOTS AND DISPOSED OF AT THE CONTRACTOR'S EXPENSE.

TOPSON - CONTRACTOR SHALL PROVIDE 4" MINIMUM THICK TOPSON LAYER IN ALL PLANTING AREAS, TOPSON, SHALL BE SPREAD OVER A PREPARED SURFACE AS A UNFORM LAYER TO PRODUCE A 1" COMPACTED THICKNESS, TOPSOL PRESENT AT THE SITE, IF ANY, MAY BE USED TO SUPPLEMENT TOTAL AMOUNT REQUIRED.

VII. SOIL CONDITIONING

CLE TWATE ALL AREAS SHALL BE PLANTED TO DEPTH OF 6", ALL DEBRIS EXPOSED FROM EXCAVATION AND CULTIVATION SHALL BE DISPOSED OF AT THE CONTRACTOR'S EXPENSE, CONDITIONER SHALL BE SPREAD EVENLY IN ALL PLANTING AREAS AND TILLED IN TWO DIRECTIONS INTO THE TOP 4", WITH THE

FOLLDAING PER 1 000 SQUARE FEET. 150 POUNDS "GRO-POWER" OR EQUAL

100 POUNDS AGRICULTURAL GYPSUM 20 POUNDS NITROFORM (COURSE) 3-0-05 BLUE CHP

FOR THE SAND SHRUBS AT THER NYENDED LOCATIONS AS PER THE PLANS AND SECURE THE APPROVAL OF THE LANDSCAPE ARCHITECT OR HIS REPRESENTATIVE BEFORE EXCHATMAGINE PIES MARING MECESSARY ADJUSTMENTS AS DIRECTED.

A. PLANTING PISS SHALL BE DOWN WITH THEY RESOTTORS, TWICE THE WORDS OF THE PLANS AND DEPTH MATCHING ARLINGTON COUNTY.

DETAILS R7.2 AND R7.6, EACH PLANT PIT SHALL BE BACKFILLED WITH THE FOLLOWING PREPARED SOR, MIXED THOROUGHLY

3 PARTS TOPSOIL BY VOLUME 21 GRANS 'AGRIFORN' PLANTING TABLETS OF ECUAL

2 TARLETS PER LOAL PLANT

3 TABLETS PER 5 CAL PLANT 4 TABLETS PER 15 GAL PLANT

FOR LARGER PLANTS 2 TABLETS PER 1/2 DIAMETER OF TRUNK CALIPER!

B. PREPARED SOC SHALL BE TAMPED FRILLY AT BOTTOM OF PIT FILL PREPARED SOU, AROUND BALL OF PLANT HALFWAY INSERT PLANT TABLETS. COMPLETE BACKER I AND WATER THOROUGHLY

ALL PLANTS SHALL BE SET SO THAT THEY BEAR THE SAME RELATION TO THE REQUIRED GRADE AS THEY BORE TO THE NATURAL GRADE BEFORE BEING

THIS DAY AFTER PLANTING, STAKE ALL TREES TO PREVENT DAMAGE FROM WIND, FASTEN TREES TO UPPER END OF STATE IN AT LEAST TWO PLACES

PROPARE RAISED EARTH BASIN AS WIDE AS PLANTING HOLE OF EACH TREE.

F. WATER MANEONATELY ASTER PLANTING, WATER SHALL BE APPLIED TO EACH TREE AND SHAUBIN SUCH WASHER AS NOT TO DISTURB BACKFILL AND TO THE EXTENT THAT ALL MATERIALS IN THE PLANTING HOLE ARE THOROUGHLY SATURATED.

PRIDME ALL PROPOSED TREES DIRECTLY ADJACENT TO WALKINAYS TO A VINIOUS OF 7-0" BRANCHING HEIGHT

IX GROUND COVER

ALL GROUND COVER AREAS SHALL RECEIVE A 14" LAYER OF HUMB'S RAKED INTO THE TOP IT OF PREPARED SOIL PRIOR TO PLANTING GROUND COVER

WEEDED PRIOR TO APPLYING PRE-EVERGENT, PRE-EVERGENT SHALL BE APPLIED PER MANUFACTURERS RECOMMENDATION

FINISH GRADING

A ALL ARES MELIBERECENED BY THE CONTRACTOR AT SUBSTANTIALLY PLUS-MANUS BY FOOT OF FRASH GRADE.

AND LAWN AND PLANTING MELAS SHALL BE DRANGED TO A SHOOTH EVER AND MARKON THAN HAVE MANUS OF SURFACE, URLESS
BY THE RANGE OF STREET BY A MADDEAT ARCHITECT OF MER PREPENSIONED, SOUL AREAS ADMICHST TO BRUDDINGS SHALL SLOPE AWAY FROM BUILDING. ALL PLANTING AREAS SHALL BE GRADED AND MAIN JAINED TO ALLOW FREE FLOW OF SURFACE WATER.

FIL GUARANTEE CONTRACTOR SHALL GUARANTEE ALL PLANTS FOR A PERIOD OF TWO YEARS FROM ACCEPTANCE OF JOB.

UPON THE COMPLETION OF ALL PLANTING WORK AND BEFORE FINAL ACCEPTANCE. THE CONTRACTOR SHALL REMOVE ALL MATERIAL, EQUIPMENT AND DEBRIS RESULTING FROUTHS WORK, ALL PAVED AREAS SHALL BE BROOM CLEANED AND THE SITE LEFT IN A NEAT AND ACCEPTABLE CONDITION AS APPROVED BY HE OWNER'S AUTHORIZED REPRESENTATIVE

ALL TIMES SHORE SCHEME ALLISTS AND PLANT BEDS SHALL BE MAINTAINED BY PRUNNIC, CULTIVATING AND WEEDING AS REQUIRED FOR HEALTHY GROUPTH. HAS WORK SHALL RICLIDE RESTORING PLANTING SAUCERS. TEATHERING AND REPARKING STAKES AND GUT SUPPORTS RESTINGT THEES AND SHOUREDS TO PROPER GROUPS OF WEITELY CORDINANS REQUIRED. SECTIONING OR REPLANDED GRANGED WITH PROPRISED AS SPRAYINGWITH HERBEDGE AS REQUIRED TO SECTION OF WEITELY CORDINANS REQUIRED. KEEP TREES AND SHRUBS FREE OF INSECTS AND DISEASE.

LAWIS SHALL BE MAINTAINED BY WATERING FERTILIZING WEEDING, MOWING TRINDING AND OTHER OPERATIONS SUCH AS ROLLING REGRADING AND REPLANTING AS REQUIRED TO ESTABLISH A SHOOTH ACCEPTABLE LAWN FREE OF ERODED OR BARE AREAS.

MAINTENANCE (ALTERNATE BID). COST PER MONTH AFTER INITIAL 90-DAY MAINTENANCE PERIOD.

PLANTING MATERIAL CHARANTEE PLANTING MATERIAL SHALL BE OF COOD MURSERY STOCK AND A MURSERY GLARANTEE SHALL BE PROVIDED BY THE GENERAL CONTRACTOR THROUGH THE DEVELOPER FOR TWO YEARS INCLUDING THE REPLACEMENT AND MAINTEMANCE TO INCLUDE BUT NOT BE LINTED TO PRINTING, FEEDING, SPRAYING, MULCHING, WEEDING AND WATERING OF ALL LANDSCAPE MATERIALS FOLLOWING THE ISSUANCE OF THE MASTER CERTIFICATE OF

THE DEVELOPER AGREES TO NOTIFY THE ARRINGTON COUNTY DEPARTMENT OF PARKS, RECREATION AND CHITURAL. RESOURCES URBAN FORESTER AT 103-236-6551 AT LEAST 73 HOURS BY ADVANCE OF THE SCHEDULED PLANTING OF ANY TREES BY THE PUBLIC RIGHT OF WAY AND TO BE AVAILABLE AT THE TIME OF PLANTING TO MEET WITH THE STAPP OF THE PORCH TO NESTED THE PLANTING STANDARDS FOR PLANTING STAPP AND PROJECTS.

THE THIS STANDARD SHOP SHOWER THE PLANTING STANDARDS FOR PLANTI AVAILABLE FROM THE URBAN FORESTER.



703-87-2045





SOUTH FADS LLC 1751-700 PINNACLE DRIVE MCLEAN, VIRGINIA

703-641-9000 DAVE MODRE

CRYSTAL CITY RESIDENTIAL

4.1 SITE PLAN

ARLINGTON COUNTY, VIRGINIA

REVISIONS

	REVISION I	4/13/
۵.	Description	Dal

PLANTING NOTES

roject Number:	110210
cale:	N/i
rawn By:	BA.
hecked By:	8AJ, M
ate:	3/7/\

Sheel No

L412

